#### SUBMISSION REQUIREMENTS FOR LARGE SCOPE PROJECTS

<u>Definition of a Large Scope Project:</u> New buildings or modification(s) of existing buildings, including, but not limited to: the construction, reconstruction, replacement or alteration of any building or structure which after said construction, reconstruction, replacement or alteration will cause changes to the height, bulk, mass, square footage, footprint, roof structure, attached porch or deck. This shall include any <u>unattached</u> accessory structure such as a shed, playhouse, pool house, garage, greenhouse or other structure which use is incidental to the principal building.

Applican	t Na	me:	Tho	mas	Haynes - Haynes Architecture PC	_ Date Filed04-28-2020
Property	Add	lress	:2	26 Ju	idson Avenue	
Check A	ppli	cati	on T	ype	(may be more than one):	·
□ New	/ Bui	ildin	g		☑ Altered Building ☐ Accessory Building	☐ Porch or Deck
Descript	tion	of P	rop	ose	d Work:	
Propose staircas		ht si	de a	dditi	on and interior alteration- including kitchen renovation, i	reconfigured space and removal of
	_	cor	nple	ted	form is to be included as a cover sheet for each of the	e 11 submissions to the AHRB.
Items de application appropris included The AHR initial ap	enote on to ate o B re plica	ed • o the colur serv	in e Al- mn c es th	the IRB onfi ne ri d m	e indicate the type of submission by checking the a column below your project type are the minimus. Please indicate the type of submission. Please indirming that the information has been submitted. Do ght to ask for any additional information as specified by deem the application incomplete and not ready should reflect all comments made at the previous	m required items for a complete licate by initialing each box in the not initial for items if they are not l on this form, if not included in the for review until this information is
			ubb	le o	n the plan, and shall include any additional requested	
					<ul> <li>Check Box (or Boxes) Above Appropriate</li> </ul>	Columns
Initial	Story Porch or Deck	Accessory Building	Altered Building	New Building	REQUIRED PLAN AND DOCUME	
Below	Porc	SSOF	ere	Nev	¶1 ₩COPIES OF EACH   (unless otherwise spe	
Ψ	1st Story	Acce	Alt		(omess other wise spec	uniedy
TH	•	•	•	•	Proof of notification of the AHRB hearing to owners subject property by certified mailing in the form of an af 300-8.4.G (1) (One copy only, not 9)	
SEE ATTACHED	•	•	•	•	Photo of subject property showing "Under AHRB Review	v" sign as per
EHER	:	1	ł	1	300-8.4.G (2). (One copy only, not 9)	


CONTINUED ON NEXT PAGE

			X		← Check Box (or Boxes) Above Appropriate Columns PAGE 2
Initial Below	1st Story Porch or Deck	Accessory Building	Altered Building	New Building	REQUIRED PLAN AND DOCUMENT SUBMISSION  11 COPIES OF EACH ITEM  (unless otherwise specified)
TH	•	•	•	•	Aerial site location map noting proposed building site and all nearby existing buildings (Google Maps satellite view may be used.)
TH	•	•	•	•	Current Survey
TH	•	•	•	•	Detailed ¾" scale elevations <u>and</u> floor plans of <u>both</u> existing and proposed conditions.
TH	•	•	•	•	Material, finish and color schedule is included <u>on</u> submitted plans.
TH	•	•	•	•	Provide a note on plan indicating that all exterior lighting shall comply with section 300-41
TH	•	•	•	•	Specification sheet for each new exterior light fixture.
TH	•	•	•	•	Site Plan
TH	•	•	•	•	Specification sheets for all new windows and doors.
тн —	•	•	•	•	(One set only, not nine) of actual material, finish and color samples to be presented at AHRB meeting.
TH		•	•	•	Site location plan indicating proposed building site and all relevant buildings as noted in section: 300-4.1.C (3)
TH			•	•	Topographical Site Plan for (but not limited to) context based bulk analysis as per section:
			•	•	300-4.1.C (3)  Mechanical Equipment locations, including visual screening and sound attenuation provisions.
TH			•	•	Table of Zoning Calculations indicating compliance with Dimensional Tables, Appendix B,
		İ	•	•	Table of eave & ridge heights as noted in the Appendix B, Table B-7
			•	•	A scaled streetscape drawing, using the above information, showing the houses on the contiguous lots, facing upon the same street, as the subject property.
			•	•	Diagram of Sky Exposure Plane envelope as per Definitions, section 300.2.1
		Ī	•	•	Landscape Plan
TH			•	•	Sections through important elevations.
			•	•	Sections through typical trim at a scale to clearly show profiles, trims, corners and their sizes.
тн		Ī	•	•	Photos of streetscape as noted in section: 300-4.1.C (3)
TH	•	•	•		Photos of all affected sides of existing structure and context.
					as Haynes Signature: Date: Date:
Complete	e app	olica	tion	rece	eived by the Village of Dobbs Ferry, on behalf of the Dobbs Ferry AHRB by:
ame:					Signature Date

Date Mailed_04-28-2020
Via Certified Mail
Dear Neighbor:  This is a notification that the owner of the property located at:
26 Judson Avenue
Has filed an application with the Village of Dobbs Ferry to do the following:
♣Proposed right side addition and interior alteration- including kitchen renovation, reconfigured space and removal of staircase
The applicant will present the proposal to the following checked Board/Boards at their next available meeting, please check the calendars and agendas on the village web site for the exact date they will first appear before the board:
o Board Of Trustees; meet 2 <sup>nd</sup> & 4 <sup>th</sup> Tuesdays at 7:30 PM o Planning Board; meet 1 <sup>st</sup> Thursday at 8:00 PM o Zoning Board of Appeals; meet 2 <sup>nd</sup> Wednesday at 8:00 PM o Architectural & Historic Review Board; meet 2 <sup>nd</sup> & 4 <sup>th</sup> Mondays at 8:00 PM
The meetings are held in the Village Board room located at 112 Main St and the plans are on file at the Building Department. Any comments or questions pertaining to this application should be voiced at the appropriate board meeting.
Owner name:

Ocule-1"-40' Cuter err

400 Series Double-Hung Window

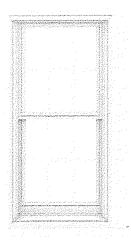

Interior Exterior

SAVE FIND A DEALER PRODUCT REQUEST A DETAILS QUOTE

Product Name	400 Series Double-Hung Window
Product ID#	TW2642
Unit Width	31 5/8"
Unit Height	<i>52 7</i> / 8"
Interior Color	White
Glass	Low-E4® Glass
Hardware	Standard Lock and Keeper, White
Optional Hardware	None, White
Grille Pattern	Colonial
Grille Width	3/4"
Exterior Color	White
Exterior Trim Profile	3.5" Flat w/ Sill Nose
Exterior Trim Color	White

<sup>\*</sup> Distressed bronze and oil rubbed bronze are 'living' finishes that will change with time and

<sup>\*</sup> Options shown are not available for all products within the series. Computer monitor limitations prevent exact color duplication. For an accurate representation of color options please view actual color samples available at your Andersen window & patio door supplier.




## TILT-WASH FULL-FRAME WINDOWS


#### **Table of Tilt-Wash Double-Hung Window Sizes**

Scale  $\frac{1}{8}$ " (3) = 1'-0" (305) - 1:96

Window Dimension	1'-9 5/8"	2'-1 <sup>5</sup> /8"	2'-5 <sup>5</sup> /8" (752)	2'-7 5/8"	2'-9 <sup>5</sup> /8" (854)	2'-11 <sup>5</sup> /8" (905)	3'-1 <sup>5</sup> /8" (956)	3'-5 <sup>5</sup> /8" (1057)	3'-9 <sup>5</sup> /8" (1159)	
Minimum Rough Opening	1 <sup>1</sup> -10 <sup>1</sup> /8" (562)	2'-2 <sup>1</sup> /8" (664)	2'-6 <sup>1</sup> /8" (765)	2'-8 ½" (816)	2'-10 <sup>1</sup> /8" (867)	3'-0 <sup>1</sup> /8" (917)	3'-2 1/8" (968)	3'-6 <sup>1</sup> /8" (1070)	3'-10 <sup>1</sup> /8" (1172)	<b>»</b> .
Unobstructed Glass (lower sash only)	15" (381)	19" (483)	23" (584)	25" (635)	(686)	29" (737)	31" (787)	35" (889)	39" (991)	7
		WIDTHS — 2	1 5/8" to 45 5	/8 <sup>11</sup>						Alexandra.
1140) (1038) 30 7/g" (377) (1038) (937) (1038) (937) (1038) (937) (1038) (937) (1038) (937) (1038)										Custom-size windows are available in 1/8" (3) increments
36 76	TW18210	TW20210	TW24210	TW26210	TW28210	TW210210	TW30210	TW34210	TW38210	
3-4 7/8" (1038) 3-4 7/8" (1038) 15 15/16" (405)			1 1 1							
	TW1832	TW2032	TW2432	TW2632	TW2832	TW21032	TW3032	TW3432	TW3832	Cottage or reverse cottage sash ratio
3'-8 7/8" (1140) 3'-8 7/8" (1140) (1140) 17 15/16" (456) custor										available for these heights in all widths. Size tables for cottage or revserse cottage
<b>-</b>	TW1836	TW2036	TW2436	TW2636	TW2836	TW21036	TW3036	TW3436	TW3836	sash are avilable at andersenwindows.com.
4'-0 7/8" (1241) 4'-0 7/8" (1241) 19 15/16" (506)										
4 2 4 2 1	<b>TW</b> 18310	<b>TW</b> 20310	TW24310	<b>TW</b> 26310	<b>TW</b> 28310	TW210310	TW30310	TW34310	TW38310	Cottage Reverse Cotta <sub>{</sub>
4.4 7/8" (1343) 4.4 7/8" (1343) (1343) (1343) (21 15/16"								n 100 pt. 1		
4.47/8" (1343) 4.47/8" (1343) 21 15/16" (557)										
	TW1842	TW2042	<b>TW</b> 2442	TW2642	<b>TW</b> 2842	TW21042	TW3042	TW3442	<b>TW</b> 3842	
4'-8 7/8" (1445) 4'-8 7/8" (1445) 23 15/16" (608)										
	T <b>W</b> 1846	<b>TW</b> 2046	TW2446	<b>TW</b> 2646	TW2846	TW21046	TW3046°	TW3446°	TW3846°	
6) //8" (6) (6) /16"										
5'-0 7/8" (1546) 5'-0 7/8" (1546) 25 15/16" (659)										
	TW18410	<b>TW</b> 20410	TW24410	TW26410	<b>TW</b> 28410	TW210410°	TW30410°	TW34410°	TW38410°	
5'-4 7/8" (1648) 5'-4 7/8" (1648) 27 15/16" (710)			To a state of the							
5'-4 (164 5'-4 (164 27 15 (71)		3 1 2 2 2 2 2 2 2 2 2 2 2 2 2 2 2 2 2 2								
	TW1852	TW2052	TW2452	TW2652	TW2852°	TW21052°	TW3052°	TW3452°	TW3852°	
5-8 7/8" (1749) 5-8 7/8" (1749) (29 15/16" (760)										
(1) (1) (1) (2)				AMOUNT OF THE PARTY OF THE PART						
	TW1856	TW2056	TW2456	TW2656	TW2856°	TW21056°	TW3056°	TW3456°	TW3856°	
6.0 7/8" (1851) 6.0 7/8" (1851) 31 15/16" (811)										
6-4 (18 (18 (18 (8)										
	TW18510	TW20510	TW24510°	TW26510	TW28510°	TW210510°	TW30510°	<b>TW</b> 34510⁰	TW38510°	<ul> <li>"Window Dimension" always refers to outside frame to frame dimension.</li> <li>"Minimum Rough Opening" dimensions</li> </ul>
3) 3) 3) 3) 16" 16"										may need to be increased to allow for use of building wraps, flashing, sill panning, brackets, fasteners or other items.
6'-4 7/8" (1953) 6'-4 7/8" (1953) 33 15/16" (862)										Dimensions in parentheses are in millimeters.     Meet or exceed clear opening area of     5.7 sq.ft. or 0.53 m², clear opening width of
	TW1862	TW2062	TW2462°	TW2662°	TW2862°	TW21062°	TW3062°	TW3462°	TW3862 <sup>◊</sup>	20" (508) and clear opening height of 24" (610).
								C	ontinued on next page	

#### **Three Patio Door Heights**

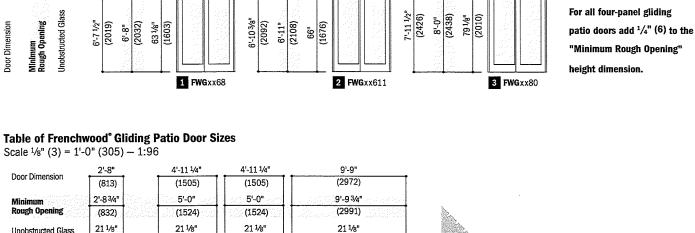

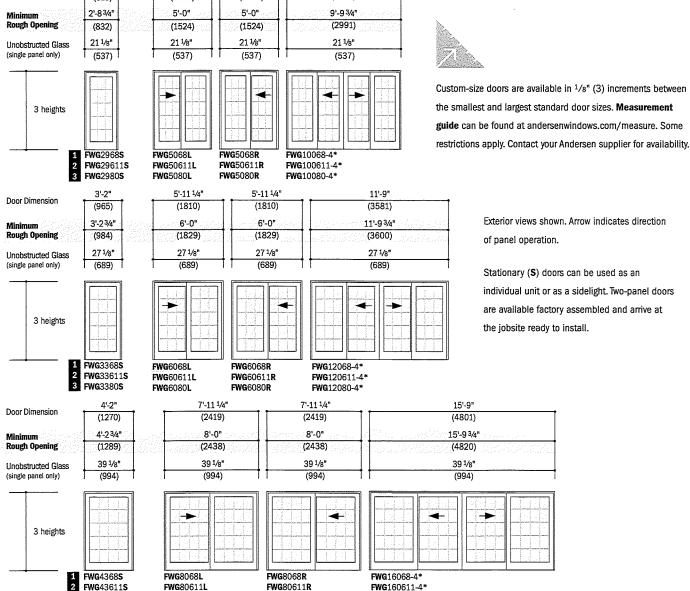

 <sup>&</sup>quot;Door Dimension" always refers to outside frame to frame dimension.

FWG4380S

FWG8080R

FWG16080-4\*

FWG8080L

<sup>• &</sup>quot;Minimum Rough Opening" dimensions may need to be increased to allow for use of building wraps, flashing, sill panning, brackets, fasteners or other items.

Dimensions in parentheses are in millimeters

<sup>\*</sup>Add 1/4" (6) to the "Minimum Rough Opening" height dimension for four-panel doors.



#### **Custom Patio Door Size Range**



Available in 1/8" (3) increments between minimum and maximum widths and heights. Some restrictions apply, contact your Andersen supplier. Measurement guide for custom sized patio doors can be found at andersenwindows.com/measure.

#### **Single Stationary Panel**

ANDERSEN\* 400 SERIES FRENCHWOOD' GLIDING PATIO DOORS

ANDERSEN 200 SERIES NARROLINE® & PERMA-SHIELD® GLIDING PATIO DOORS

#### 2-Panel


ANDERSEN 400 SERIES FRENCHWOOD GLIDING PATIO DOORS

ANDERSEN 200 SERIES NARROLINE & PERMA-SHIELD GLIDING PATIO DOORS

#### 4-Panel

ANDERSEN 400 SERIES FRENCHWOOD GLIDING PATIO DOORS

ANDERSEN 200 SERIES NARROLINE GLIDING PATIO

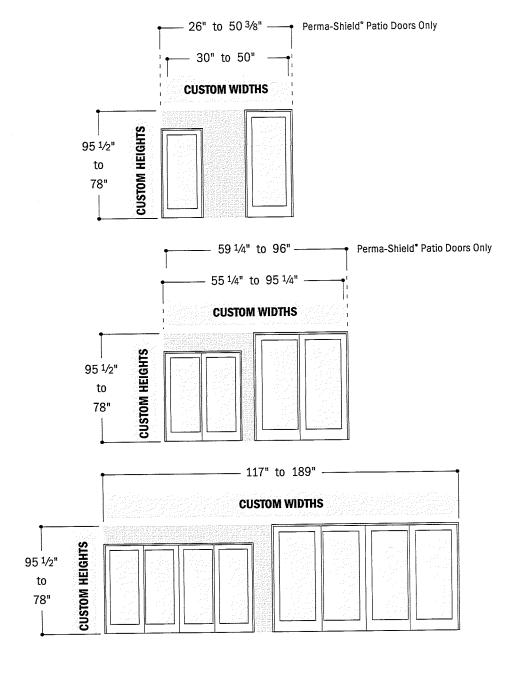

<sup>&</sup>quot;Door Dimension" always refers to outside frame to frame dimension.
Dimensions in parentheses are in millimeters.



#### FRENCHWOOD® GLIDING PATIO DOORS

## Frenchwood® Gliding Patio Door Opening and Area Specifications


		Clear Opening in	Full Open Position	Glass		Overall Door
Door Number	Clear Openi Sq. Ft./(m <sup>2</sup>		Height Inches/(mm)	Area Sq. Ft./(m²)	Vent Sq. Ft./(m²)	Area Sq. Ft./(m²)
FWG2968			-	9.26 (0.86)	_	17.67 (1.64)
FWG3368	_	Para Para A	4 <del>-</del>	11.89 (1.11)		20.98 (1.95)
FWG4368	-	nt Jana Ethiofia.	-	17.15 (1.59)	_	27.60 (2.56)
FWG5068	11.58 (1.0	8) 22 1/8" (562)	75 <sup>3</sup> / <sub>8</sub> " (1915)	18.52 (1.72)	11.58 (1.08)	32.71 (3.04)
FWG6068	14.72 (1.3	7) 28 ½" (714)	75 3/8" (1915)	23.78 (2.21)	14.72 (1.37)	39.34 (3.66)
FWG8068	21.00 (1.9	5) 40 ½" (1019)	75 <sup>3</sup> / <sub>8</sub> " (1915)	34.30 (3.19)	21.00 (1.95)	52.59 (4.89)
FWG10068	23.42 (2.1	.8) 44 <sup>3</sup> / <sub>4</sub> * (1137)	75 <sup>3</sup> / <sub>8</sub> " (1915)	37.04 (3.44)	23.42 (2.18)	64.59 (6.00)
FWG12068	29.70 (2.7	'6) 56 <sup>3</sup> / <sub>4</sub> " (1441)	75 3/8" (1915)	47.55 (4.42)	29.70 (2.76)	77.84 (7.23)
FWG16068	42.27 (3.9	3) 80 <sup>3</sup> / <sub>4</sub> " (2051)	75 <sup>3</sup> / <sub>8</sub> " (1915)	68.60 (6.37)	42.27 (3.93)	104.34 (9.69)
FWG29611	_	in data filosofi	(t	9.68 (0.90)	<u> </u>	18.31 (1.70)
FWG33611	_	49 th <del>1</del> 40 th	<u>-</u>	12.43 (1.16)		21.74 (2.02)
FWG43611	_	46940 <del>-</del> 93555	, -	17.93 (1.67)		28.60 (2.66)
FWG50611	12.04 (1.:	12) 22 ½ (562)	78 ³/ <sub>16</sub> " (1987)	19.36 (1.80)	12.04 (1.12)	33.89 (3.15)
FWG60611	15.31 (1.4	12) 28 ½" (714)	78 ³/ <sub>16</sub> " (1987)	24.86 (2.31)	15.31 (1.42)	40.76 (3.79)
FWG80611	21.84 (2.	03) 40 ½" (1019)	78 <sup>3</sup> / <sub>16</sub> " (1987)	35.85 (3.33)	21.84 (2.03)	54.49 (5.06)
FWG100611	24.36 (2.3	26) 44 3/4" (1137)	78 <sup>3</sup> / <sub>16</sub> " (1987)	38.72 (3.60)	24.36 (2.26)	66.93 (6.22)
FWG120611	30.89 (2.	37) 56 <sup>3</sup> / <sub>4</sub> " (1441)	78 <sup>3</sup> / <sub>16</sub> " (1987)	49.71 (4.62)	30.89 (2.87)	80.66 (7.49)
FWG160611	43.95 (4.	08) 80 ³/₄" (2051)	78 <sup>3</sup> / <sub>16</sub> " (1987)	71.71 (6.66)	43.95 (4.08)	108.12 (10.04)
FWG2980	-	vysálta <del> f</del> ilajás	<i></i>	11.60 (1.08)	<u> </u>	21.22 (1.97)
FWG3380	-	farait-sinc	ş <del>-</del>	14.90 (1.38)	<u> </u>	25.20 (2.34)
FWG4380	- ·	(45,41,-34,6)	,	21.49 (2.00)	<del>-</del>	33.16 (3.08)
FWG5080	14.04 (1.	30) 22 1/8" (562)	91 3/8" (2321)	23.20 (2.16)	14.04 (1.30)	39.29 (3.65)
FWG6080	17.85 (1.	66) 28 ½" (714)	91 3/8" (2321)	29.80 (2.77)	17.85 (1.66)	47.25 (4.39)
FWG8080	25.46 (2.	37) 40 ½" (1019)	91 3/8" (2321)	42.98 (3.99)	25.46 (2.37)	63.17 (5.87)
FWG10080	28.40 (2.	64) 44 3/4" (1137)	91 3/8" (2321)	46.40 (4.31)	28.40 (2.64)	77.59 (7.21)
FWG12080	36.01 (3.	35) 56 <sup>3</sup> / <sub>4</sub> " (1441)	91 3/8" (2321)	59.60 (5.54)	36.01 (3.35)	93.51 (8.69)
FWG16080	Principle (1-7)	76) 80 3/4" (2051	91 3/8" (2321)	85.96 (7.99)	51.24 (4.76)	125.34 (11.64)

<sup>•</sup> Dimensions in parentheses are in millimeters or square meters.

## Proposed Alterations at:

# **26 JUDSON AVENUE**

DOBBS FERRY, NEW YORK

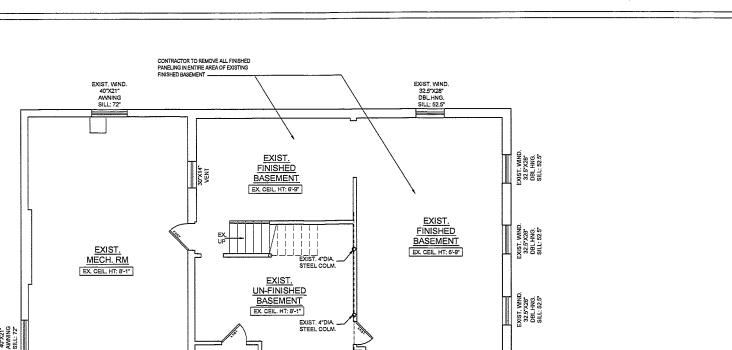

EXIST. UN-FINISHED BASEMENT

DROPPED PIPE @ \_\_\_\_\_\_ 67" A.F.F

Village of Dobbs Ferry

DYUS I YAM



#### 2016 IECC - CODE

DESCRIPTION	REQUIRED	PROPOSED
CEILING	R-49	R-49
WOOD FRAME WALL	R-20+6 or 13+10	R-20+5
MASS WALL	R-15/20	N.A.
FLOOR	R-30	R-30
BASEMENT WALL	R-15/19	N.A.
SLAB FLOOR	R-10 / 4-FT.	N.A.
CRAWL SPACE WALL	R-15/19	N.A.

DESCRIPTION	COMMENTS	REQUIRED	PROPOSED
FENESTRATION	DOUBLE PANE, LOW E WITH ARGON	0.32	0.25

NOTES:

1. ALL NEW WINDOWS SHALL HAVE INSULATED GLASS

# Building Department



NOTE: CHART UPDATED AS PER THE 2016 SUPPLEMENT NYS ECCC

CODE DESIGN APPROACH: CHAPTER 4 (TABLE 402.1.2)
HEATING TYPE: GAS FIRED FORCED HOT AIR

DESCRIPTION	REQUIRED	PROPOSED
CEILING	R-49	R-49
WOOD FRAME WALL	R-20+6 or 13+10	R-20+5
MASS WALL	R-15/20	N.A.
FLOOR	R-30	R-30
BASEMENT WALL	R-15/19	N.A.
SLAB FLOOR	R-10/4FT.	N.A.
CRAWL SPACE WALL	R-15/19	N.A.

DECORAL FIGURE	OCHINE, TIE		11105 0000
FENESTRATION	DOUBLE PANE, LOW E WITH ARGON	0.32	0.25

- 1. ALL NEW WINDOWS SHALL BEY CLIV WATHERSTRIPPD
  2. PLOVIDE CAULING AROUND ALL DOORS AND WINDOWS TO PREVENT AIR
  INFLITATION THO BUILDING
  4. PROVIDE CAULING AROUND ALL FLOOR & CELLING PENETRATIONS (MECHANICAL,
  PLIVIABING AND ELECTRICAL)
  5. ALL NEW INSULATIONS TO BE FIBERGLASS BATT. WITH FOIL FACED VAPOR BARRIER

I, THOMAS E. HAYNES CERTIFY THAT THE DESIGN SHOWN ON THESE CONSTRUCTION DOQUMENTS IS IN COMPLIANCE WITH ALL REQUIREMENTS OF THE 2015 INTERNATIONAL, EVERGY CONSERVATION CONSTRUCTION CODE AND THE 2016 EMERGY CODE SUPPLEMENT

#### BASEMENT FLOOR DEMOLITION PLAN

NOTE: ALL EXISTING FRAMING TO BE VERIFIED IN FIELD BY CONTRACTOR PRIOR TO ANY DEMOLITION OR CONSTRUCTION -NOTIFY ARCHITECT IF ANY DISCREPANCY

SCALE: 1/4" = 1'-0"

#### SMOKE DETECTOR NOTES

PROVIDE DETECTORS AS PER SECTION R314 OF THE 2015 IRC

DEVICES TO BE LOCATED AS FOLLOWS:

EXISTING UN-FINISHED BASEMENT

1.) REMOVE EXISTING WOOD STAIR AND 1.) REMOVE EXISTING WOOD STATE AND DRYER-RAILINGS
2.) REMOVE EXISTING WASHER AND DRYER-LICENSED PLUMBER TO CAP AND SEAL ALL LINES AS REQUIRED 4 AUNORY TO BE RELOCATED TO 2ND FLOOR

DEVICES LOCATED IN AREAS WHERE INTERIOR WALL OR CILLING FINISHES ARE NOT REMOVED TO EXPOSE THE STRUCT CAN BE BATTERY OFERATED AND ARE NOT REQUIRED TO BE INTERCONNECTED, EXCEPT THAT INTERCONNECTION IS REQUIRED IT THE ROOMS CAN BE ACCESSED THROUGH THE ATTER CADO.

#### CARBON MONOXIDE ALARM NOTES

DEVICES TO BE LOCATED AS FOLLOWS:

1. ONE FOR EACH STORY HAVING A SLEEPING AREA 2. ONE FOR EACH STORY WHERE FUEL FIRED APPLIANCES AND EQUIPMENT OR ATTACHED GARAGES ARE LOCATED DEVICES LOCATED IN AREAS WHERE INTERIOR WALL OR CEILING FINISHES ARE NOT REMOVED TO EXPOSE THE STRUCTURE CAN BE BATTERY OPERATED AND ARE NOT REQUIRED TO BE INTERCONNECTED. ALARMS MUST BE LOCATED WITHIN 10 FEET OF ANY BEDROOM DOOR AND MUST HAVE A DIGITAL READ-OUT

NOTE: THESE DRAWINGS HAVE BEEN DESIGNED IN ACCORDANCE WITH THE 2015 IRC

NOTE: THESE DRAWINGS HAVE BEEN DESIGNED IN ACCORDANCE WITH THE 2017 NEW YORK STATE UNIFORM CODE SUPPLEMENT

NOTE: THESE DRAWINGS HAVE BEEN DESIGNED IN ACCORDANCE WITH THE 2016 NYS IECC SUPPLEMENT NOTE: THESE DRAWINGS HAVE BEEN DESIGNED IN COMPLIANCE WITH THE 2016 IECC


#### PROJECT DIRECTORY

ARCHITECT:

HAYNES ARCHITECTURE P.C 570 YONKERS AVENUE YONKERS, NY 10704 TELEPHONE: (914) 963-3838 (914) 963-3861 EMAIL: INFO@HAYNESDESIGNGROUP.COM

OWNER:

ROBERT MUSLINER / TALI AMIR 26 JUDSON AVENUE DOBBS FERRY, NY TELEPHONE: (609) 933-4717 EMAIL: RMUSLINER@GMAIL.COM

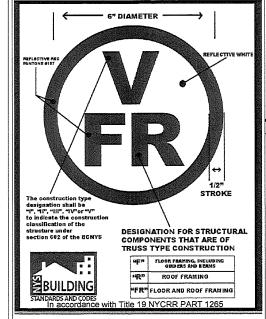

3.120-116-6 Printkey/TaxID: ZONE: OF3



#### **LOCATION PLAN / PLOT PLAN**

A001

Proposed Alterations at: **26 JUDSON** Dobbs

project title:

AVENUE

**New York** 

Ferry

HAYNES ARCHITECTURE P.C.

570 yonkers ave. yonkers, ny 10704

e: info @ havnesdesiangroup.com


date: 02-10-2020 drawn by: TJH checked by: TEH


SCALE N.T.S.


NO YES NO B SEVERE 3'-8" Moderate To Heavy 15deg.F


FLOOD HAZ ARDS:
A). First code date of adoption July 9, 1980
B). Date of Flood insurance Study Jan. 21 1999
C). Map panel numbers 38119C0307F through 38119C0338F effective Sept.28, 2007

CLIMATIC AND GEOGRAPHIC DESIGN CRITERIA

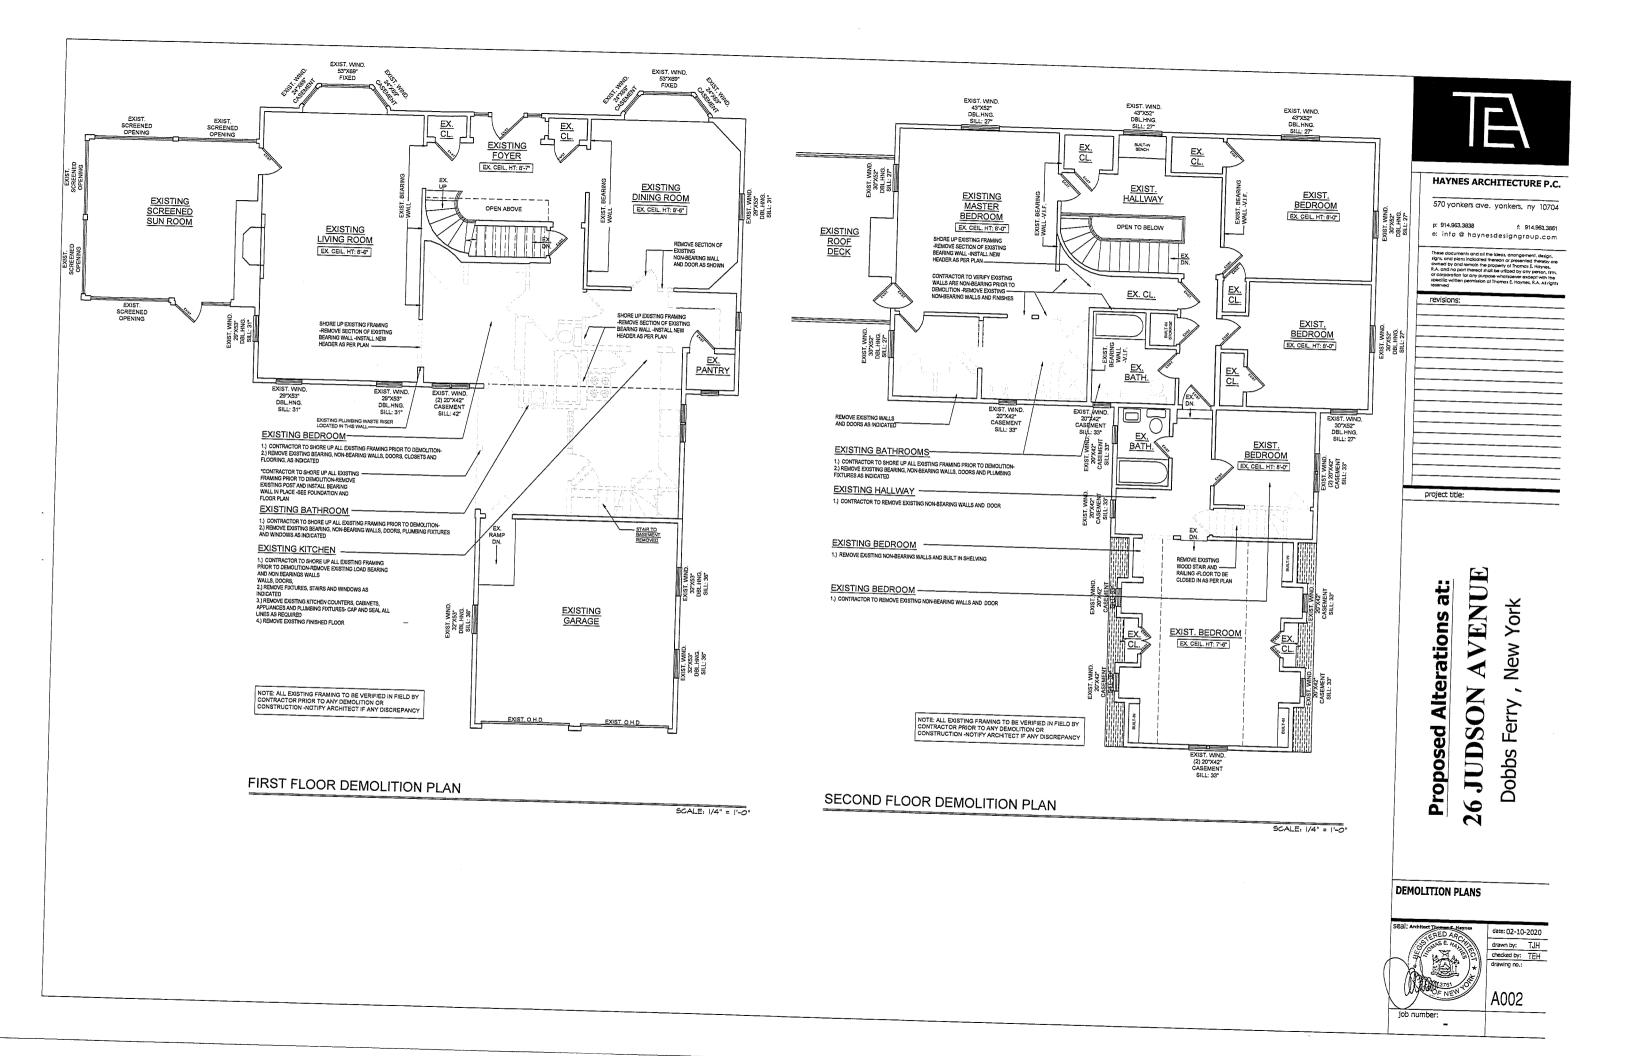

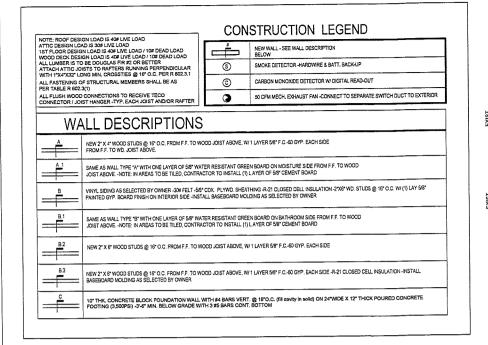

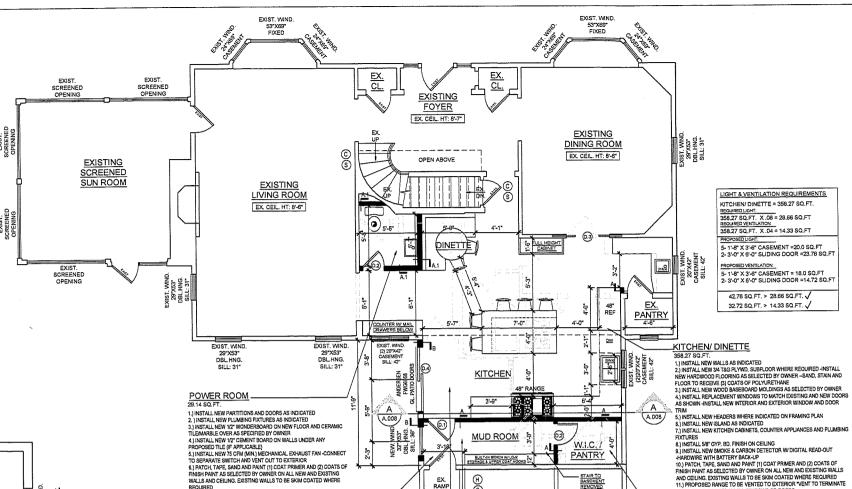

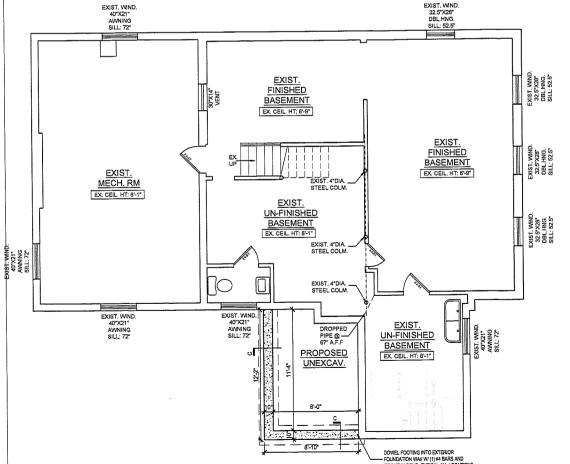

**BASEMENT FLOOR PLAN** 

#### FIRST FLOOR PLAN

SCALE: 1/4" = 1'-0

REQUIRED
7.) INSTALL NEW VANITY, MIRRORS, LIGHT FIXTURES AND HARDWARE AS SELECTED BY OWNER

2.) INSTALL NEW 2" TAG PLYWOOD SUBFLOOR IN REQUIRED AREAS
3.) INSTALL NEW 12" WONDERBOARD (OR APPROVED EQUAL) WITH NEW CERAM!
TILE OR STONE FLOORING (AS SELECTED BY OWNER) OVER WOOD SUBFLOOR

AND JOISTS
4, INSTALL NEW WOOD BASEBOARD MOLDINGS AS SELECTED BY OWNER
5, PATCH TAPE, SAND AND PAINT (1) COAT PRIMER AND (2) COATS OF FINISH
PAINT AS SELECTED BY OWNER ON ALL WALLS AND CEILING.

6 ) INSTALL NEW BUILT-IN BENCH SEAT WITH INTEGRATED STORAGE AND COAT

HOOKS OVER AS SELECTED BY OWNER -COORDINATE WITH MILLWORKER AND/OF

1.) INSTALL NEW PARTITIONS AND DOORS AS INDICATED

7.) INSTALL 5/8" GYP, BD. FINISH ON CEILING

MUDROOM -

DOOR TYPE SCHEDULE DOOR TYPE NO. REMARKS 1 3/4" SOLID CORE DOOR SHAKER STYLE DOOR -SINGLE PANEL -HARDWARE PROVIDED BY OWNER -HINGES AS SPECIFIED BY OWNER AND SUPPLIED BY DOOR MANUFACTURER 0.1 30"X80" SWING 1 3/4" SOLID CORE DOOR SHAKER STYLE DOOR -SINGLE PANEL HARDWARE PROVIDED BY OWNER -HINGES AS SPECIFIED BY OWNER AND SUPPLIED BY DOOR MANUFACTURER 0.2 (2) 24°X80° POCKET 1 3/4° SOLID CORE DOOR SHAKER STYLE DOOR -SINGLE PANEL HARDWARE PROVIDED BY OWNER HINGES AS SPECIFIED BY OWNER AND SUPPLIED BY DOOR MANUFACTURER (2) 36"X80" SLIDING 1 3/4" THICK SOLID CORE INSULATED ENTRY DOOR -STAIN GRADE WOOD -STYLE AND MANUFACTURER AS SELECTED BY OWNER 1 3/4" SOLID CORE DOOR SHAKER STYLE DOOR -SINGLE PANEL -HARDWARE PROVIDED BY OWNER -HINGES AS SPECIFIED BY OWNER AND SUPPLIED BY DOOR MANUFACTURER D.5 28"X80" 1 3/4" SOLID CORE DOOR SHAKER STYLE DOOR -SINGLE PANE HARDWARE PROVIDED BY OWNER -HINGES AS SPECIFIED BY OWNER AND SUPPLIED BY DOOR MANUFACTURER (D.6) (2)36"X80" SWING

\*\* NOTE: ALL INSULATED, TYPE "B" LABEL AND ENTRY DOORS TO BE WEATHER STRIPPED AND W/ U-VALUE OF u0.35 MAX



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5.) INSTAL, NEW HEADERS WHERE INDICATED ON FRAMING PLAN
5.) INSTALL NEW ISLAND AS NOICATED
7.) INSTALL NEW KITCHEN CABINETS, COUNTER APPLIANCES AND PLUMBING
FIXTURES
8.) INSTALL SE' GYP. BD. FINISH ON CEILING
8.) INSTALL SE' GYP. BD. FINISH ON CEILING
9.) INSTALL NEW SMOKE & CARBON DETECTOR WIDIGITAL READ-OUT
HARDWIRE WITH BATTERY BACK-UP
10.) PATON, TABLE SHAD AND PAINT (1) COAT PRIMER AND (2) COATS OF
FINISH PAINT AS SELECTED BY OWNER ON ALL NEW AND EXISTING WALLS
AND CEILING. EXISTING WALLS TO BE SKIM COATED WHERE REQUIRED
1). PROPAGES BANGET OB BE VENDED TO EXTERNO "VENT TO TERMINATE
AMIN. OF 38" AWAY FROM ALL WINDOWS OR DOORS
WILL CL. P. ANTITY.

W.I.C/ PANTRY 24.24 SQ.FT.

32") 32") 38L SILL

PANTRY

BUILT-IN BENCH W/LOW STORAGE & UPPER COAT HOOKS

INSTALL 2"X6" WD. SLEEPERS W/ R-19 BATT. INSULATION IN THE CAVITY OVER 4" CONC SLAB W/ 6-6 10/10 WWM -6 MIL VAPOR BARRIER -4" GRAVEL

EXISTING GARAGE

1 HINSTALL NEW PARTITIONS AND DOOR AS INDICATED 2) INSTALL NEW 2 TAG PLYWOOD SUBFLOOR OVER NEW WOOD JOISTS IN AREAS OF REMOVED STAIR

AREAS OF REMOVED STAIR

3.) IN LOCATION OF NEW TILE FLOORING: ADD NEW 12" PERMARASE CEMENT
BOARD SUBFLOOR (OR APPROVED EQUAL) WITH NEW CERAMIC TILE OR STONE
FLOORING OVER WOOD JOISTS AS SELECTED BY OWNER
4.) INSTALL NEW WOOD BASEBOARD MOLDINGS AS SELECTED BY OWNER
5.) PATCH TAPE, SAND AND PAINT (1) COAT PRIMER AND (2) COATS OF FINISH
PAINT AS SELECTED BY OWNER ON ALL WALLS AND CEILING.
6.) INSTALL 50" GYP, BD. FINISH ON CIELING.

NOTE: CONTRACTOR TO PROVIDE CLOTHES POLE & SHELF AT ALL CLOSET LOCATIONS -COORDINATE PANTY SHELVING AND ALL BUILT-IN MILLWORK WITH CONTRACTOR AND/OR MILLWORKER -SHOP DRAWINGS TO BE PRESENTED TO OWNER FOR REVIEW AND APPROVAL

NOTE: ALL EXISTING FRAMING TO BE VERIFIED IN FIELD BY CONTRACTOR PRIOR TO ANY DEMOLITION OR CONSTRUCTION -NOTIFY ARCHITECT IF ANY DISCREPANCY

NOTE: ALL EXISTING WINDOWS TO BE REPLACED WITH NEW TO MATCH EXISTING

NOTE: ALL EXISTING HARDWOOD FLOORING TO BE SANDED, STAINED AS PER OWNER'S SUGGESTION AND FINISHED WITH (3) COATS OF POLYURETHANE

SCALE: 1/4" = 1'-0"

FLOOR PLANS / DOOR SCHEDULE / WALL LEGEND

AVENUE

**JUDSON** 

9

York

New

Dobbs




iob number:

A003

date: 02-10-2020

drawn by: TJH

checked by: TEH

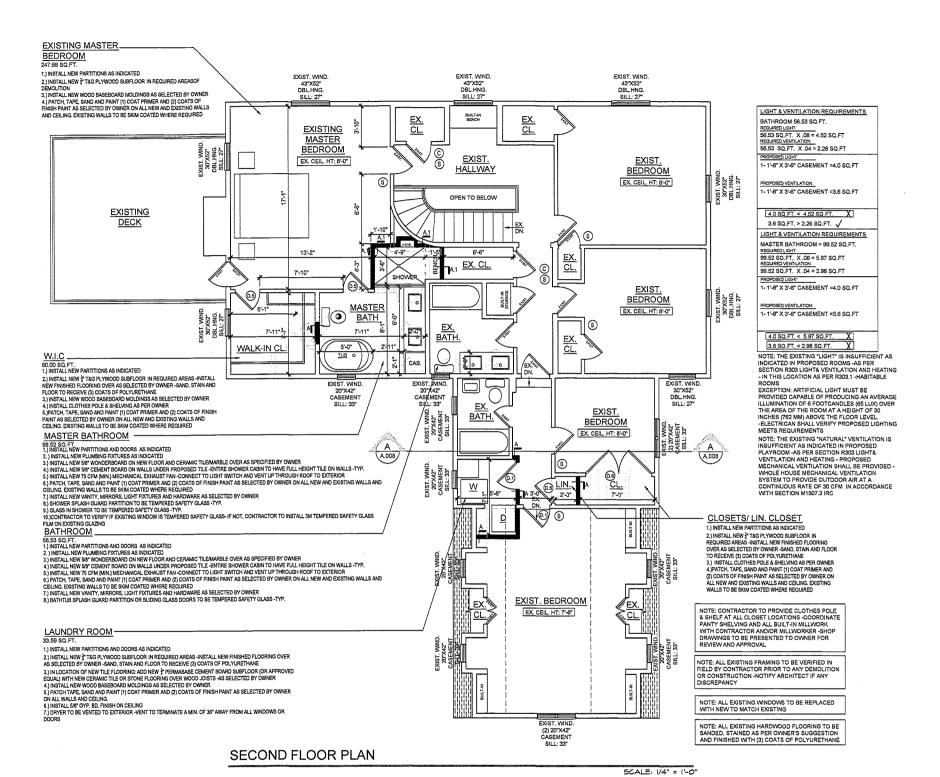

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These documents and all the ideas, arrangement, design, stans, and plans indicated thereon or presented thereby an

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	revisions:		
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project title:

**Alterations** 

**Proposed** 

H VENUI York New V ON Ferry JUDS Dobbs

9


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FLOOR PLAN



date: 02-10-2020 checked by: TEH drawing no.:

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AVENUE Alterations at: JUDSON

LIGHTING / ELECTRIC FLOOR PLANS

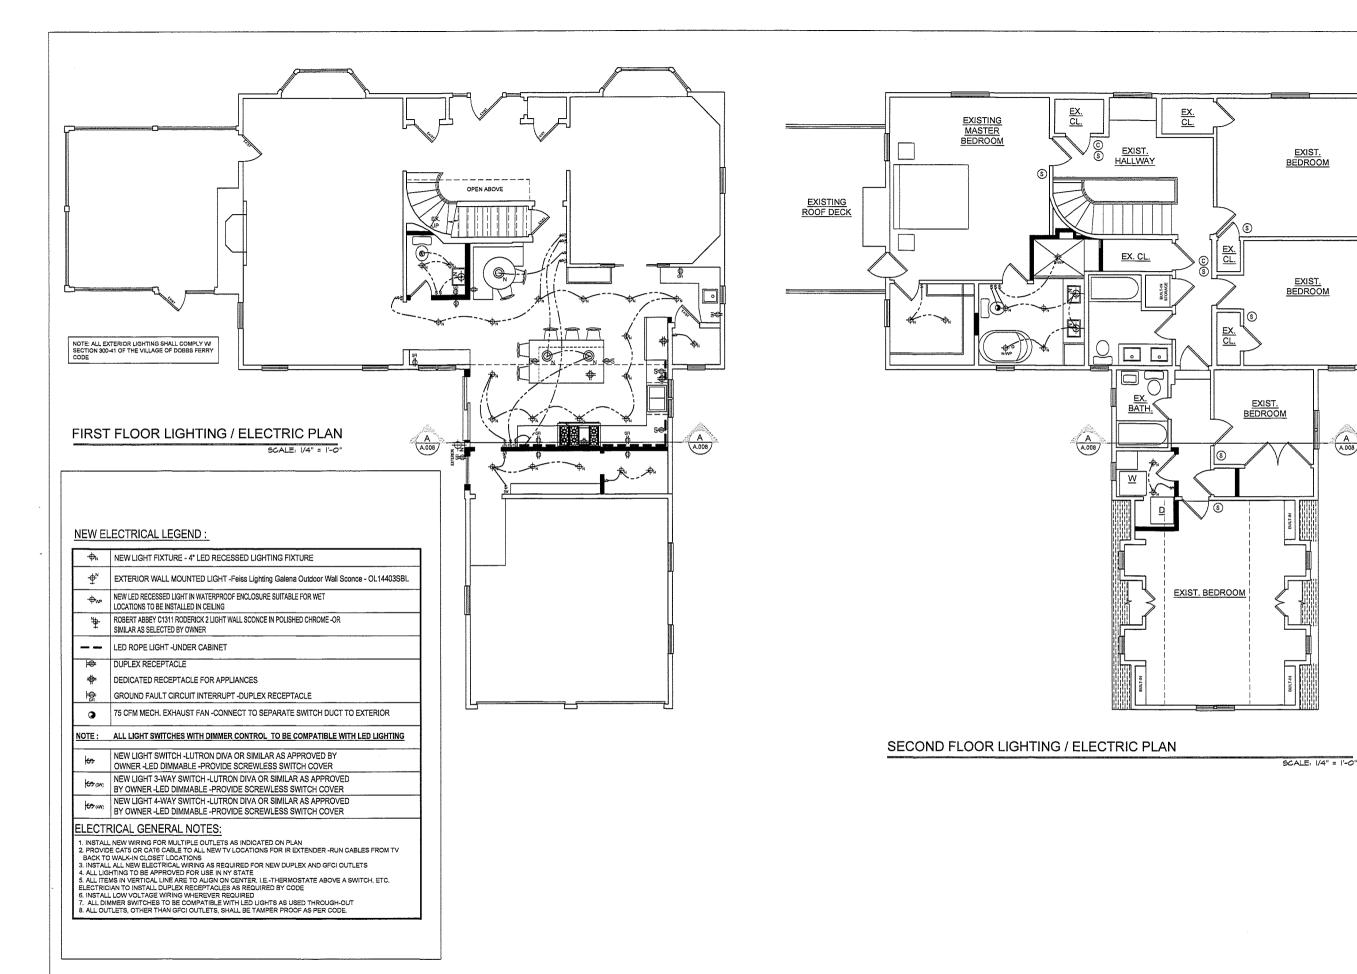9

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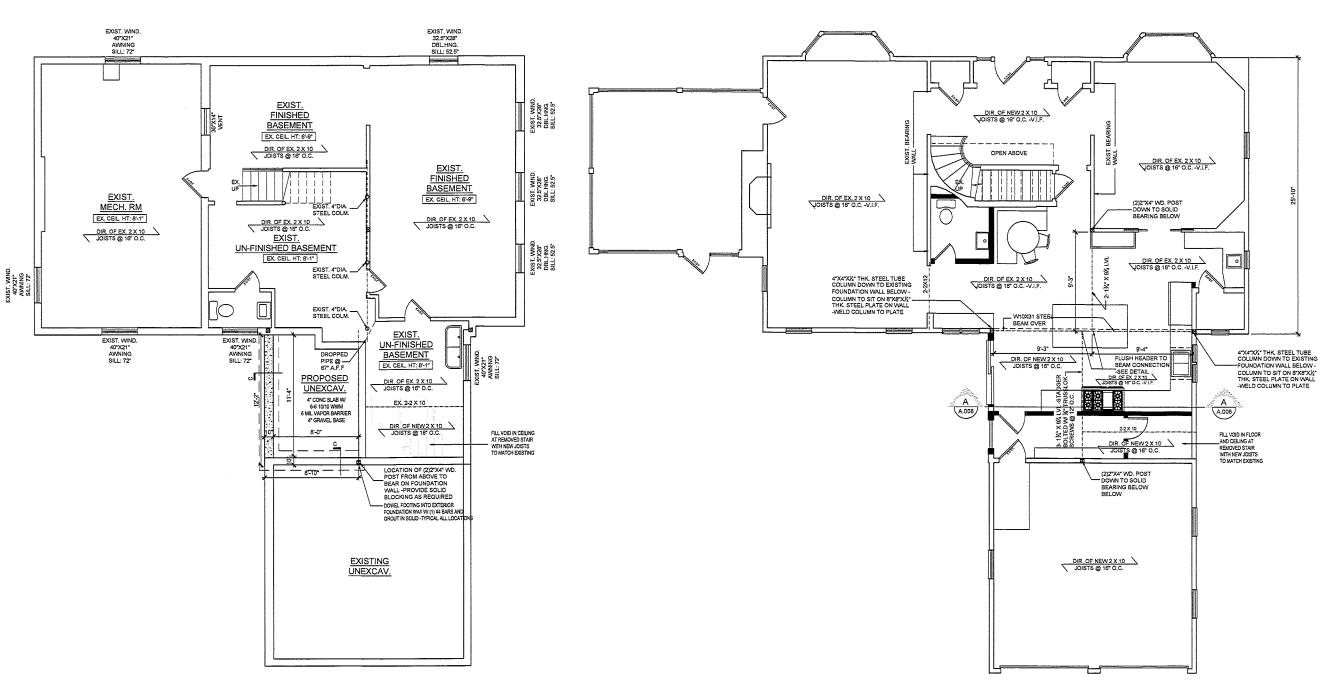
**Proposed** 

A005

date: 02-10-2020

Dobbs

drawn by: TJH checked by: TEH



SCALE: 1/4" = 1'-0"

FIRST FLOOR FRAMING PLAN

BASEMENT FLOOR FRAMING PLAN



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p: 914.963,3838 f: 914.963.3861

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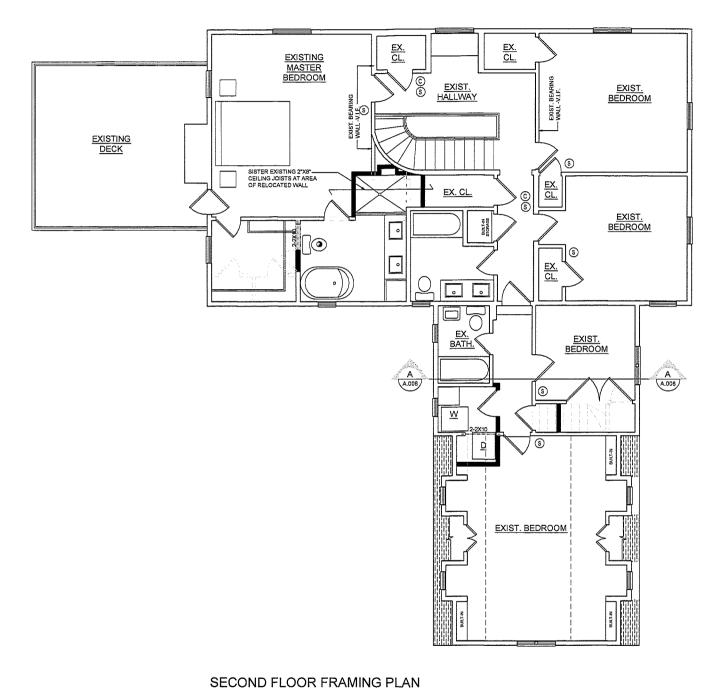
Proposed Alterations at:

VENUE New York A 26 JUDSON Dobbs Ferry

FRAMING FLOOR PLANS

date: 02-10-2020 drawn by: TJH checked by: TEH

SCALE: 1/4" = 1'-0'



SCALE: 1/4" = 1'-0"



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project title:

AVENUE Proposed Alterations at: 26 JUDSON


Dobbs Ferry, New York


FRAMING FLOOR PLANS



A007

date: 02-10-2020 drawn by: TJH
checked by: TEH
drawing no.:

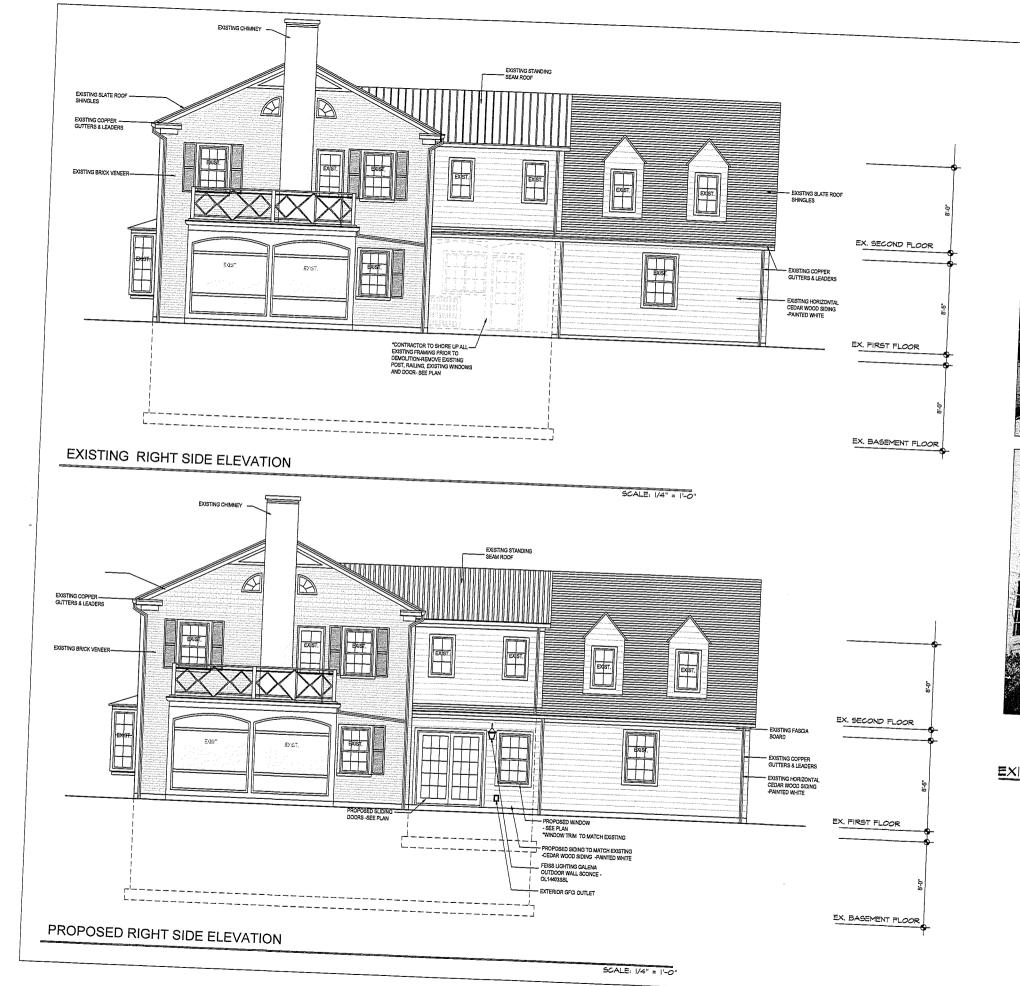

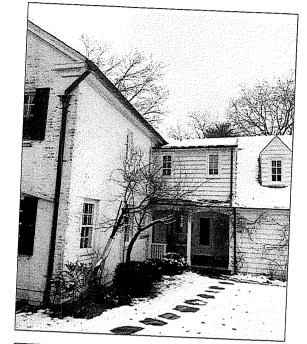



EXISTING PARTIAL RIGHT SIDE ELEVATION



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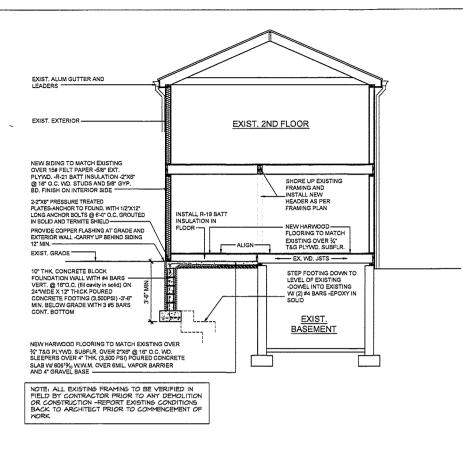
project title:

26 JUDSON AVENUE Proposed Alterations at: , New York Dobbs Ferry

**ELEVATIONS** 


date: 02-10-2020

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#### **SECTION A-A**


SCALE: 1/4" = 1'-0'



For SI: 1 inch = 25.4 mm.
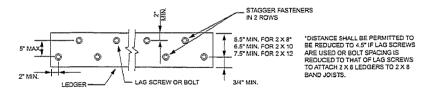
#### TYPICAL BOLTING PATTERN DETAIL


R403.1.5 SLOPE. THE TOP SURFACE OF FOOTINGS SHALL BE LEVEL. THE BOTTOM SURFACE OF FOOTINGS SHALL NOT HAVE A SLOPE EXCEEDING ONE UNIT VERTICAL IN 10 UNITS HORIZONTAL (10-PERCENT SLOPE), FOOTINGS SHALL BE STEPPED WHERE IT IS NECESSARY TO CHANGE THE ELEVATION OF THE TOP SURFACE OF THE FOOTINGS OR WHERE THE SLOPE OF THE BOTTOM SURFACE OF THE FOOTINGS WILL EXCEED ONE UNIT VERTICAL IN TEN UNITS HORIZONTAL (10-PERCENT SLOPE) IN CONFORMANCE WITH FIGURE R403.15.

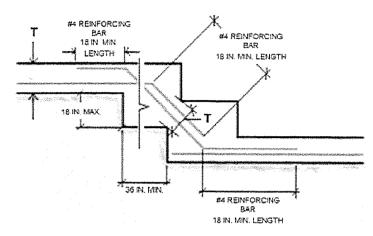

NOTES: T = FOOTING THICKNESS THE MINIMUM FOOTING THICKNESS, T, IN STEPPED AREAS SHALL EQUAL THE FOOTING THICKNESS IN THOSE UNSTEPPED AREAS. THE REINFORCING BAR SIZE IN STEPPED AREAS SHALL EQUAL THE BAR SIZE IN THOSE UNSTEPPED AREAS. A MINIMUM OF 3 INCHES OF CONCRETE IS REQUIRED AROUND ALL REINFORCING BARS

#### STEPPED FOOTING DETAIL

SCALE: N.T.S.

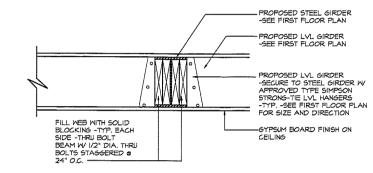

### FLUSH BEAM / GIRDER DETAIL 'C

SCALE: 1 1/2"=1'-0"



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VENUE at: **Alterations** A NOSGAL 9 Proposed

New York

Ferry

Dobbs


date: 02-10-2020 drawn by: TJH checked by: TEH

A009


**DETAILS** 



N.T.S

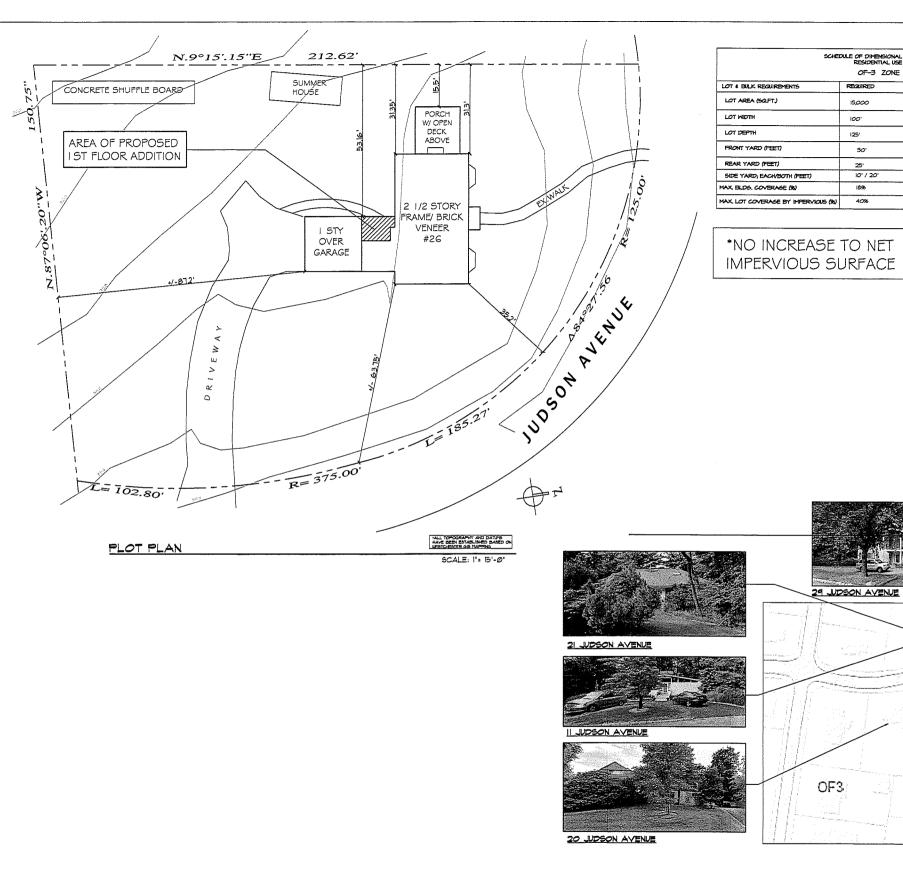

SITE MAP:

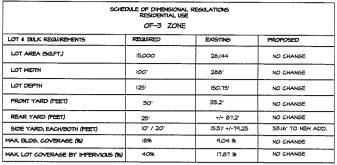

IMPERVIOUS SURFACE



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35 JUDSON AVENUE



43 JUDSON AVENUE



SUBJECT PROPERTY: 26 JUDSON AVENUE



50 JUDSON AVENUE

# AVENUE Proposed Alterations at: 26 JUDSON

SITE PLAN



A010

date: 02-10-2020 drawn by: TJH checked by: TEH

Dobbs Ferry, New York