
# RENOVATIONS & EXTENSIONS TO THE BRAMBRINK RESIDENCE 20 LYMAN PLACE, DOBBS FERRY, NY 10522 C H R I S T I N A G R I F F I N A R C H I T E C T

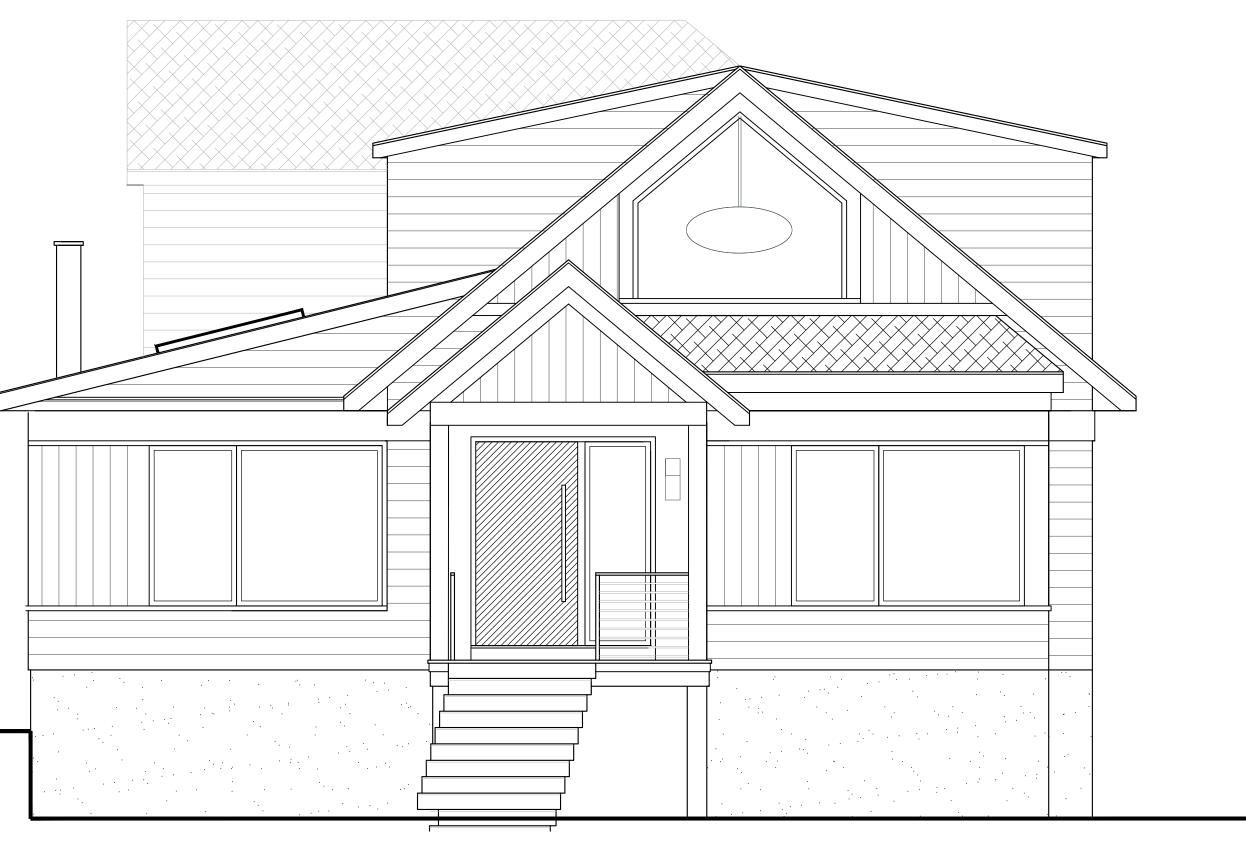

## **GENERAL NOTES**

- 1. These documents remain the exclusive property of the Architect, and may not be used for any purpose whatsoever without written consent of the Architect.
- 2. All construction shall comply fully with the 2020 Residential code of NYS, local building code, fire department regulations, and all other agencies having jurisdiction over project.
- 3. Approved stamped set of building plans must be present 14. All construction sites shall conform to the 2020 New on site for all inspections.
- 4. A current Westchester County licensed and insured contractor must be on file with current building permit until Certificate of Occupancy is issued. If contractor of record has been removed from the project, a stop work order will be issued untill a new Westchester County licensed and insured contractor is retained.
- 5. General Contractor shall carry property damage insurance, public liability insurance, workman's compensation, auto insurance, and general liability as required by Federal, State, and Local Codes and as Owner requires.
- 6. Licensed electrician to file separate electrical permit.
- 7. Licensed plumber to file separate plumbing permit. 8. All health, safety, fire, zoning and environmental
- regulations shall be adhered to at all times by the Owner and/or occupant. 9. The contractor shall become familiar with conditions of
- the site, and the work as shown on the construction documents, prior to submitting a bid for construction. 10. Contractors shall coordinate all work procedures and
- working hours with local authorities, neighborhood associations, and any other governing authorities. 11. The contractor shall be responsible for providing all labor
- and materials to complete the project, in accordance with the construction documents, tested and ready for owner's use.
- 12. All indicated Survey material is for general reference only. The Architect assumes no responsibility for the

accuracy or the correctness of any of the indicated material.

- 13. Contractors shall be responsible for protection of all existing and new conditions and materials with and adjacent to the construction area. Any damage caused by the execution of the work indicated or implied herein shall be repaired or replaced to the Owner's satisfaction.
- York State Property Maintenance Code. All rubbish garbage and construction debris shall be disposed of in an onsite dumpster or removed off site immediately. Materials shall be stacked in orderly fashion as to not create a blight on the community. The village right of way must be kept clear and maintained at all times.
- 15. General contractor shall be responsible for the removal 23. The drawings and notes are intended to be complete. of construction debris, rubbish and offsite disposal in a responsible manner.
- 16. The contractor shall obtain all inspections, approvals and permits, and pay all necessary permit fees required by the local building department and all other agencies having jurisdiction over the project, such as plumbing, electrical & HVAC, except for the building permit, which shall be obtained by the Architect. The contractor shall obtain the certificate of occupancy for the project when construction is complete.
- 17. Contractor shall keep work site free from debris and accumulated refuse, and shall have sole responsibility for protecting all dangerous areas from entry by unauthorized parties.
- 18. Drawings may be rough scaled for estimating and general purposes, but are not to be scaled for construction locations, dimensions, or any other purposes. Dimensions shown shall govern over measurements scaled from plans. Wall dimensions are given to finished surfaces. Contractor to consult with the Architect for questions regarding final dimensions and locations.
- 19. All dimensions and conditions shown and assumed on the drawings must be verified at the site by contractor

- before ordering any material or doing any work. 20.Contractor is to design and install adequate and code approved shoring and bracing where needed to safely complete structural work. Contractor to assume full and 28. The contractor shall do all the cutting, fitting & patching sole responsibility for structural adequacy of the shoring and for any injuries, damages, cracks, or defects caused by shoring or bracing, and shall repair all such damage at his sole expense.
- 21. The Architect is not responsible for workmanship, construction methods, or any omissions or derivations from the drawings during construction.
- 22.Materials and products indicated on drawings shall be installed in accordance with manufacturer's requirements
- Should anything be omitted from the drawings necessary to the proper construction of the work herein described, it 31.If blown or sprayed insulation used, Installer of insulation shall be the duty of the contractor to notify the Architect. The builder shall visit the site and inform the Architect of any discrepancies of field conditions that may interfere with the total completion of all work included within the contract and verify all conditions prior to the ordering of materials and the start of construction.
- 24.Minor details not usually shown or specified, but necessary for proper and acceptable construction, installation or operation of any part of the work shall be 32. All work shall be guaranteed for one year after final included in the work the same as specified or indicated.
- 25. The contractor shall supervise and direct the work using his best skill and attention, he shall be solely responsible for all construction means, methods, sequences and procedures and for coordination of all portions of the work.
- 26. The use of the words "provide" or "provided" in connection with any item specified is intended to mean that such item be furnished and installed and connected where required.
- 27.Contractor shall maintain a sealed enclosure between work area and other areas of the residence. In addition,

12 Spring Street, Hastings-on-Hudson, NY 10706

the contractor shall be responsible to (a) protect all interior spaces from the area of renovation, and (b) broom sweep all areas at end of each work day. that may be required to make several parts of the work come together properly, and to fit his work, and/or receive, or be received by the work of others, as shown, or as reasonably implied on the drawings.

29.New and existing work shall come together in a seamless fashion.All new or modified surfaces shall be finished including, but not limited to taping, spackling and priming.

30. All insulation to comply with the Energy Efficiency Certificate required by 401.3 2020 Energy Conservation Construction Code of New York, prepared by the Architect

to submit insulation certification to include the installed thickness of the area covered and R-value of the installed thickness shall be listed on the certificate. The insulation installer shall sign, data and post the certificate in a conspicuous location on the job site per N1101.5 of the 2020 Residential Code of New York State and submit an original signed copy for the Building Departments records

payment. The general contractor is to furnish written guarantees on his work and all subcontractors work against defects resulting from the use of inferior materials, equipment, or workmanship as determined solely by the Architect. All such defects are to be at no cost to owner.

shown on the drawings or in the specifications shall be made only upon approval of the Architect or owner as noted on the drawings or in these specifications. The contractor shall submit his substitution for approval before releasing any order for fabrication and/or

shipments. The Architect reserves the right to disapprove such substitution, provided in his sole opinion, the item offered is not equal or detailed on the Amended by the NY Stretch Energy Code 2020 drawings, which requires any redesign of the structure, partitions, piping, redesign, and all new drawings and detailing required therefore shall, with the approval of the Architect, be prepared by the contractor at his own expense

34. All work shall be installed so that all parts required are readily accessible for inspection, operation, maintenance and repair. Minor deviations from the drawings may be made to accomplish this, but changes of magnitude shall Design Criteria: not be made without prior written approval from the Architect.

35.Upon completion of the work, the entire project is to be R402.2.1 CEILINGS WITH ATTIC SPACES completely cleaned and the site restored to existing condition, including but not limited to the following.

- a) Complete sweeping of all areas, and removal of all rubbish and debris, except that caused by the owner or others doing N.I.C. work.
- b) Removal of all labels from glass, fixtures, and equipment, etc. and spray cleaning of glass and mirrors.
- c) Removal of stains, and paint from glass, hardware, finished flooring, cabinets, etc.
- d) Final cleaning of all chrome and aluminum metal
- e) Restoration of property by returning shrubs to original ceiling area, whichever is less. locations, filling of all ruts and raked topsoil and repairs to damaged blacktop.
- replaced or repaired, complete with labor and materials, 36. Finish materials and paint colors shall be reviewed and approved by the homeowner.
- 33. Substitutions of equipment or materials other than those 37. The Architect assumes no responsibility for the accuracy 2020 Residential code of NYS. or correctness of any material or drawings prepared by others and provided to the Architect.

Energy Notes R-Values & U-Factors 2020 Residential code of NYS

	Climate Z	one 4A	
		Required	Proposed
;	Ceiling	R-49	R-49
	Wall	R-21	R-21
	Glazing	0.27 U value	0.27 U value
	Floor	R-30	R-19
1		or R-19 per footnote	(g)

5750 Degree Days 15% Maximum Glazing

\* Installing R-38 over 100% of the ceiling area requiring insulation shall be deemed to satisfy the requirement for R-49 insulation wherever the full height of uncompressed R-38 insulation extends over the wall top plate at eaves. R402.2.2 CEILINGS WITHOUT ATTIC SPACES Where Section R402.1.2 requires insulation R-values greater than R38 in the ceiling and the design of the roof/ceiling assembly does not allow sufficient space for the required insulation, the minimum required insulation R-value for such roof/ceiling assemblies shall be R38. Insulation shall extend over the top of the wall plate to the outer edge of such plate and shall not be compressed. This reduction of insulation from the requirements of Section R402.1.2 shall be limited to 500 SF or 20% of the total insulated

## Certification

I, Christina Griffin, Architect A.I.A., hereby states that I have prepared these plans and specifications to the best of my knowledge in compliance with all the requirements of the

				TION 02.1.2			
	CLIMA ZON			IESTRATI I-FACTOR			ع د
	4A			0.27			
				ASS WAL R-VALUE	Lq		
				15/20			
	a. b. c. d. e. f. g. h.	the spe Int. of F The R-1 Mas insu 15/ <sup>7</sup> the R-1 edg requ Alte	label o cified i (interm 2-10 ins first va 3 cavit ss walls ulation 19 mea basem 0 conti je insul uired to ernative	are minimu or design the n the table nediate fran- sulation. alue is cav y insulation s shall be i is on the in- ns R-15 con- nent wall. nuous insu- ation R-va extend be- ely, insulation tration U-fa	icknes mings) ity insu- n plus n acco- iterior ontinuo ilation lue for elow th on suf	ss of den ulatio R-1( ordar of th ous i shal slat ne sla ficie	th not nc nc nc nc nc nc nc nc nc nc nc nc nc
			Ι	DESIC C	COE		(
				WIND E	ESIGN	1	
	GROUN SNOW LOAD		SPEED (MPH)	TOPO EFFECTS	SPECI WIND REGIC		W B( DI Z(
•							

NO

YES

30 PSF 120-

130 MPH



## FENESTRATION REQUIREMENT BY COMPONENT JY ECC AMENDED BY NY STRETCH ENERGY CODE

SKYLIGHT U-FACTOR <sup>h</sup>	GLAZED FENESTRATION SHGC <sup>h</sup>	CEILING R-VALUE	WOOD FRAME WALL <sup>b,c</sup> R-VALUE	
0.50	0.40	49	21 or 20+5 or 13+10 <sup>cont</sup>	
FLOOR R-VALUE	BASEMENT WALL <sup>®</sup> R-VALUE	SLAB <sup>f</sup> R-VALUE & DEPTH	CRAWL SPACE WALL® R-VALUE	
30 <sup>g</sup>	15/19	10, 4FT(d)	15/19	_

rs and SHGC are maximums. Where insulation is installed in a cavity that is less than he insulation, the installed R-value of the insulation shall be not less than the R-value

tes standard framing 16 inches on center. Headers shall be insulated with a minimum n, the second value is continuous insulation. Therefore, as an example, "13+10" means

continuous insulation e with Section R402.2.5. The second R-value applies when more than half the mass wall.

sulation on the interior or exterior of the home or R-19 cavity insulation at the interior of be provided under the full slab area of a heated slab in addition to the required slab

as indicated in the table. The slab edge insulation for heated slabs shall not be

to fill the framing cavity and providing not less than an R-value of R-19. excludes skylights. The SHGC column applies to all glazed fenestration.

## QUIREMENTS for the 2020 RESIDENTIAL OF NEW YORK STATE CLIMATIC & OGRAPHIC DESIGN CRITERIA

-										
			SUBJECT .	TO DAMAG	E FROM					
	WIND BORNE DEBRIS ZONE	SEISMIC DESIGN CATAGORY	WEATHERING	FROST LINE DEPTH	TERMITE	ICE SHIELD UNDERLAY REQUIRED	FLOOD HAZARDS	AIR FREEZING INDEX	MEAN ANNUAL TEMP.	A
	NO	В	SEVERE	42"	MODERATE TO HEAVY	YES	N/A	2000	51.6	E


## DATES

PRE-BID DOCUMENTS **BUILDING PERMIT SUBMISSION** PLANNING BOARD SUBMISSION **BID DOCUMENTS** AHRB SUBMISSION

8-12-21 8-13-21 9-16-21 11-18-21 12-2-21

## LIST of DRAWINGS

TITLE SHEET	GENERAL NOTES, CLIMATIC & GEOGRAPHIC CRITERIA, DATES, LIST OF DRAWINGS
<i>I</i> I-1	COLOR SCHEME AND MATERIALS
S-1	SITE PLAN, ZONING COMPLIANCE, LOCATION MAP
8-2	STREETVIEW, PHOTOS OF EXISTING CONDITIONS & NEIGHBORING PROPERTIES
ST- 1	STRUCTURAL / DEMOLITION PLANS
<b>\-1</b>	FIRST FLOOR PLAN
<b>\-2</b>	SECOND FLOOR PLAN
<b>\-3</b>	EXTERIOR ELEVATIONS, FENCE & RAILING DETAILS
<b>\-4</b>	EXTERIOR ELEVATIONS
<b>\-5</b>	GARAGE PLAN & ELEVATIONS, PHOTOS OF EXIST. CONDITIONS
-1	ELECTRICAL PLANS
-2	ELECTRICAL PLAN - EXTERIOR FIXTURES

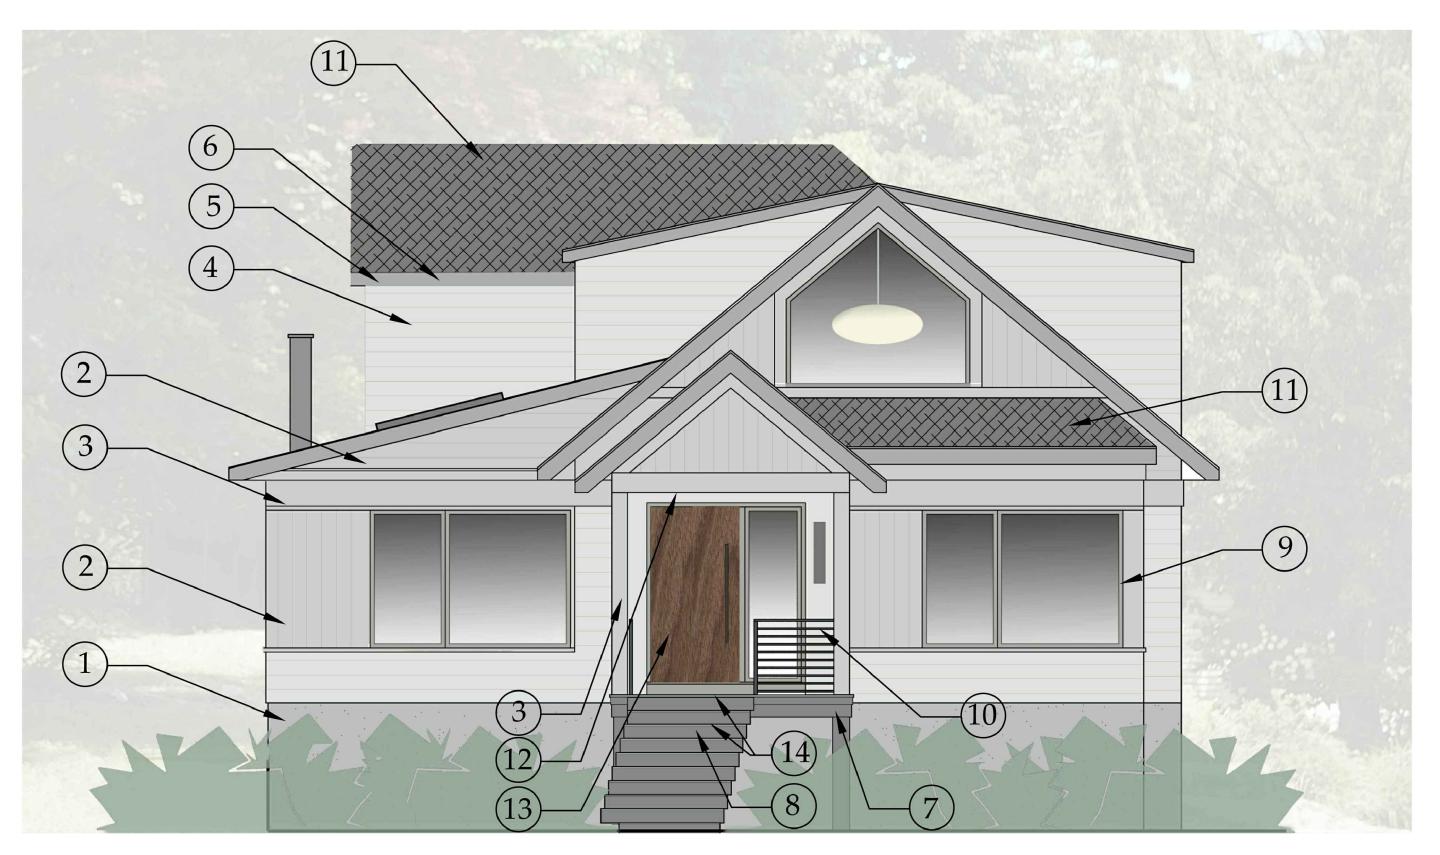

**COLOR SCHEME -SOUTH ELEVATION** SCALE: 1/4" = 1'-0"

L. 3-COAT CEMENT STUCCO, FINE FINISH, COLOR MATCH TO	2. JAMES HARDIE ARTISAN SHIPLAP CEMENTITIOUS SIDING, SMOOTH FINISH,	4. JAMES HARDIE ARTISAN SHIPLAP CEMENTITIOUS SIDING, SMOOTH FINISH,	5. AZEK PAINT BEN. M LAMPI

- COLOR MATCH TO BEN. MOORE COVENTRY GRAY #HC-169
- PAINT FINISH, BEN. MOORE THUNDER #AF-685
- 3. AZEK TRIM BOARDS, POST ENCLOSURE, PAINT FINISH, BEN. MOORE THUNDER #AF-685

PAINT FINISH,

BEN. MOORE

HORIZON #OC-53

6.ALUMINUM HALF-ROUND GUTTER, COLOR-MATCHED TO BEN. MOORE LAMPBLACK, # CW-695




- K FACIA BOARDS, NT FINISH, MOORE LAMPBLACK, #CW-695
- 7. AZEK TRIM BOARDS, POST ENCLOSURE, PAINT FINISH, BEN. MOORE CHELSEA GRAY, #CW-695
- 8.3-COAT CEMENT STUCCO AT STAIR RISERS, FINE FINISH, COLOR MATCH TO BEN. MOORE CHELSEA GRAY, #CW-695
- 9. PELLA WINDOWS LIFESTYLE SERIES, 'WOLF GRAY' ALUMINUM CLADDING
- 10. STEEL RAILING WITH POWDERCOAT PAINT FINISH, COLOR-MATCHED TO BEN. MOORE LAMPBLACK, # CW-695



14.BLUESTONE ATSTAIR TREADS, PORCH FLOOR AND PATIO TO MATCH **EXISTING PAVERS** AT PATIO

2 2 S 0  $\succ$ Ζ TΗE T  $\succ$  $\mathbf{R}$ ΟL  $\mathbf{R}$ [I] XTENSIONS I Ц S В SII В  $\bigcirc$ RE Ш S TIONS **ABRI** Ч  $\triangleleft$  $\geq$ 2 RENO BR 0 2

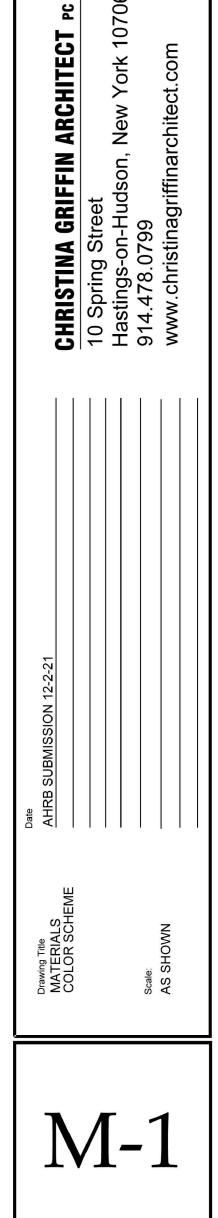



11.30-YEAR ARCHITECTURAL SHINGLES BY CERTANTEED, LANDMARK SERIES, **GEORGETOWN GREY** 

15. FIELDSTONE **RETAINING WALL AT** PATIO EXTENSION TO MATCH EXISTING



- 12. SOLID WALNUT DOOR WITH SINGLE INSET PANEL, STAIN FINISH
- 13.T & G WALNUT CEILING AT ENTRY PORCH, STAINED FINISH





## 20 LYMAN PLACE PHOTOS OF EXISTING CONDITIONS SCALE: N.T.S.






36 Temple Road


25 Lyman Place

23 Lyman Place


## PHOTOS OF NEIGHBORING PROPERTIES SCALE: N.T.S.

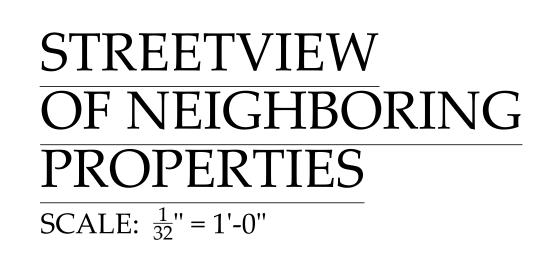



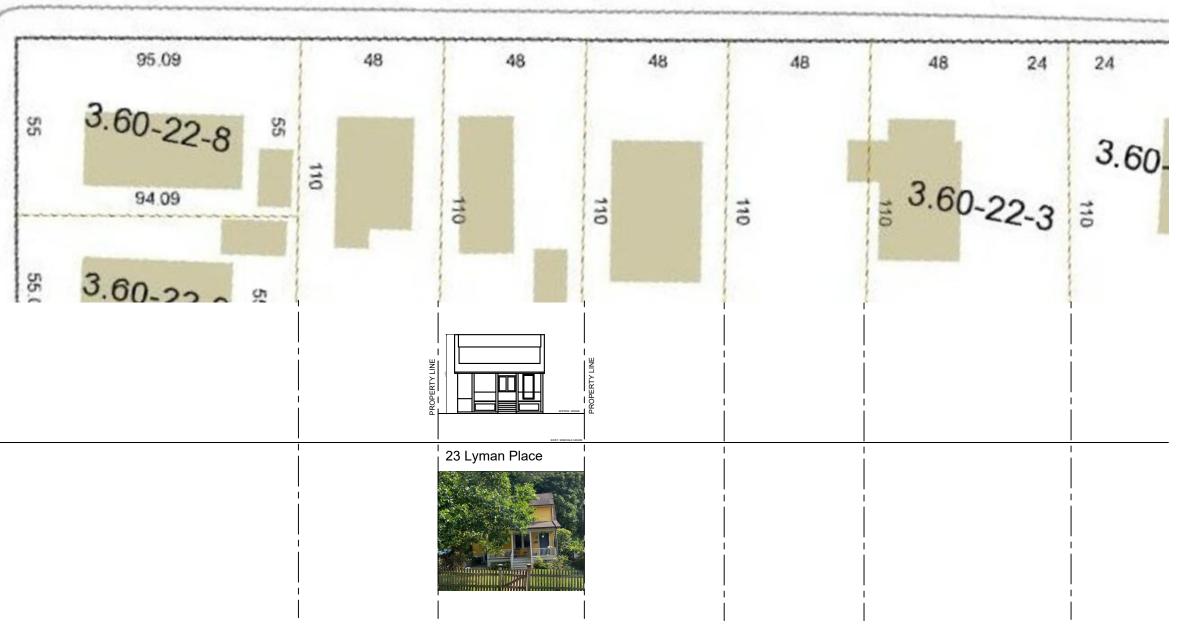

8 Lyman Place

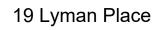

3 Lyman Place

LYMAN PL




2 1052  $\succ$ Ζ TΗE  $\succ$ [] ERR T O EXTENSION Γīη SIDE OBBS  $\square$ R Ы  $\bigcirc$  $\mathcal{S}$  $\checkmark$ ATIONS **ABRIN** PLΖ  $\triangleleft$ Ζ RENOV  $\succ$  $\sim$ BI 2 0 PC 107 FIN ARCHITECT GRII **CHRISTINA** 10 Spring St Hastings-on-914.478.079

Date PRE-BID DOCUMENTS 8-12-21 BUILDING PERMIT SUBMISSION 8-13-21 AHRB SUBMISSION 12-2-21

TOS 010S

S-2

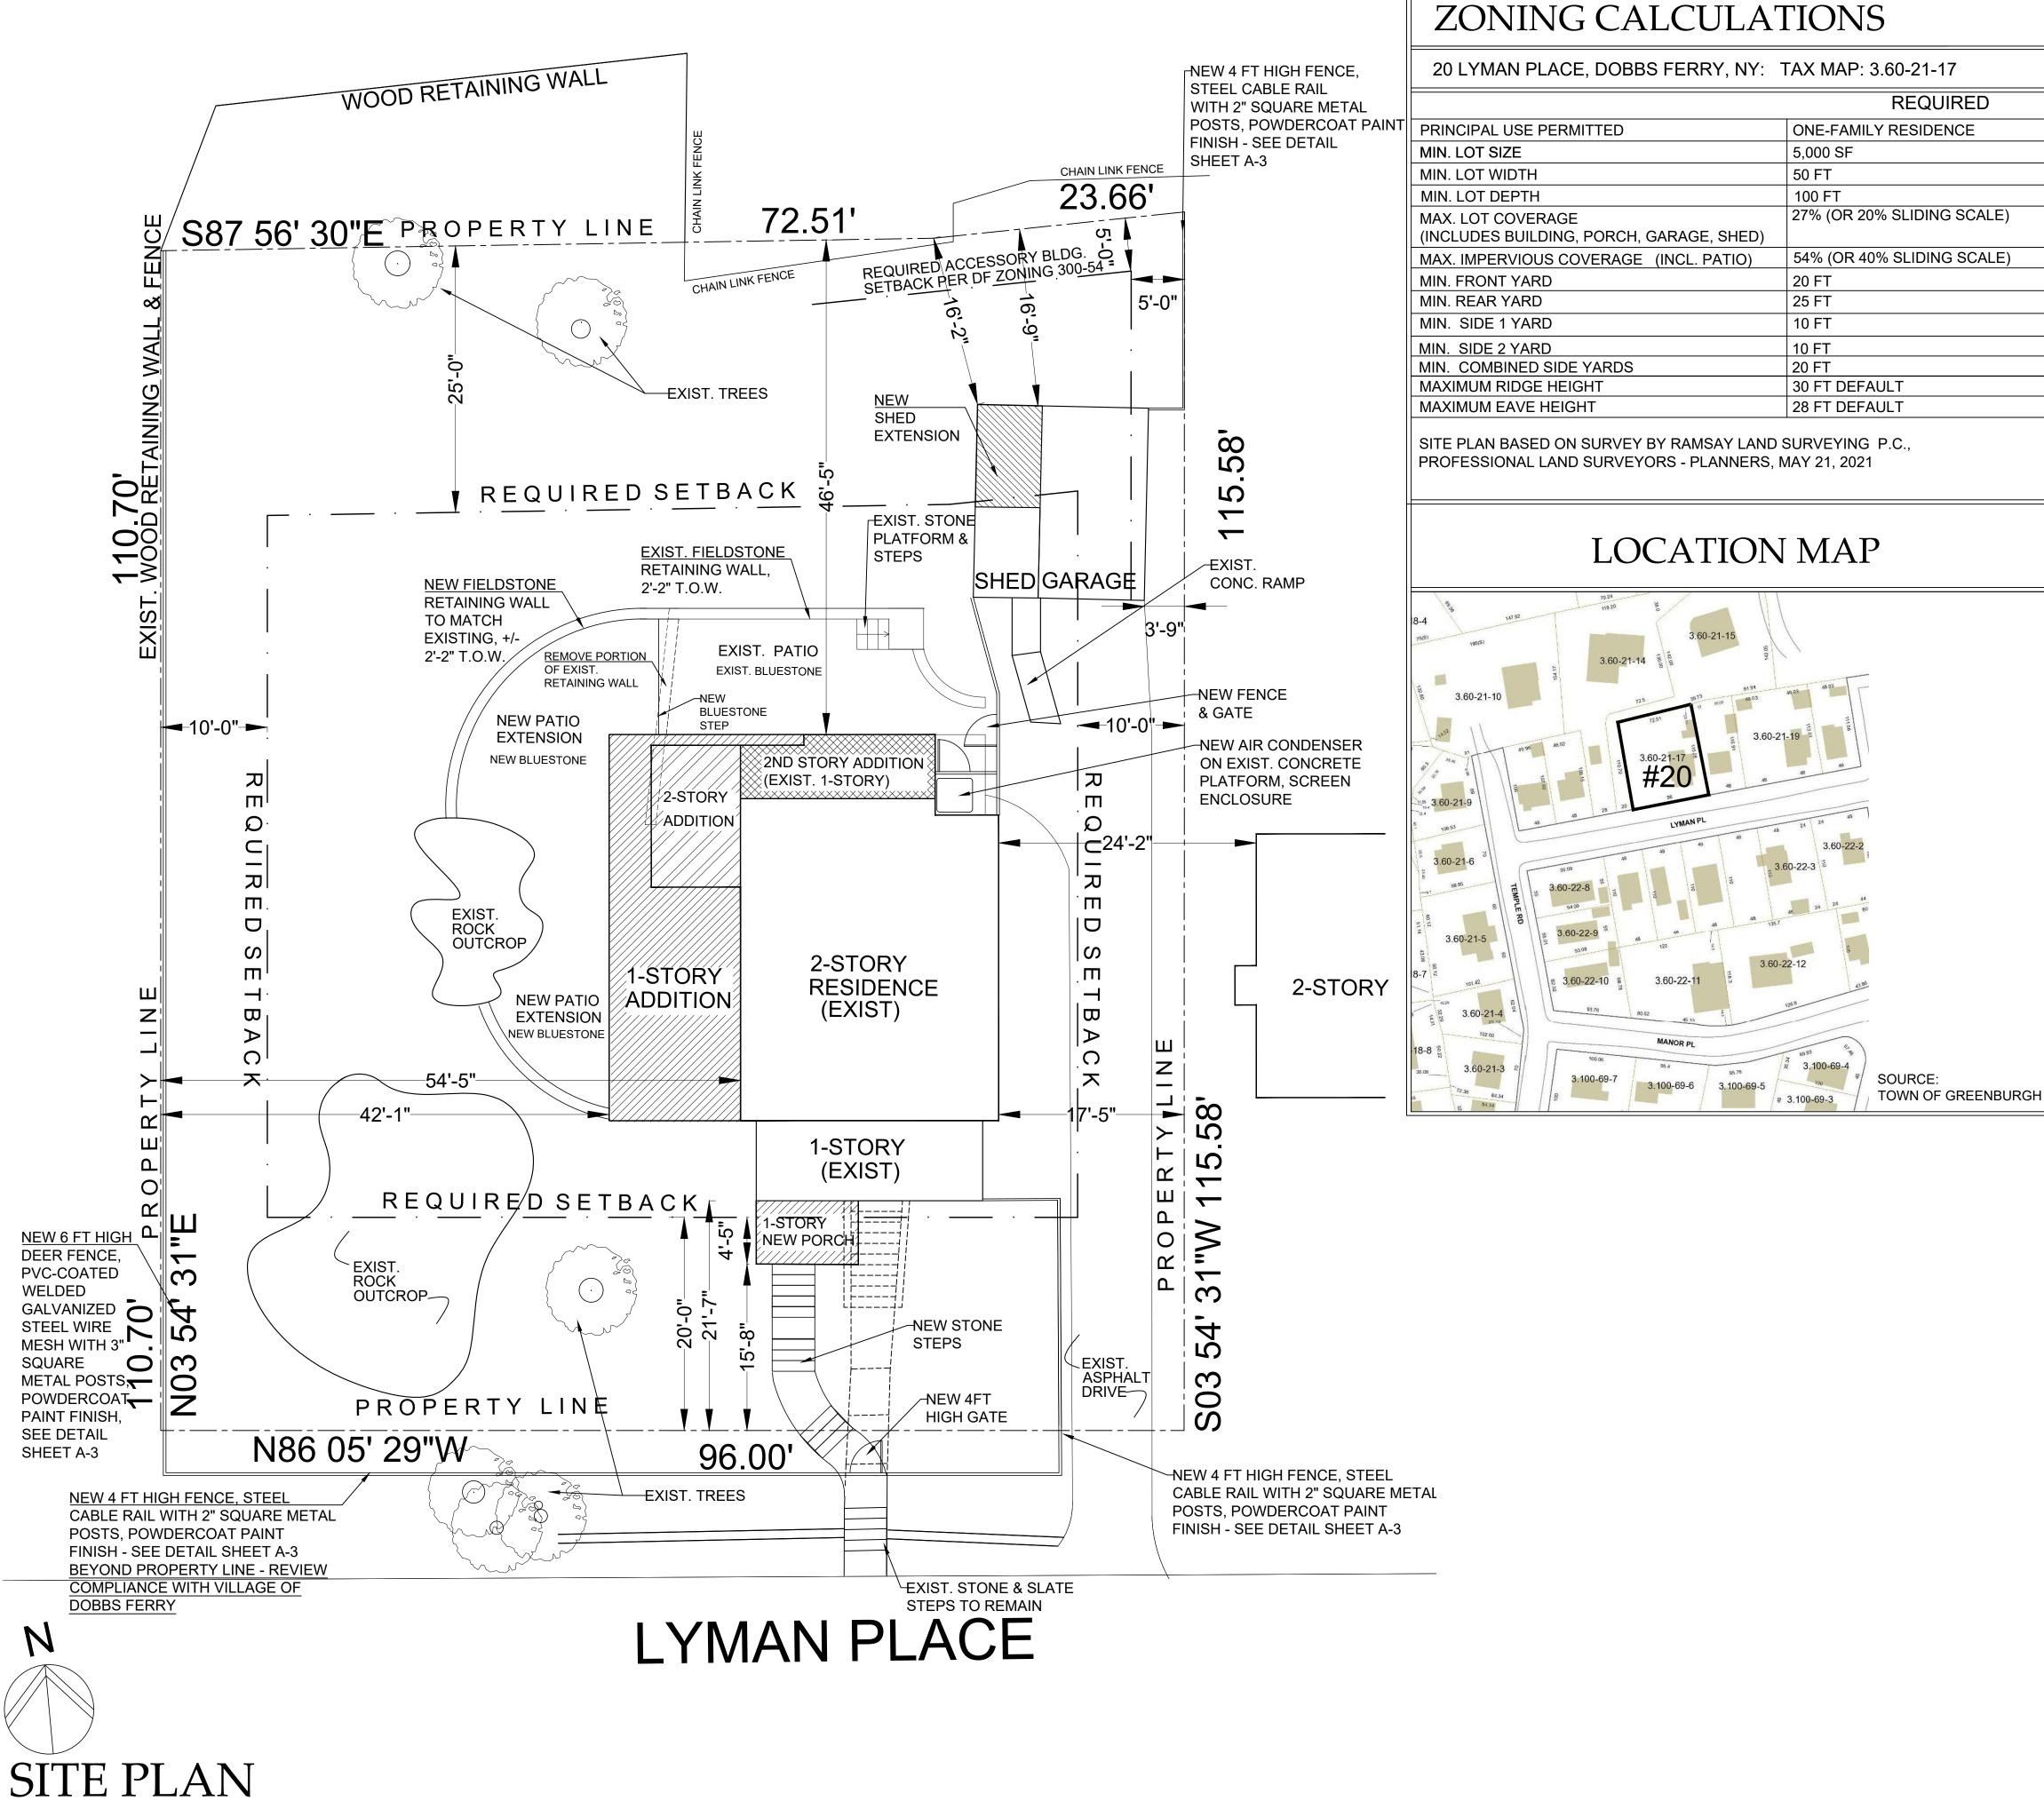

SCALE: 1/8" = 1'-0"

ZONING DISTRICT: OF-6	
EXISTING	PROPOSED
ONE-FAMILY RESIDENCE	ONE-FAMILY RESIDENCE
10,797 SF	10,797 SF
96 FT	96 FT
110.70 FT / 115.58 FT	110.70 FT / 115.58 FT
11% (1,232 SF)	17% (1,792 SF)
23% (2,507 SF)	3,452 SF (32%)
21.58 FT	21.58 FT; 15.7 FT TO PORCH **
46.4 FT (16.75FT TO EXIST. GARAGE)	46.4 FT (16.75FT TO EXIST. GARAGE)
17.4 FT	17.4 FT
54.4 FT	42.08 FT TO NEW ADDITION
71.8 FT	59.48 FT
23 FT	25.6 FT
19.9 FT	19.9 FT
	***PER DF ZONING CODE 300-34-B(4)(C), OPEN PORCHES MAY PROJECT INTO FRONT YARD SETBACK


	COVERAGE CAI	LCULAT	IONS
	LOT AREA	10,7	97 SF
		EXISTING	PROPOSED
	PRINCIPAL BUILDING & FRONT PORCH	1,001 SF	1,446 SF
	GARAGE & SHED	231 SF	289 SF
	NEW FRONT PORCH	N/A	57 SF
	REAR / SIDE PATIO	421 SF	869 SF
	ENTRY PLATFORM/ WALKS/ STONE STEPS	129 SF	66 SF
	DRIVEWAY & CONCRETE RAMP	725 SF	725 SF
	TOTAL IMPERVIOUS COVERAGE	EXISTING	PROPOSED
GIS		2,507 SF (23%)	3,452 SF (32%)


	RENOVATIONS & EXTENSION TO THE
v York 10706	<b>BRAMBRINK RESIDENCE</b>
∋ct.com	20 LYMAN PLACE, DOBBS FERRY, NY 105


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S

CHRISTINA GRIFFIN ARCHITECT PC	— 10 Spring Street — Hastings-on-Hudson, New York 10706	914.478.0799 	
Date PRE-BID DOCUMENTS 8-12-21 BUILDING PERMIT SUBMISSION 8-13-21 PUIMING POADD SUBMISSION 8-13-21	PLANNING BOARD SUBMISSION 9-16-21 PLANNING BOARD SUBMISSION 9-16-21 PLANNING BOARD REVISIONS 10-14-21 BID DOCUMENTS 11-18-21	AHRB SUBMISSION 12-2-21	
Drawing Title SITE PLAN ZONING DATA	AKEA MAP	Scale: AS SHOWN	
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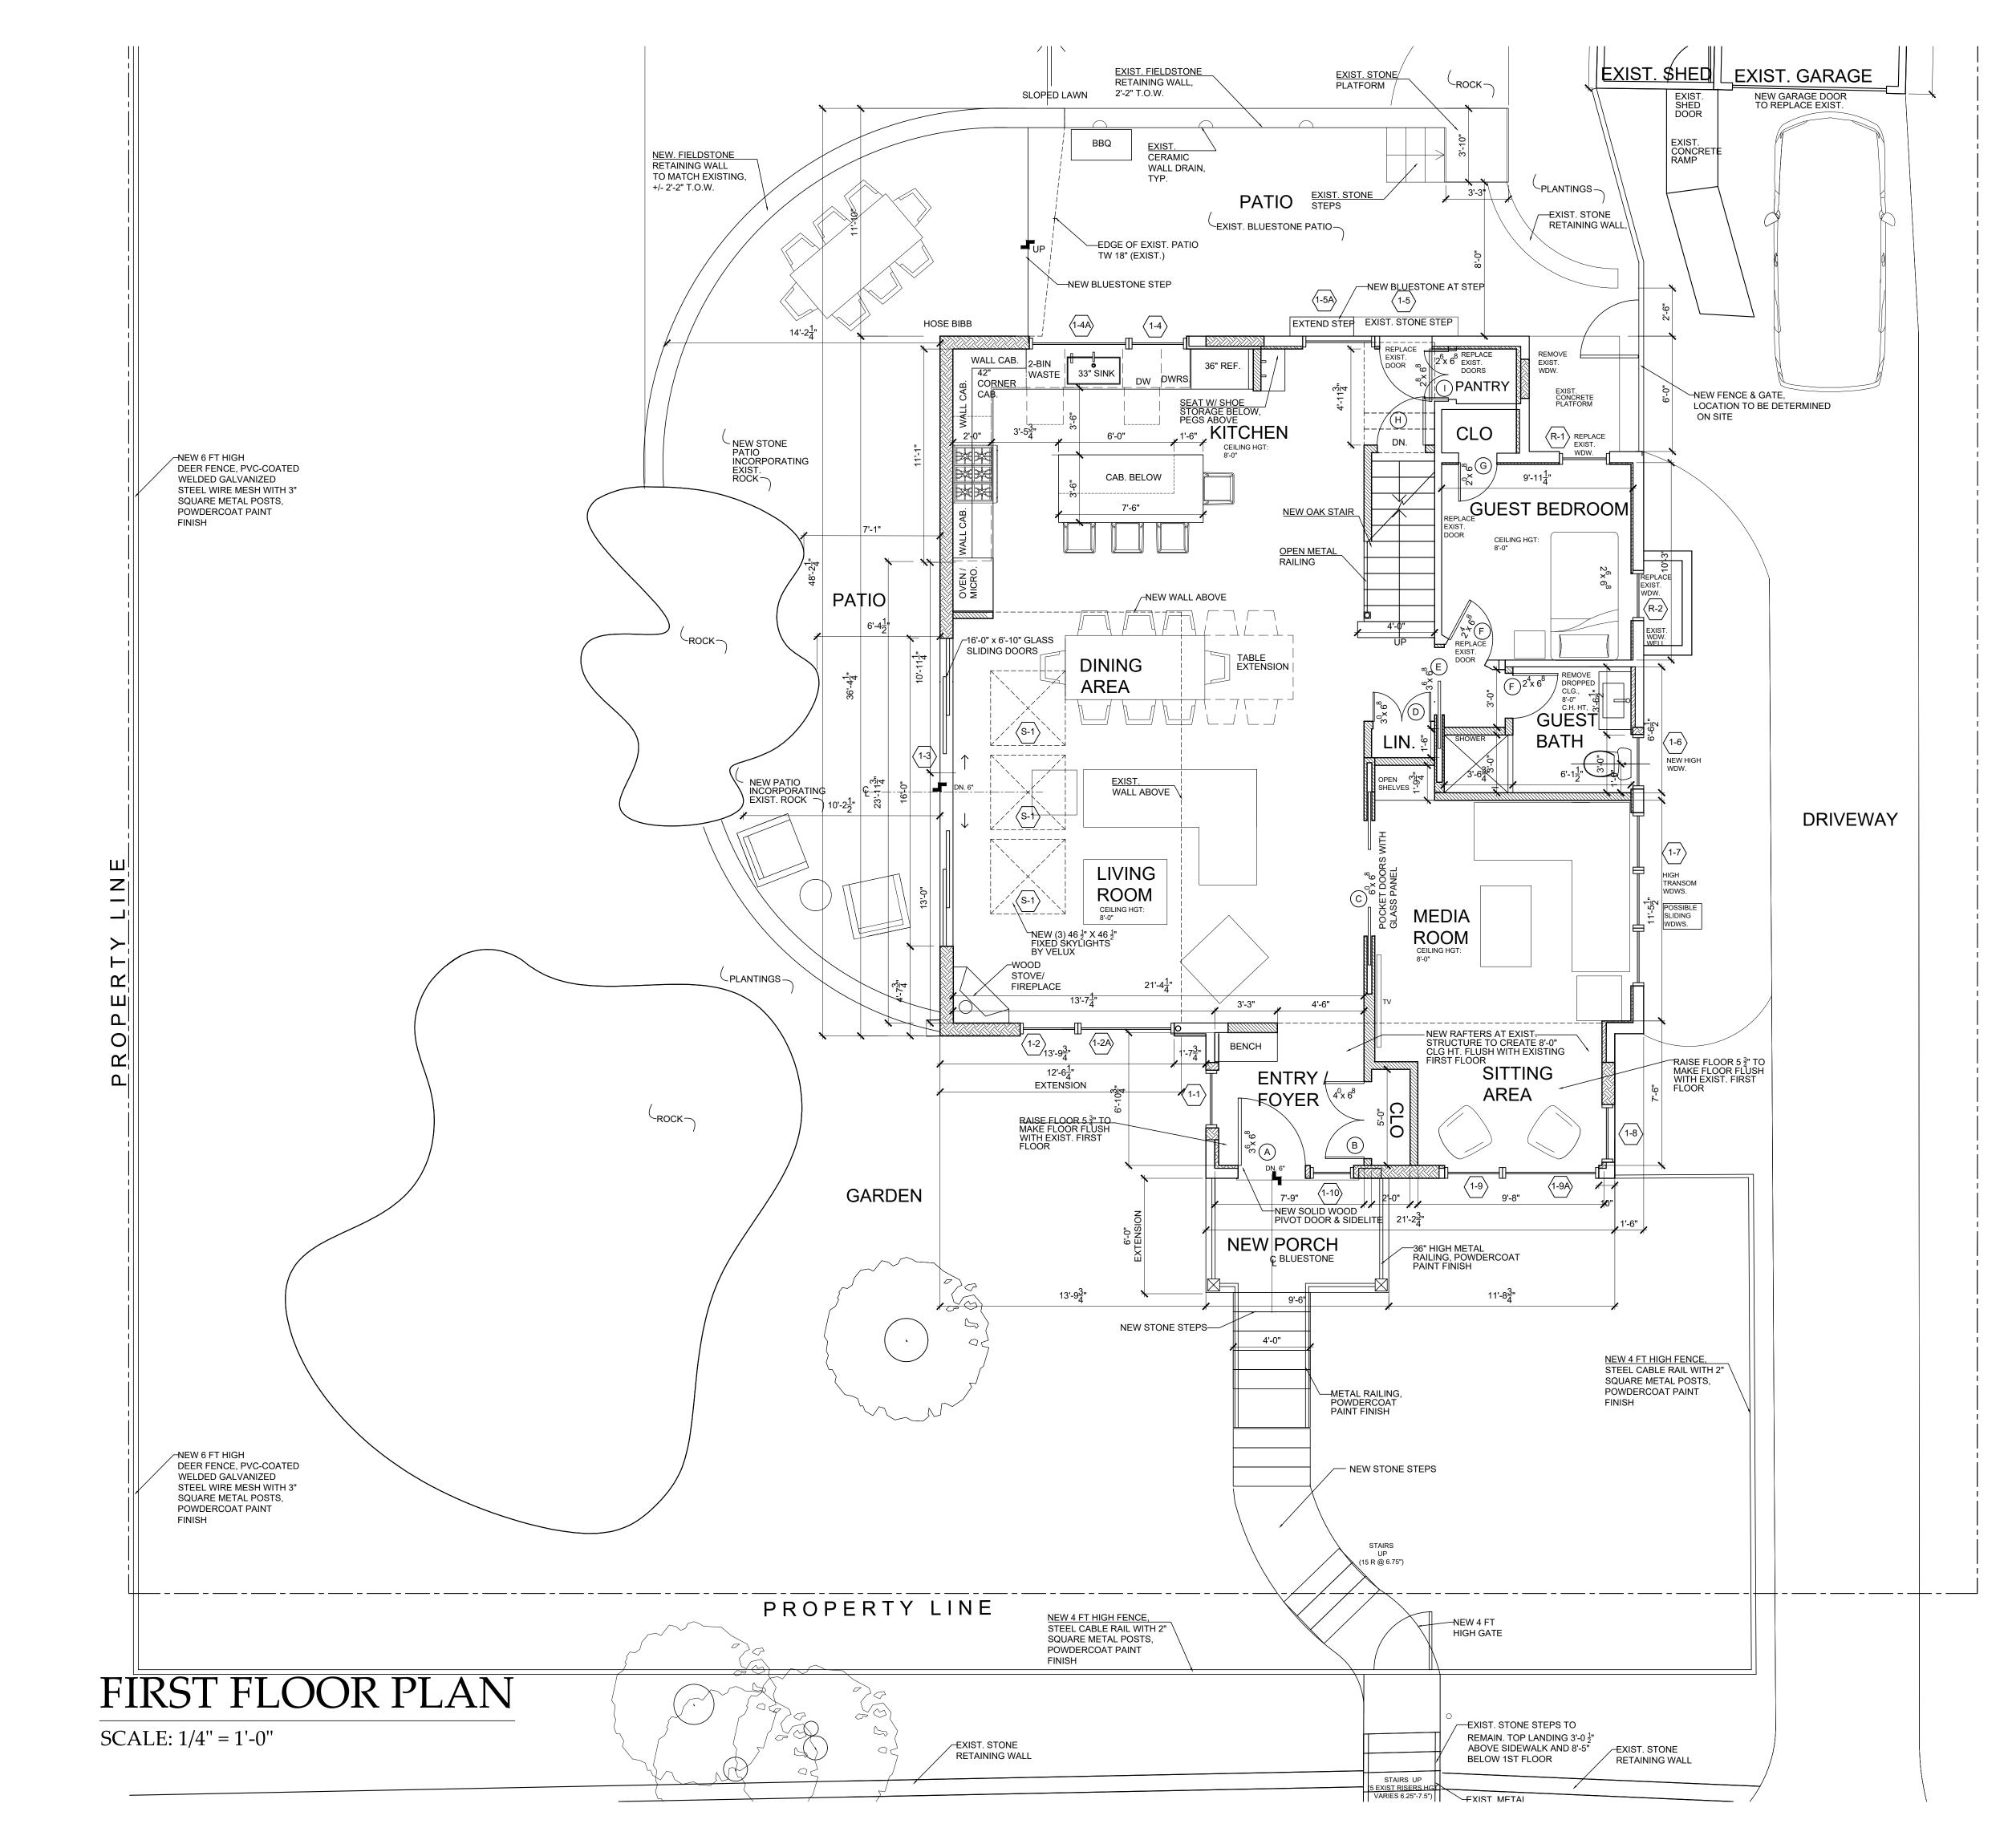




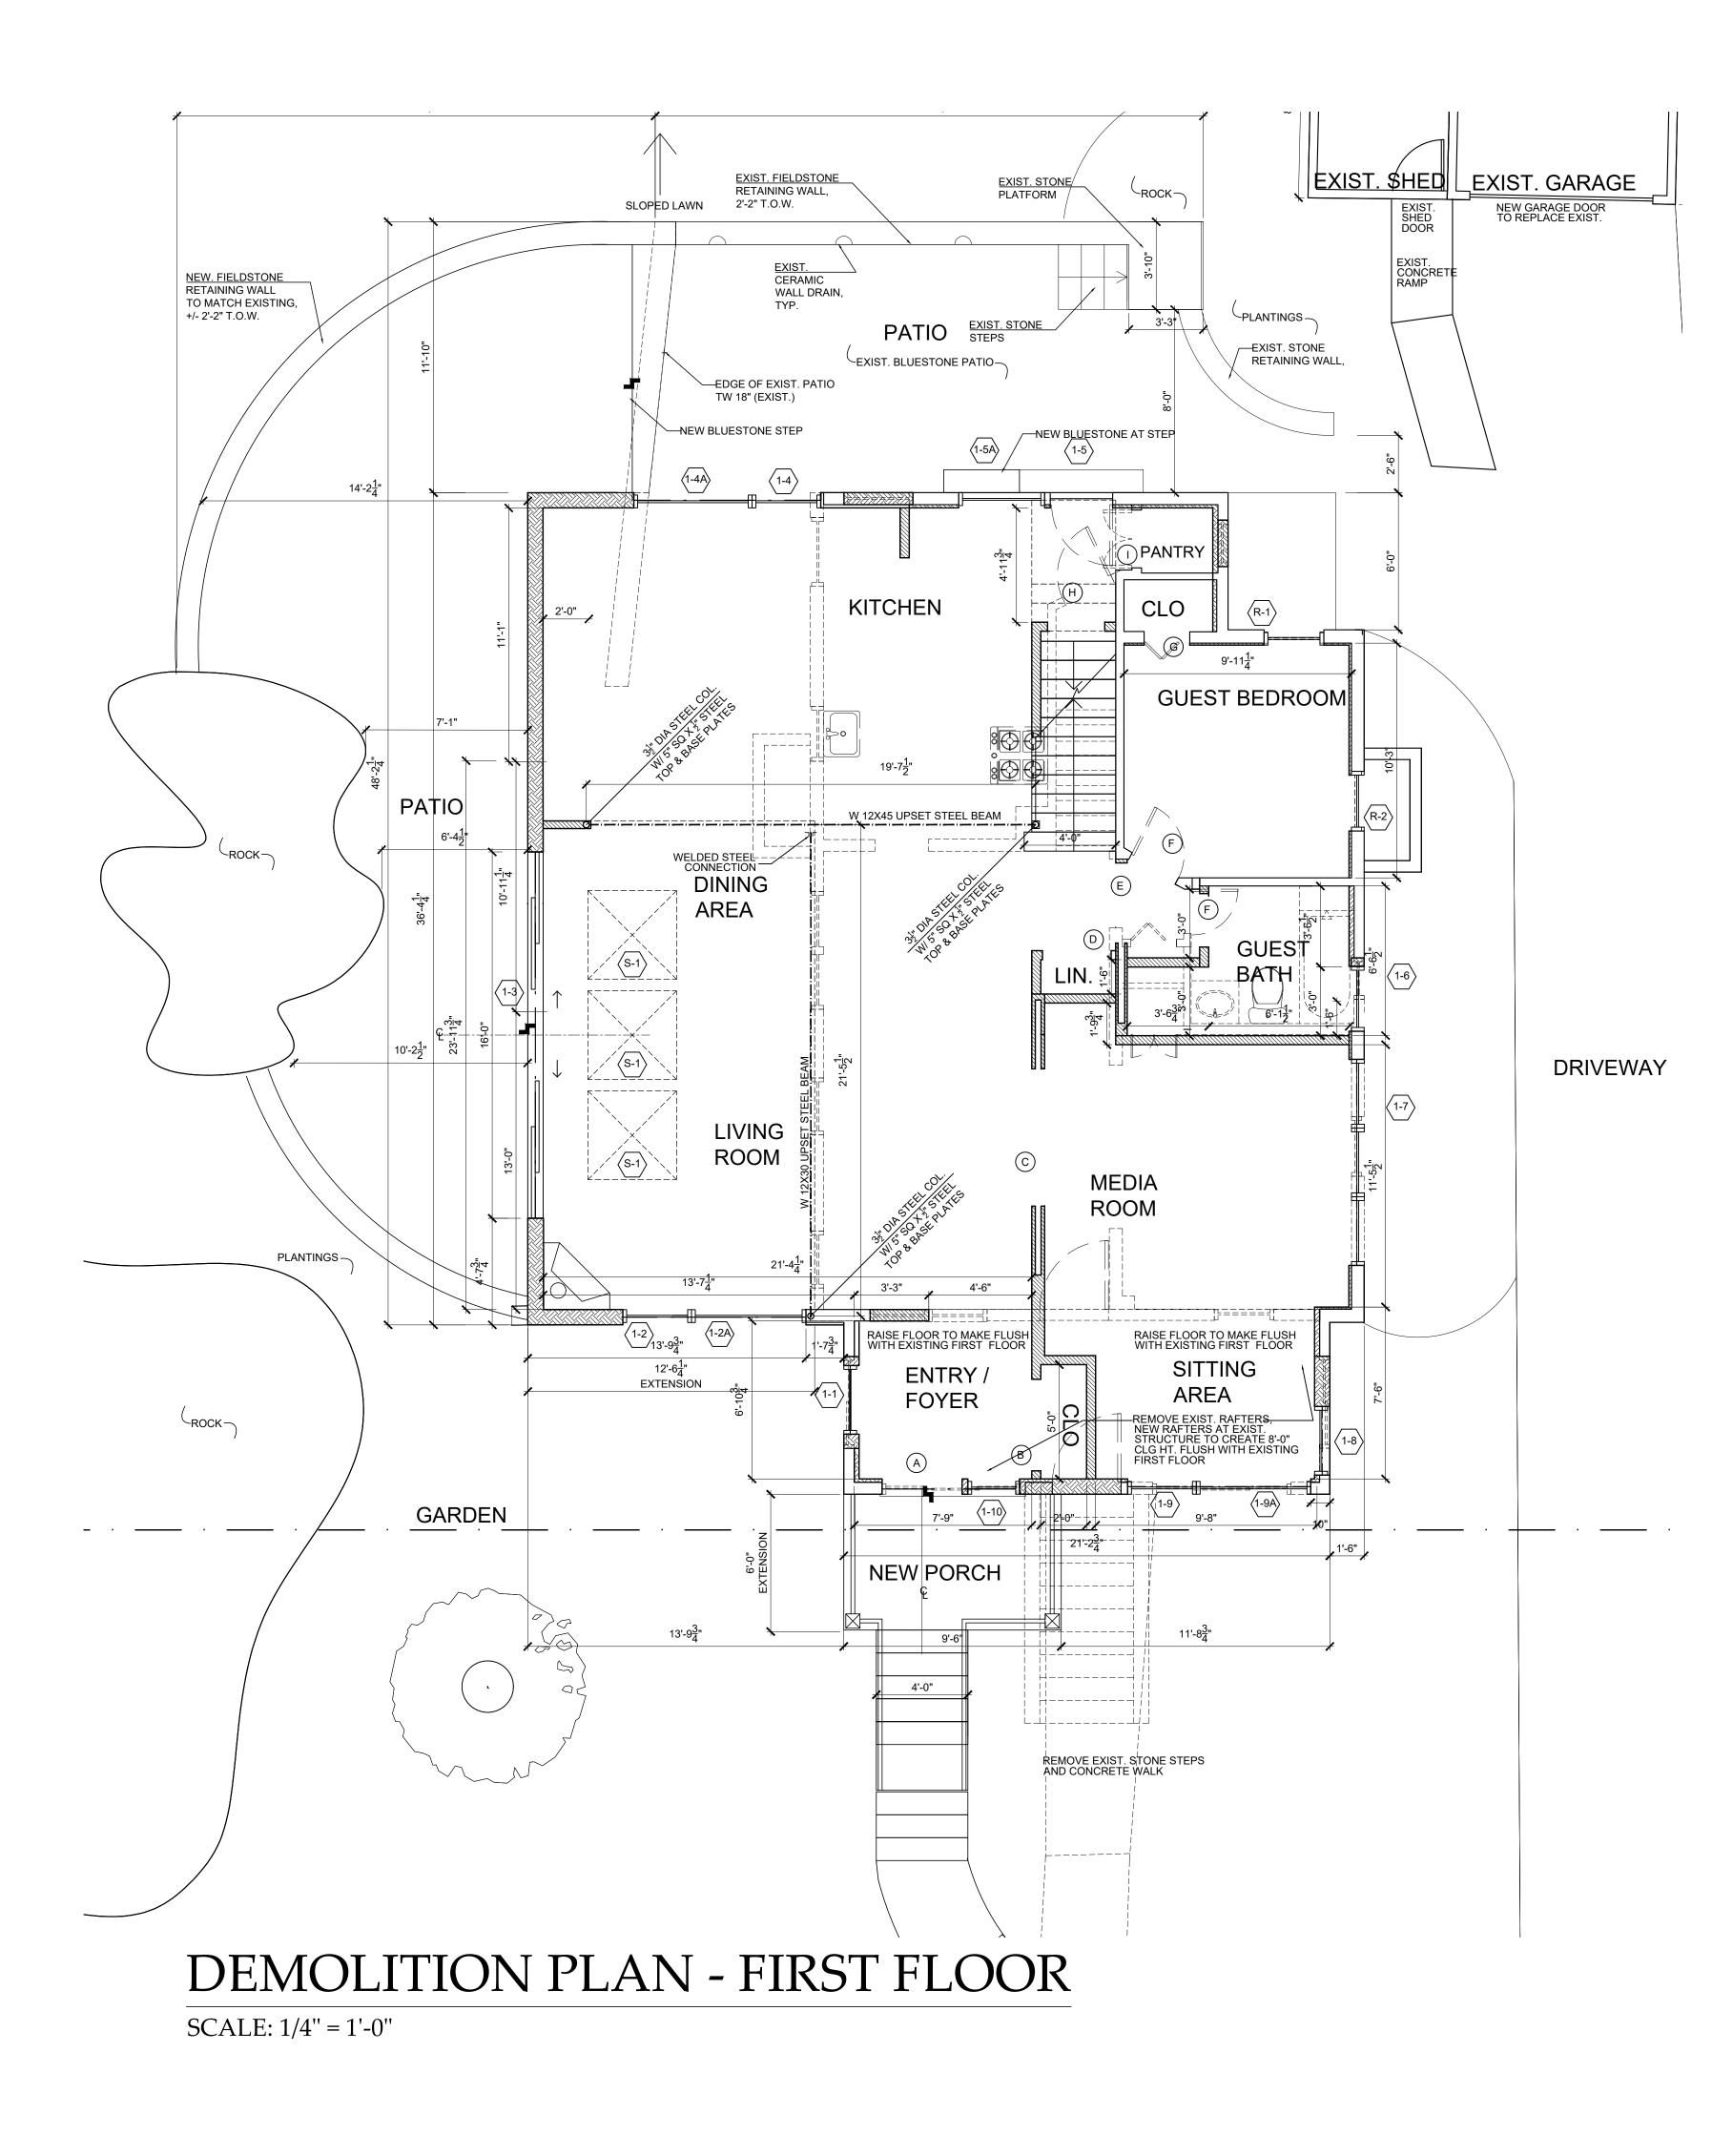

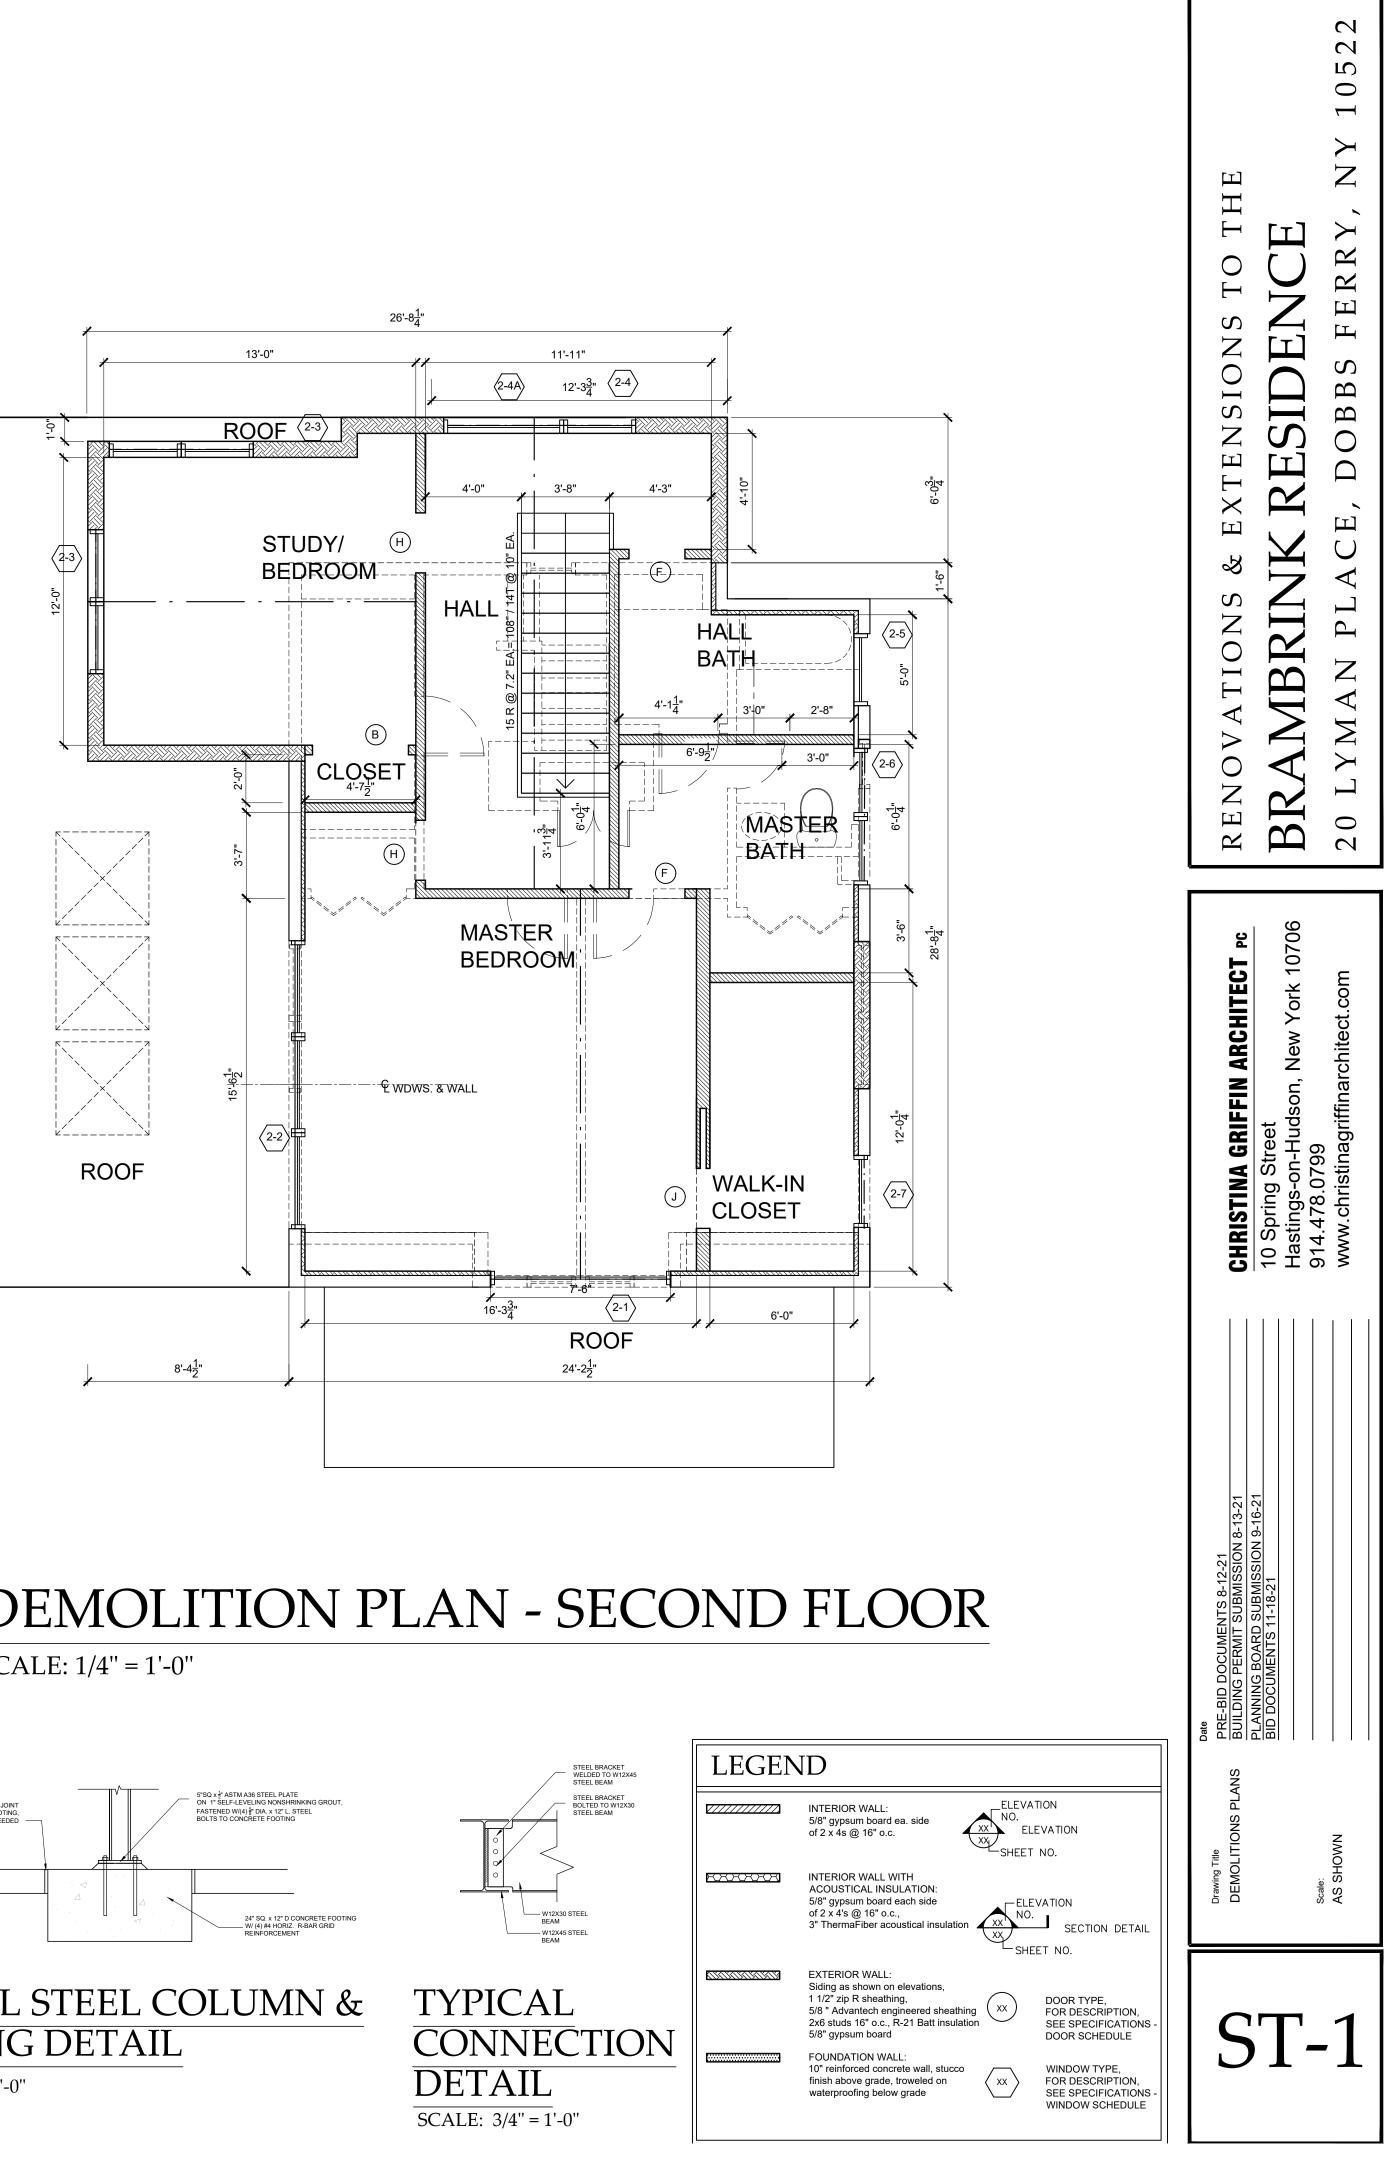TYPICAL STEEL COLUMN & FOOTING DETAIL

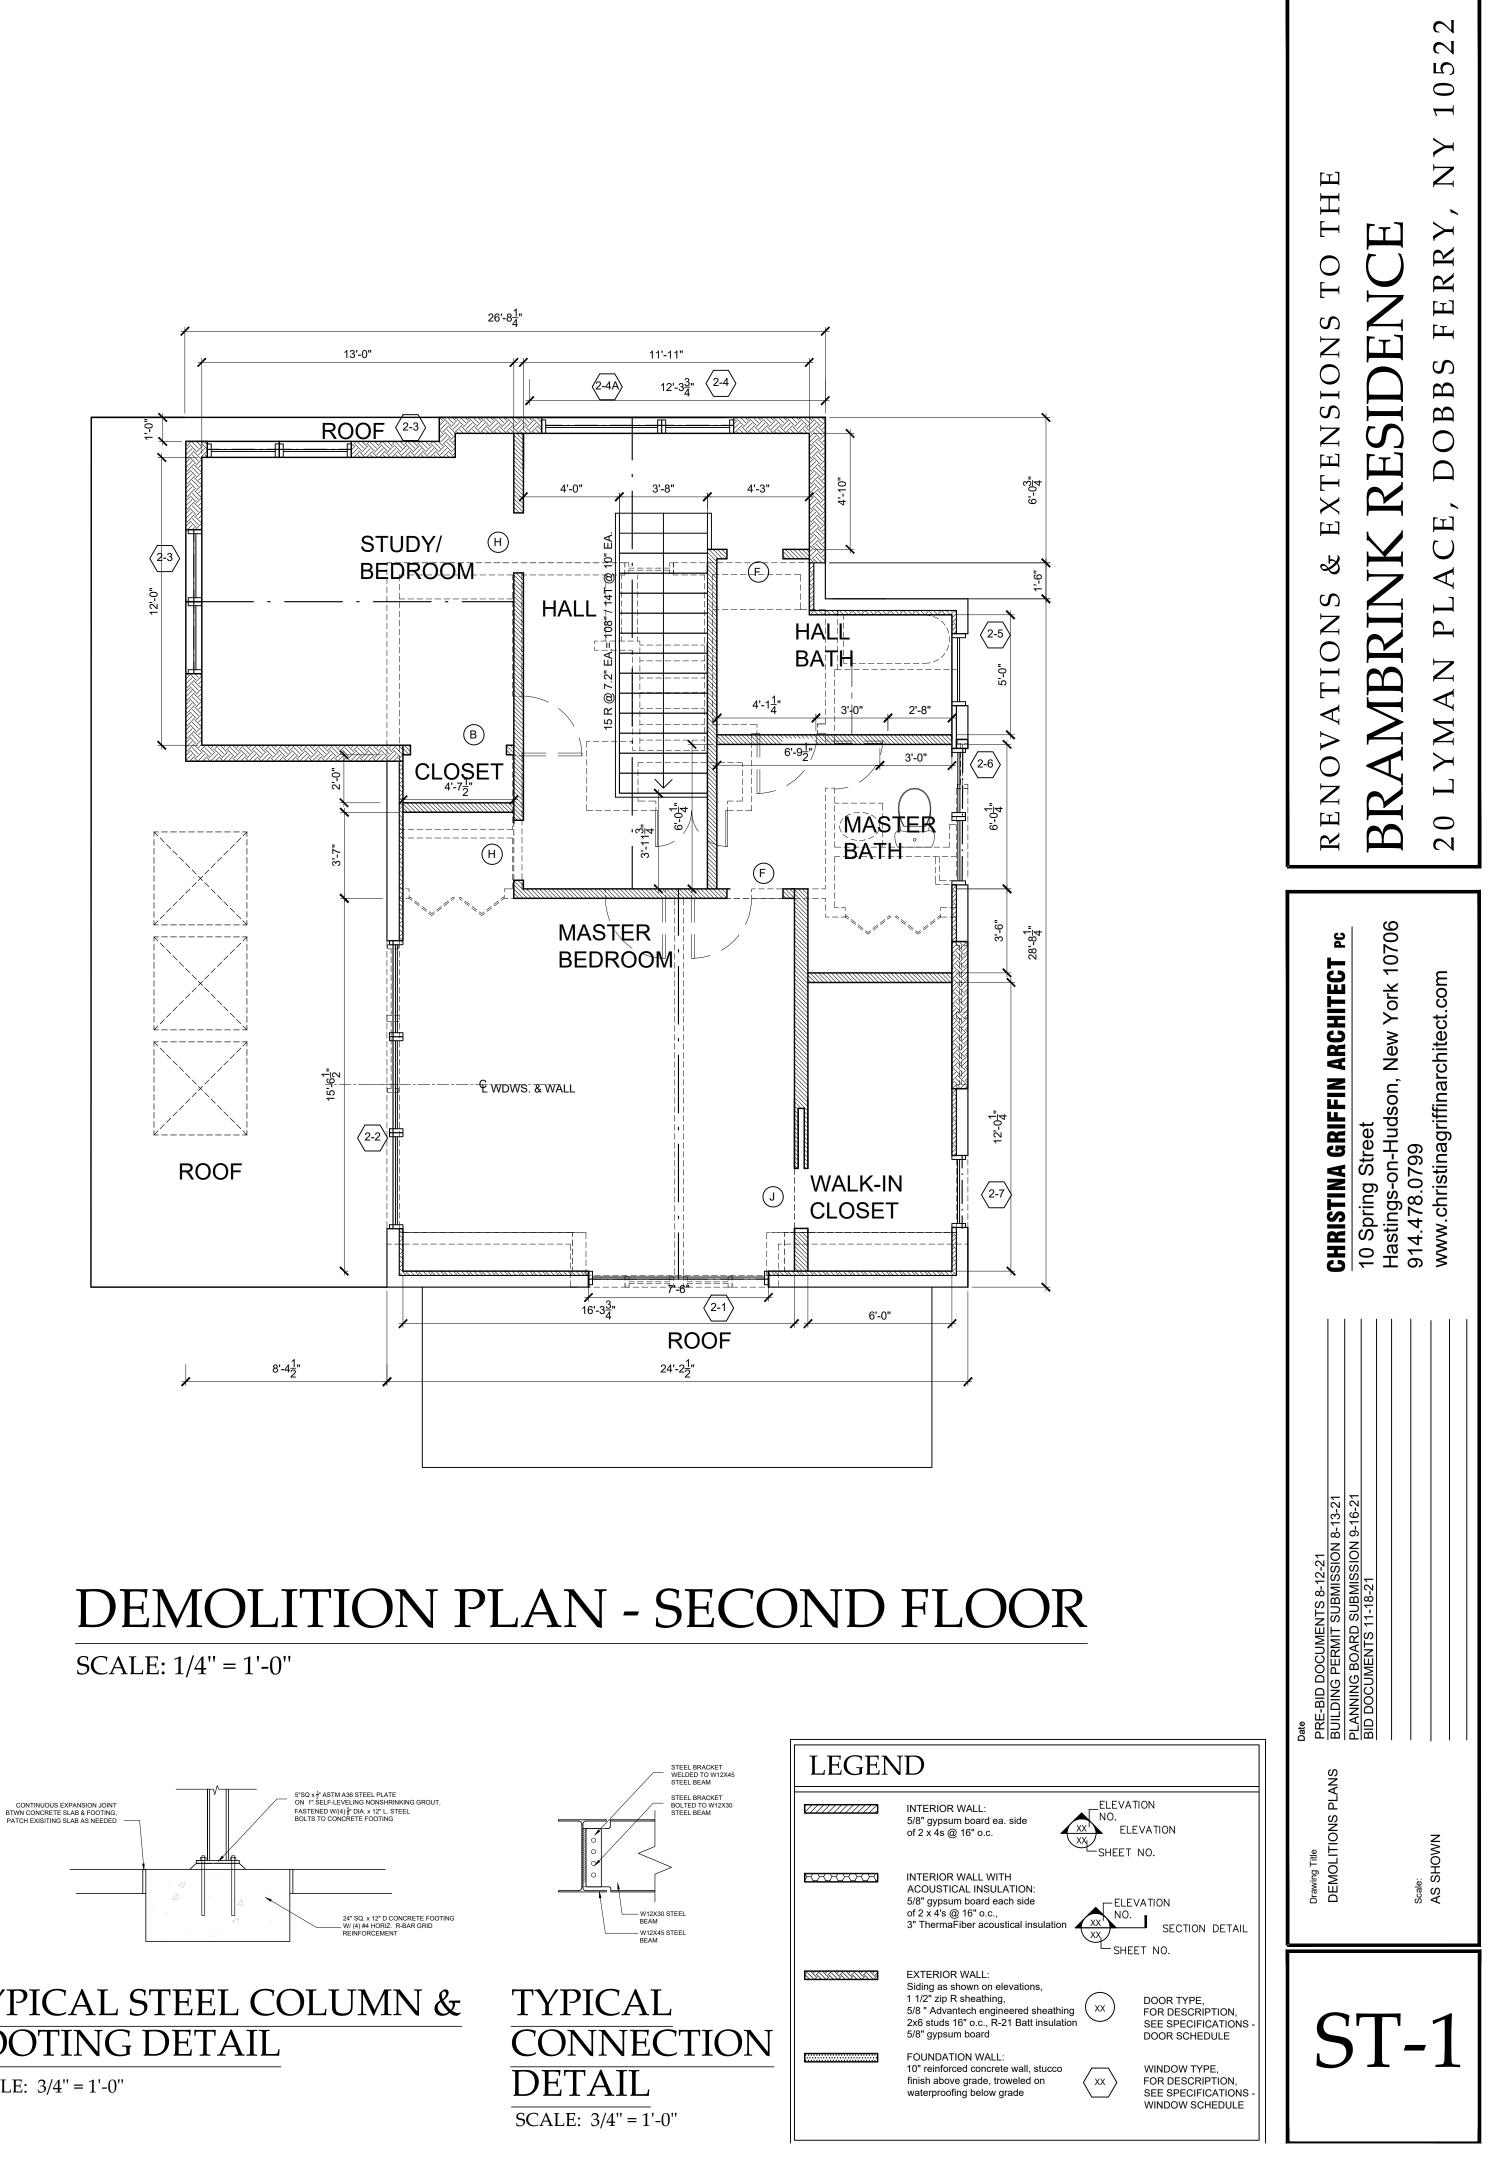
SCALE: 3/4" = 1'-0"



	Renovations & extension to the <b>BRAMBRINK RESIDENCE</b> 20 Lyman place, dobbs ferry, ny 10522
	CHRISTINA GRIFFIN ARCHITECT       Pc         10       Spring Street         11       New York 10706         11       Springs-on-Hudson, New York 10706         11       Street         11       Springs-on-Hudson, New York 10706         11       Street         11       Springs-on-Hudson, New York 10706         11       Street         11       Street         12       Street         13       Street         14       Street         15       Street         16       Street         17       Street         18       Street         19       Street         14       Street         14       Street         14
N	Date PRE-BID DOCUMENTS 8-12-21 BUILDING PERMIT SUBMISSION 8-13-21 BUILDING BOARD SUBMISSION 9-16-21 PLANNING BOARD REVISIONS 10-14-21 BID DOCUMENTS 11-18-21 AHRB SUBMISSION 12-2-21
ATION ATION D. TION SECTION DETAIL NO. DOOR TYPE, OR DESCRIPTION, DES SPECIFICATIONS - DOOR SCHEDULE VINDOW TYPE, OR DESCRIPTION,	Drawing Title FIRST FLOOR PLAN Scale: AS SHOWN
EE SPECIFICATIONS - VINDOW SCHEDULE	




## LEGEND \_ELEVATION INTERIOR WALL: NO. ELEVATIO SHEET NO. 5/8" gypsum board ea. side of 2 x 4s @ 16" o.c. INTERIOR WALL WITH KXXXXX ACOUSTICAL INSULATION: 5/8" gypsum board each side ELEVATI of 2 x 4's @ 16" o.c., 3" ThermaFiber acoustical insulation -SHEET EXTERIOR WALL: UKIKIKIKIKI Siding as shown on elevations, 1 1/2" zip R sheathing, 5/8 " Advantech engineered sheathing 2x6 studs 16" o.c., R-21 Batt insulation 5/8" gypsum board FOUNDATION WALL: ..... 10" reinforced concrete wall, stucco $\langle xx \rangle$ finish above grade, troweled on waterproofing below grade

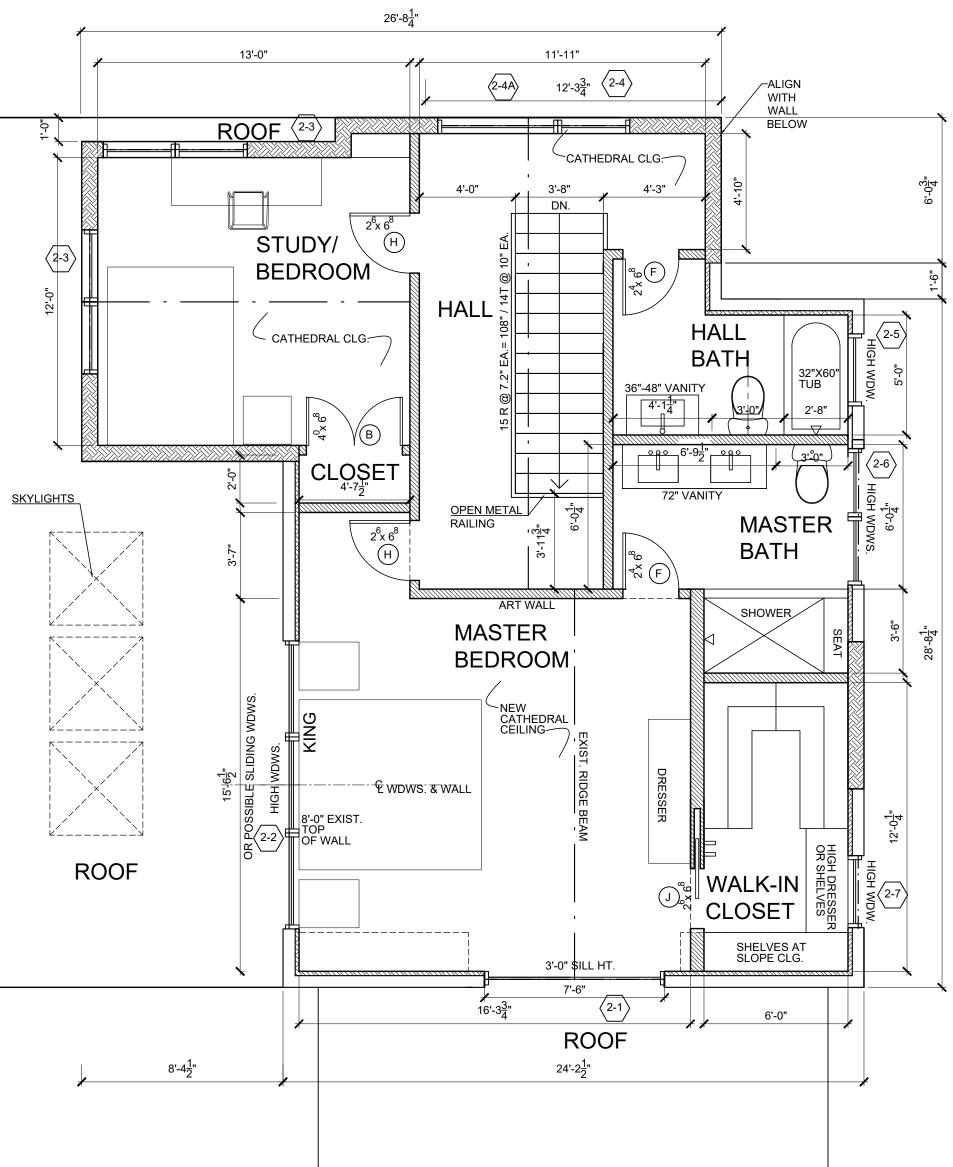


# SECOND FLOOR PLAN

SCALE: 1/4" = 1'-0"


RENOVATIONS & EXTENSIONS TO THE BRAMBRINK RESIDENCE 20 LYMAN PLACE, DOBBS FERRY, NY 10522
CHRISTINA GRIFFIN ARCHITECT PC 10 Spring Street Hastings-on-Hudson, New York 10706 914.478.0799 www.christinagriffinarchitect.com
Drawing Title     Date       Drawing Title     PRE-BID DOCUMENTS 8-12-21       SECOND FLOOR PLAN     BUILDING PERMIT SUBMISSION 9-16-21       BID DOCUMENTS 11-18-21     BID DOCUMENTS 11-18-21       Scale:     Scale:       AS SHOWN     Scale:
A-2

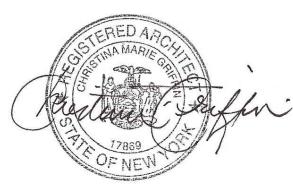



LEGEND			
<u> </u>	5/8" gypsum board ea. side of 2 x 4s @ 16" o.c.	VATION ELEVATION ET NO.	
	of 2 x 4's @ 16" o.c., 3" ThermaFiber acoustical insulation	LEVATION 10. SECTION DETAIL HEET NO.	
	EXTERIOR WALL: Siding as shown on elevations, 1 1/2" zip R sheathing, 5/8 " Advantech engineered sheathing 2x6 studs 16" o.c., R-21 Batt insulation 5/8" gypsum board	DOOR TYPE, FOR DESCRIPTION, SEE SPECIFICATIONS - DOOR SCHEDULE	
	FOUNDATION WALL: 10" reinforced concrete wall, stucco finish above grade, troweled on waterproofing below grade	WINDOW TYPE, FOR DESCRIPTION, SEE SPECIFICATIONS - WINDOW SCHEDULE	

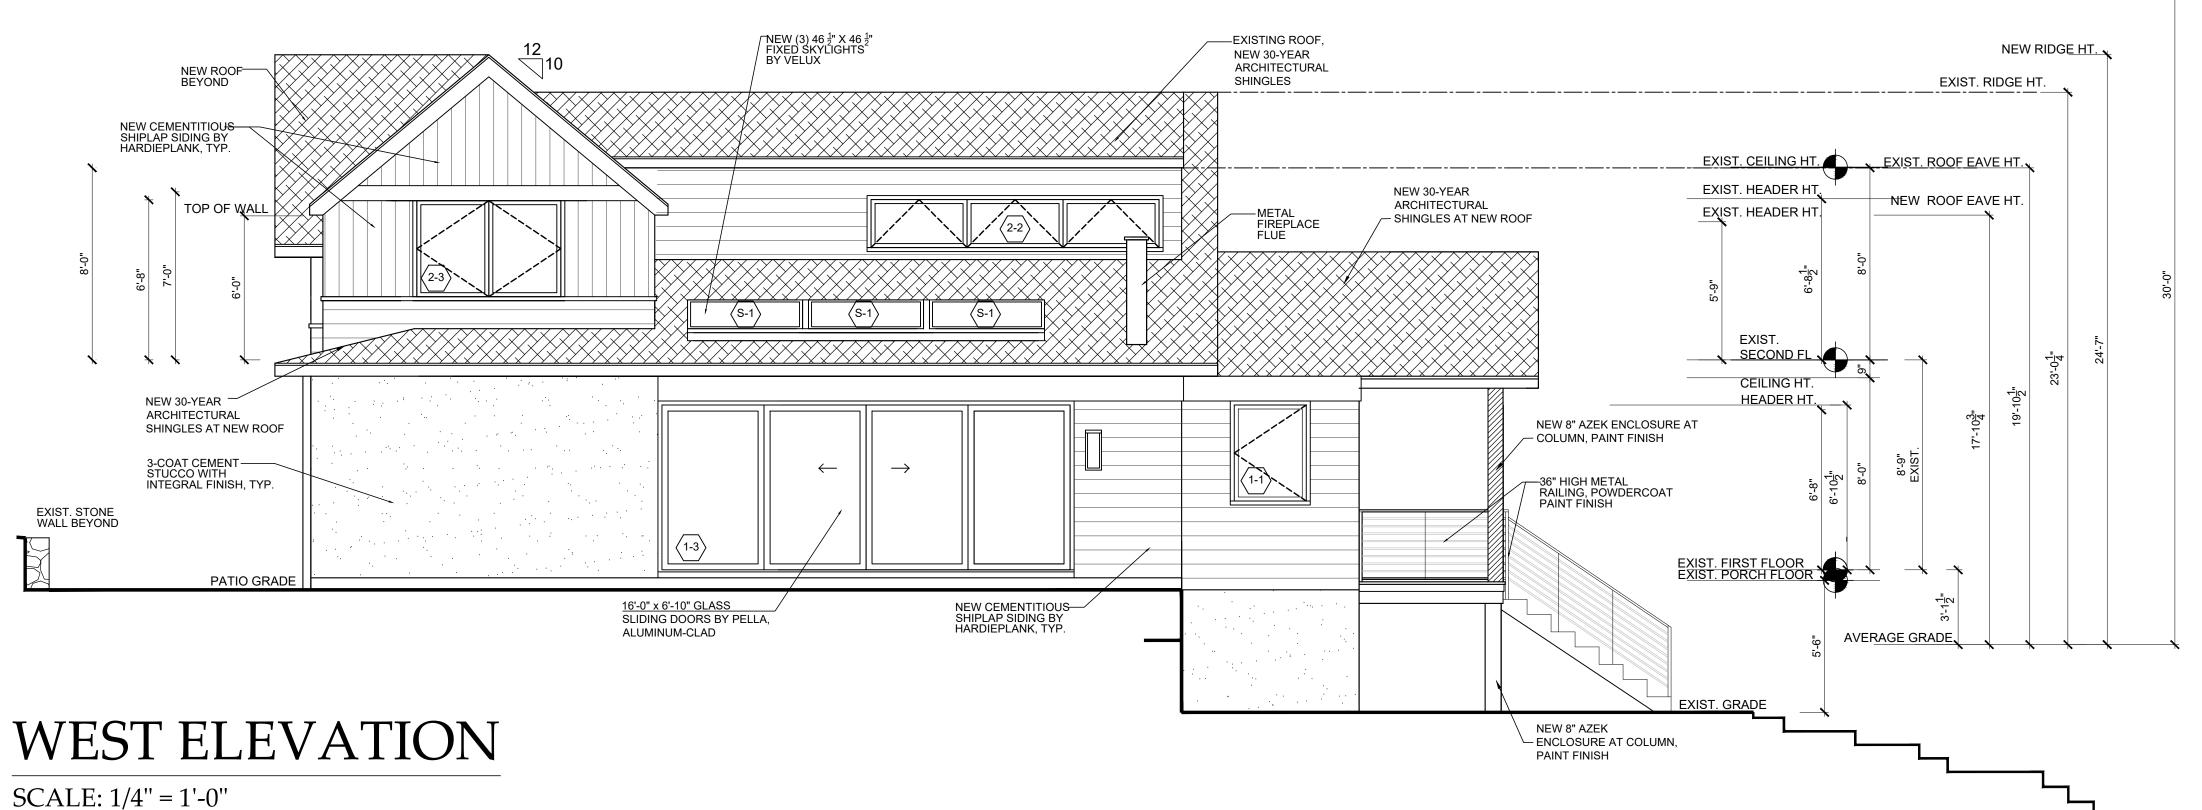


## SOUTH ELEVATION SCALE: 1/4" = 1'-0"

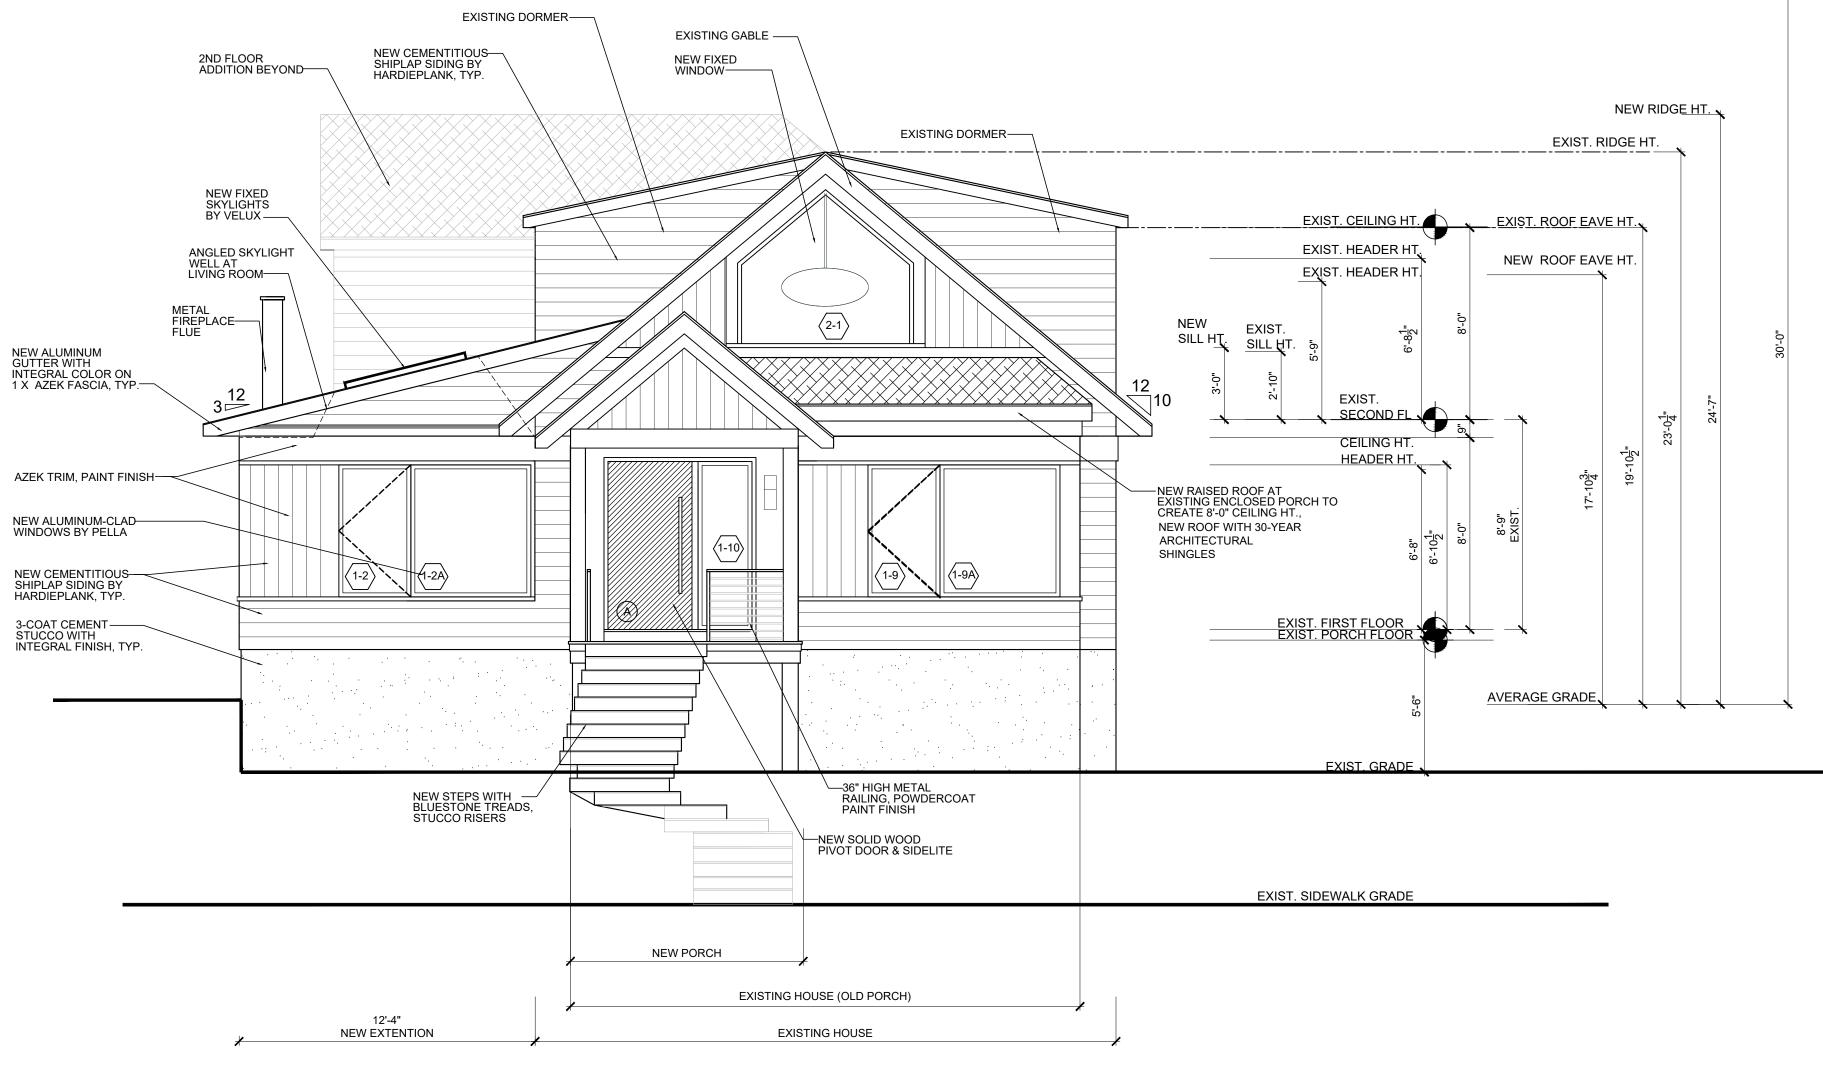


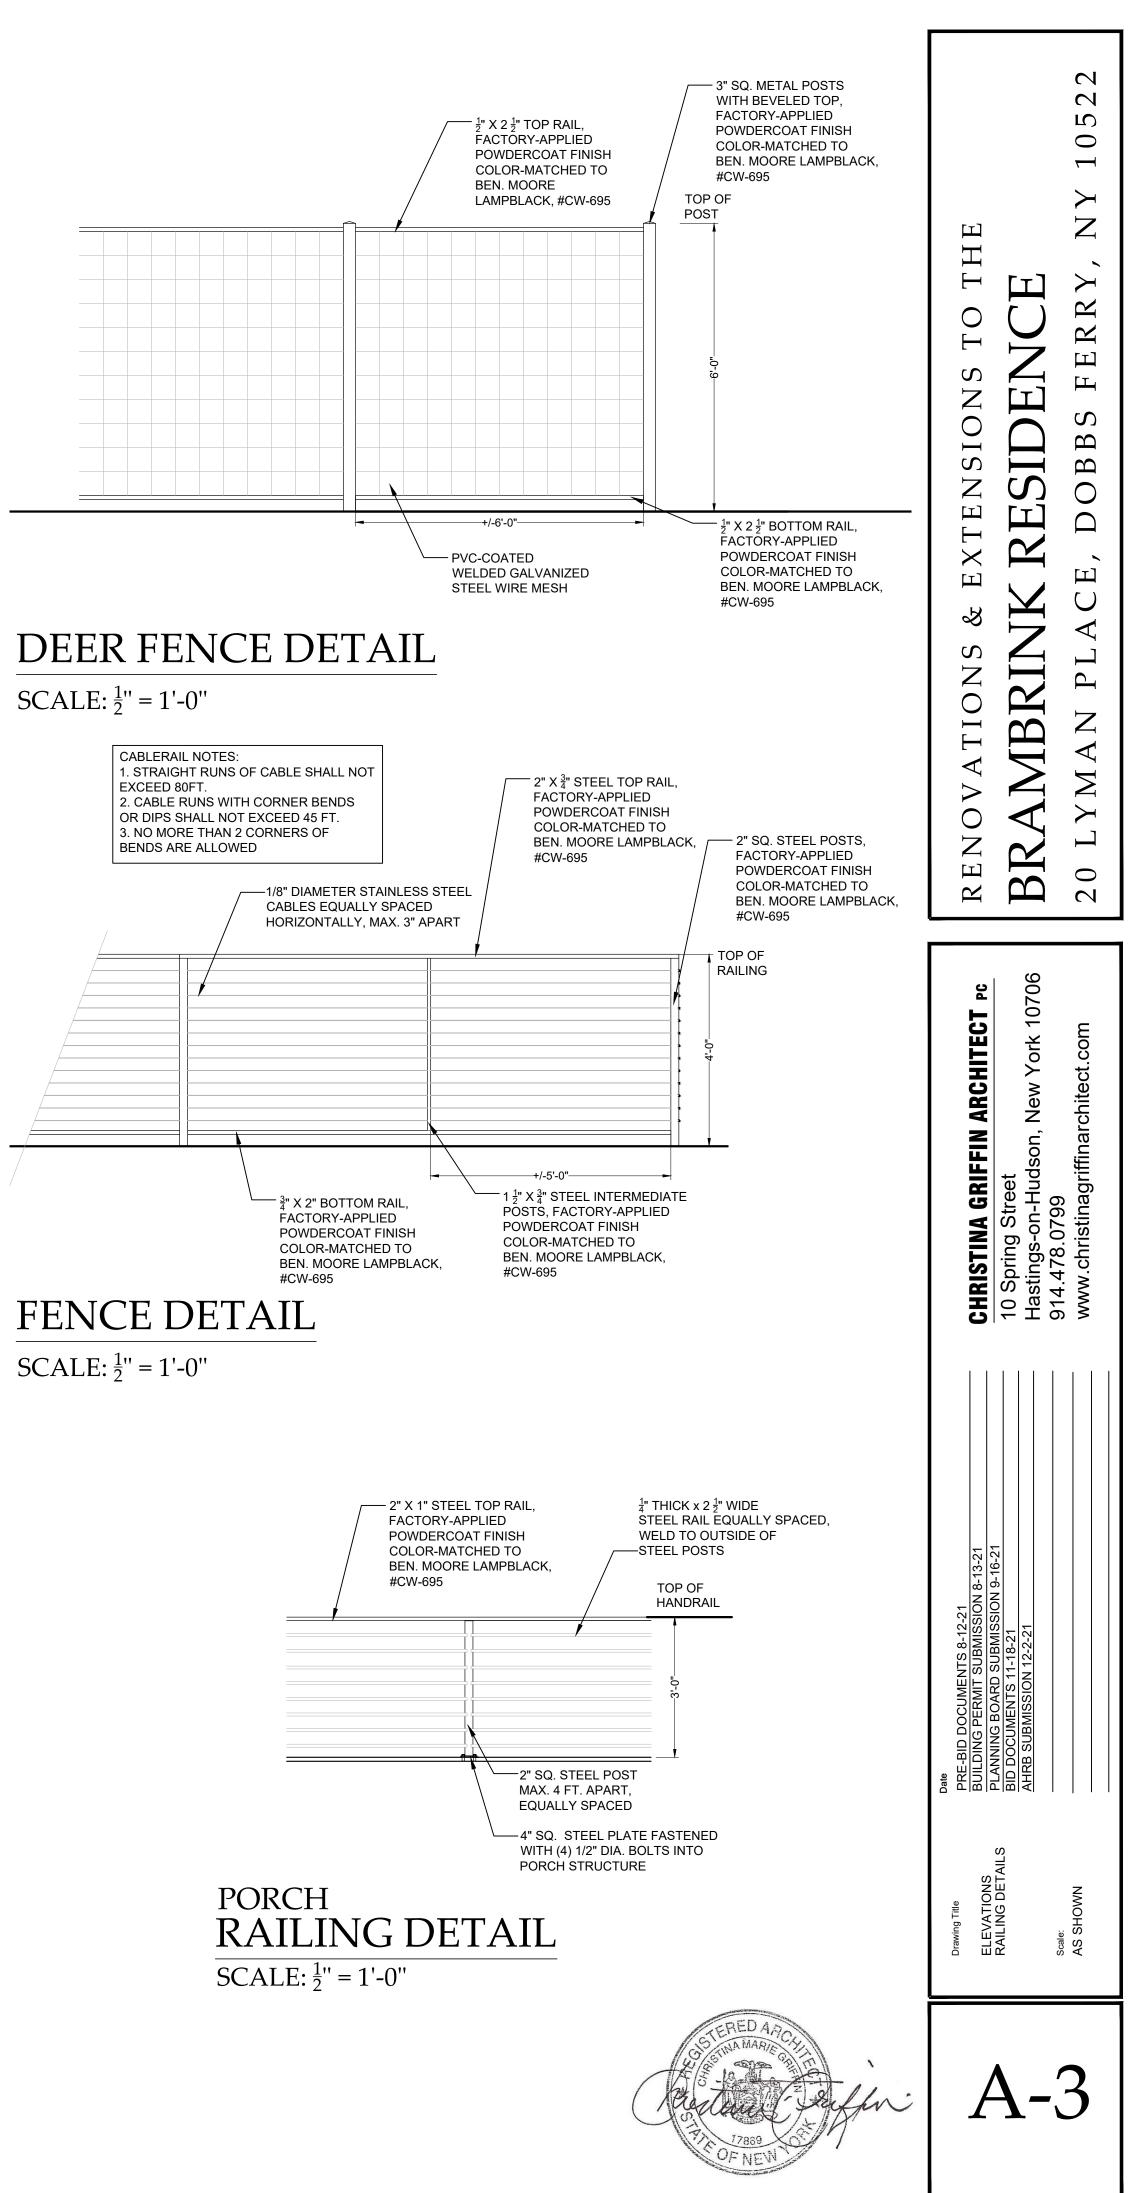

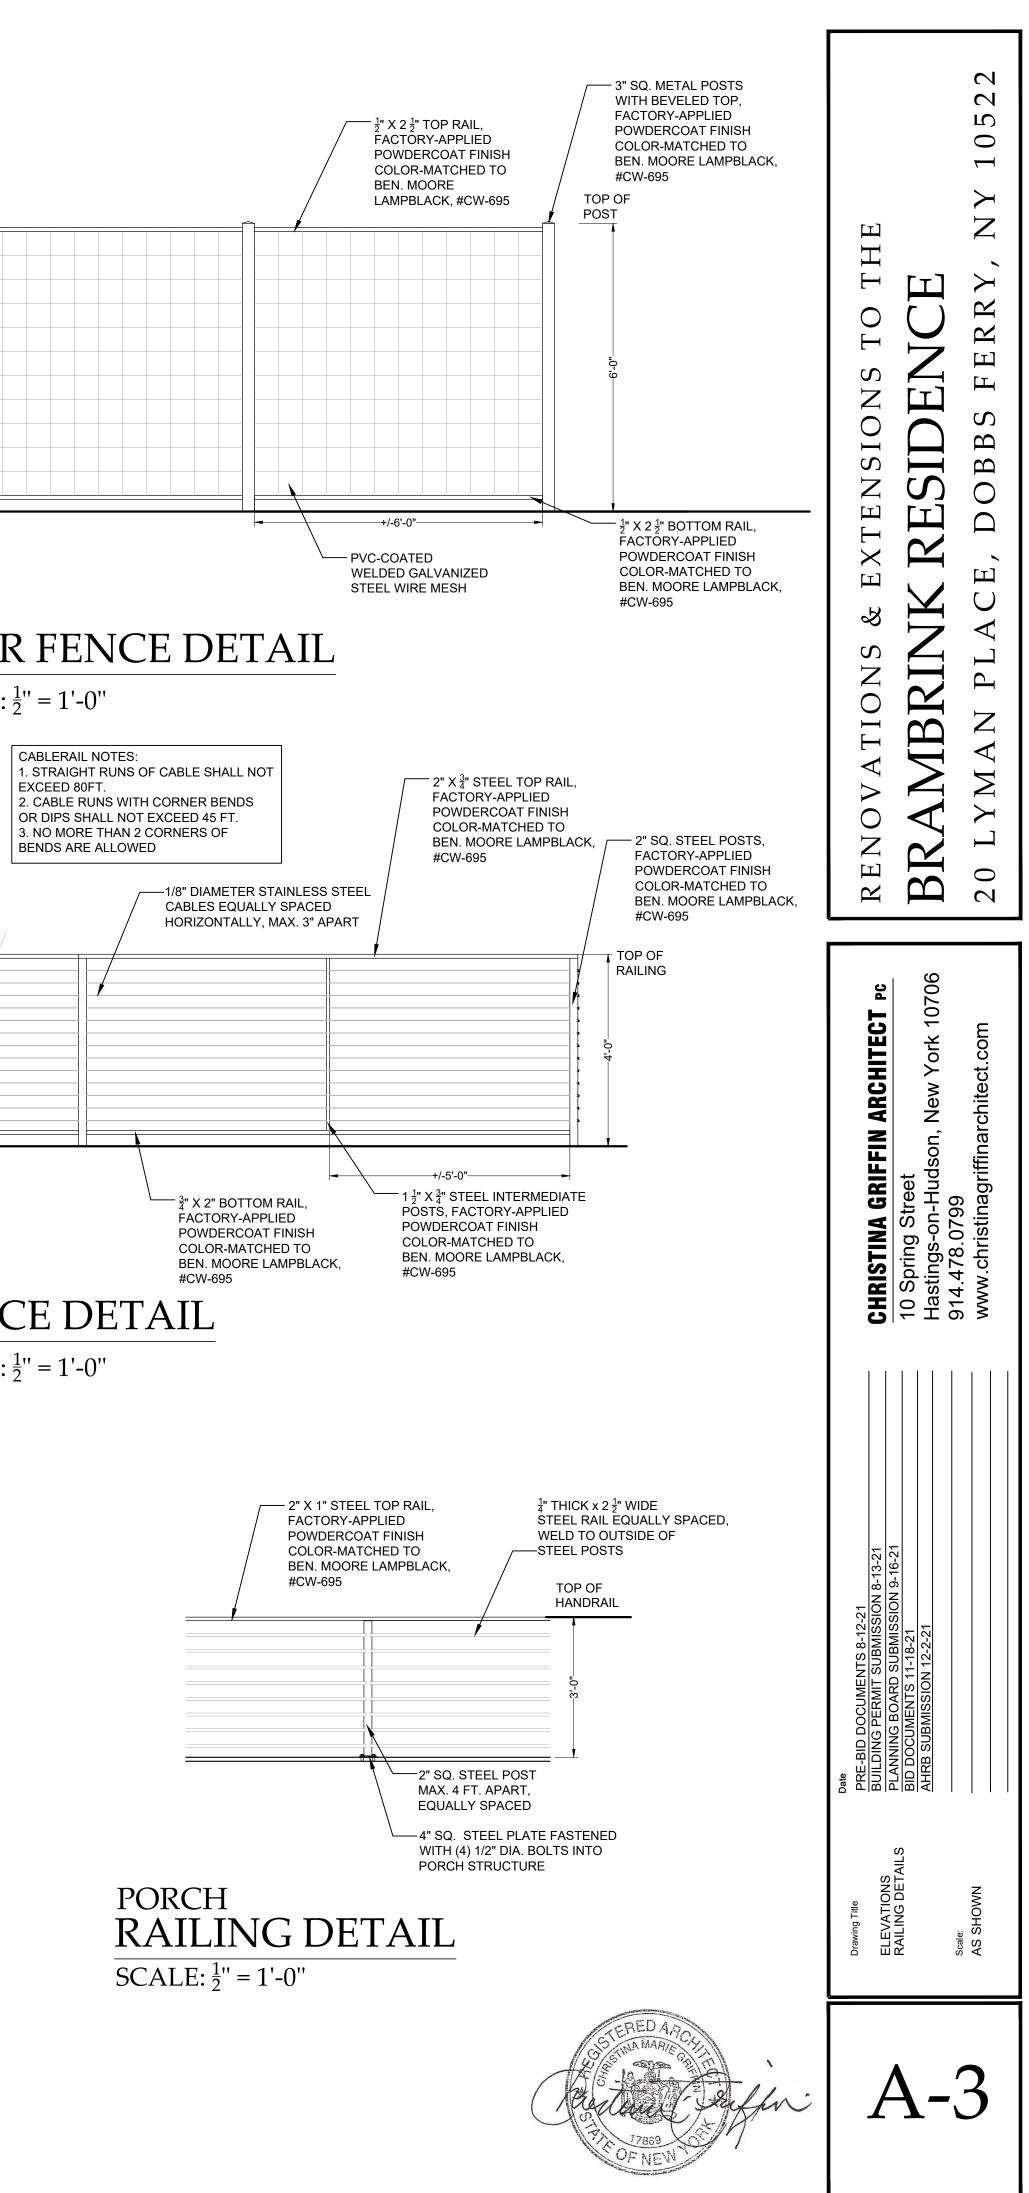

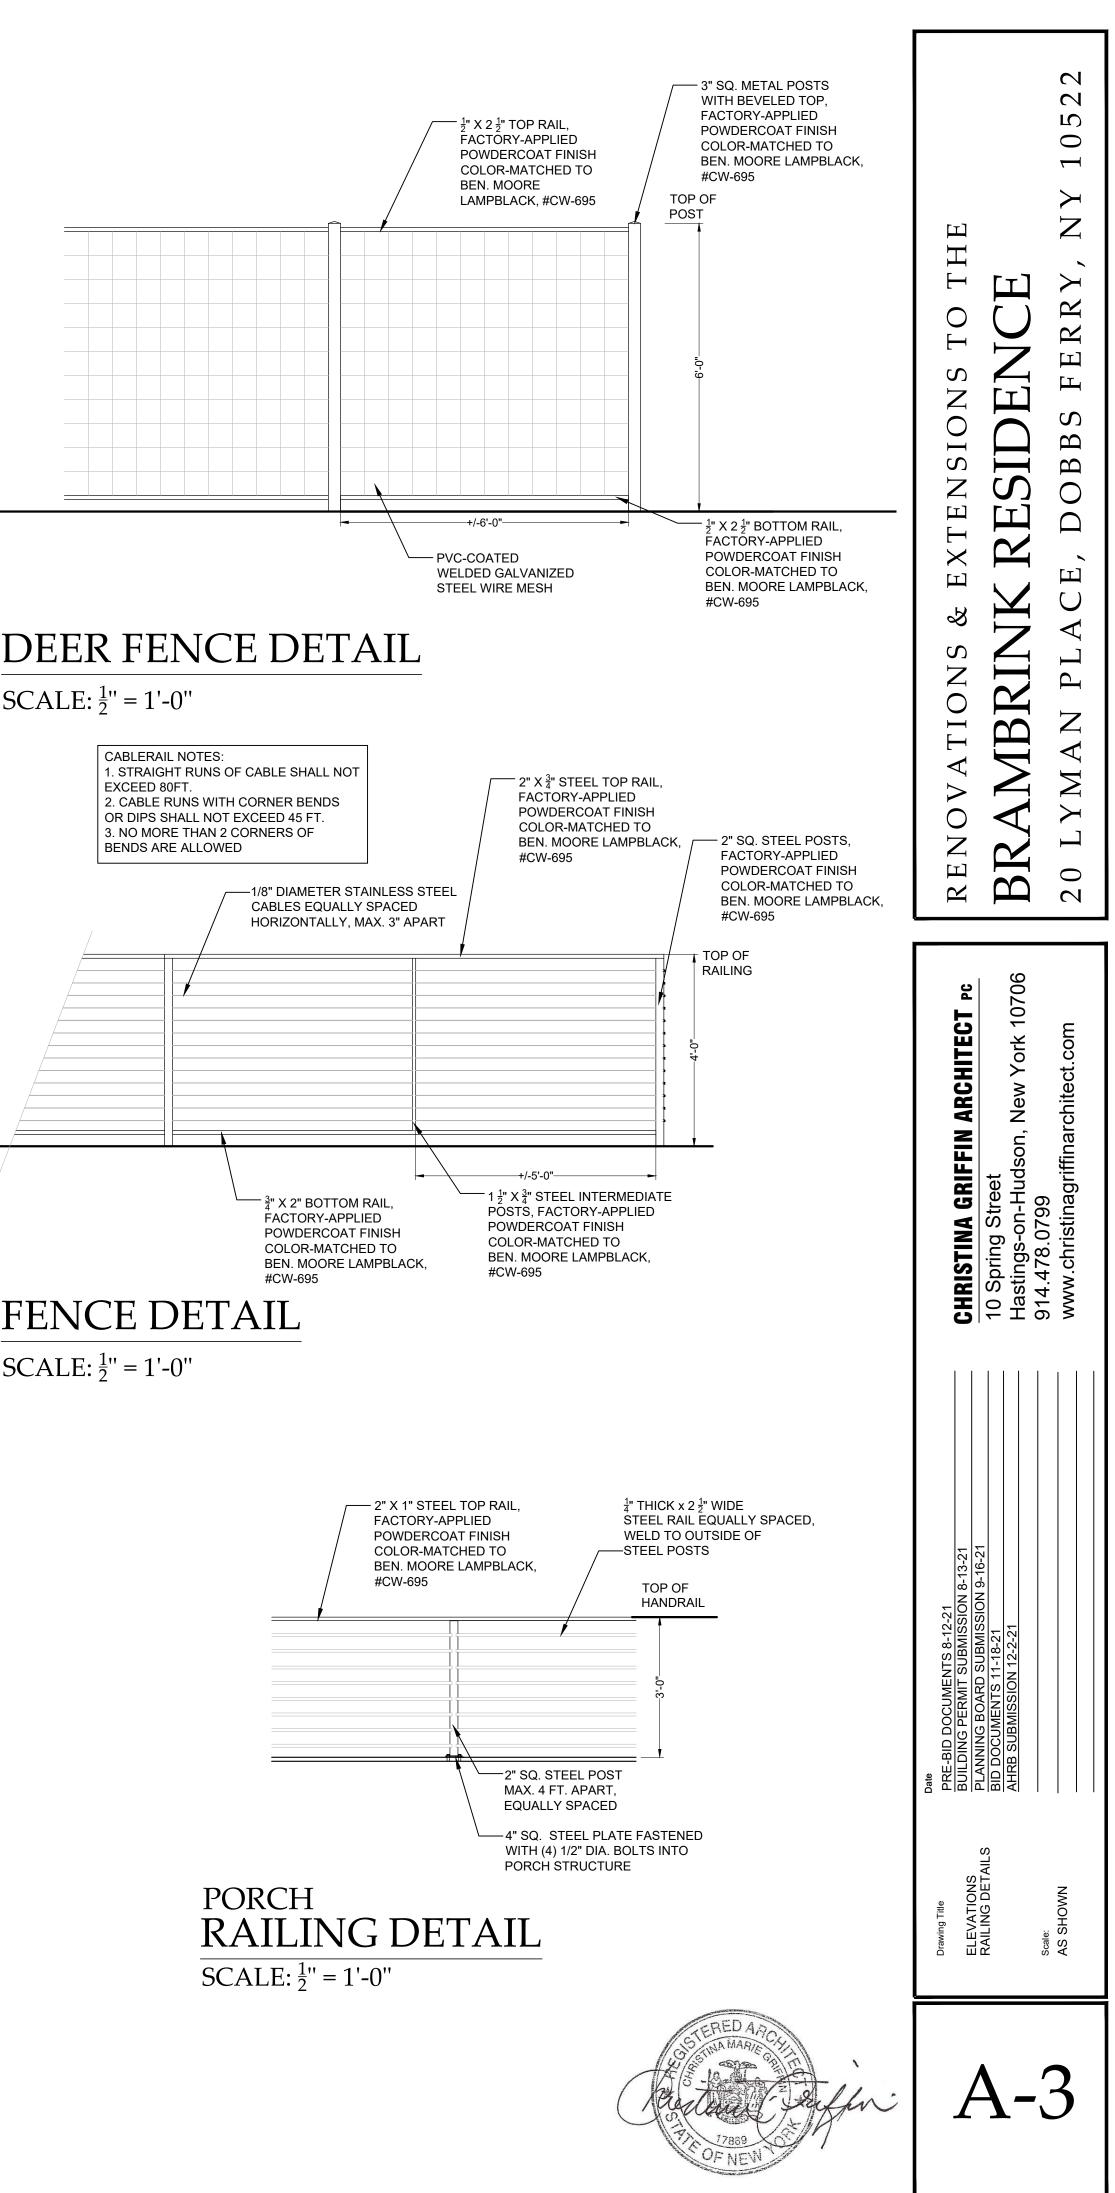

MAX. ALLOWABLE RIDGE HT.

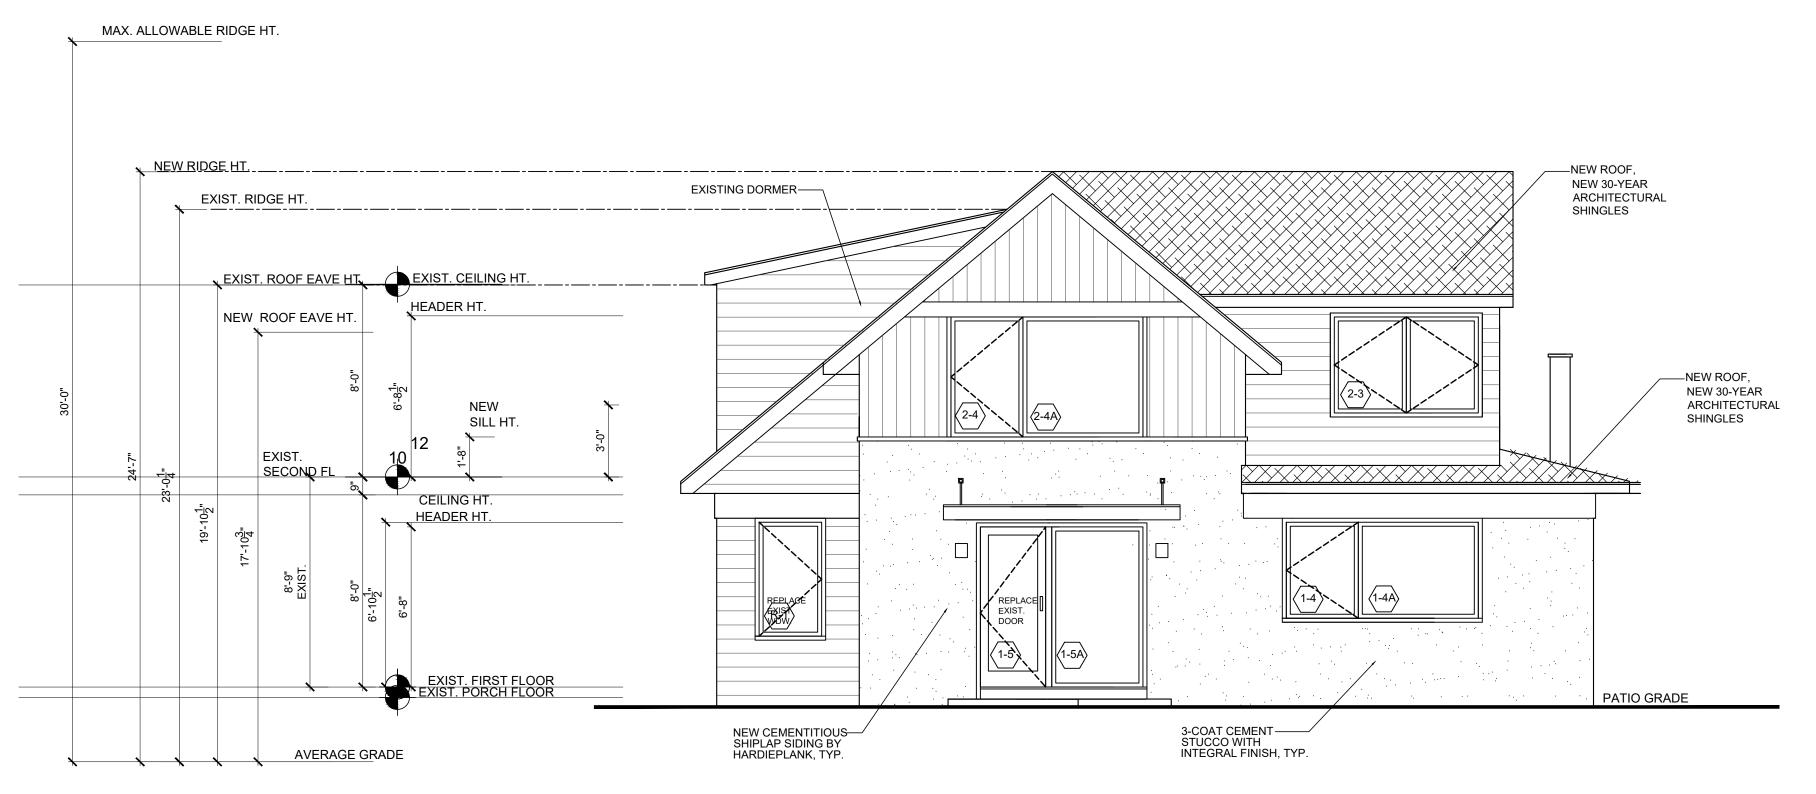



# NORTH ELEVATION


SCALE: 1/4" = 1'-0"

# EAST ELEVATION

SCALE: 1/4" = 1'-0"

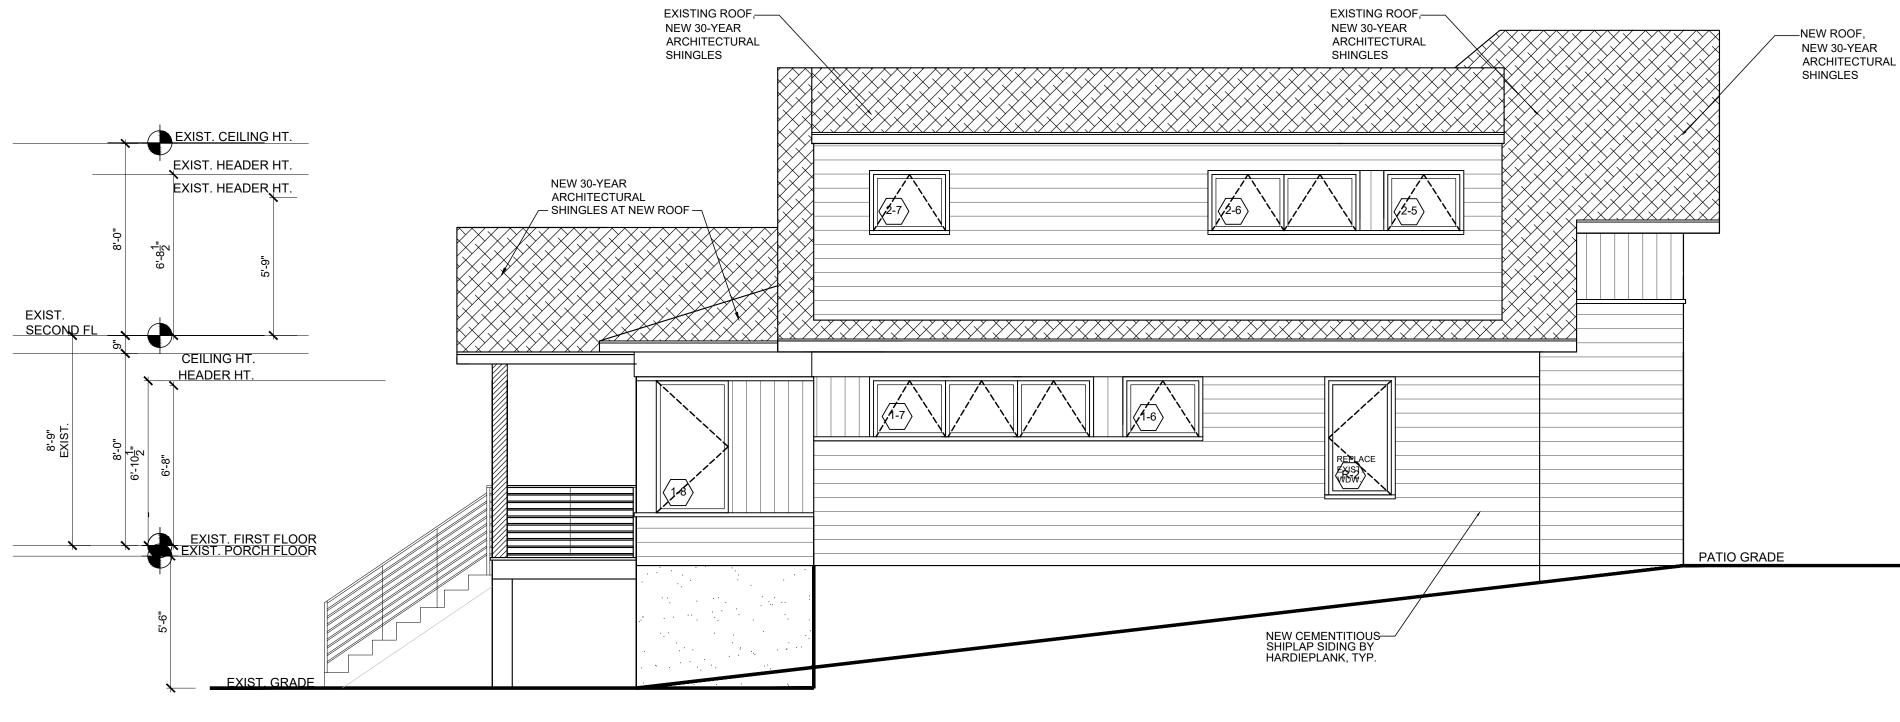


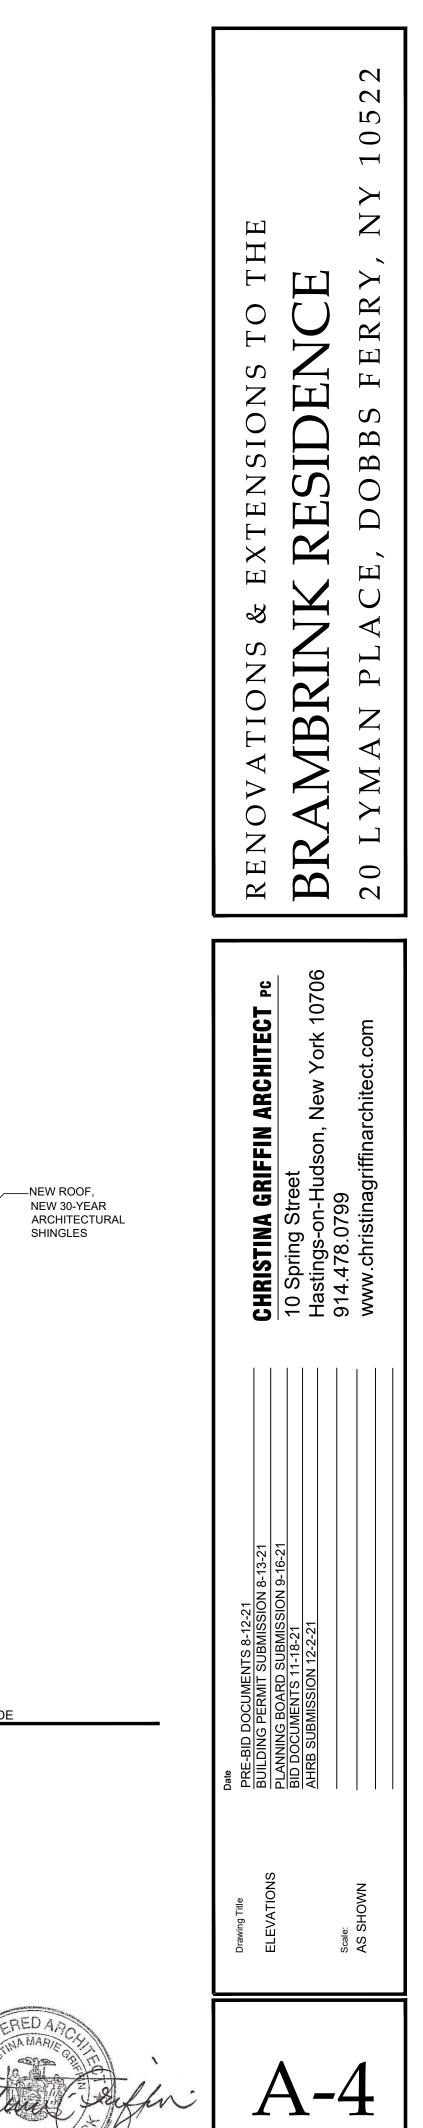

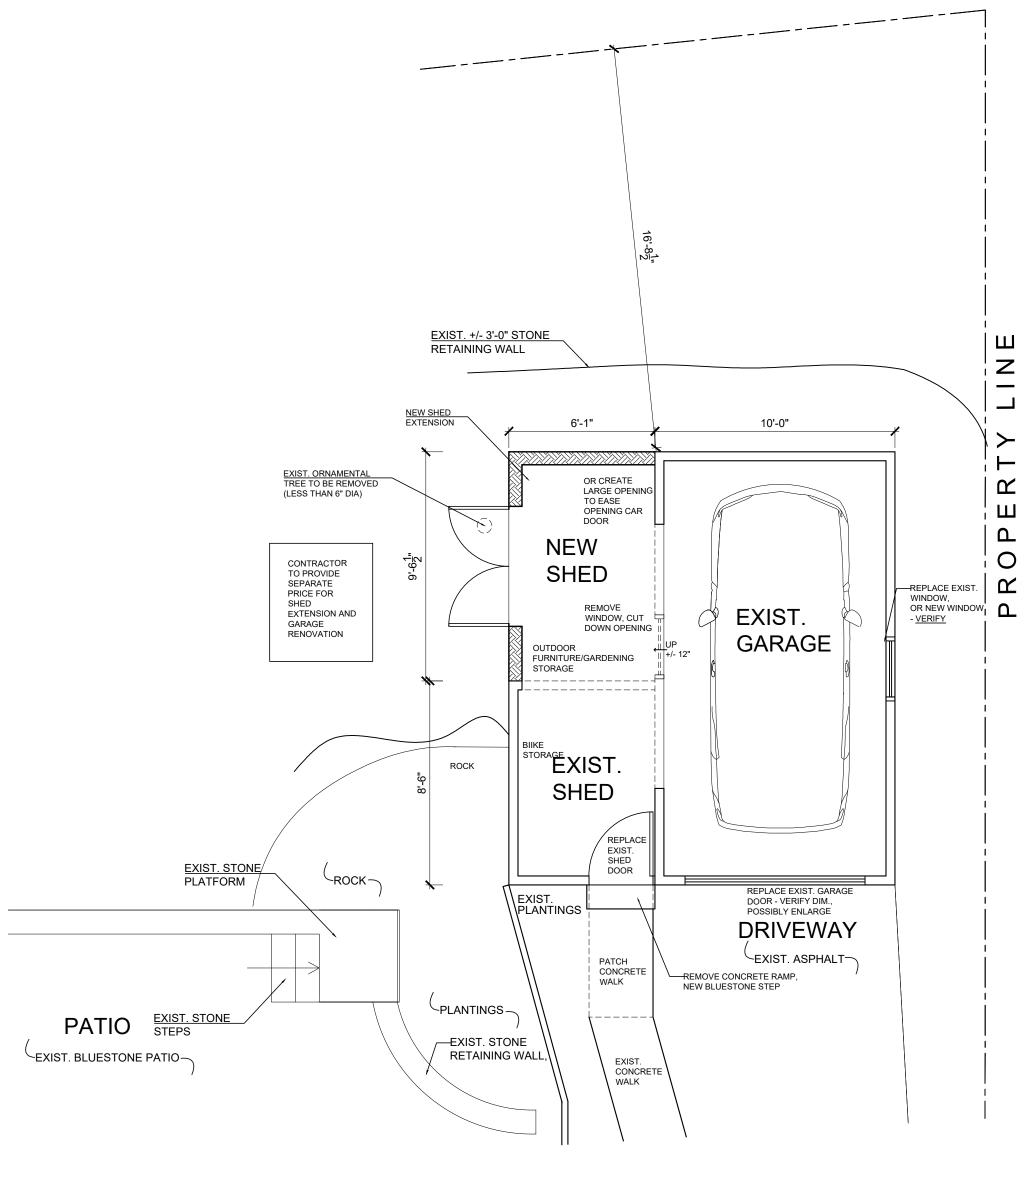

# GARAGE / SHED FLOOR PLAN

SCALE: 1/4" = 1'-0"

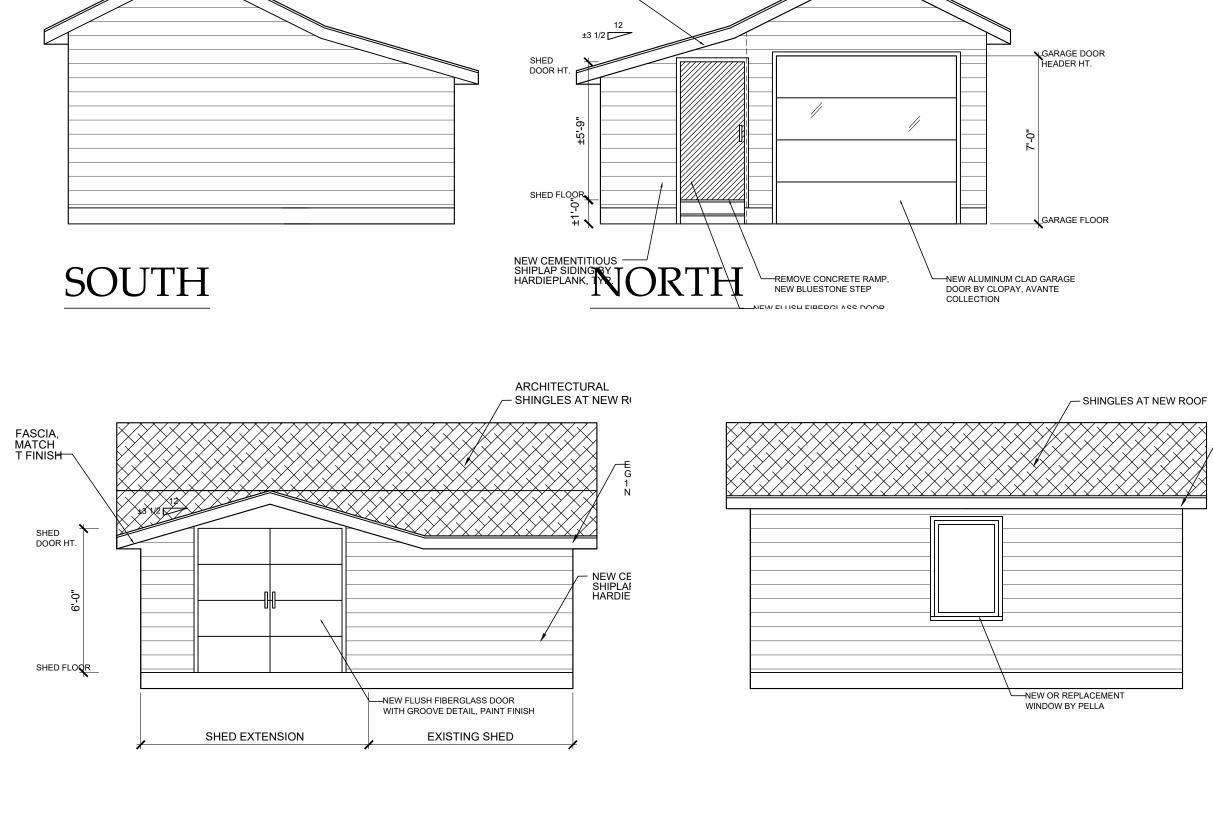

1 X WOOD FASCIA, NEW PAINT FINISH

## WEST

EAST

<u>12</u>±(

# GARAGE ELEVATIONS

SCALE: 1/4" = 1'-0"










# PHOTOS OF EXIST. GARAGE /SHED Scale: NTS


2 S 0  $\succ$ Ζ TΗE  $\mathbf{X}$  $\mathbf{N}$ Ο  $\mathbf{N}$ Η Ш SION Щ Гт S В OB TEN Ś ГЦ  $\square$ ΕX  $\sim$ Ш  $\mathfrak{R}$ 1 S TION С B Ζ A Ν  $\geq$ ENO  $\succ$  $\frown$ BI 0  $\mathbf{R}$ 2

2

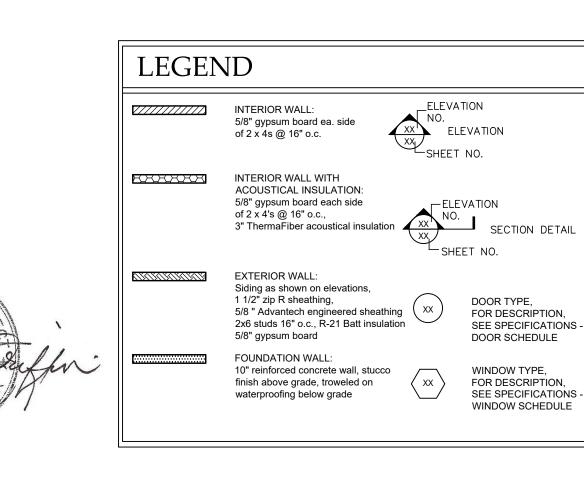

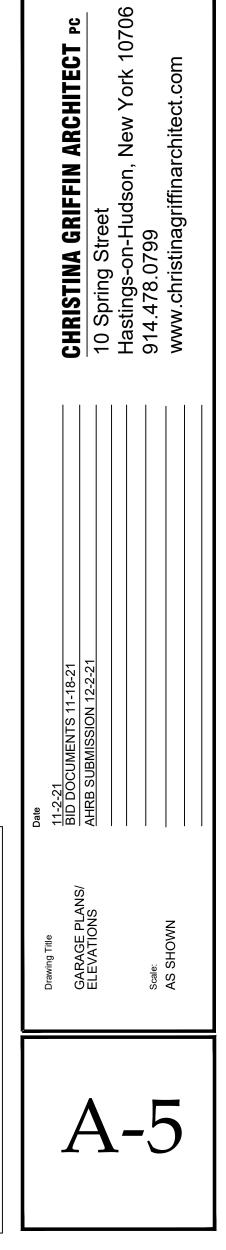

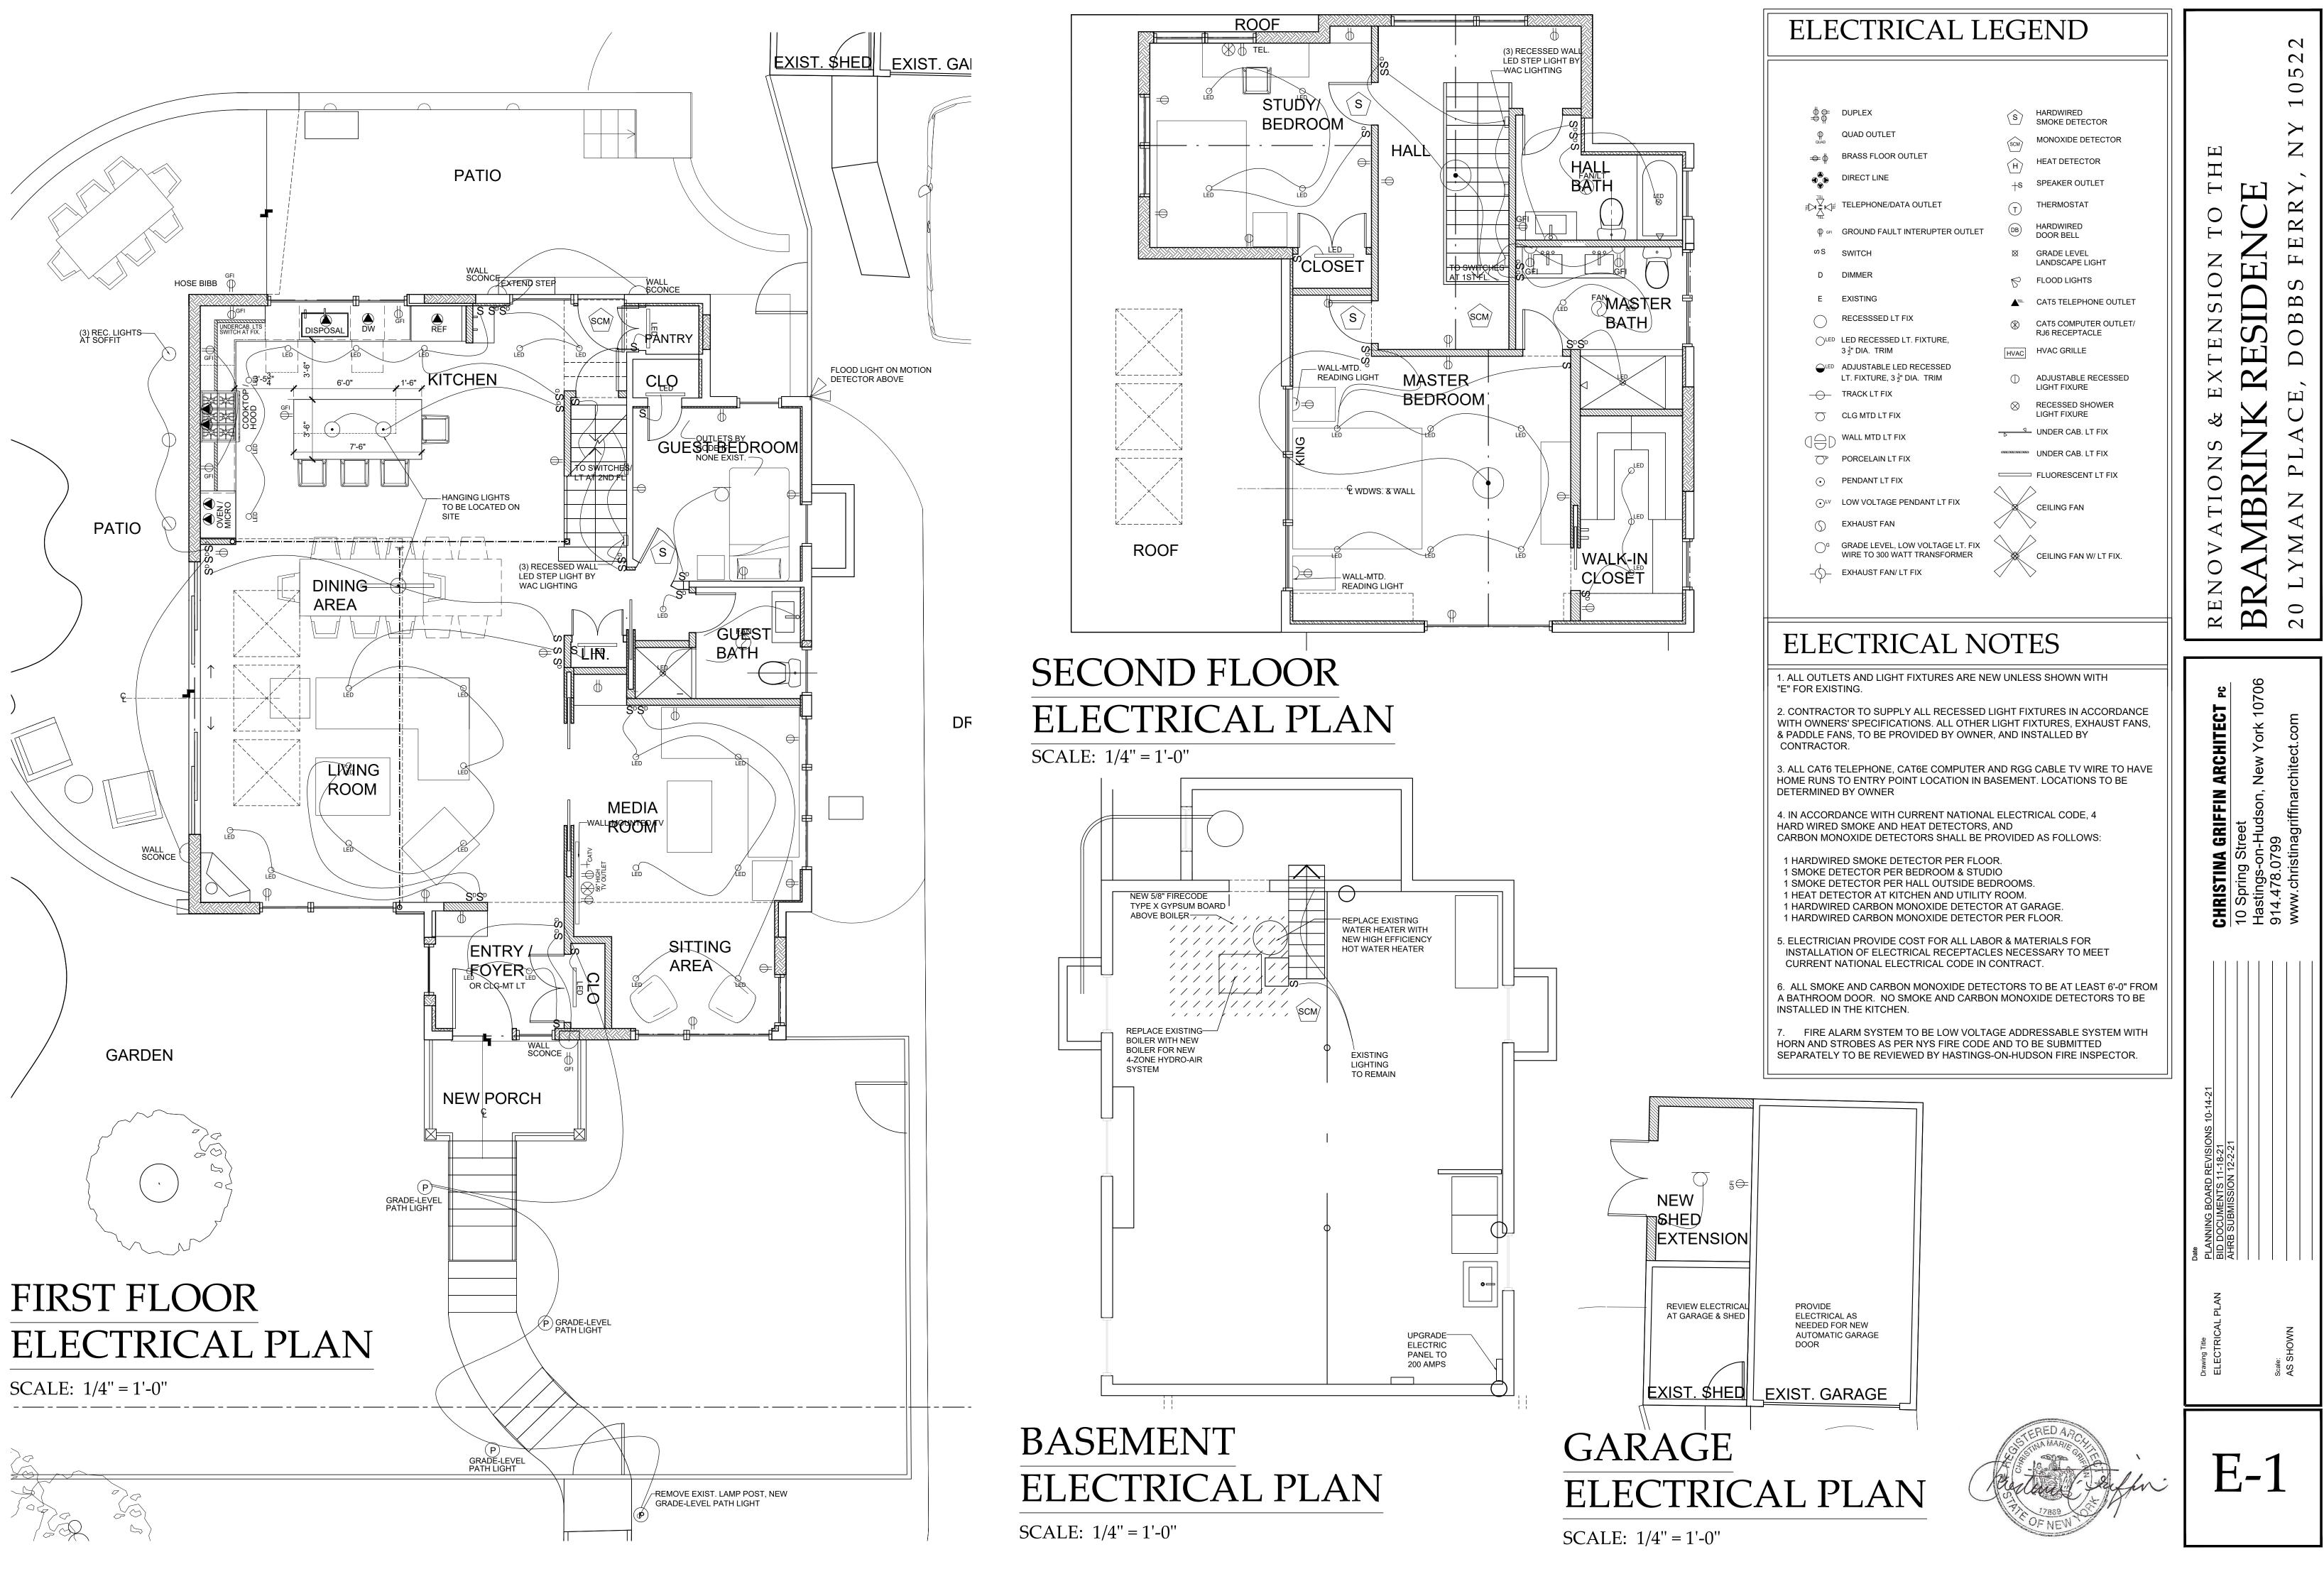

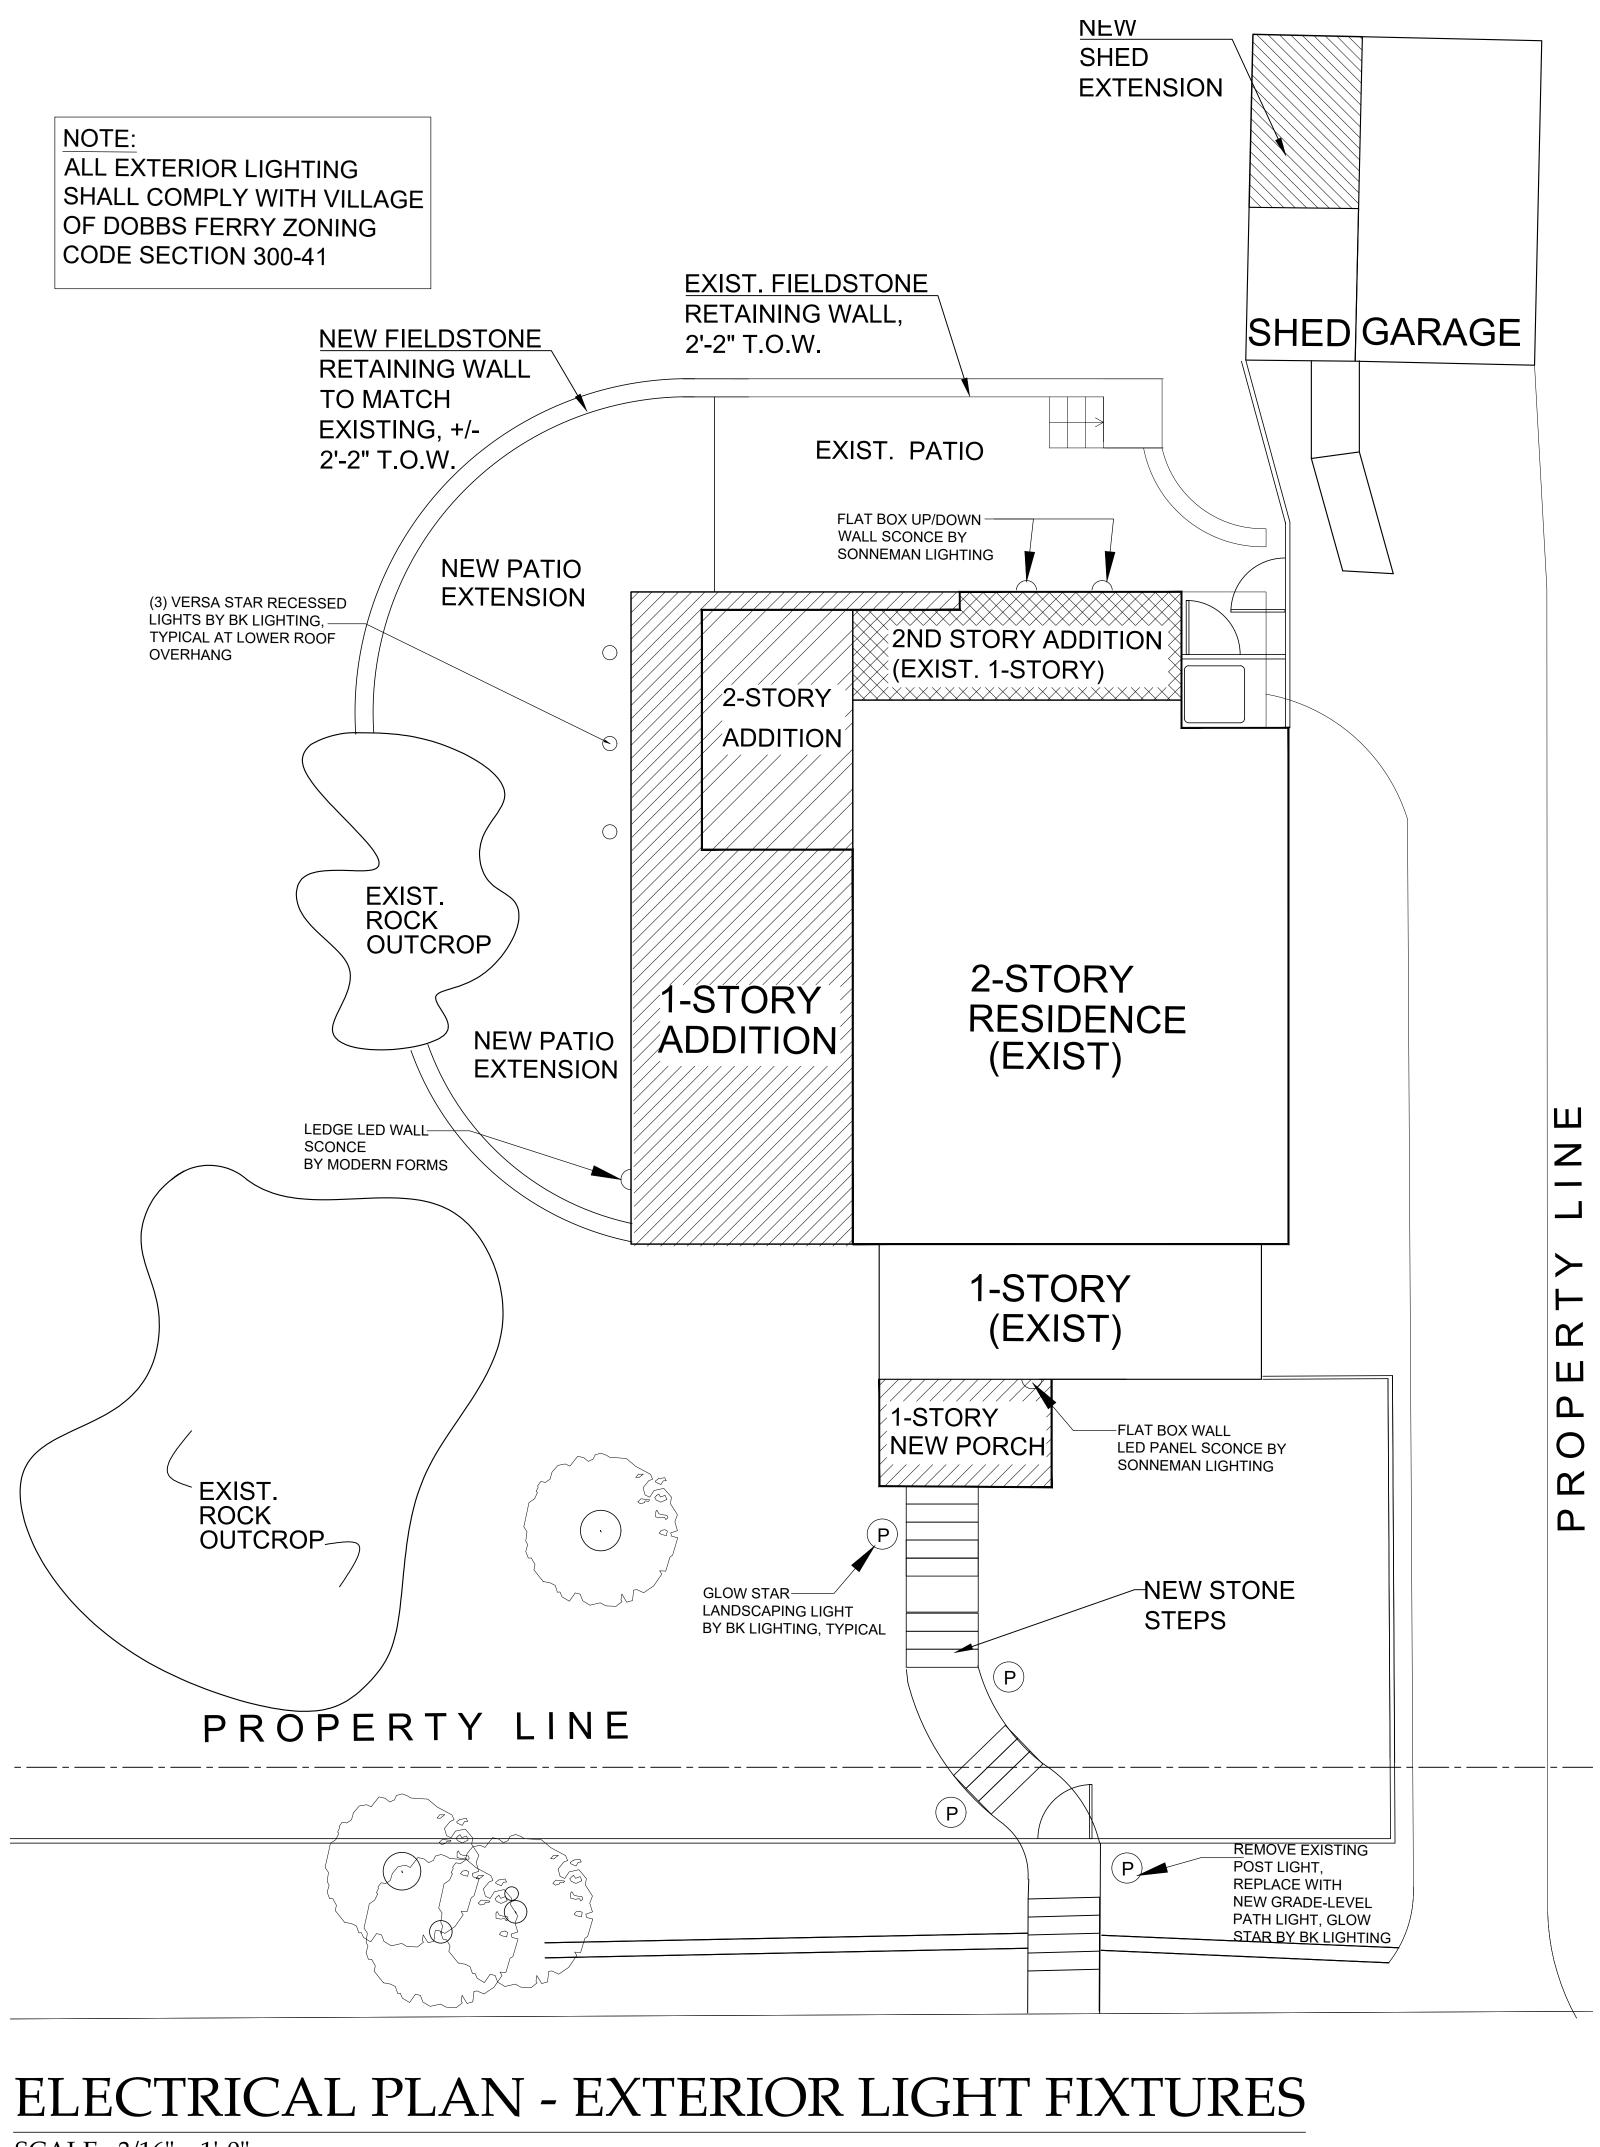

SCALE: 3/16" = 1'-0"



LEDGE WALL SCONCE BY MODERN FORMS, 8" W X 20" H X 4" D **ALUMINUM FINISH** 




FLAT BOX WALL SCONCE BY SONNEMAN LIGHTING, 6" W X 17" H X 2.5" D TEXTURED GREY FINISH



GLOW STAR LANDSCAPE LIGHT BY BK LIGHTING, STYLE "K" 2 1/2" DIAMETER,  $6\frac{3}{4}$ " HIGH SATIN ALUMINUM FINISH



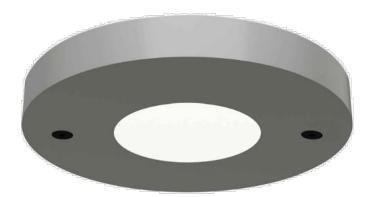

VERSA STAR RECESSED LIGHT BY BK LIGHTING, 5" DIAMETER, SATIN ALUMINUM FINISH



FLAT BOX WALL SCONCE BY SONNEMAN LIGHTING, 6" W X 7" H X 2.5" D **TEXTURED GREY FINISH** 



RENOVATIONS & EXTENSION TO THE	BRAMBRINK RESIDENCE	20 LYMAN PLACE, DOBBS FERRY, NY 10522	
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Date PLANNING BOARD REVISIONS 10-14-21 AHRB SUBMISSION 12-2-21			
Drawing Title ELECTRICAL PLAN Scale: AS SHOWN			