Modifications to 24 ELDREDGE PLACE - Phase 2 - Addition

APPLICATION # A 2022 - 0230

TREE REMOVAL APPLICATION # AT2022-0069

GENERAL REQUIREMENTS

1. Related Documents: Drawings, Specifications and General Conditions of the Contract for Construction apply to Work of this Project.

2. Scope of Work: Includes all items described in Drawings & Specifications, verbally & graphically, with more stringent and/or costly items assumed in all cases of discrepancy.

3. All new construction shall adhere to the 2020 Residential Code of NYS. Notify Architect of any inadvertent noncompliance with Codes regarding information contained in Drawings and Specifications, with no Work to be performed knowingly in noncompliance with Code.

4. The General Contractor (G.C.) shall coordinate all work procedures w/ requirements of Local Authorities. Prior to commencement of Construction, the G.C. shall be responsible for the acquisition of a Building Permit and pay all fees required by Governing Agencies. The G.C. shall be responsible for calling for Inspections and Sign-offs of all Work, including Plumbing & Electrical, as required by Governing Agencies.

5. The G.C., Subcontractors, and all others working for Owner shall comply with National, State, and Local Laws and Regulations relating to insurance for work under this Contract. The following insurance policies shall be in force and copies shall be submitted to Architect prior to signing Agreement Between Owner and Contractor: Workman's Compensation & Unemployment Insurance as required by law, Contractor's Liability Coverage in the amount required by applicable Governing Agencies, & Liability Coverage for damages & uninstalled materials. The G.C. shall submit to the Owners, Insurance Certificates naming Owner as Additional Insured. All insurance shall be at Contractor's expense.

6. All Terms & Conditions laid out in the A.I.A. Standard Form Of General Conditions shall apply to the G.C. & to all of his Sub-Contractors.

7. The G.C. & Subcontractors shall attend regular job meetings as required by the Architect.

DIVISION 01: PROJECT REQUIREMENTS

1. The G.C. shall verify all Dimensions & Conditions in the field prior to Construction. Any discrepancies are to be brought to the attention of the Architect prior to work. The G.C. shall be responsible for Field Fit & Quality of all Work, whether by the G.C. or by Subcontractors. No allowances shall be made on behalf of the G.C. for any error or neglect on his part. Under no circumstances are the Drawings to be scaled for location of Work. G.C. shall verify all clearances & locations prior to installation including requirements for appliances, fixtures, or equipment.

2. Retain licensed Surveyor to mark site before beginning construction and to verify location of foundation and slab-on-grade formwork before pouring concrete. Verify that all work conforms to zoning requirements including all setbacks and yard requirements.

3. The G.C. shall be responsible for the protection of all new & existing Work, Owner's Property, Building, and its Premises from damage & dirt or dust.

4. Plumbing & Electrical Work shall be performed by Contractors licensed in their trade. G.C. shall be licensed to perform the Work as required. 5. The G.C. shall maintain at the Site one Record Copy of all Drawings, Clarification Sketches, Approved Shop Drawings, Approved Samples, and Change Orders continuously updated to record all changes during Construction. G.C. shall fully correct, at no additional expense, all Work wrongly constructed or

6. Details not usually shown or specified, but necessary for proper construction on any part of the work shall be included as if they were indicated in the Drawings.

7. Architectural Drawings shall be Followed as closely as actual Field Conditions & the work of other trades permit. Any piping, wiring, or materials not specifically shown or specified but required to complete Work shall be deemed to be part of Work & shall be furnished & installed by the G.C.

8. G.C. shall prepare schedule for completion of Work prior to commencement and submit to Architect for approval. Contractor shall follow approved schedule and immediately notify Architect of any deviations from the approved schedule.

9. The G.C. must submit all Engineering & Shop Drawings (including Millwork) & cut sheets of all equipment, plumbing & electrical fixtures, hardware & accessories to the Architect for approval prior to Fabrication, Ordering and/or Construction. Shop Drawings shall be revised per Architect's instruction if required prior to approval.

10. The G.C. shall supervise & be solely responsible for all aspects of the Work, including Site Safety, maintenance of exit clearances & fire extinguishers as required by Code. The G.C. shall have sole responsibility for any damage or injuries caused by or during the execution of the Work.

11. The G.C. shall be responsible for demolition & safe removal from the Site of all materials that must be removed to enable completion of Work and occupation of the Premises. All removed materials shall be disposed of regularly in a legal manner.

12. All piping & wiring to be demolished shall be removed to a point of concealment & shall be properly capped or plugged.

13. The G.C. shall do all cutting, patching & repairing as required to perform all Work required to complete the Job. All patching where new construction

occurs shall match existing adjacent or as indicated on the Drawings.

14. All new construction shall be laid-out in field for Architect's approval prior to starting construction.

15. No changes to approved layouts shall be made without Written Consent Of The Architect.

16. When "Approved Equal", "Equal To", "Similar" or other general qualifying terms are used, it shall be subject to final review by the Architect. There shall be no substitutions unless agreed upon in writing by the Architect.

17. The G.C. shall verify all equipment dimensions, locations & hook-ups with Manufacturer's Specifications whether the G.C. or Others supply the equipment.

18. All items noted "Furnished By Owner" shall be installed by the G.C. under this Contract as per Manufacturers' Specifications & industry standards. Wall reinforcement & all other requirements required to incorporate Owner furnished items shall be provided & coordinated by the G.C.

19. G.C. shall employ experienced workers or professional cleaners for final cleaning prior to request of inspection for Certificate of Substantial Completion.

STRETCH ENERGY CODES

materials wrongly ordered from obsolete Drawings.

1. This design is in compliance with requirements of 2020 Energy Conservation Code of NYS, the 2020 Residental Code of NYS, and the 2020 NYStretch Code.

2. Contractor shall perform all work in accordance with applicable codes listed above. 3. Updated Table R420.1.4 below showing updated values prevails where applicable. WESTCHESTER NY: CLIMATE ZONE 4A

2020 ENERGY CONSERVATION CODE OF NEW YORK STATE

Table R402.1.2 – Envelope (U-factor Table R402.1.4 changed accordingly. Prescriptive, e.g., can be traded.)

Stretch Code 0.27 0.50 .04 49 21 or 20+5 or 13+10 15/20 30 ^a 15/19 10, 4 ft. 15/19		Climate Zone 4	Fen U-Factor	SkyLt U-Factor	SHGC	Ceiling R-Val	Wood Wall R-Value	Mass Wall R-Value	Floor R-Val	Bsmt Wall R-value	Slab R-Value/ Depth	Crawl Sp Wall R-Value
	001		0.27	0.50	.04	49	20+5 or	15/20	30ª	15/19	10, 4 ft.	15/19

INSULATION AND FENESTRATION REQUIREMENTS BY COMPONENT®

CLIMATE ZONE	FENESTRATION <i>U</i> -FACTOR [₽]	SKYLIGHT [®] <i>U</i> -FACTOR	GLAZED FENESTRATION SHGC ^{5, 6}	CEILING <i>R</i> -VALUE	WOOD FRAME WALL <i>R</i> -VALUE	MASS WALL <i>R</i> -VALUE	FLOOR <i>R</i> -VALUE	BASEMENT [®] WALL <i>R</i> -VALUE	SLAB ^d <i>R</i> -VALUE & DEPTH	CRAWL SPACE [©] WALL <i>R</i> -VALUE
1	NR	0.75	0.25	30	13	3/4	13	0	0	0
2	0.40	0.65	0.25	38	13	4/6	13	0	0	0
3	0.32	0.55	0.25	38	$20 \text{ or } 13 + 5^{\text{h}}$	8/13	19	5/13 ^f	0	5/13
4 except Marine	0.27	0.55	0.40	49	20 or 13 + 5 ^h	8/13	19	10/13	10,2 ft	10/13
5 and Marine 4	0.30	0.55	NR	49	20 or 13 + 5 ^h	13/17	30 ^g	15/19	10, 2 ft	15/19
6	0.30	0.55	NR	49	$20 + 5^{h}$ or $13 + 10^{h}$	15/20	30 ^g	15/19	10,4 ft	15/19
7 and 8	0.30	0.55	NR	49	$20 + 5^{h}$ or $13 + 10^{h}$	19/21	38 ^g	15/19	10,4 ft	15/19

For SI: 1 foot = 304.8 mm.

NR = Not Required. a. R-values are minimums. U-factors and SHGC are maximums. Where insulation is installed in a cavity that is less than the label or design thickness of the insulation, the installed *R*-value of the insulation shall be not less than the *R*-value specified in the table.

b. The fenestration U-factor column excludes skylights. The SHGC column applies to all glazed fenestration.

c. "10/13" means R-10 continuous insulation on the interior or exterior of the home or R-13 cavity insulation on the interior of the basement wall. "15/19" means R-15 continuous insulation on the interior or exterior of the home or R-19 cavity insulation on the interior of the basement wall. Alternatively, compliance with "15/19" shall be R-13 cavity insulation on the interior of the basement wall plus R-5 continuous insulation on the interior or exterior of the home. d. R-5 insulation shall be provided under the full slab area of a heated slab in addition to the required slab edge insulation *R*-value for slabs. as indicated in the table. The slab edge insulation for heated slabs shall not be required to extend below the slab.

e. Reserved.

wall

f. Reserved

g. Alternatively, insulation sufficient to fill the framing cavity providing not less than an *R*-value of R-19.

h. The first value is cavity insulation, the second value is continuous insulation. Therefore, as an example, "13+5" means R-13 cavity insulation plus R-5 continuous insulation i. Mass walls shall be in accordance with Section N1102.2.5. The second *R*-value applies where more than half of the insulation is on the interior of the mass



SPRINKLER NOTE

1. SPRINKLER SYSTEM FOR EXISTING HOUSE AND PROPOSED ADDITION WILL BE FILED UNDER APPLICATION # A2022-0230, TO INCLUDE SPRINKLER SYSTEM INSTALLED AS PER DOBBS FERRY BUILDING CODE

GENERAL CONDITIONS

1. APPROVED STAMPED SET OF BUILDING PLANS MUST BE PRESENT ON SITE AT ALL TIMES.


2. LICENSED ELECTRICIAN TO FILE ELECTRICAL PERMIT

PRE-ENGINEERED WOOD PLACARDING CONTRACTOR SHALL PROVIDE PLACARD AS REQUIRED BY CODE, 6" DIA. CIRCLE WITH RED REFLECTIVE PRINT ON WHITE BACKGROUND, INDICATING THAT PRE-ENGINEERED WOOD HAS BEEN USED IN CONSTRUCTION. PLACARD SHALL BE PLACED AT EXTERIOR ON OR NEAR ELECTRIC METER IN PLAIN VIEW AND INDICATE THAT PRE-ENGINEERED WOOD HAS BEEN USED FOR ROOF AND FLOOR SUPPORT IN THE BUILDING OF TYPE-V CONSTRUCTION.

WESTCHESTER , NY: CLIMATE ZONE 4A CLIMATIC AND GEOGRAPHIC DESIGN CRITERIA

GROUND	WIND	TOPOGRAPHIC	SPECIAL	WIND-BORNE	SEISMIC	SUBJECT	TO DAMA	GE FROM	WINTER	ICE BARRIER	FLOOD	AIR	MEAN
SNOW	SPEED	EFFECTS	WIND	DEBRIS	DESIGN	WEATHERING	FROST	TERMITE	DESIGN	UNDERLAYMENT	HAZARDS	FREEZING	ANNUA
LOAD	(MPH)		REGION	ZONE	CATEGORY		DEPTH		TEMP	REQUIRED		INDEX	TEMP
30 PSF	115-120	NO	YES	NO	С	SEVERE	3'6"	MODERATE/	15°F	YES	NO	2000	51.6°F
								HEAVY					

PHOTO OF FRONT ELEVATION - taken from Eldredge Place - looking South

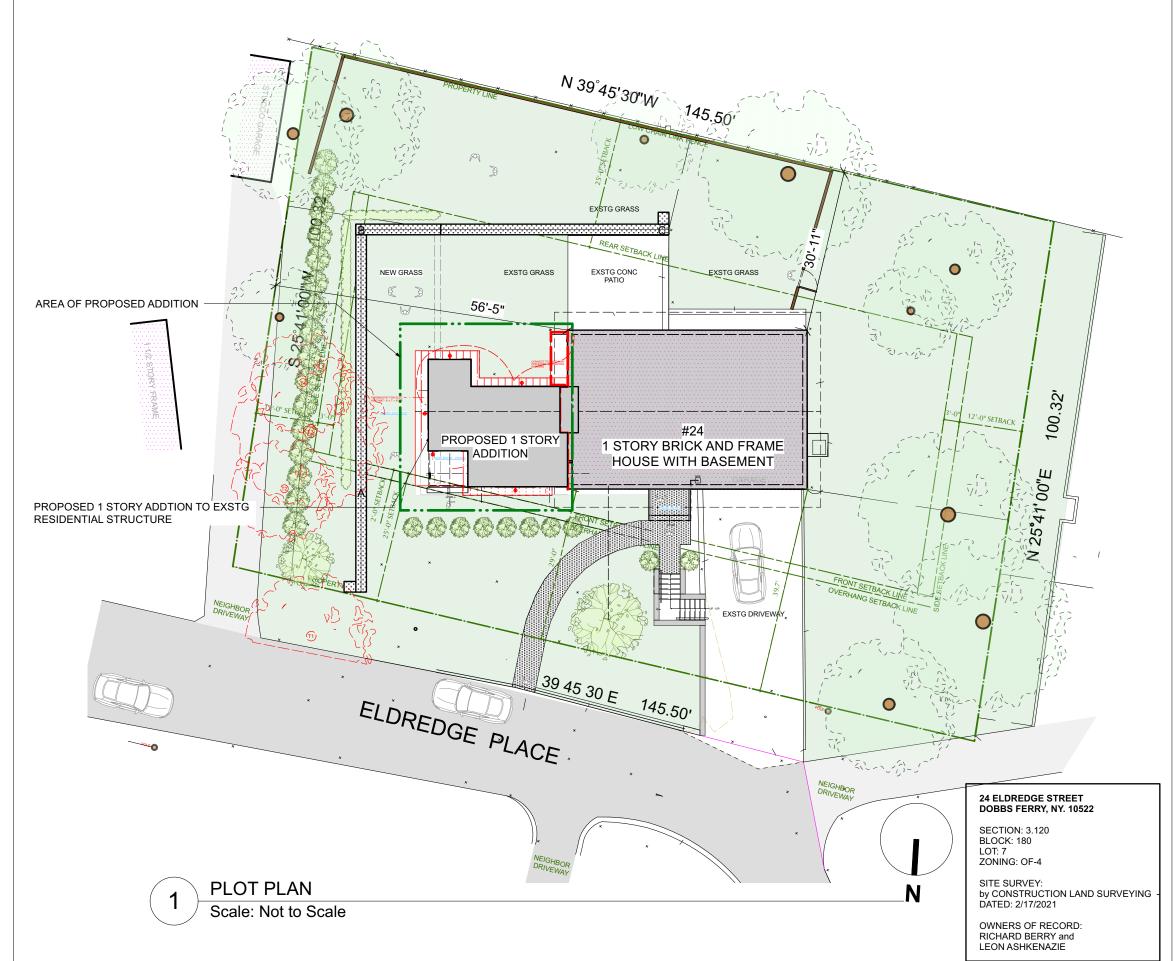

CLIMATE AND GEOGRAPHIC DESIGN CRITERIA

2020 RESIDENTIAL CODE OF NEW YORK STATE

1/2" STROKE REFLECTIVE RED PRINT PLACARD CONFIGURATION NO.

T-000.00 A-001.00

A-100.00 A-101.00 A-102.00

A-500.00 A-501.00 A-502.00 A-503.00

A-700.00 A-701.00

A-800.00

STRUCTURAL & LOADING NOTES

Required Placard

High Wind Connections

24 ELDREDGE PLACE DOBBS FERRY, NY 10522

DRAWING INDEX

SHEET	ISSUE DATE REV.	DATE
TITLE SHEET, SITE PLANS, ZONING		
Title Sheet, Plot Plan	7/28/22	
Site Plans - Existing + Proposed	7/28/22	
PLANS		
Basement Plans - Existing + Proposed	7/28/22	
First Floor Plans - Existing + Proposed	7/28/22	
Roof Plans - Existing + Proposed	7/28/22	
ELEVATIONS		
Front Elevations North - Existing + Proposed	7/28/22	
Side Elevations East - Existing + Proposed	7/28/22	
Rear Elevations South - Existing + Proposed	7/28/22	
Side Elevation West - Partial	7/28/22	
STORMWATER		
Stormwater Plan - HEC-C1	7/18/22	
Stormwater Details - HEC- C2	7/18/22	
SPRINKLER		
Sprinkler - Plans		
Sprinkler - Backflow preventer - not included - pa	nding approval	

A-801.00 |Sprinkler - Backflow preventer - not included - pending approval

Soil Bearing Capacity:

Design bearing capacity of soil shall be 2,000 PSI in accordance with NY State Residential Code Table R401.4.1 for Sand, Silty Sand, Clayey Sand

Concrete Compressive Strength Shall be Min. 3,000 PSI at exposed exterior walls; shall be Min. 2,500 PSI at basement slabs; and shall be Min. 3,500 PSI at horizontal surfaces exposed to the weather including porches, steps, walks, and garage floor slabs, all to be in compliance with the 2020 Residential Code of NYS

Provide exterior placard as required by code indicating that engineered lumber is used for roof support in a Class V structure. Placard is to be permanentlymounted for display as required near electrical meter or as directed in field by Architect.

Whever applicable provide strapping as required to resist high wind and uplift forces to be in compliance with table R802.11 of the Code. Use tension tie equal to Simpson model # HTT22 at all footing-post connections and equal to Simpson model #H2 at all post-plate-rafter connections.

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NO. REVISIONS

1 PLANNING BOARD FILING

DATE

DATE

7/19/22

NO. ISSUE

A REVISED INITIAL PERMIT for PLANNING BOARD 5/26/22 B PLANNING BOARD INITIAL FILING 6/15/22 C AHRB INITIAL FILING 7/28/22

APPLICATION # A 2022 - 0230

TREE REMOVAL APPLICATION # AT2022-0069

Michael Lewis Architects PC 145 Palisade St. Suite #307 Dobbs Ferry, NY 10522 tel 914-231-7700, fax 914-231-7701 info@mlarchitect.com www.mlarchitect.com Modifications to 24 Eldredge Place

PHASE 2 - ADDITION 24 Eldredge Place Dobbs Ferry, NY 10522

DRAWING TITLE: FITLE SHEET, GENERAL NOTES

FILE NAME: PG/ML DRAWN BY: SCALE: 7/27/22 DATE: 2125C

DRAWING NUMBER

T-000.00

PROJECT ID:

ZONING CHART

N			
Block - 108	Lot: 1		
REQUIRED/ALLOWED	EXISTING	PROPOSED	COMPLIANT
10,000 SF	14,550 SF	NO CHANGE	YES
100'0"	145'6"	NO CHANGE	YES
100'0"	100'4"	NO CHANGE	YES
	EVICTING	PROPOSED	
			COMPLIANT YES
			YES
			YES
			YES
REQUIRED/ALLOWED	EXISTING	PROPOSED	COMPLIANT
30'0"	1 19'4"	1 NO CHANGE	YES
300			VEC
			YES
28'0"	18'7"	NO CHANGE NO CHANGE	YES YES
	18'7"	NO CHANGE	YES
REQUIRED/ALLOWED	18'7" EXISTING	NO CHANGE PROPOSED	YES COMPLIANT
REQUIRED/ALLOWED	18'7" EXISTING 14,550 SF	NO CHANGE PROPOSED NO CHANGE	YES COMPLIANT NO CHANGE
REQUIRED/ALLOWED 10,000 SF MAX 22 % of 14,550 SF = 3,201 SF	18'7" EXISTING	NO CHANGE PROPOSED	YES COMPLIANT
REQUIRED/ALLOWED 10,000 SF MAX 22 % of 14,550 SF = 3,201 SF B-3 Sliding Scale x.75 = 2,401 SF	18'7" EXISTING 14,550 SF 1,407 SF	NO CHANGE PROPOSED NO CHANGE 1,893 SF	YES COMPLIANT NO CHANGE YES
REQUIRED/ALLOWED 10,000 SF MAX 22 % of 14,550 SF = 3,201 SF B-3 Sliding Scale x.75 = 2,401 SF MAX 40% of 14,550 SF = 5,820 SF	18'7" EXISTING 14,550 SF 1,407 SF 1,457SF + 1407 SF =	NO CHANGE PROPOSED NO CHANGE 1,893 SF 1,861 SF +1,893 SF =	YES COMPLIANT NO CHANGE YES YES
REQUIRED/ALLOWED 10,000 SF MAX 22 % of 14,550 SF = 3,201 SF B-3 Sliding Scale x.75 = 2,401 SF	18'7" EXISTING 14,550 SF 1,407 SF	NO CHANGE PROPOSED NO CHANGE 1,893 SF	YES COMPLIANT NO CHANGE YES
REQUIRED/ALLOWED 10,000 SF MAX 22 % of 14,550 SF = 3,201 SF B-3 Sliding Scale x.75 = 2,401 SF MAX 40% of 14,550 SF = 5,820 SF B-3 Sliding Scale x .75 = 4,365 SF	18'7" EXISTING 14,550 SF 1,407 SF 1,457SF + 1407 SF = 2,864 SF	NO CHANGE PROPOSED NO CHANGE 1,893 SF 1,861 SF +1,893 SF = 3,764 SF	YES COMPLIANT NO CHANGE YES YES YES
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REQUIRED/ALLOWED 10,000 SF MAX 22 % of 14,550 SF = 3,201 SF B-3 Sliding Scale x.75 = 2,401 SF MAX 40% of 14,550 SF = 5,820 SF B-3 Sliding Scale x .75 = 4,365 SF REQUIRED/ALLOWED	18'7" EXISTING 14,550 SF 1,407 SF 1,457SF + 1407 SF = 2,864 SF EXISTING SINGLE FAMILY	NO CHANGE PROPOSED NO CHANGE 1,893 SF 1,861 SF +1,893 SF = 3,764 SF PROPOSED NO CHANGE	YES COMPLIANT NO CHANGE YES YES COMPLIANT NO CHANGE
	REQUIRED/ALLOWED 10,000 SF 100'0" 100'0" 100'0" 25'0" 25'0" 12'0" 30'0"	REQUIRED/ALLOWED EXISTING 10,000 SF 14,550 SF 100'0" 145'6" 100'0" 100'4" URE) EXISTING 25'0" 29'0" 25'0" 30'11" 12'0" 56'5" 30'0" 95'6" REQUIRED/ALLOWED EXISTING 25'1 30'11" 12'0" 56'5" 30'0" 95'6"	REQUIRED/ALLOWED EXISTING PROPOSED 10,000 SF 14,550 SF NO CHANGE 100'0" 145'6" NO CHANGE 100'0" 100'4" NO CHANGE 100'0" 100'4" NO CHANGE 100'0" 100'4" NO CHANGE URE) EXISTING PROPOSED 25'0" 29'0" 25'3" 25'0" 30'11" 30'11" 12'0" 56'5" 30'10" 30'0" 95'6" 69'5" REQUIRED/ALLOWED EXISTING PROPOSED 25'10" 21/2 1 1

PARKING ANALYSIS

DOBBS FERRY MULTI-FAMILY PARKING REQUIREMENT	EXISTING	PROPOSED	
	2 SPOTS	DRIVEWAY SPOTS	2
		PROPOSED PARKING	0
		TOTAL SPOTS	2

VILLAGE NOTES:

1. ALL WORK TO CONFORM TO THE SATISFACTION OF THE BUILDING INSPECTOR 2. PROVIDE RETAINING WALLS ON ALL SLOPES EXCEEDING (1) FOOT

VERTICAL ON (1 1/2) FEET HORIZONTAL. 3. THE BUILDER SHALL FURNISH 6" PERFORATED CMP ENCASED IN STONE WHEREVER DIRECTED BY THE BUILDING INSPECTOR. 4. SWALES TO BE INSTALLED AS DIRECTED BY THE BUILDING

INSPECTOR. 5. ALL GRADING TO BE PERFORMED TO CREATE POSITIVE DRAINAGE. 6. ALL DRIVEWAYS SLOPING DOWN TO GARAGES SHALL HAVE A DRAIN INLET WITH A PIPE EXTENDING BEYOND THE REAR OF THE

HOUSE TO CARRY RAIN RUN-OFF. 7. ALL DRIVEWAYS SLOPING DOWN SHALL RISE 6" THE FIRST 5' AND THEN SLOPE DOWN.

8. "AS-BUILT" DRAWINGS OF THE SITE IMPROVEMENTS SHALL BE SUBMITTED TO THE VILLAGE ENGINEER FOR REVIEW PRIOR TO OBTAING CERTIFICATE OF OCCUPANCY.

9. OWNER OR CONTRACTOR SHALL NOTIFY BUILDING INSPECTOR PRIOR TO CHANGES OR MODIFICATIONS TO THE APPROVED PLANS. 10. ROCK REMOVAL BY BLASTING SHALL BE IN ACCORDANCE WITH CHAPTER 125 OF THE VILLAGE CODE.

11. FILL MATERIAL IMPORTED TO THE SITE SHALL BE CERTIFIED IN WRITING BY A NY LICENSED PROFESSIONAL ENGINEER AS CLEAN, NON-CONTAMINATED FILL SUITABLE FOR THE INTENDED USE. 12. BEFORE THE SITE PLAN IS SIGNED BY THE CHAIRMAN OF THE PLANNING BOARD, THE APPLICANT SHALL BE REQUIRED TO POST A PERFORMANCE BOND OR OTHER TYPE OF ACCEPTABLE MONETARY WARRANTY WHICH SHALL BE IN AN AMOUNT DETERMINED BY THE PLANNING BOARD AND VILLAGE ENGINEER AND IN A FORM SATISFACTORY TO THE VILLAGE ATTORNEY.

CONSTRUCTION SEQUENCE:

1. INSTALL SILT FENCE & OTHER PROTECTIVE MEASURES AS REQUIRED AT LIMITS OF CONSTRUCTION. 2. AREAS OF PROPOSED STORMWATER MANAGEMENT SYSTEM SHALL BE PROTECTED FROM OVER-COMPACTION DURING CONSTRUCTION. AREAS SHALL BE FENCED OFF DURING CONSTRUCTION OR THE AREA SHOULD BE DE-COMPACTED PRIOR TO INSTALLATION OF THE INFILTRATION UNITS. 3. EXCAVATE FOR FOOTINGS AND SWRS, PREPARE GRADE FOR SLAB.

4. INSTALL SWRS, REINFORCING & FORMWORK FOR FOOTINGS. 5. INSTALL C.I.P. CONCRETE FOOTINGS. 6. CONSTRUCT PROPOSED PORTE-COCHERE, GARAGE, AND

BUILDING ADDITIONS. 7. COMPLETE ALL FINISHES, DOORS, WINDOWS, FIXTURES, HARDWARE & EQMT.

8. PROPOSED GUTTER LEADERS SHALL BE CONNECTED TO SWRS.

NOTE: THE SYSTEM MUST NOT BE CONNECTED UNTIL CONSTRUCTION IS COMPLETE AND THE SITE IS STABILIZED.

SITE PLAN NOTES:

1. SURVEY INFORMATION TAKEN FROM SURVEY DATED 2/17/21, BY CONSTRUCTION LAND SURVEYING. 2. THE BUILDING INSPECTOR OR VILLAGE ENGINEER MAY REQUIRE ADDITIONAL EROSION CONTROL MEASURES IF DEEMED APPROPRIATE TO MITIGATE UNFORESEEN SILTATION AND EROSION OF DISTURBED SOILS.

UTILITIES:

1. CONTRACTOR TO VERIFY LOCATION OF PUBLIC UTILITIES AND PROVIDE PROTECTION IF /AS REQ'D.

2. CONTRACTOR TO COORDINATE SHUT OFF AND/OR DISCONNECTION OF UTILITIES IF / AS REQUIRED.

3. NO EXTG UTILITIES TO BE IMPACTED. NO EXTG UTILITIES

RUN THROUGH AREA OF NEW WORK. 4. A CODE 53 WILL BE CALLED IN PRIOR TO CONSTRUCTION

FOR SURVEY OF EXTG UNDERGROUND UTILITIES.

LANDSCAPING NOTES


- 1. ALL LANDSCAPING OUTSIDE OF WORK AREA IS EXISTING TO REMAIN. ALL PLANTINGS INDICATED ON SITE PLAN ARE EXISTING TO REMAIN UNLESS NOTED.
- 2. REMOVE TOPSOIL AT DISTURBED WORK AREA AND STORE ON SITE. REPLACE REFURBISH TOPSOIL AT COMPLETION AND RE-SOD LAWN AS NEEDED.
- 3. NO TREES ARE PROPOSED TO BE REMOVED UNDER THIS APPLICATION EXCEPT AS INDICATED. EXCAVATE BY HAND WHERE REQUIRED TO PROTECT ROOT SYSTEMS OF
- EXISTING TREES. 4. UNLESS OTHERWISE DIRECTED, REMOVE EXISTING PLANTINGS AND SHRUBS BY HAND AND PROPERLY STORE
- ON SITE FOR REPLANTING UNDER SEPARATE APPLICATION

GENERAL SITE PLAN NOTE: 1. PREPARATION OF STORMWATER MANAGEMENT PLAN, EROSION CONTROL, LOCATION OF CONSTRUCTION LIMITS, SILT FENCE, SOIL STOCKILE, ANTI-TRACKING PAD, AND OTHER SITE PROTECTION DETAILS CURRENTLY UNDERWAY TO BE SUBMITTED AS PART OF PUBLIC HEARING PLANNING BOARD DRAWING SET AND SUBMITTAL 2. ALL EXISTING TREES AND LANDSCAPING TO REMAIN UNLESS OTHERWISE NOTED.

NYS CODE COMPLIANCE

1. This design is in compliance with requirements of 2020 Residential Code of New York State and the 2020 Energy Conservation Code of New York State. 2. Contractor shall perform all work in accordance with applicable codes as listed in the 2020 NYS Code Books.

3. In the case of multiple codes applying to any area or component of the building, the stricter code shall apply.

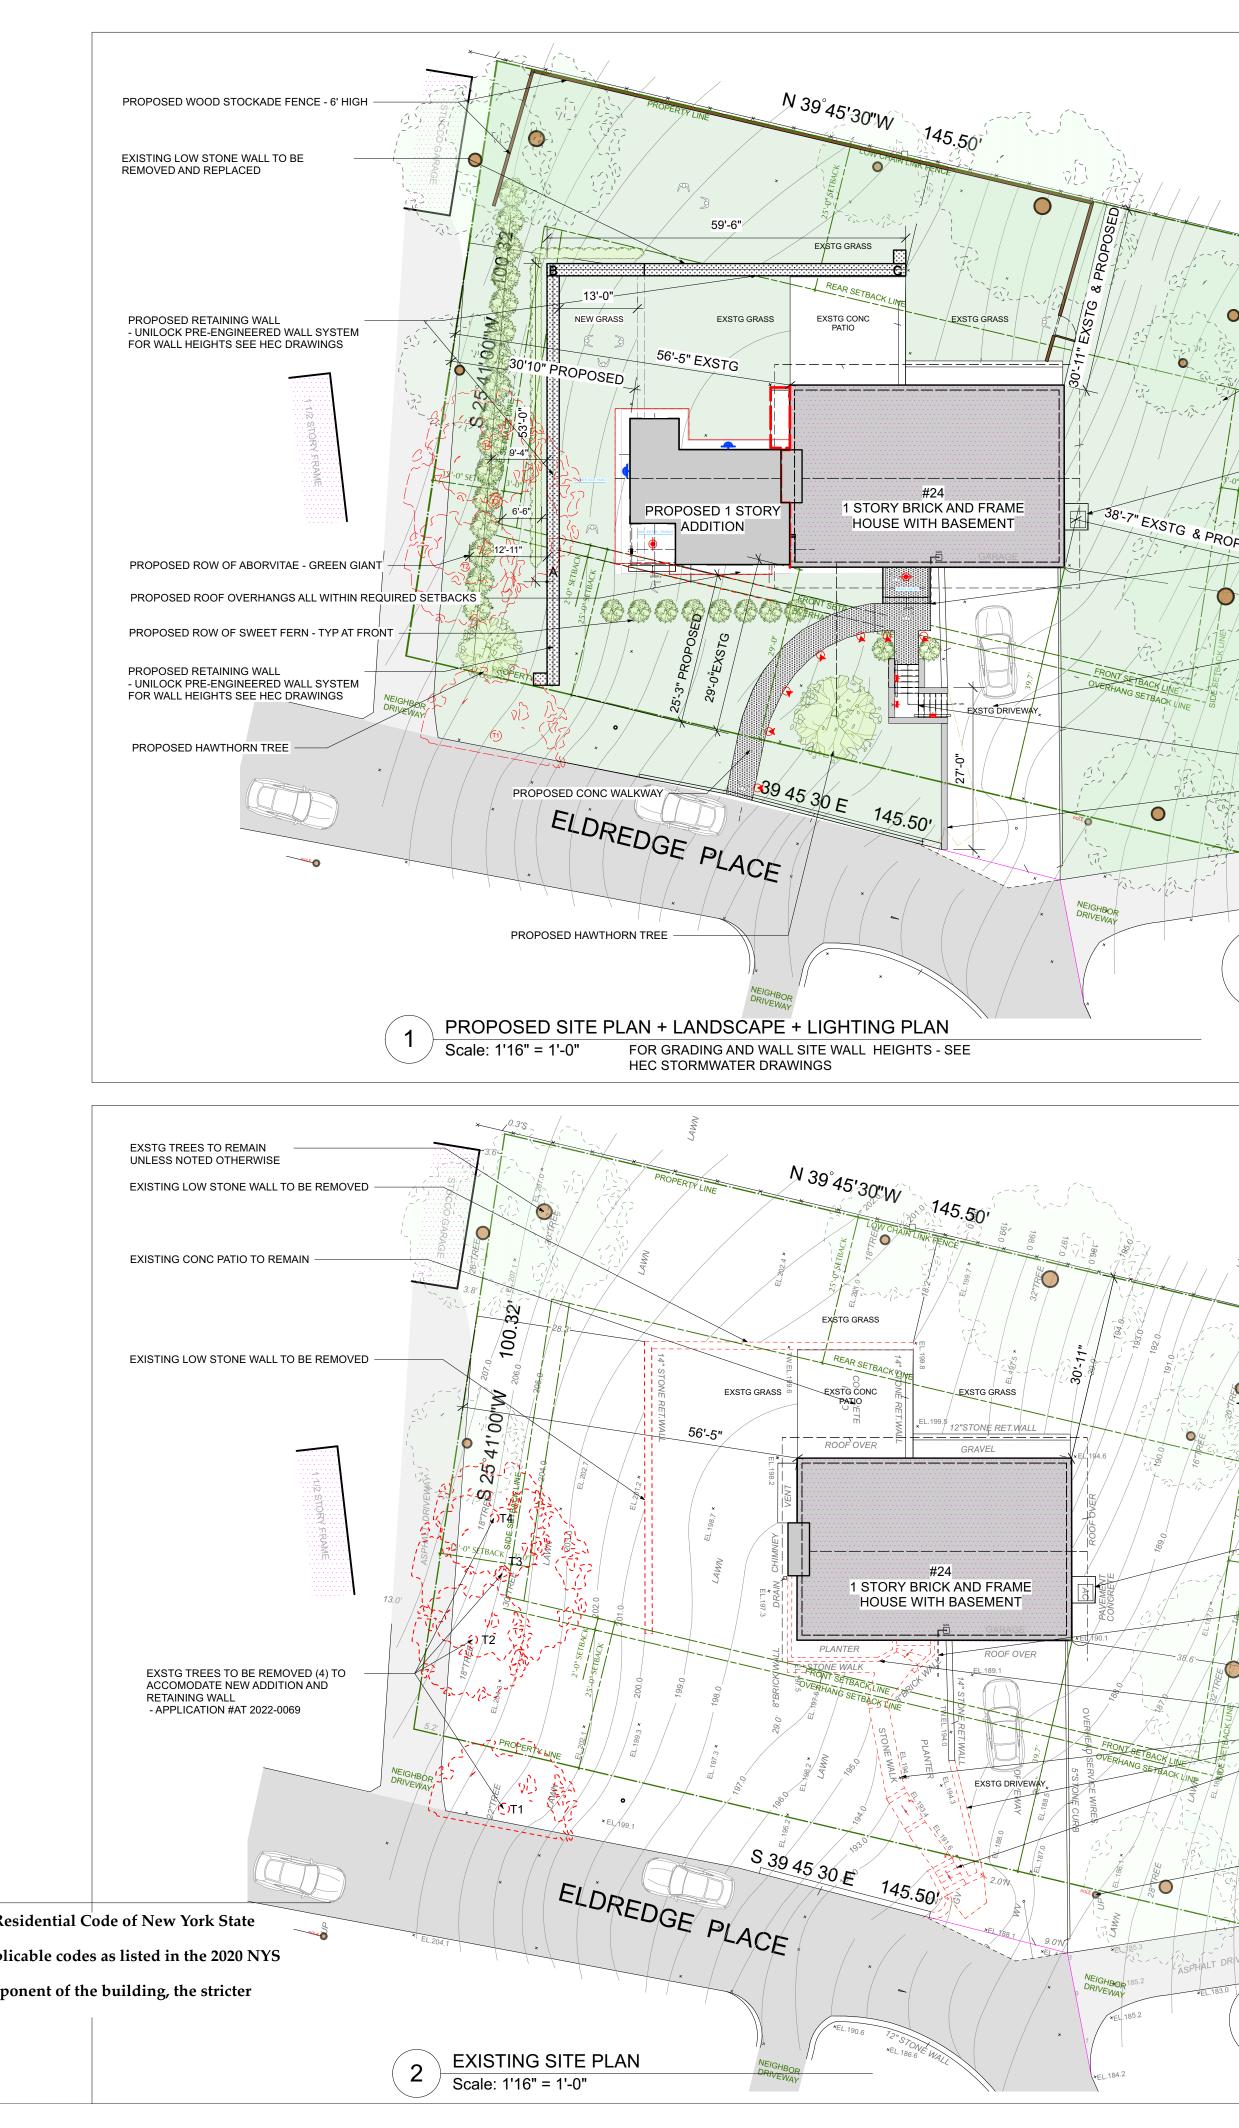

		ISSI REACES (within Property Line)
		DUS SURFACES (within Property Line)
	WINDOW WELL TO BSMT -	32 SF NT WALL ANGLE REMOVED) - 733 SF
	EXSTG CONC HVAC PAD -	
		AND LOW WALL AT GRADE - 374 SF
		PORCH, WALKS, WALLS, - 479 SF
		/ RETAINING WALL - 269 SF
/	PROPOSED SITE IMPERVIO	US - 1904 SF
	PROPOSED <u>H</u> ouse - 1893	SF
	TOTAL IMPERVIOUS - HOU	ISE + SITE - 3797 SF
	*	
- in the second s		
	GT TORY FR ME	
11/4		
7-0" 12 ⁻⁰ " SETBACK		
12'-0" 12'-0" SETBACK		
OPOSED H		GAS LINE NOTE:
30. I		PRIOR TO ANY WORK LOCATE EXSTG GAS LINE, REPORT TO ARCHITECT ANY
1		CONFLICT WITH PROPOSED WORK
2.4		
The second	- 1	
	_	
	() ()	
	>	PROPOSED CONC STEPS, RETAINING WALLS, RAILINGS
		- UNILOCK PRE-ENGINEERED WALL SYSTEM
Mark 1		
	-	
N		
		I
	EXSTG IMPERVIOUS S	URFACES (within Property Line)
	EXSTG IMPERVIOUS S	URFACES (within Property Line) 32 SF
		32 SF
	WINDOW WELL TO BSMT -	32 SF - 695 SF
	WINDOW WELL TO BSMT - EXSTG LOWER DRIVEWAY EXSTG CONC HVAC PAD -	32 SF - 695 SF
>	WINDOW WELL TO BSMT - EXSTG LOWER DRIVEWAY EXSTG CONC HVAC PAD -	32 SF - 695 SF 17 SF AND LOW WALL AT GRADE - 374 SF
MNA	WINDOW WELL TO BSMT - EXSTG LOWER DRIVEWAY EXSTG CONC HVAC PAD - EXSTG CONC REAR PATIO	32 SF - 695 SF 17 SF AND LOW WALL AT GRADE - 374 SF KS, WALLS, CURB - 238 SF
14MM	WINDOW WELL TO BSMT - EXSTG LOWER DRIVEWAY EXSTG CONC HVAC PAD - EXSTG CONC REAR PATIO - EXSTG FRONT STEPS, WALL	- 32 SF - 695 SF 17 SF AND LOW WALL AT GRADE - 374 SF KS, WALLS, CURB - 238 SF G WALL - 101 SF
	WINDOW WELL TO BSMT - EXSTG LOWER DRIVEWAY EXSTG CONC HVAC PAD - EXSTG CONC REAR PATIO A EXSTG FRONT STEPS, WALL L SHAPED LOW RETAINING EXSTG SITE IMPERVIOUS - EXSTG HOUSE - 1407 SF	- 32 SF - 695 SF 17 SF AND LOW WALL AT GRADE - 374 SF KS, WALLS, CURB - 238 SF G WALL - 101 SF
9.1%	WINDOW WELL TO BSMT - EXSTG LOWER DRIVEWAY EXSTG CONC HVAC PAD - EXSTG CONC REAR PATIO EXSTG FRONT STEPS, WALL L SHAPED LOW RETAINING EXSTG SITE IMPERVIOUS - EXSTG HOUSE - 1407 SF TOTAL IMPERVIOUS - HOL	32 SF - 695 SF 17 SF AND LOW WALL AT GRADE - 374 SF (S, WALLS, CURB - 238 SF G WALL - 101 SF 1457 SF
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9.1%	WINDOW WELL TO BSMT - EXSTG LOWER DRIVEWAY EXSTG CONC HVAC PAD - EXSTG CONC REAR PATIO EXSTG FRONT STEPS, WALL L SHAPED LOW RETAINING EXSTG SITE IMPERVIOUS - EXSTG HOUSE - 1407 SF TOTAL IMPERVIOUS - HOL	32 SF - 695 SF 17 SF AND LOW WALL AT GRADE - 374 SF (S, WALLS, CURB - 238 SF G WALL - 101 SF 1457 SF
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5,200 The State St	WINDOW WELL TO BSMT - EXSTG LOWER DRIVEWAY EXSTG CONC HVAC PAD - EXSTG CONC REAR PATIO EXSTG FRONT STEPS, WALL L SHAPED LOW RETAINING EXSTG SITE IMPERVIOUS - EXSTG HOUSE - 1407 SF TOTAL IMPERVIOUS - HOL	- 32 SF - 695 SF 17 SF AND LOW WALL AT GRADE - 374 SF (S, WALLS, CURB - 238 SF G WALL - 101 SF 1457 SF ISE + SITE - 2864 SF EXSTG TREES TO REMAIN
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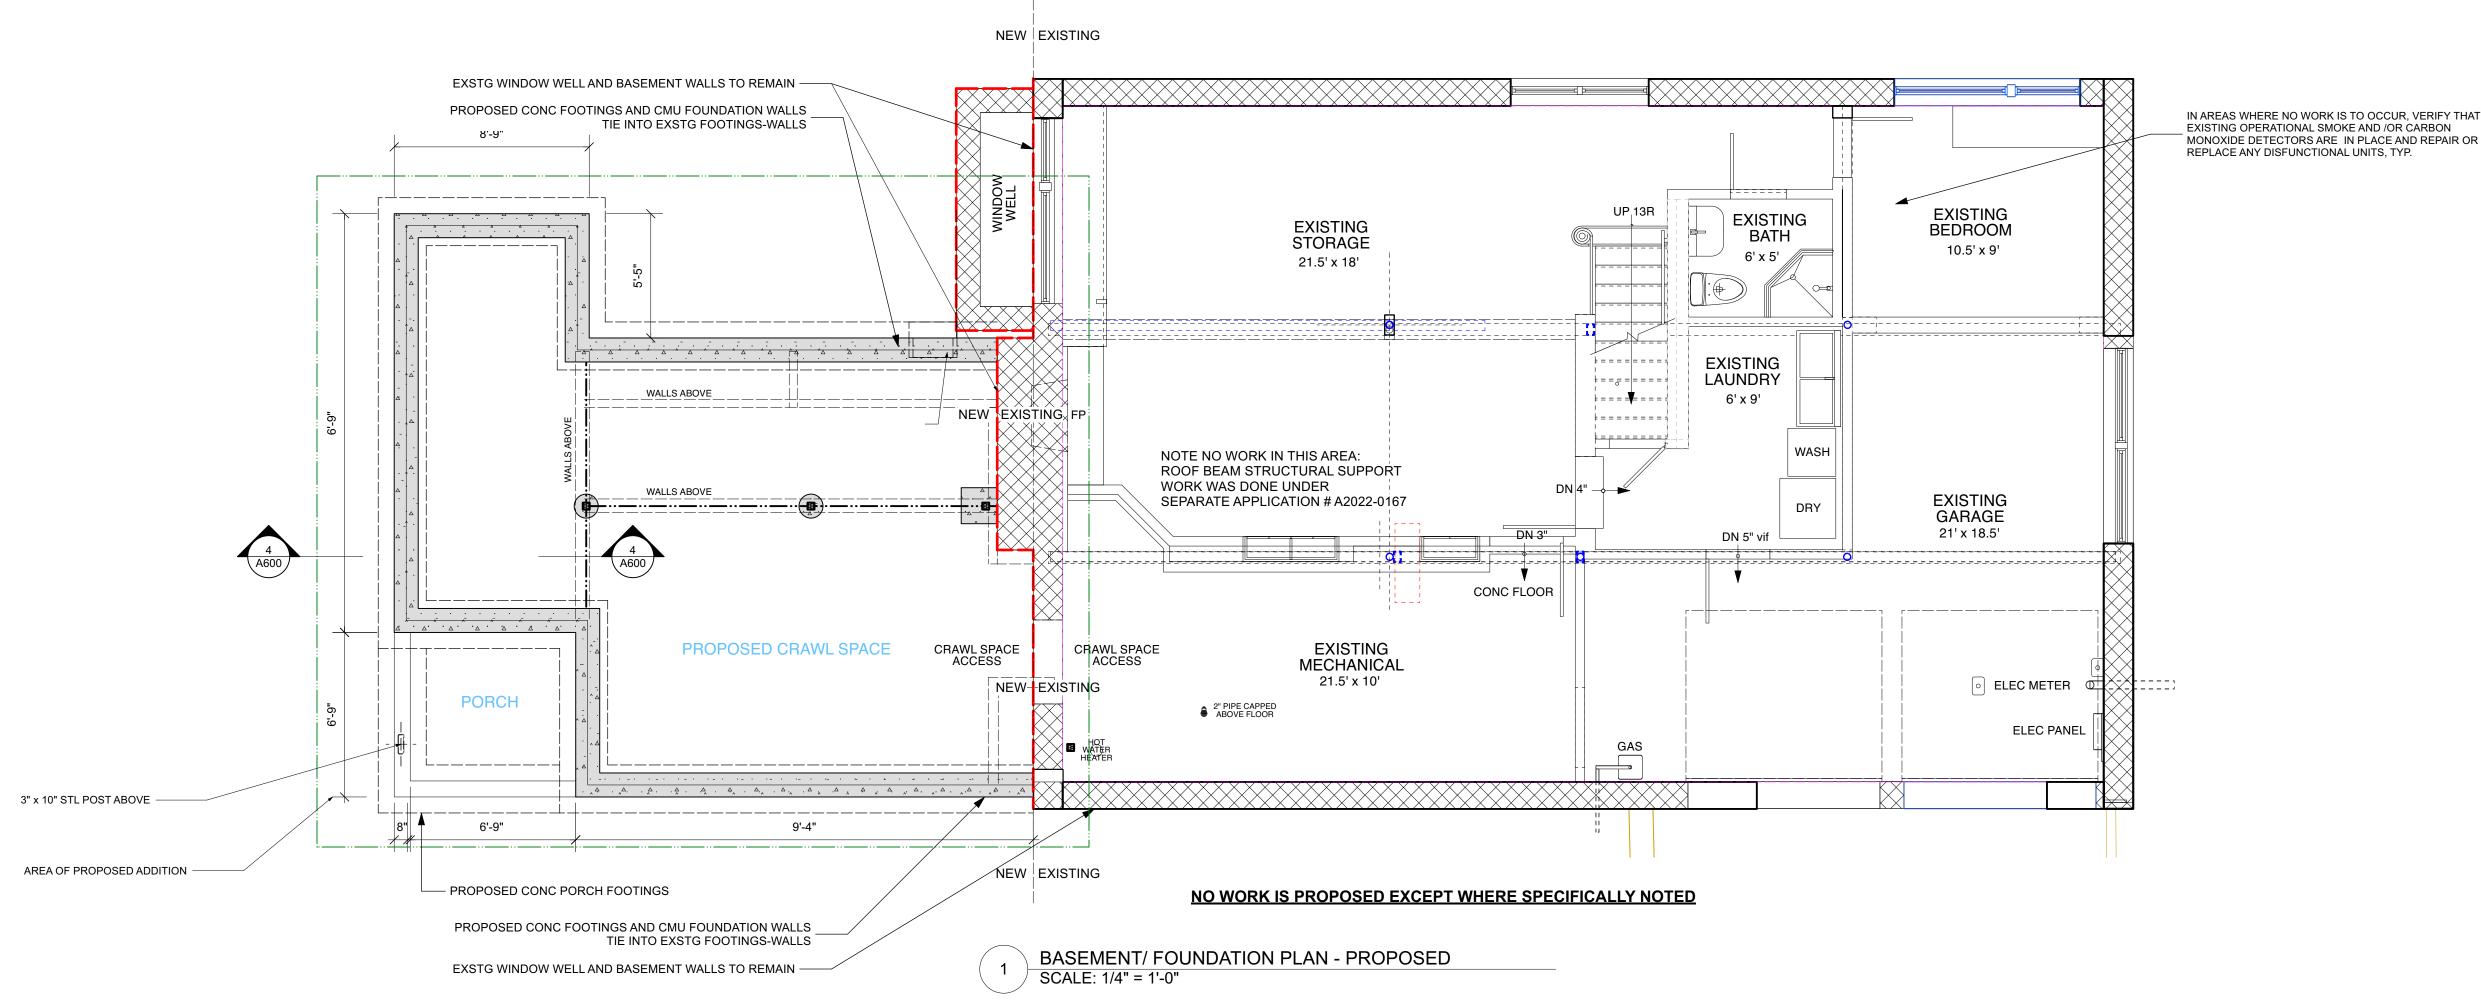
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PRELIMINARY LIGHTING PLAN LEGEND							
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2		ILT-IN WA EE SPEC:	LL OR RISER LIGH S	ΗT			
3		RFACE. N EE SPEC	IOUNTED S				
4	-	USE SCC					
	OP	TIONAL C	COODLIGHT (AND CAMERA) - B-K DEI FLOOD, 8W WARI	LTA			
	WH		MITIQUE (AGED)	VI			
WITH VILLA REQUIREM CUTOFF ST	NOTE: ALL EXTERIOR LIGHT FIXTURES SHALL COMPLY WITH VILLAGE EXTERIOR LIGHTING CODE REQUIREMENTS (300-41), INCLUDING THE USE OF FULL CUTOFF STYLE FIXTURES WITH LIGHT LEVELS WITHIN THE LIMITS SET BY THE CODE.						
PRELIMINARY PLANTING SCHEDULE As indicated on Proposed Site + Landscape Plan							
Common Na			cal Name	Native			
ORNAMENTA Hawthorn / Ma		Crataeg	us	Yes			
SCREENING Green Giant aborvitae Thuja plicata							
SHRUBS Sweet fern		Comptor	nia perigrina	Yes			
TREE REMOVAL SCHEDULE							
As indicated		ng Site F /pe	Plan Diamete	r ABH			
T1		Mulberry					
<u>T2</u> T3		Maple Maple	<u>1'6'</u> 2'6'				
T4		Maple	1'6'				
FERRY TRE LOCAL LAW	NOTE - TREE PERMIT APPLICATION # AT 2022-069 ALL TREE RELATED WORK TO COMPLY WITH DOBBS FERRY TREE VALUATION (300-51 i) AND LOCAL LAW 1-2022						
NO. REVIS	JONS			DATE			
1 PLANNING 2 TREE COM	G BOARD FI	LING		7/19/22 7/25/22			
NO. ISSUE				DATE			
	G BOARD IN		ANNING BOARD NG	5/26/22 6/15/22 7/28/22			
			A 2022 -				
			CATION # AT20				
Michael 145 Palisade St Dobbs Ferry, N tel 914-231-770 info@mlarchite www.mlarchite	t. Suite #30 VY 10522 00, fax 914- ect.com)7	hitects PC				
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PROJECT ID:

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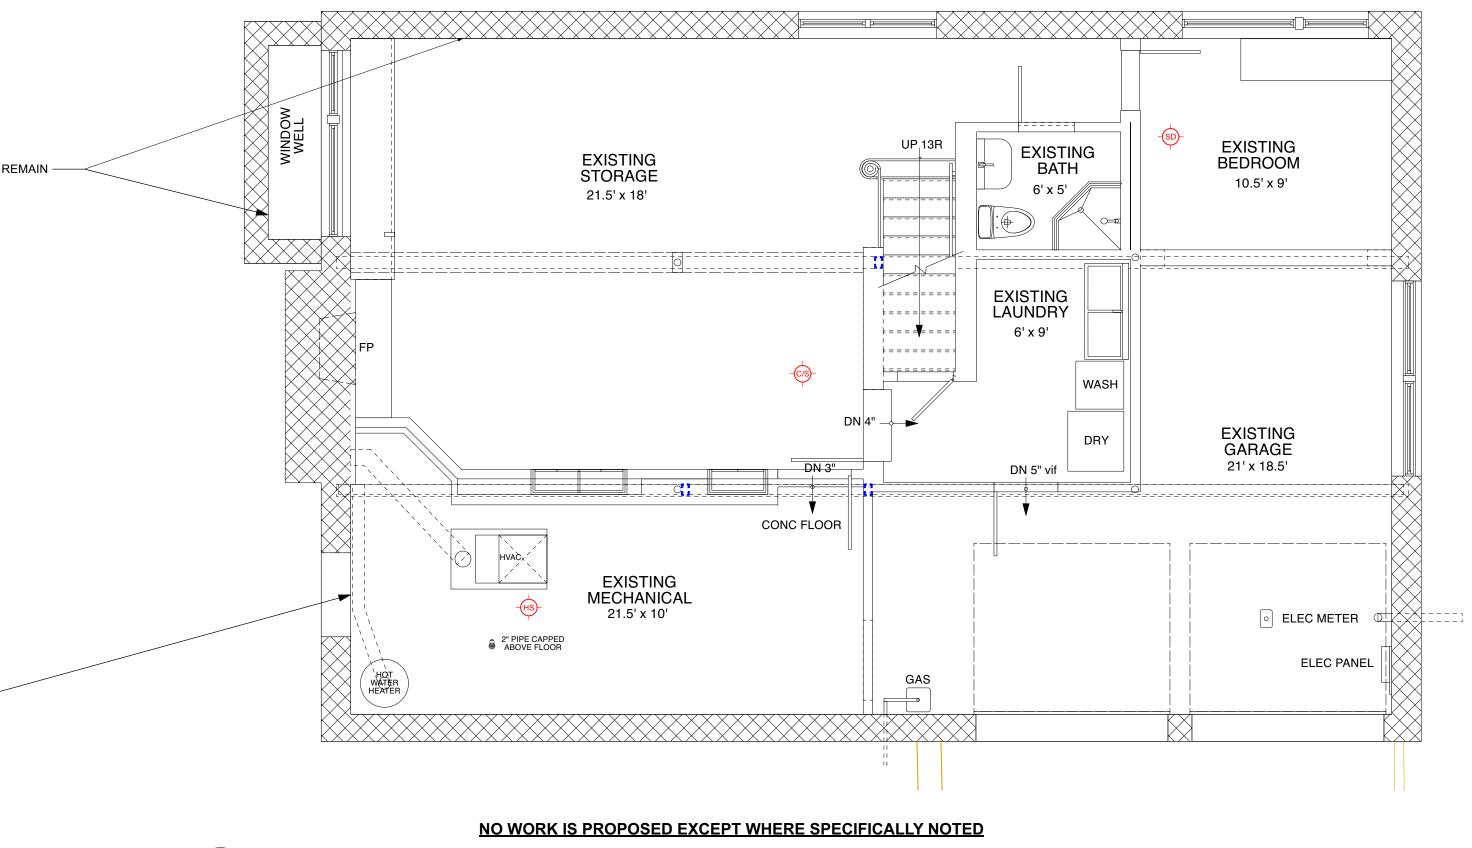


EXSTG WINDOW WELL AND BASEMENT WALLS TO REMAIN -

DEMO PLAN GENERAL NOTES

- **1.** ALL DEMOLITION TO BE APPROVED BY ARCHITECT IN FIELD PRIOR TO START OF WORK.
- 2. ALL SHOWN DIMENSIONS ARE SUBJECT TO VERIFICATION IN FIELD.
- 3. CONTRACTOR SHALL ESTABLISH CONSTRUCTION BARRIERS TO PROTECT AREAS OF NO OR LIMITED WORK PRIOR TO COMMENCEMENT OF DEMOLITION.
- 4. CONTRACTOR SHALL PROVIDE NEAT CUTS & BOUNDARIES AT LIMITS OF DEMOLITION.
- 5. CONTRACTOR TO PROTECT EXT'G FINISHES TO REMAIN.
- 6. CONTRACTOR TO PROVIDE REQ'D SUPPORT AND BRACING PRIOR TO DEMOLITION OF ALL EXISTING WALLS.
- 7. CONTRACTOR TO SAVE EXT'G DOORS, FIXTURES & APPLIANCES FOR RE-USE AS DIRECTED BY THE OWNER UNLESS OTHERWISE DIRECTED IN THE FIELD BY OWNER OR ARCHITECT.


OPENING TO PROPOSED CRAWL SPACE



BASEMENT FLOOR PLAN - EXISTING - DEMOLITION SCALE: 1/4" = 1'-0"

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DEMOLITION PLAN LE	GEND
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WALL	TO REMAIN
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ТО В	ING INTERIOR WALL E REMOVED
	ING OBJECT TO EMOVED
	ON TO BE APPROVED BY PRIOR TO START OF WORK.
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INTERIOR DOOR SCHEDULE

о.	Loc.	Door					Frame				Remarks
		Туре	Mat.	Width	Height	Thick	Туре	Mat.	Sill	HRDW	
1-1	LIVING - MAIN BED	A	WD	2'10"	7'-0"	1 3/4"	SWING	WD		A	
1-2	MAIN BED - HALL	A	WD	2'10"	7'-0"	1 3/4"	POCKET	WD		В	
1-3	MAIN BED - HALL	A	WD	2'10"	7'-0"	1 3/4"	POCKET	WD		В	
1-4	HALL - CL2	A	WD	7'6"	7'-0"	1 3/4"	SLIDING	WD		С	
1-5	HALL - CL1	A	WD	7'6""	7'-0"	1 3/4"	SLIDING	WD		С	
1-6	HALL - MAIN BATH	A	WD	2'10"	8'0"	1 3/4"	SWING	ST		D	

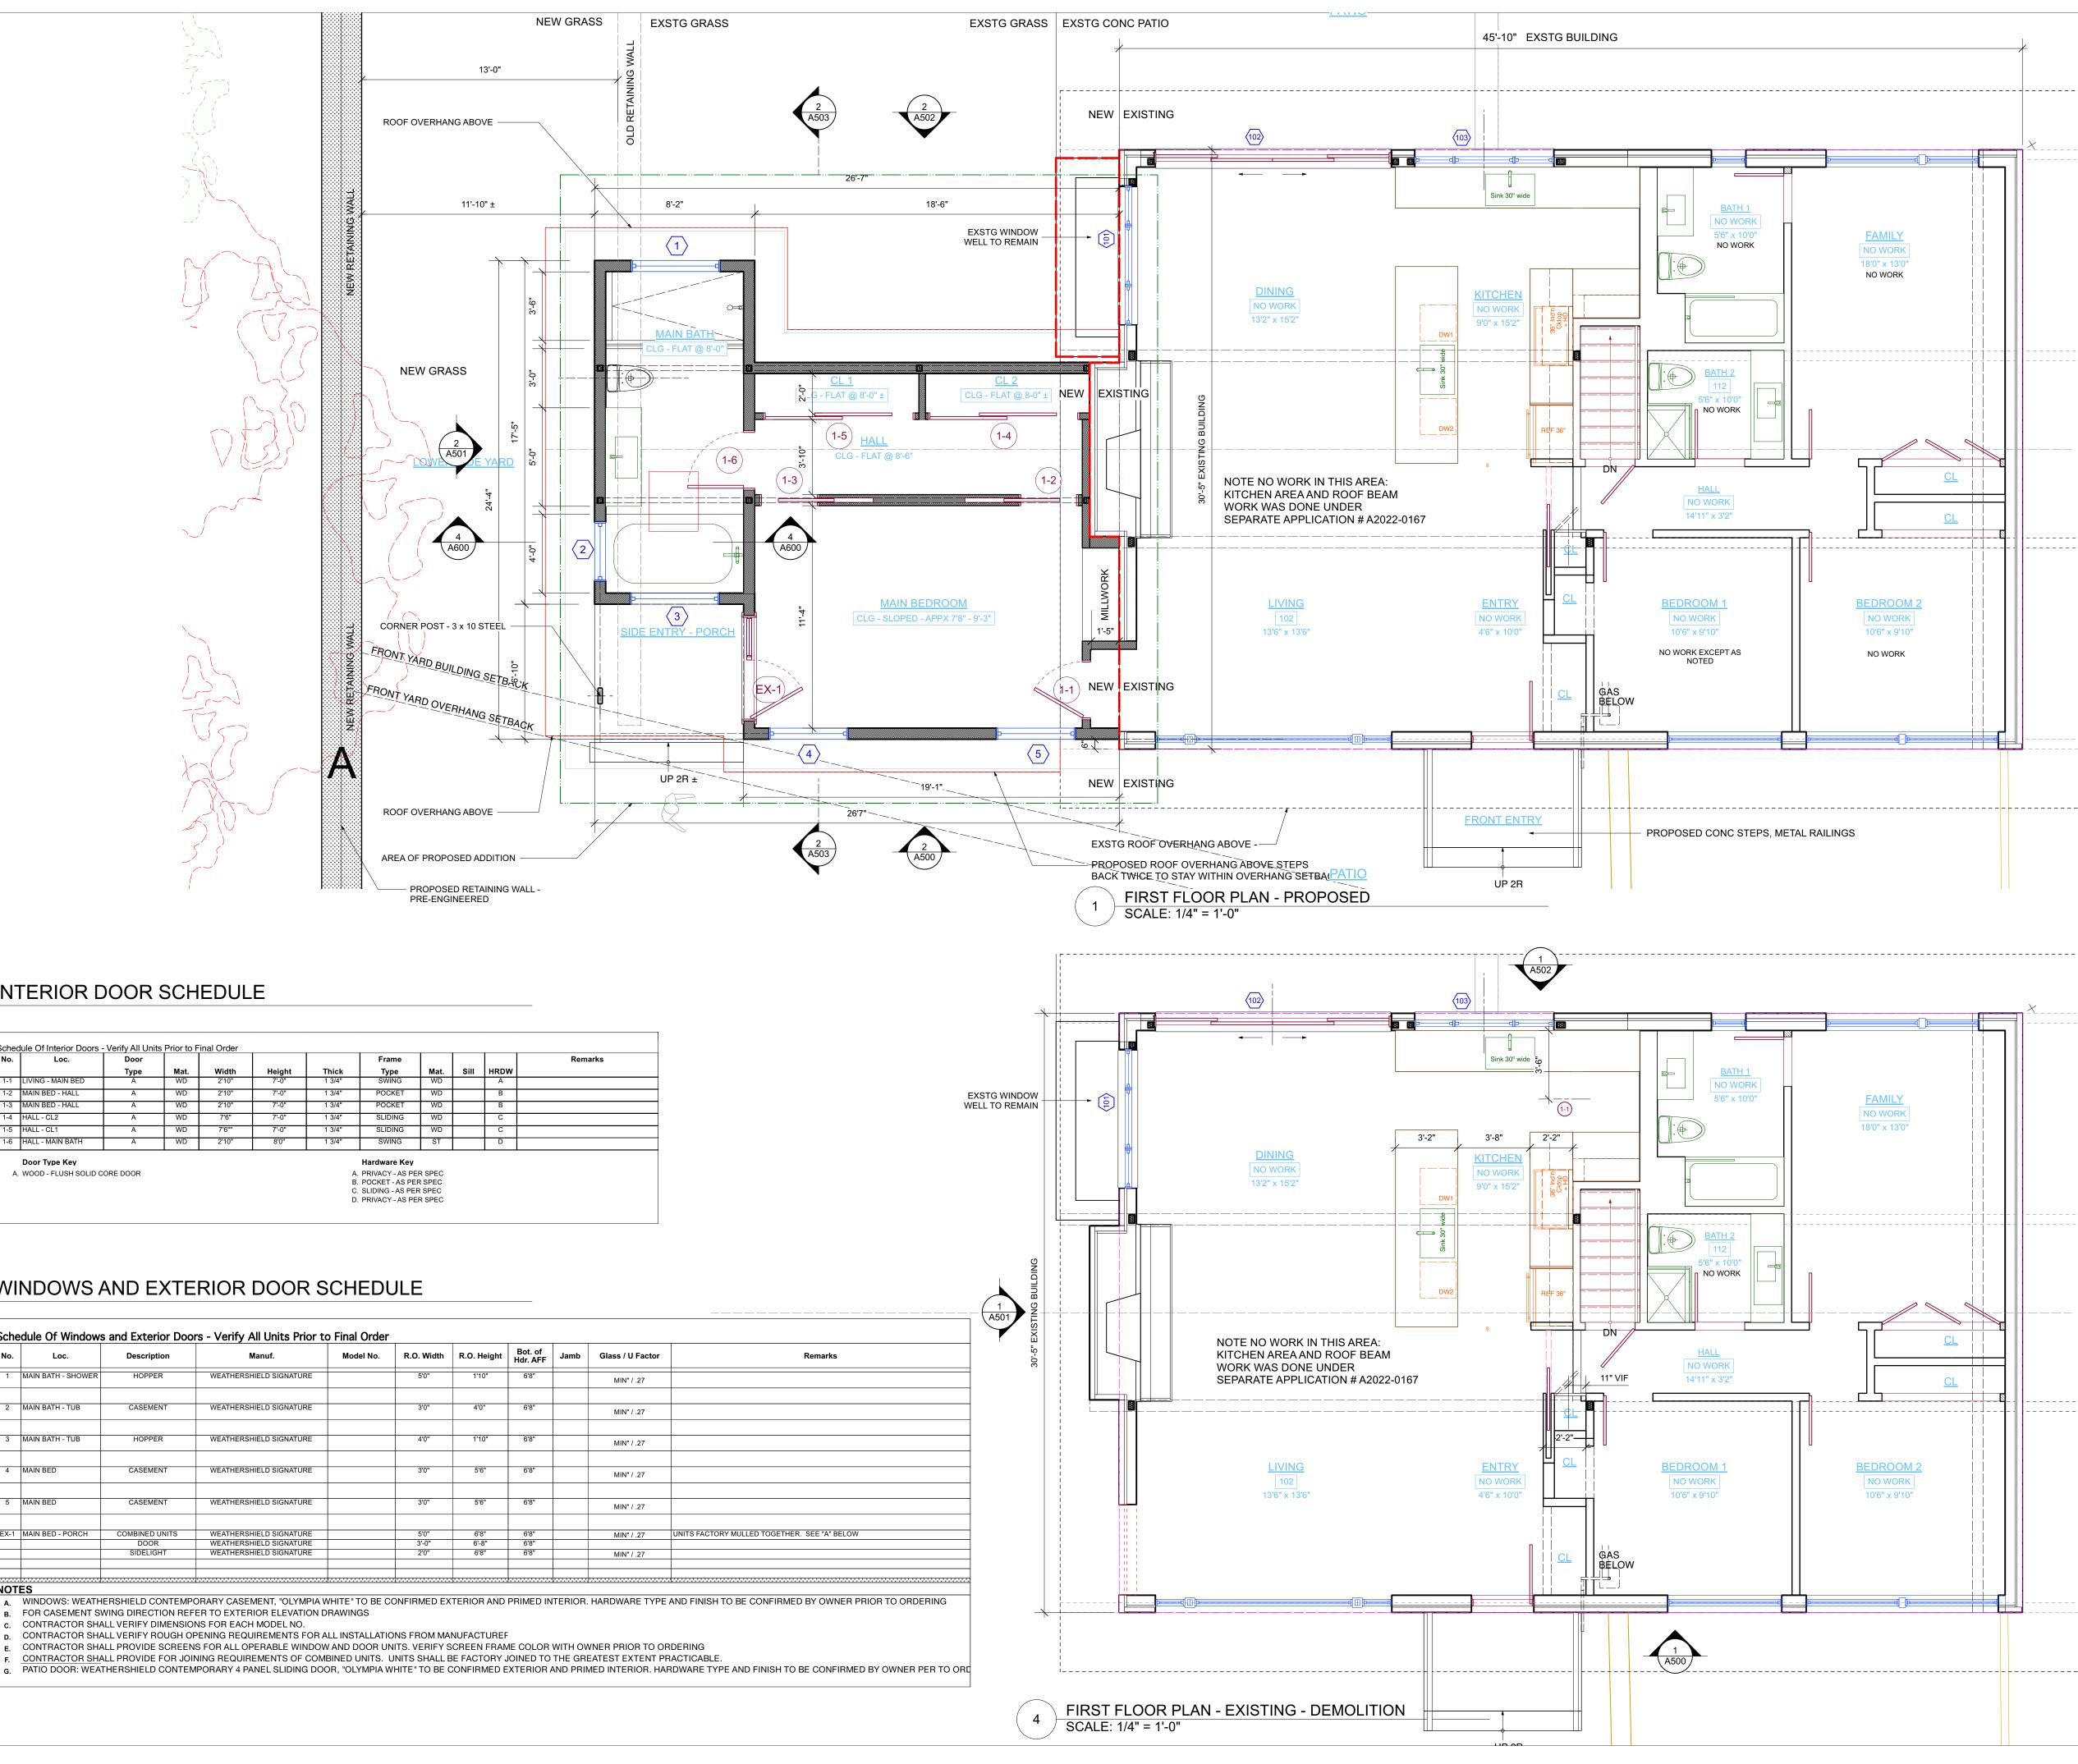WINDOWS AND EXTERIOR DOOR SCHEDULE

No.	Loc.	Description	Manuf.	Model No.	R.O. Width	R.O. Height	Bot. of Hdr. AFF	Jamb Glass / U Factor	Remarks
1	MAIN BATH - SHOWER	HOPPER	WEATHERSHIELD SIGNATURE		5'0"	1'10"	6'8"	MIN" / .27	
2	MAIN BATH - TUB	CASEMENT	WEATHERSHIELD SIGNATURE		3'0"	4'0"	6'8"	MIN" / .27	
3	MAIN BATH - TUB	HOPPER	WEATHERSHIELD SIGNATURE		4'0"	1'10"	6'8"	MIN" / .27	
4	MAIN BED	CASEMENT	WEATHERSHIELD SIGNATURE		3'0"	5'6"	6'8"	MIN" / .27	
5	MAIN BED	CASEMENT	WEATHERSHIELD SIGNATURE		3'0"	5'6"	6'8"	MIN" / .27	
EX-1	MAIN BED - PORCH	COMBINED UNITS	WEATHERSHIELD SIGNATURE		5'0"	6'8"	6'8"	MIN" / .27	UNITS FACTORY MULLED TOGETHER. SEE "A" BELOW
		DOOR	WEATHERSHIELD SIGNATURE		3'-0"	6'-8"	6'8"		
		SIDELIGHT	WEATHERSHIELD SIGNATURE		2'0"	6'8"	6'8"	MIN" / .27	

NULES A. WINDOWS: WEATHERSHIELD CONTEMPORARY CASEMENT, "OLYMPIA WHITE" TO BE CONFIRMED EXTERIOR AND PRIMED INTERIOR. HARDWARE TYPE AND FINISH TO BE CONFIRMED BY OWNER PRIOR TO ORDERING B. FOR CASEMENT SWING DIRECTION REFER TO EXTERIOR ELEVATION DRAWINGS

c. CONTRACTOR SHALL VERIFY DIMENSIONS FOR EACH MODEL NO. D. CONTRACTOR SHALL VERIFY ROUGH OPENING REQUIREMENTS FOR ALL INSTALLATIONS FROM MANUFACTUREF

E. CONTRACTOR SHALL PROVIDE SCREENS FOR ALL OPERABLE WINDOW AND DOOR UNITS. VERIFY SCREEN FRAME COLOR WITH OWNER PRIOR TO ORDERING

G. PATIO DOOR: WEATHERSHIELD CONTEMPORARY 4 PANEL SLIDING DOOR, "OLYMPIA WHITE" TO BE CONFIRMED EXTERIOR AND PRIMED INTERIOR. HARDWARE TYPE AND FINISH TO BE CONFIRMED BY OWNER PER TO ORD

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CONSTRUCTIO	N PLAN LEGEND
	EXISTING STONE WALL TO REMAIN
	EXISTING MASONRY WALL TO REMAIN
	EXISTING EXTERIOR FRAME WALL TO REMAIN
	EXISTING INTERIOR FRAME WALL TO REMAIN
	NEW MASONRY WALL
	NEW C.I.P. CONCRETE WALL
	NEW EXTERIOR FRAME WALL
	NEW INTERIOR FRAME WALL
	OBJECTS ABOVE
000	WINDOW ID
000	DOOR ID
\rightarrow	WALL TYPE ID
1-A1	BUILDING SECTION KEY
1/A1	EXTERIOR ELEVATION KEY
	DETAIL KEY
A1 1	INTERIOR ELEVATION KEY

NOTE: ALL DIMENSIONS ARE TO BE VERIFIED IN FIELD (VIF) PRIOR TO CONSTRUCTION

NO. REVISIONS

DATE

1 PLANNING BOARD FILING

7/19/22

DATE

NO.	ISSUE

(1) (A503)

А	REVISED INITIAL PERMIT for PLANNING BOARD	5/26/22
В	PLANNING BOARD INITIAL FILING	6/15/22
С	AHRB INITIAL FILING	7/28/22

APPLICATION # A 2022 - 0230

TREE REMOVAL APPLICATION # AT2022-0069

Michael Lewis Architects PC 145 Palisade St. Suite #307 Dobbs Ferry, NY 10522 tel 914-231-7700, fax 914-231-7701 info@mlarchitect.com www.mlarchitect.com Modifications to 24 Eldredge Place PHASE 2 - ADDITION 24 Eldredge Place Dobbs Ferry, NY 10522


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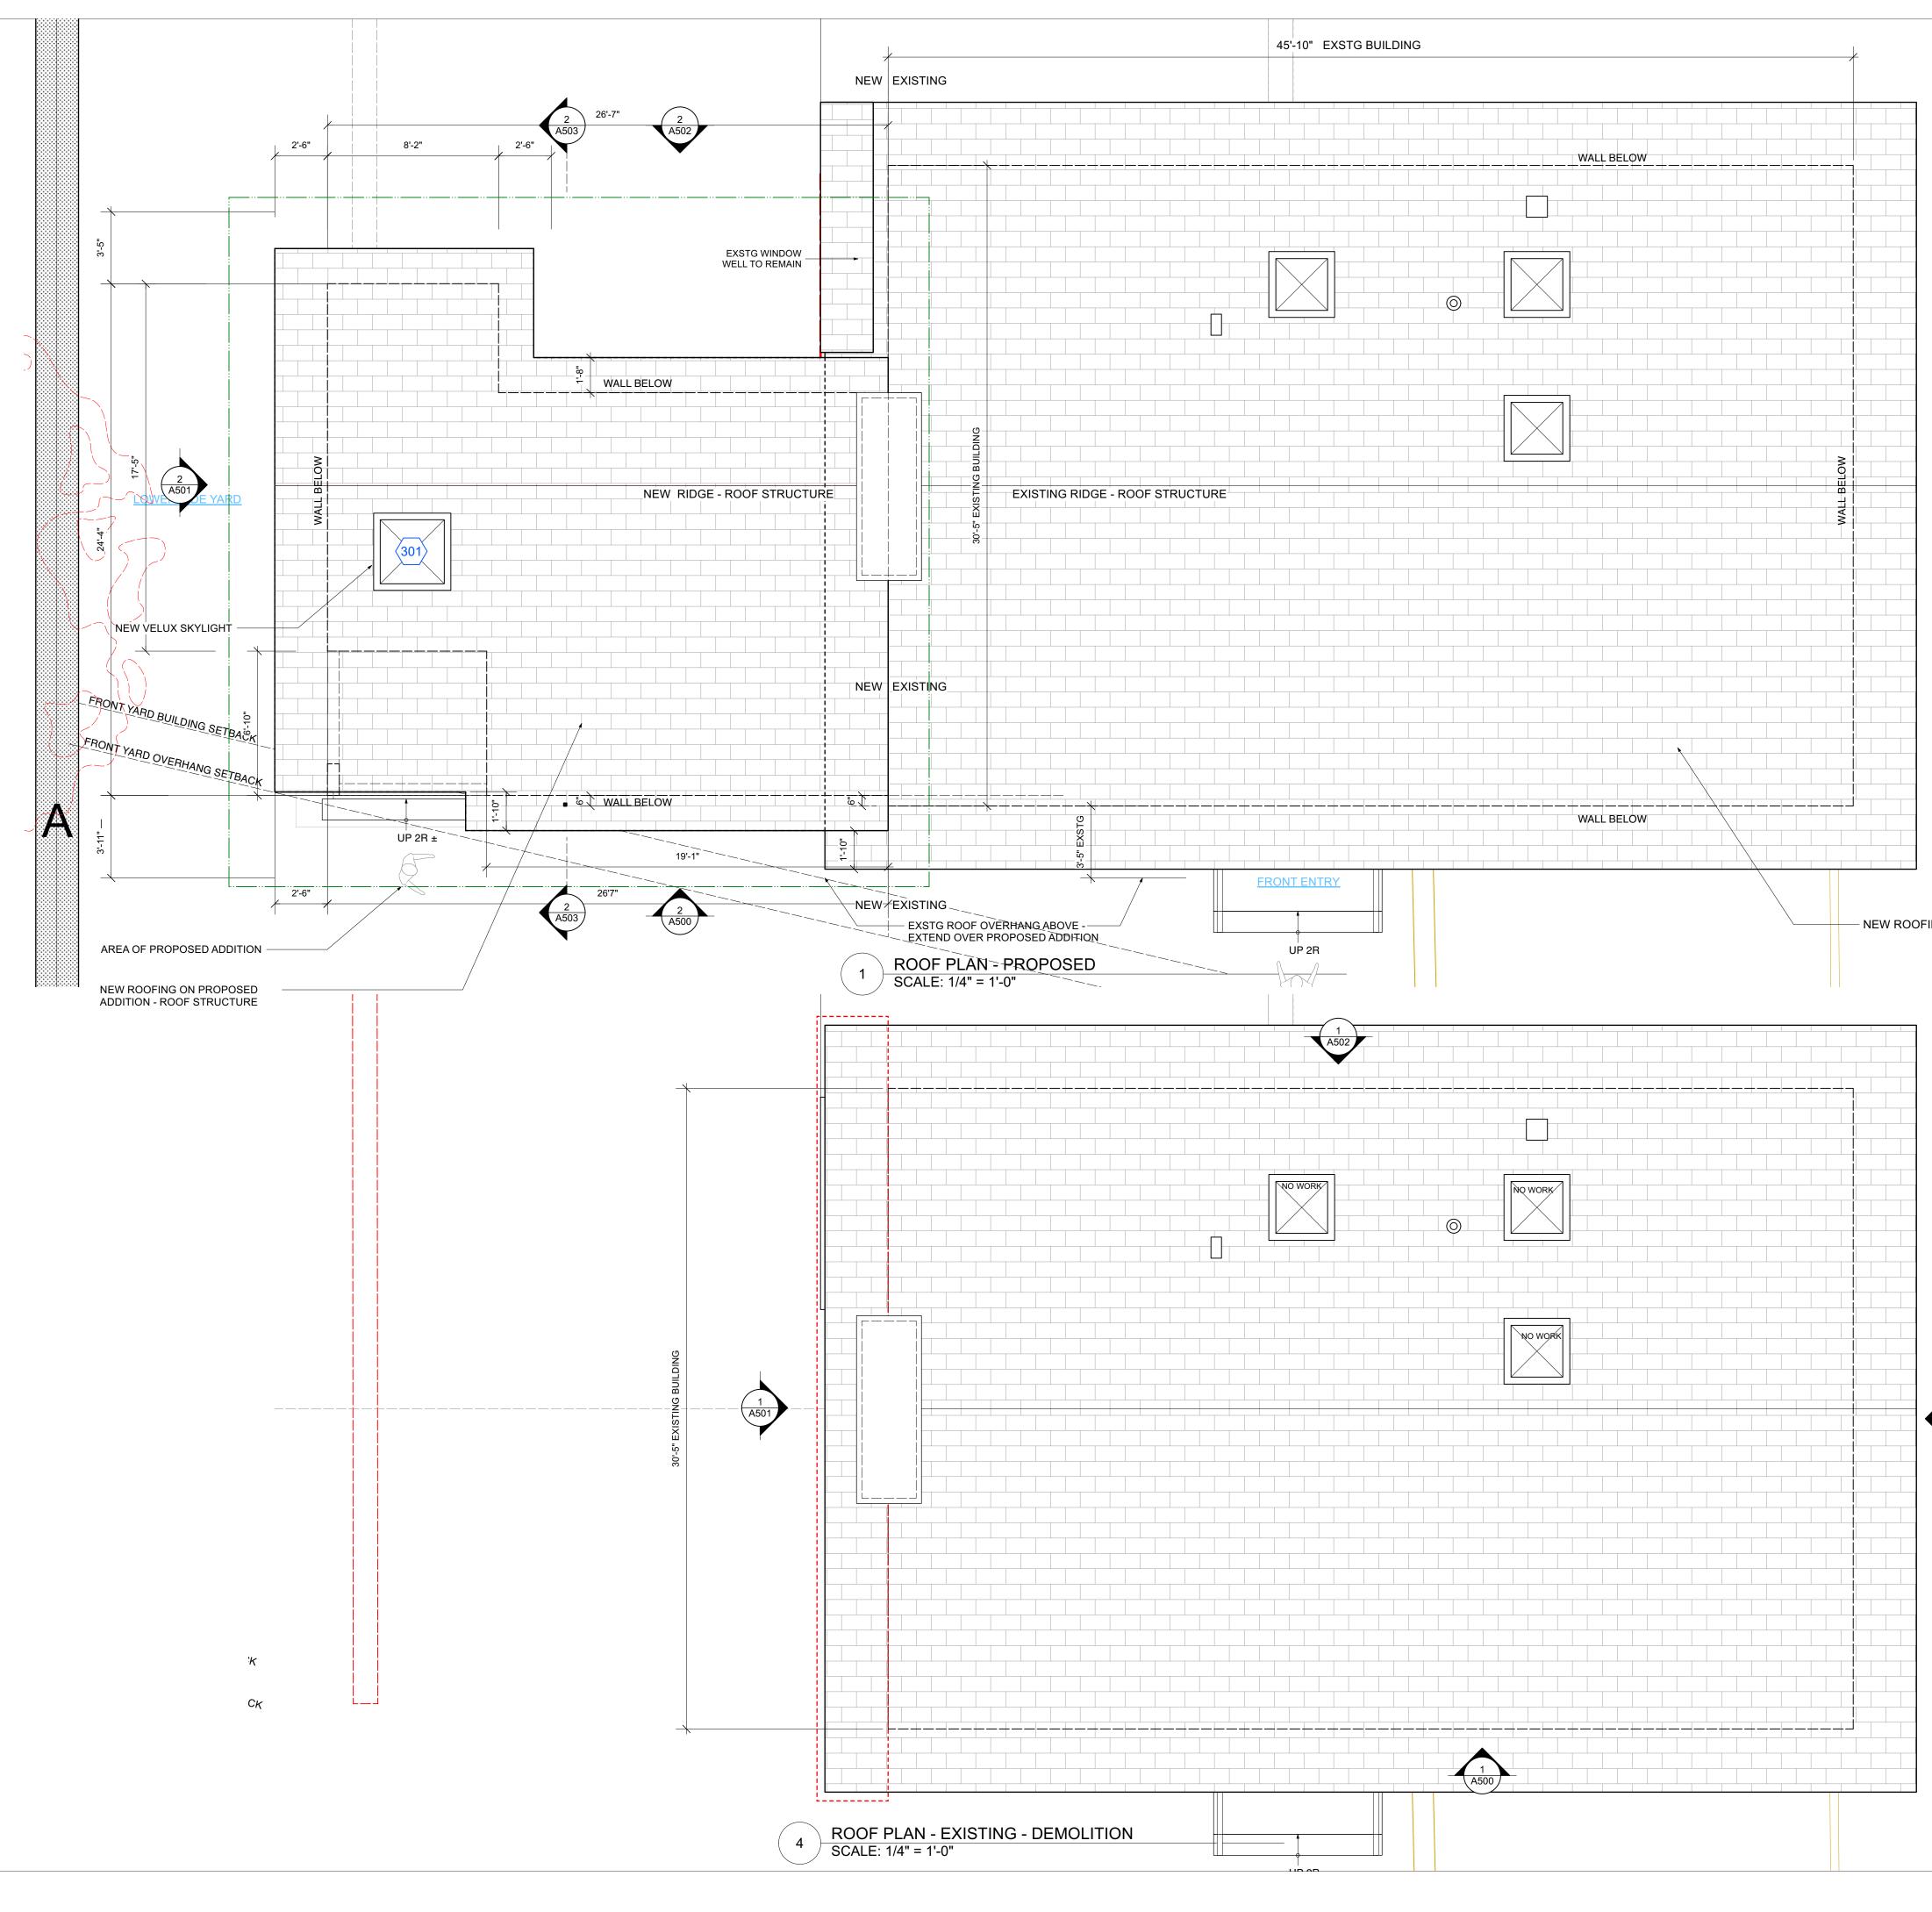
FIRST FLOOR PLANS - Schedules

FILE NAME:

DRAWN BY:	PG/ML
SCALE:	As Noted
DATE:	7/27/22
PROJECT ID:	2125C

DRAWING NUMBER



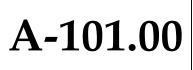

- NEW ROOFING ON EXSTG ROOF STRUCTURE

1 (A503) © 2021 Michael Lewis Architects P.C.

CONSTRUCTIO	N PLAN LEGEND
	EXISTING STONE WALL TO REMAIN
	EXISTING MASONRY WALL TO REMAIN
	EXISTING EXTERIOR FRAME WALL TO REMAIN
	EXISTING INTERIOR FRAME WALL TO REMAIN
\boxtimes	NEW MASONRY WALL
	NEW C.I.P. CONCRETE WALL
	NEW EXTERIOR FRAME WALL
	NEW INTERIOR FRAME WALL
	OBJECTS ABOVE
(000)	WINDOW ID
000	DOOR ID
\rightarrow	WALL TYPE ID
1-A1	BUILDING SECTION KEY
1/A1	EXTERIOR ELEVATION KEY
	DETAIL KEY
A1 1	INTERIOR ELEVATION KEY

DATE

NO. REVISIONS

NOTE: ALL DIMENSIONS ARE TO BE VERIFIED IN FIELD (VIF) PRIOR TO CONSTRUCTION

1PLANNING BOARD FILING7/19/22NO. ISSUEDATEAREVISED INITIAL PERMIT for PLANNING BOARD5/26/22BPLANNING BOARD INITIAL FILING6/15/22CAHRB INITIAL FILING7/28/22APPLICATION # A 2022 - 0230TREE REMOVAL APPLICATION # AT2022-0069


Michael Lewis Architects PC 145 Palisade St. Suite #307 Dobbs Ferry, NY 10522 tel 914-231-7700, fax 914-231-7701 info@mlarchitect.com www.mlarchitect.com Modifications to 24 Eldredge Place PHASE 2 - ADDITION 24 Eldredge Place Dobbs Ferry, NY 10522


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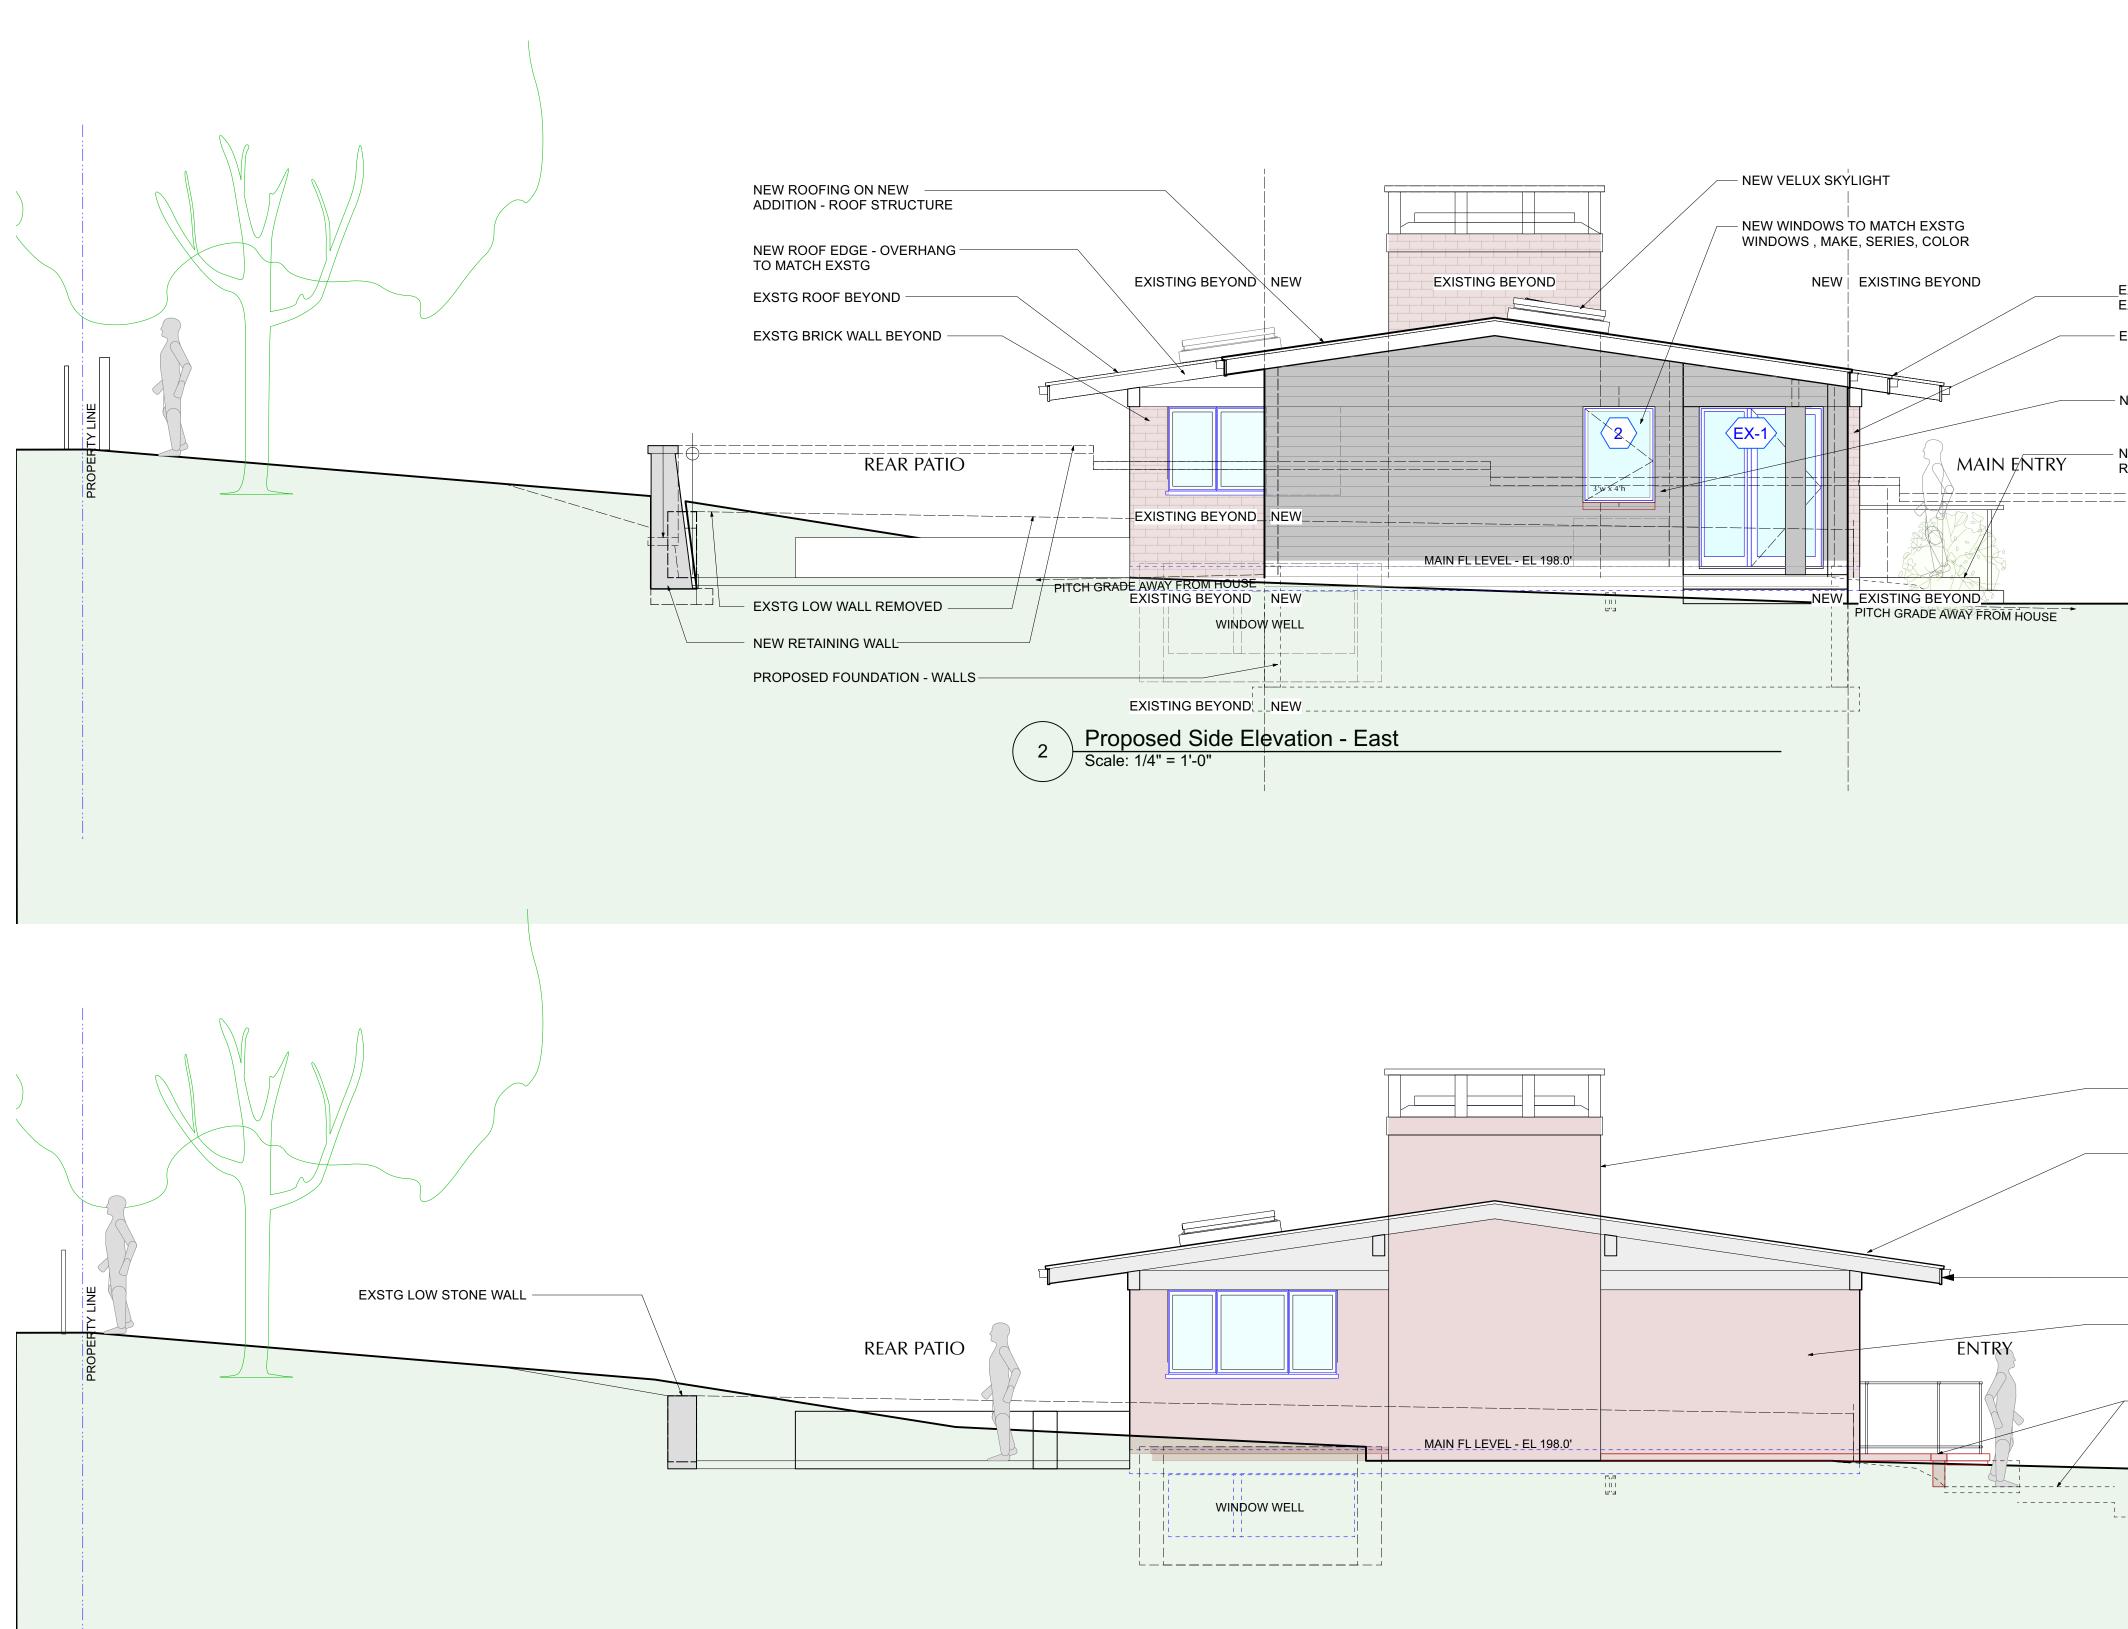
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DRAWN BY:PG/MLSCALE:As NotedDATE:7/27/22PROJECT ID:2125C

DRAWING NUMBER





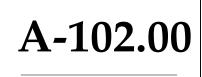

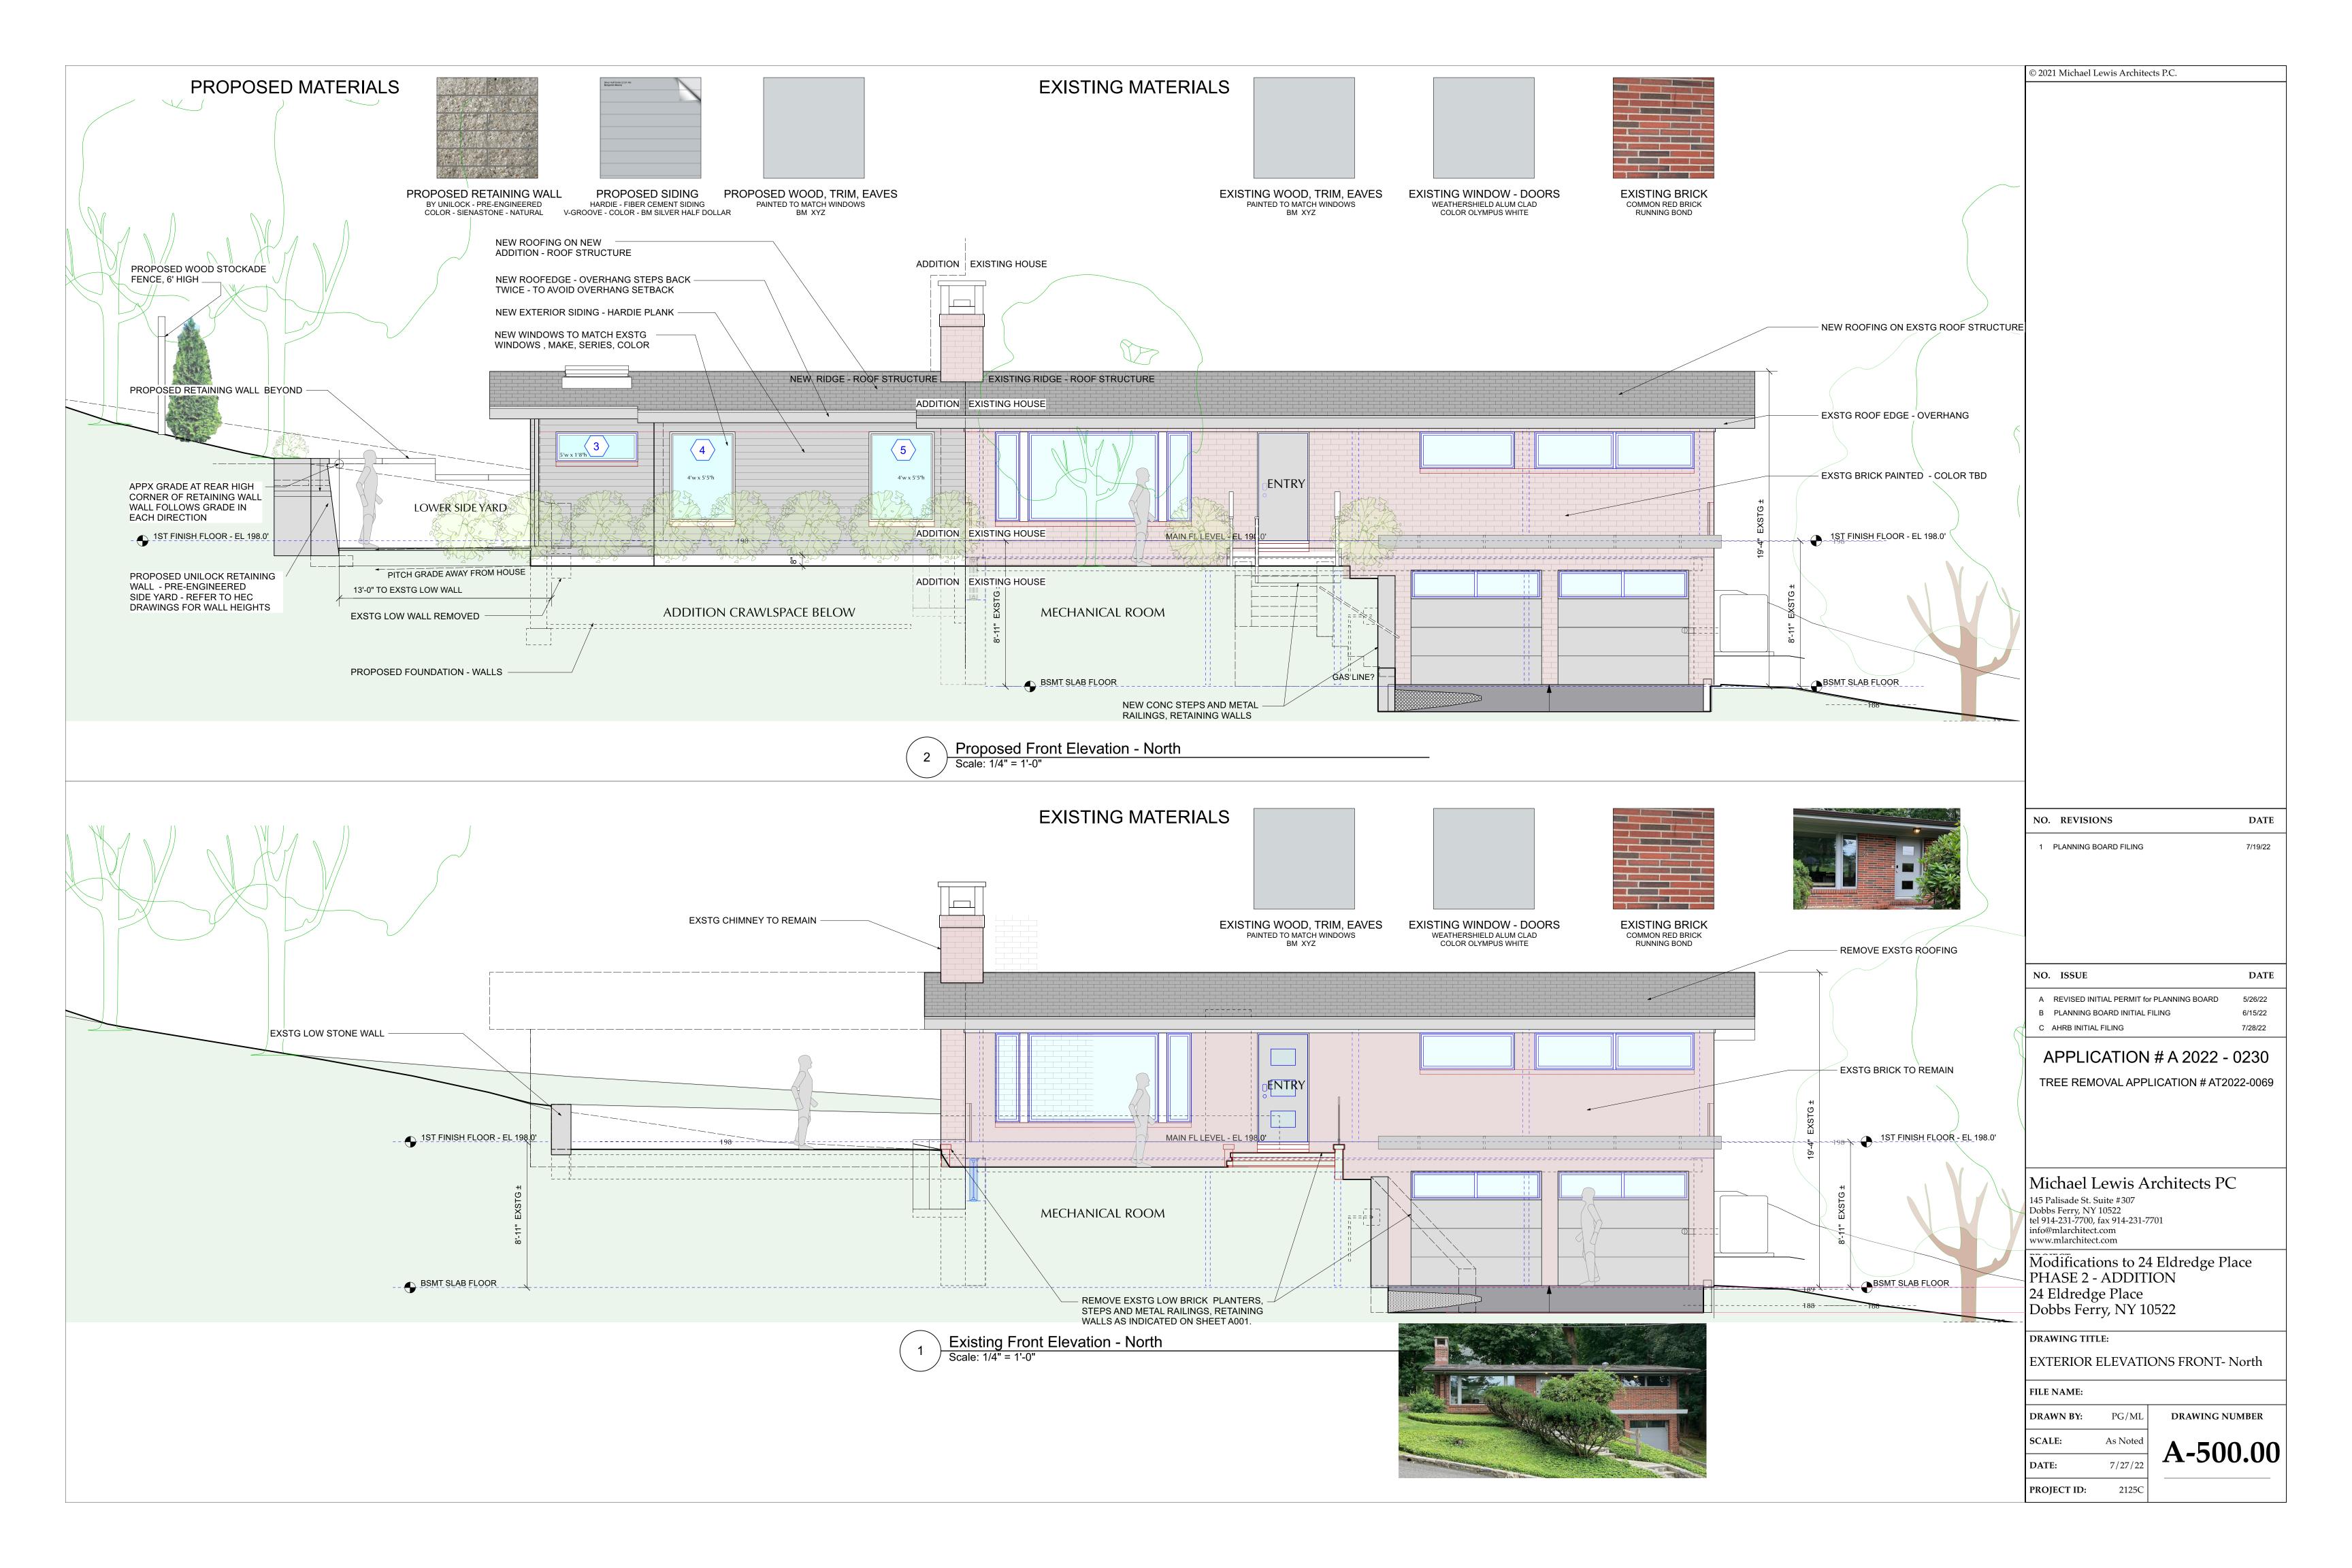

Existing Side Elevation - East Scale: 1/4" = 1'-0"

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EXSTG ROOF LINE - OVERHANG EXTENDED OVER NEW ADDITION EXSTG BRICK WALL BEYOND NEW EXTERIOR SIDING - HARDIE PLANK NEW CONC STEPS AND METAL RAILINGS, RETAINING WALLS BEYOND	© 2021 Michael Lewis Architects P.C.	
	NO. REVISIONS DATE	
	1 PLANNING BOARD FILING 7/19/22	
—— EXSTG CHIMNEY TO REMAIN		
REMOVE EXSTG ROOFING		
	NO. ISSUE DATE	
EXISTING ROOF, FASCIAS, GUTTERS, DOWNSPOUTS TO REMAIN, TYP. EXSTG BRICK TO REMAIN	AREVISED INITIAL PERMIT for PLANNING BOARD5/26/22BPLANNING BOARD INITIAL FILING6/15/22CAHRB INITIAL FILING7/28/22APPLICATION # A 2022 - 0230	
	TREE REMOVAL APPLICATION # AT2022-0069	
 REMOVE EXSTG LOW BRICK PLANTERS, STEPS AND METAL RAILINGS, RETAINING WALLS AS INDICATED ON SHEET A001. 		
	Michael Lewis Architects PC 145 Palisade St. Suite #307 Dobbs Ferry, NY 10522 tel 914-231-7700, fax 914-231-7701 info@mlarchitect.com www.mlarchitect.com	
	Modifications to 24 Eldredge Place PHASE 2 - ADDITION 24 Eldredge Place Dobbs Ferry, NY 10522	
	DRAWING TITLE: EXTERIOR ELEVATIONS SIDE - East	
	FILE NAME:	
	DRAWN BY: PG/ML DRAWING NUMBER SCALE: As Noted	
	SCALE: As Noted DATE: 7/27/22 A-501.00	
	PROJECT ID: 2125C	
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DATE
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1 PLANNING BOARD FILING

7/19/22

DATE

A	REVISED INITIAL PERMIT for PLANNING BOARD	5/26/22
В	PLANNING BOARD INITIAL FILING	6/15/22
С	AHRB INITIAL FILING	7/28/22

APPLICATION # A 2022 - 0230

TREE REMOVAL APPLICATION # AT2022-0069

Michael Lewis Architects PC 145 Palisade St. Suite #307 Dobbs Ferry, NY 10522 tel 914-231-7700, fax 914-231-7701 info@mlarchitect.com www.mlarchitect.com Modifications to 24 Eldredge Place PHASE 2 - ADDITION 24 Eldredge Place Dobbs Ferry, NY 10522

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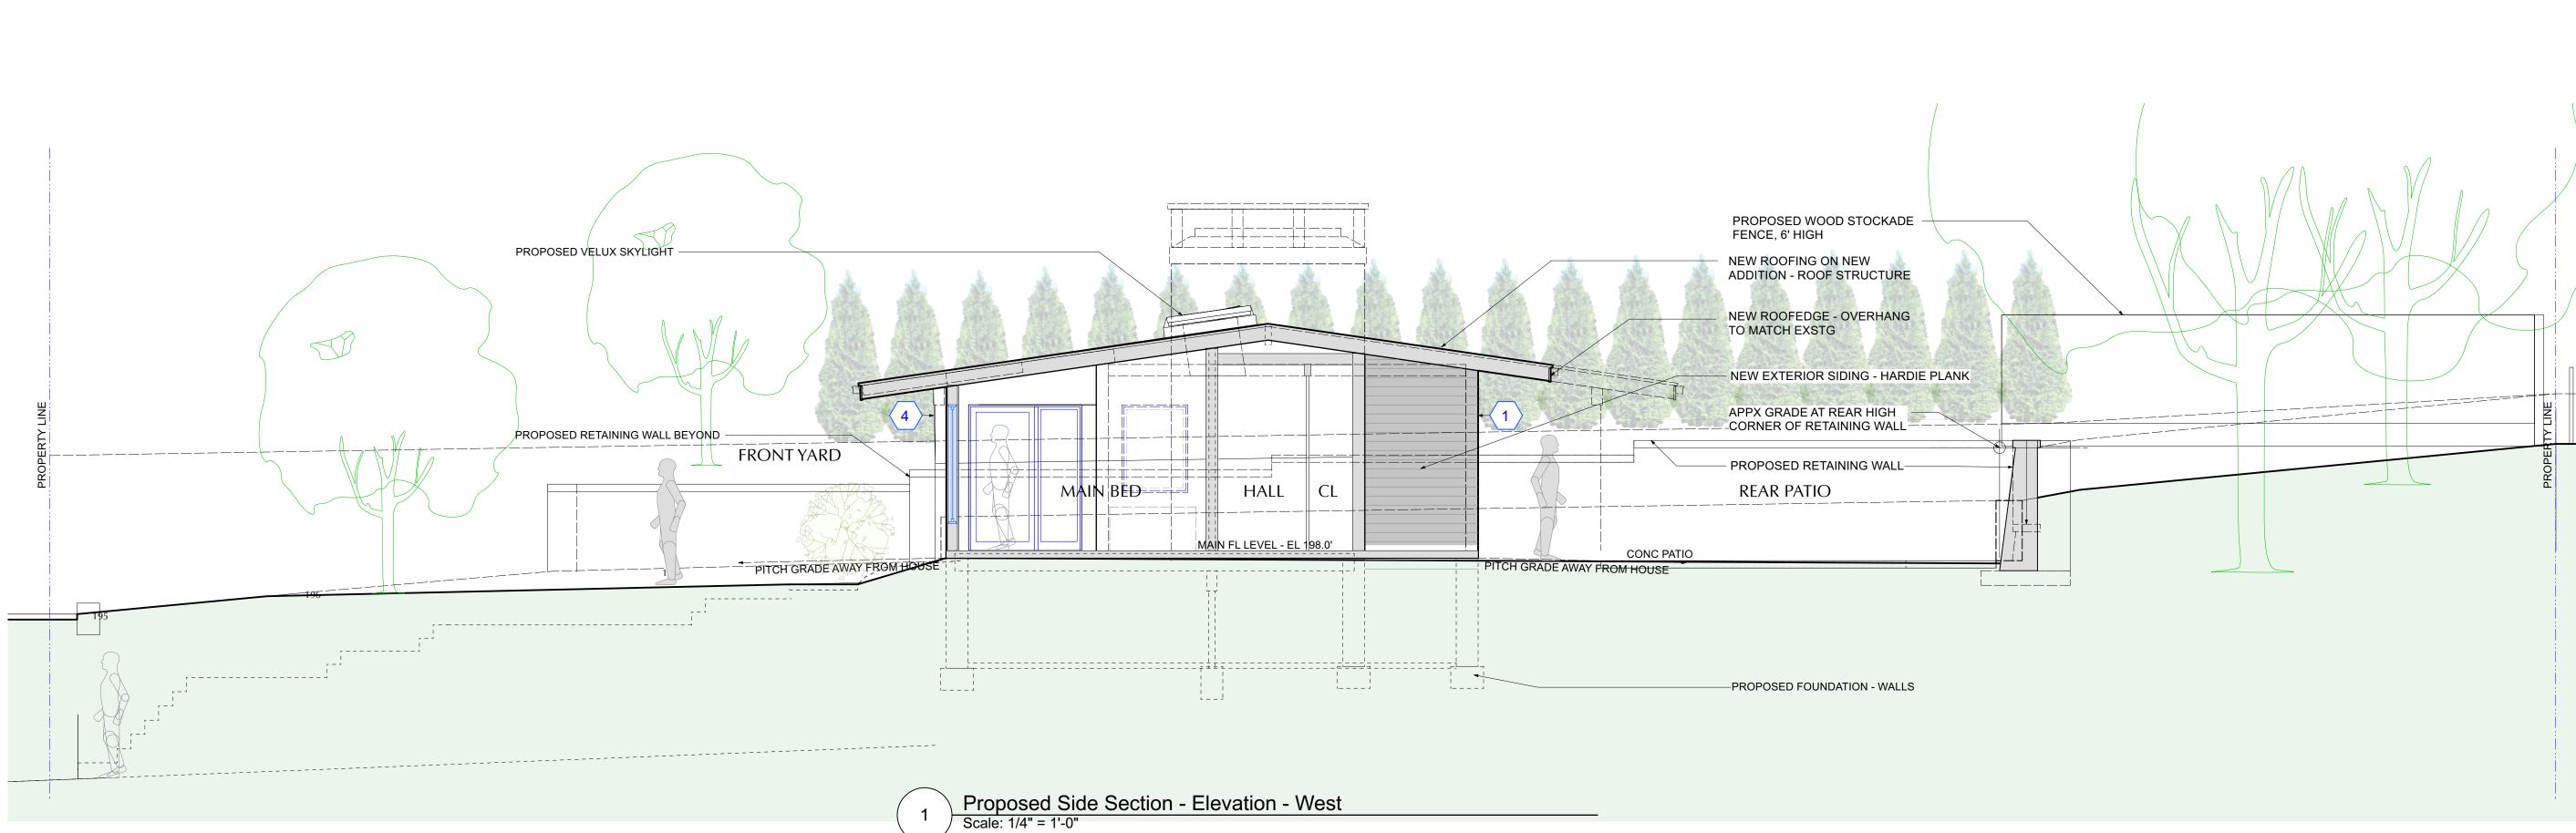
EXTERIOR ELEVATIONS REAR - South

FILE NAME:

DRAWN BY:	PG/ML
SCALE:	As Noted
DATE:	7/27/22
PROJECT ID:	2125C

DRAWING NUMBER





NO. REVISIONS

1 PLANNING BOARD FILING

DATE

7/19/22

DATE

NO. ISSUE

A REVISED INITIAL PERMIT for PLANNING BOARD 5/26/22 B PLANNING BOARD INITIAL FILING 6/15/22 C AHRB INITIAL FILING 7/28/22

APPLICATION # A 2022 - 0230

TREE REMOVAL APPLICATION # AT2022-0069

Michael Lewis Architects PC 145 Palisade St. Suite #307 Dobbs Ferry, NY 10522 tel 914-231-7700, fax 914-231-7701 info@mlarchitect.com www.mlarchitect.com Modifications to 24 Eldredge Place PHASE 2 - ADDITION

24 Eldredge Place Dobbs Ferry, NY 10522

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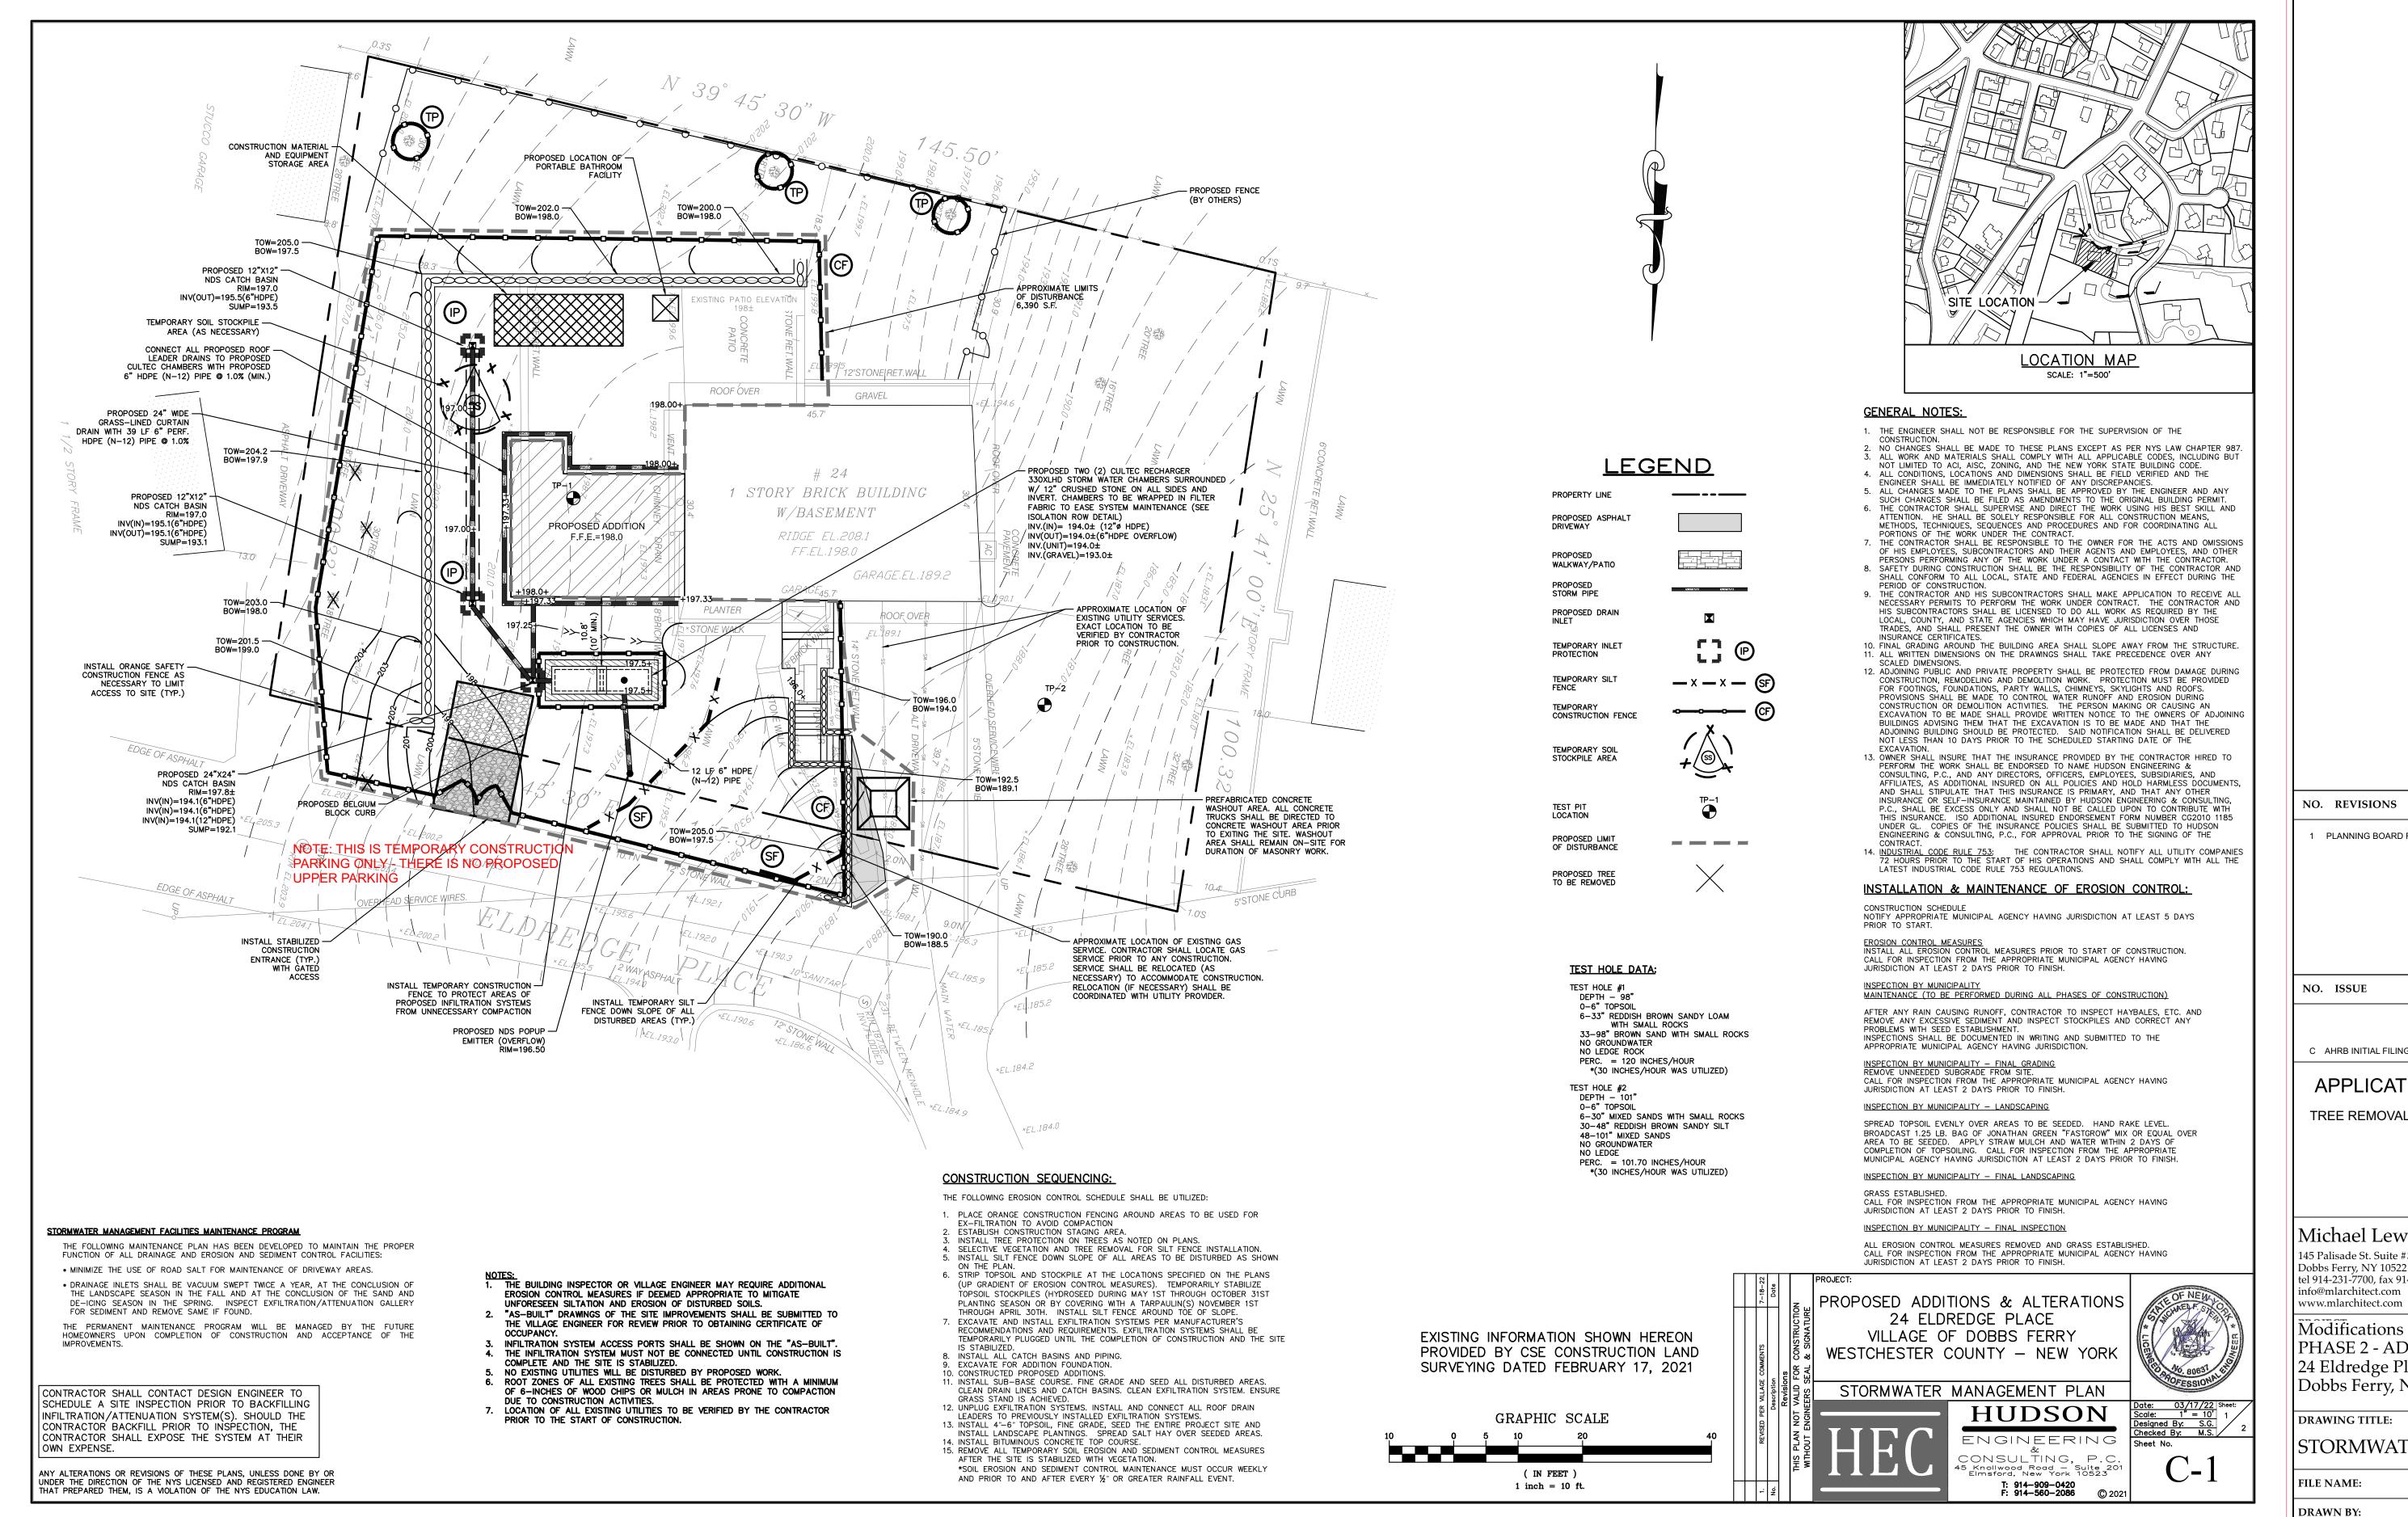
EXTERIOR ELEVATION SIDE - Partial West


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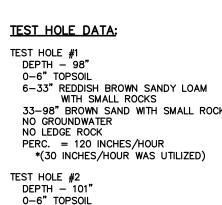
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DRAWING NUMBER







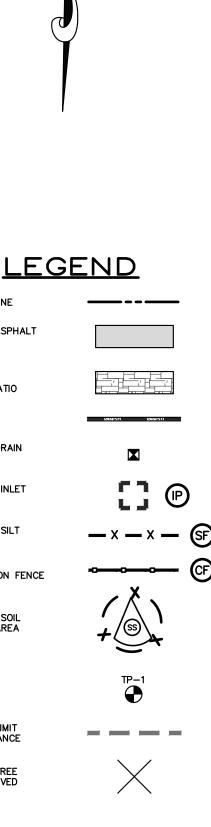

DATE 1 PLANNING BOARD FILING 7/19/22 DATE 7/28/22 APPLICATION # A 2022 - 0230 TREE REMOVAL APPLICATION # AT2022-0069 Michael Lewis Architects PC Dobbs Ferry, NY 10522 STORMWATER 1 - HEC

24 Eldredge Place

DRAWING NUMBER

A700.00

145 Palisade St. Suite #307 Dobbs Ferry, NY 10522 tel 914-231-7700, fax 914-231-7701 Modifications to 24 Eldredge Place PHASE 2 - ADDITION

AS NOTED

7/27/22

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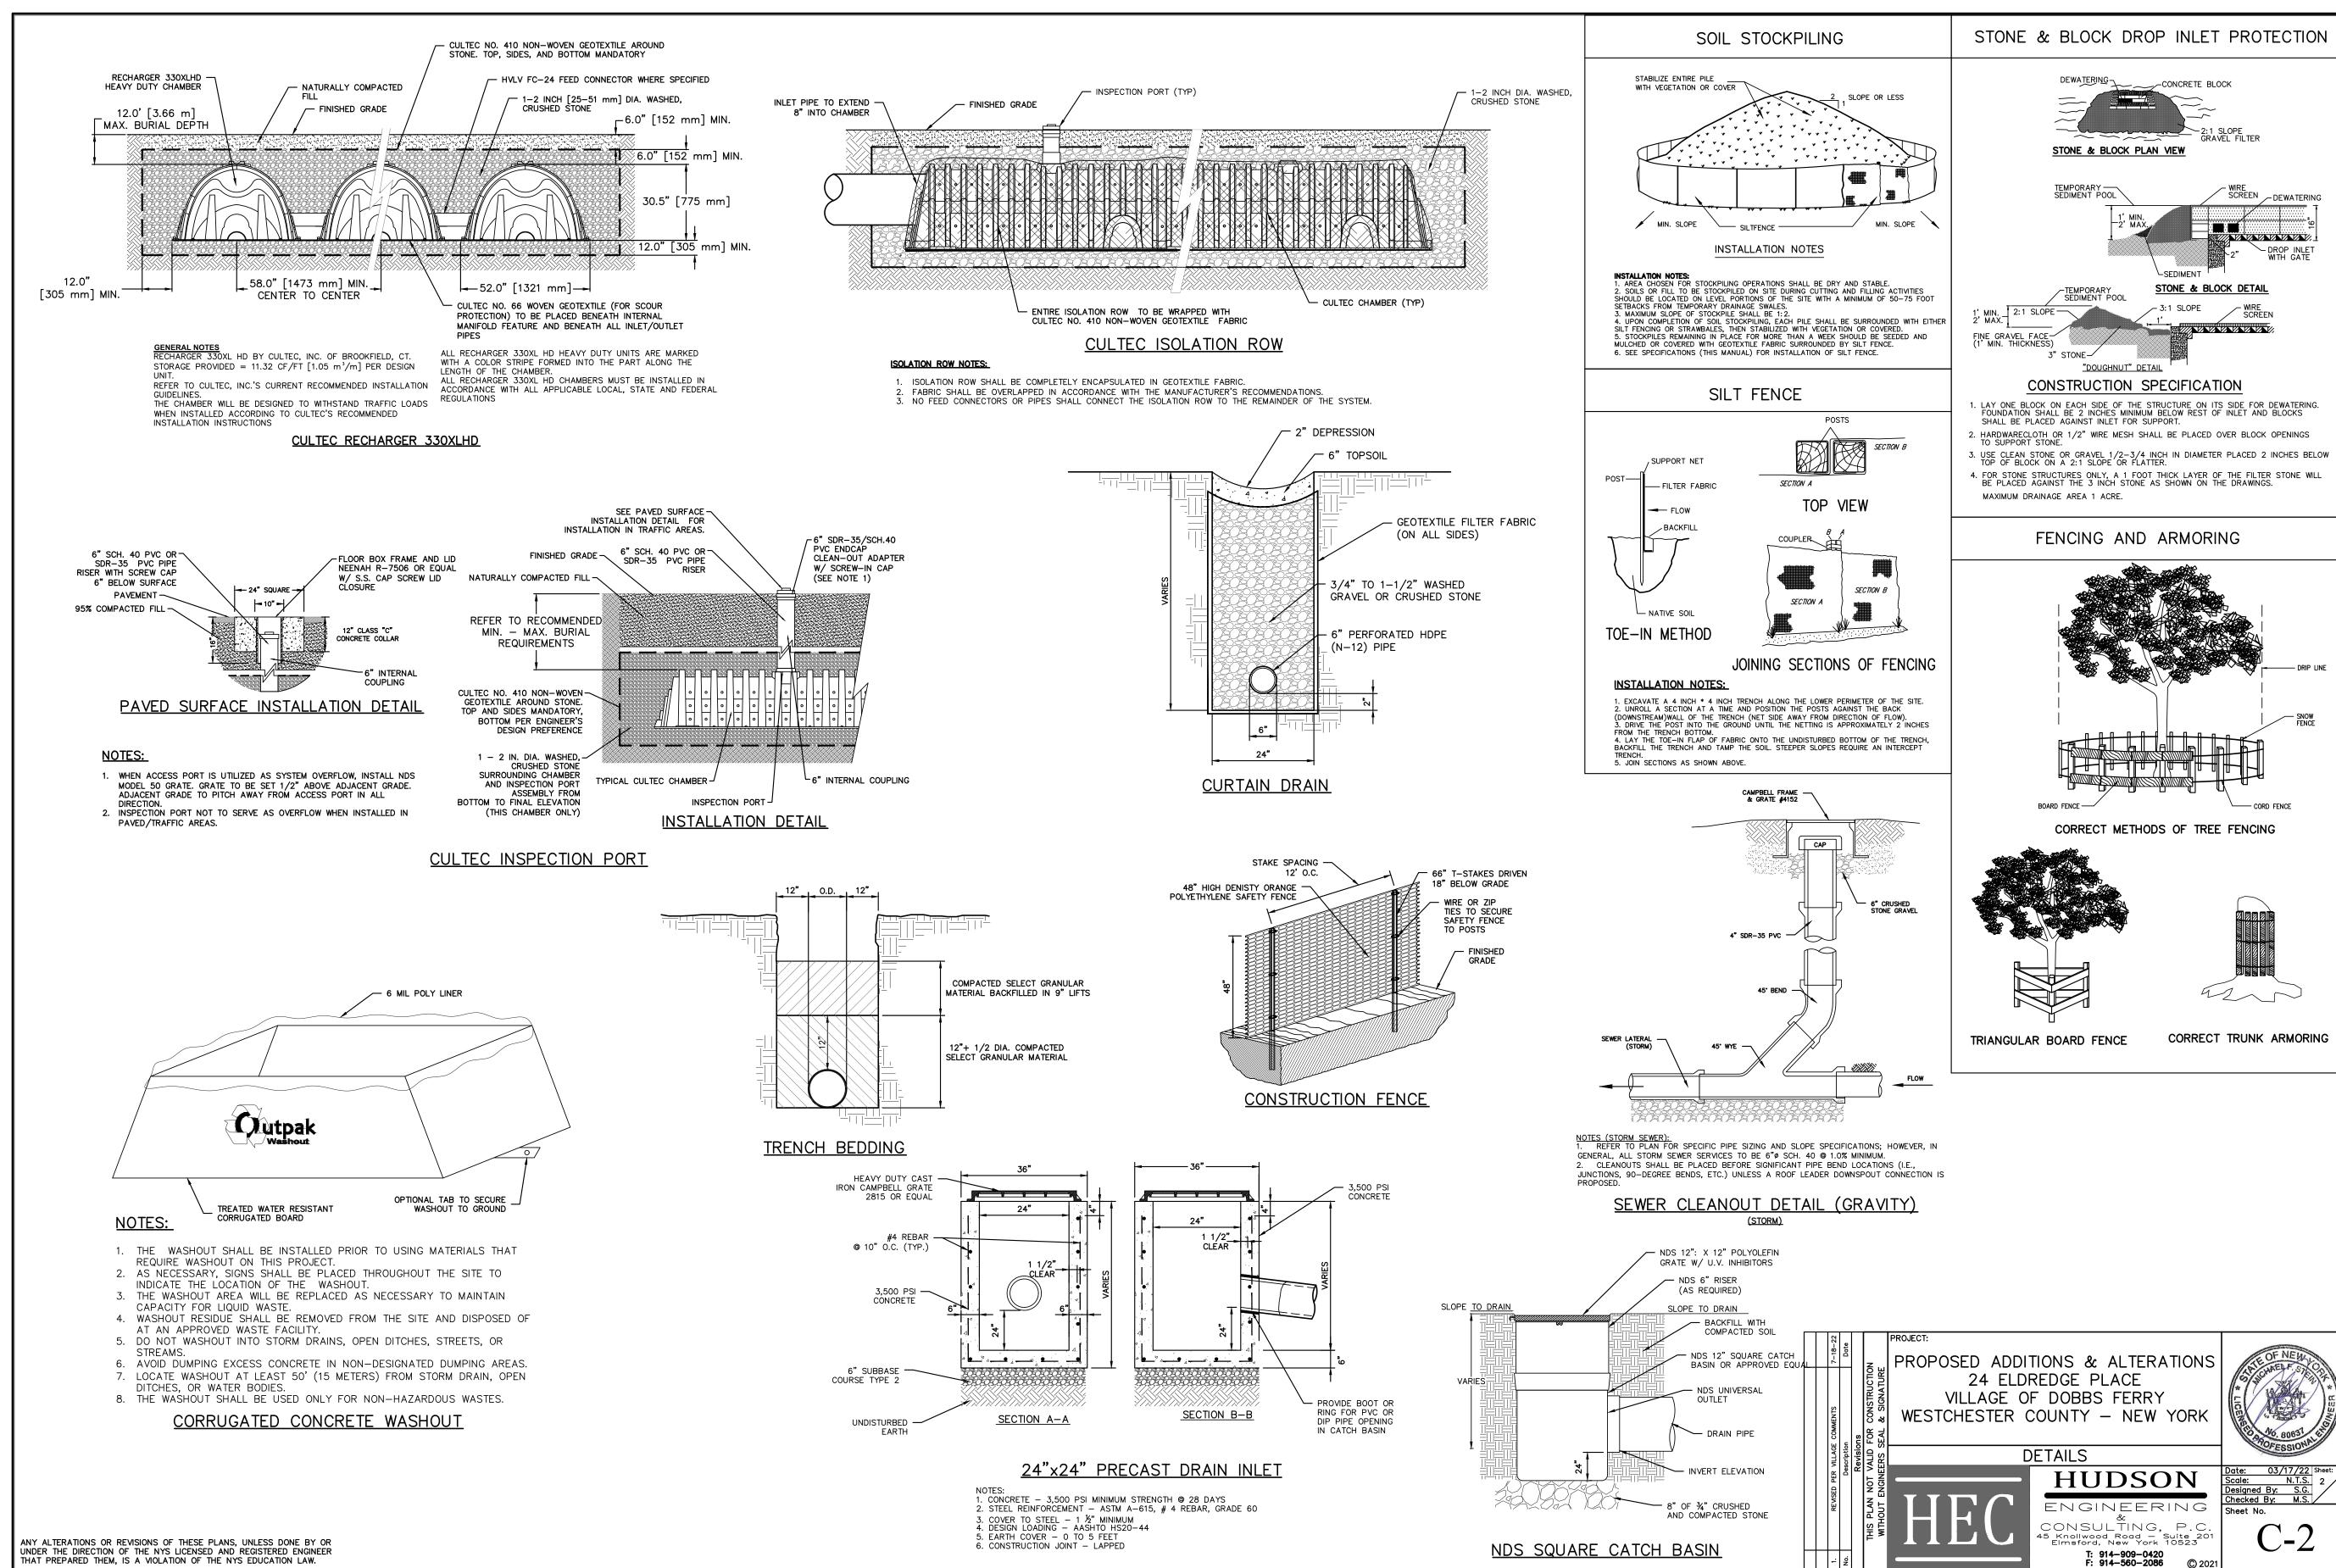
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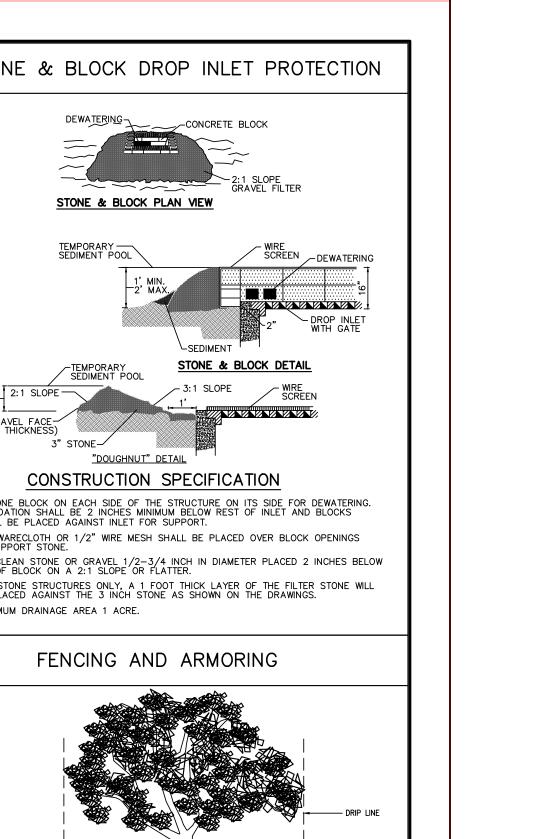
DATE:

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C AHRB INITIAL FILING

2021 Michael Lewis Architects P.C.





NO. REVISIONS 1 PLANNING BOARD FILING

NO. ISSUE

DATE

7/28/22

DATE

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APPLICATION # A 2022 - 0230 TREE REMOVAL APPLICATION # AT2022-0069

Michael Lewis Architects PC 145 Palisade St. Suite #307 Dobbs Ferry, NY 10522 tel 914-231-7700, fax 914-231-7701 info@mlarchitect.com www.mlarchitect.com Modifications to 24 Eldredge Place PHASE 2 - ADDITION 24 Eldredge Place Dobbs Ferry, NY 10522

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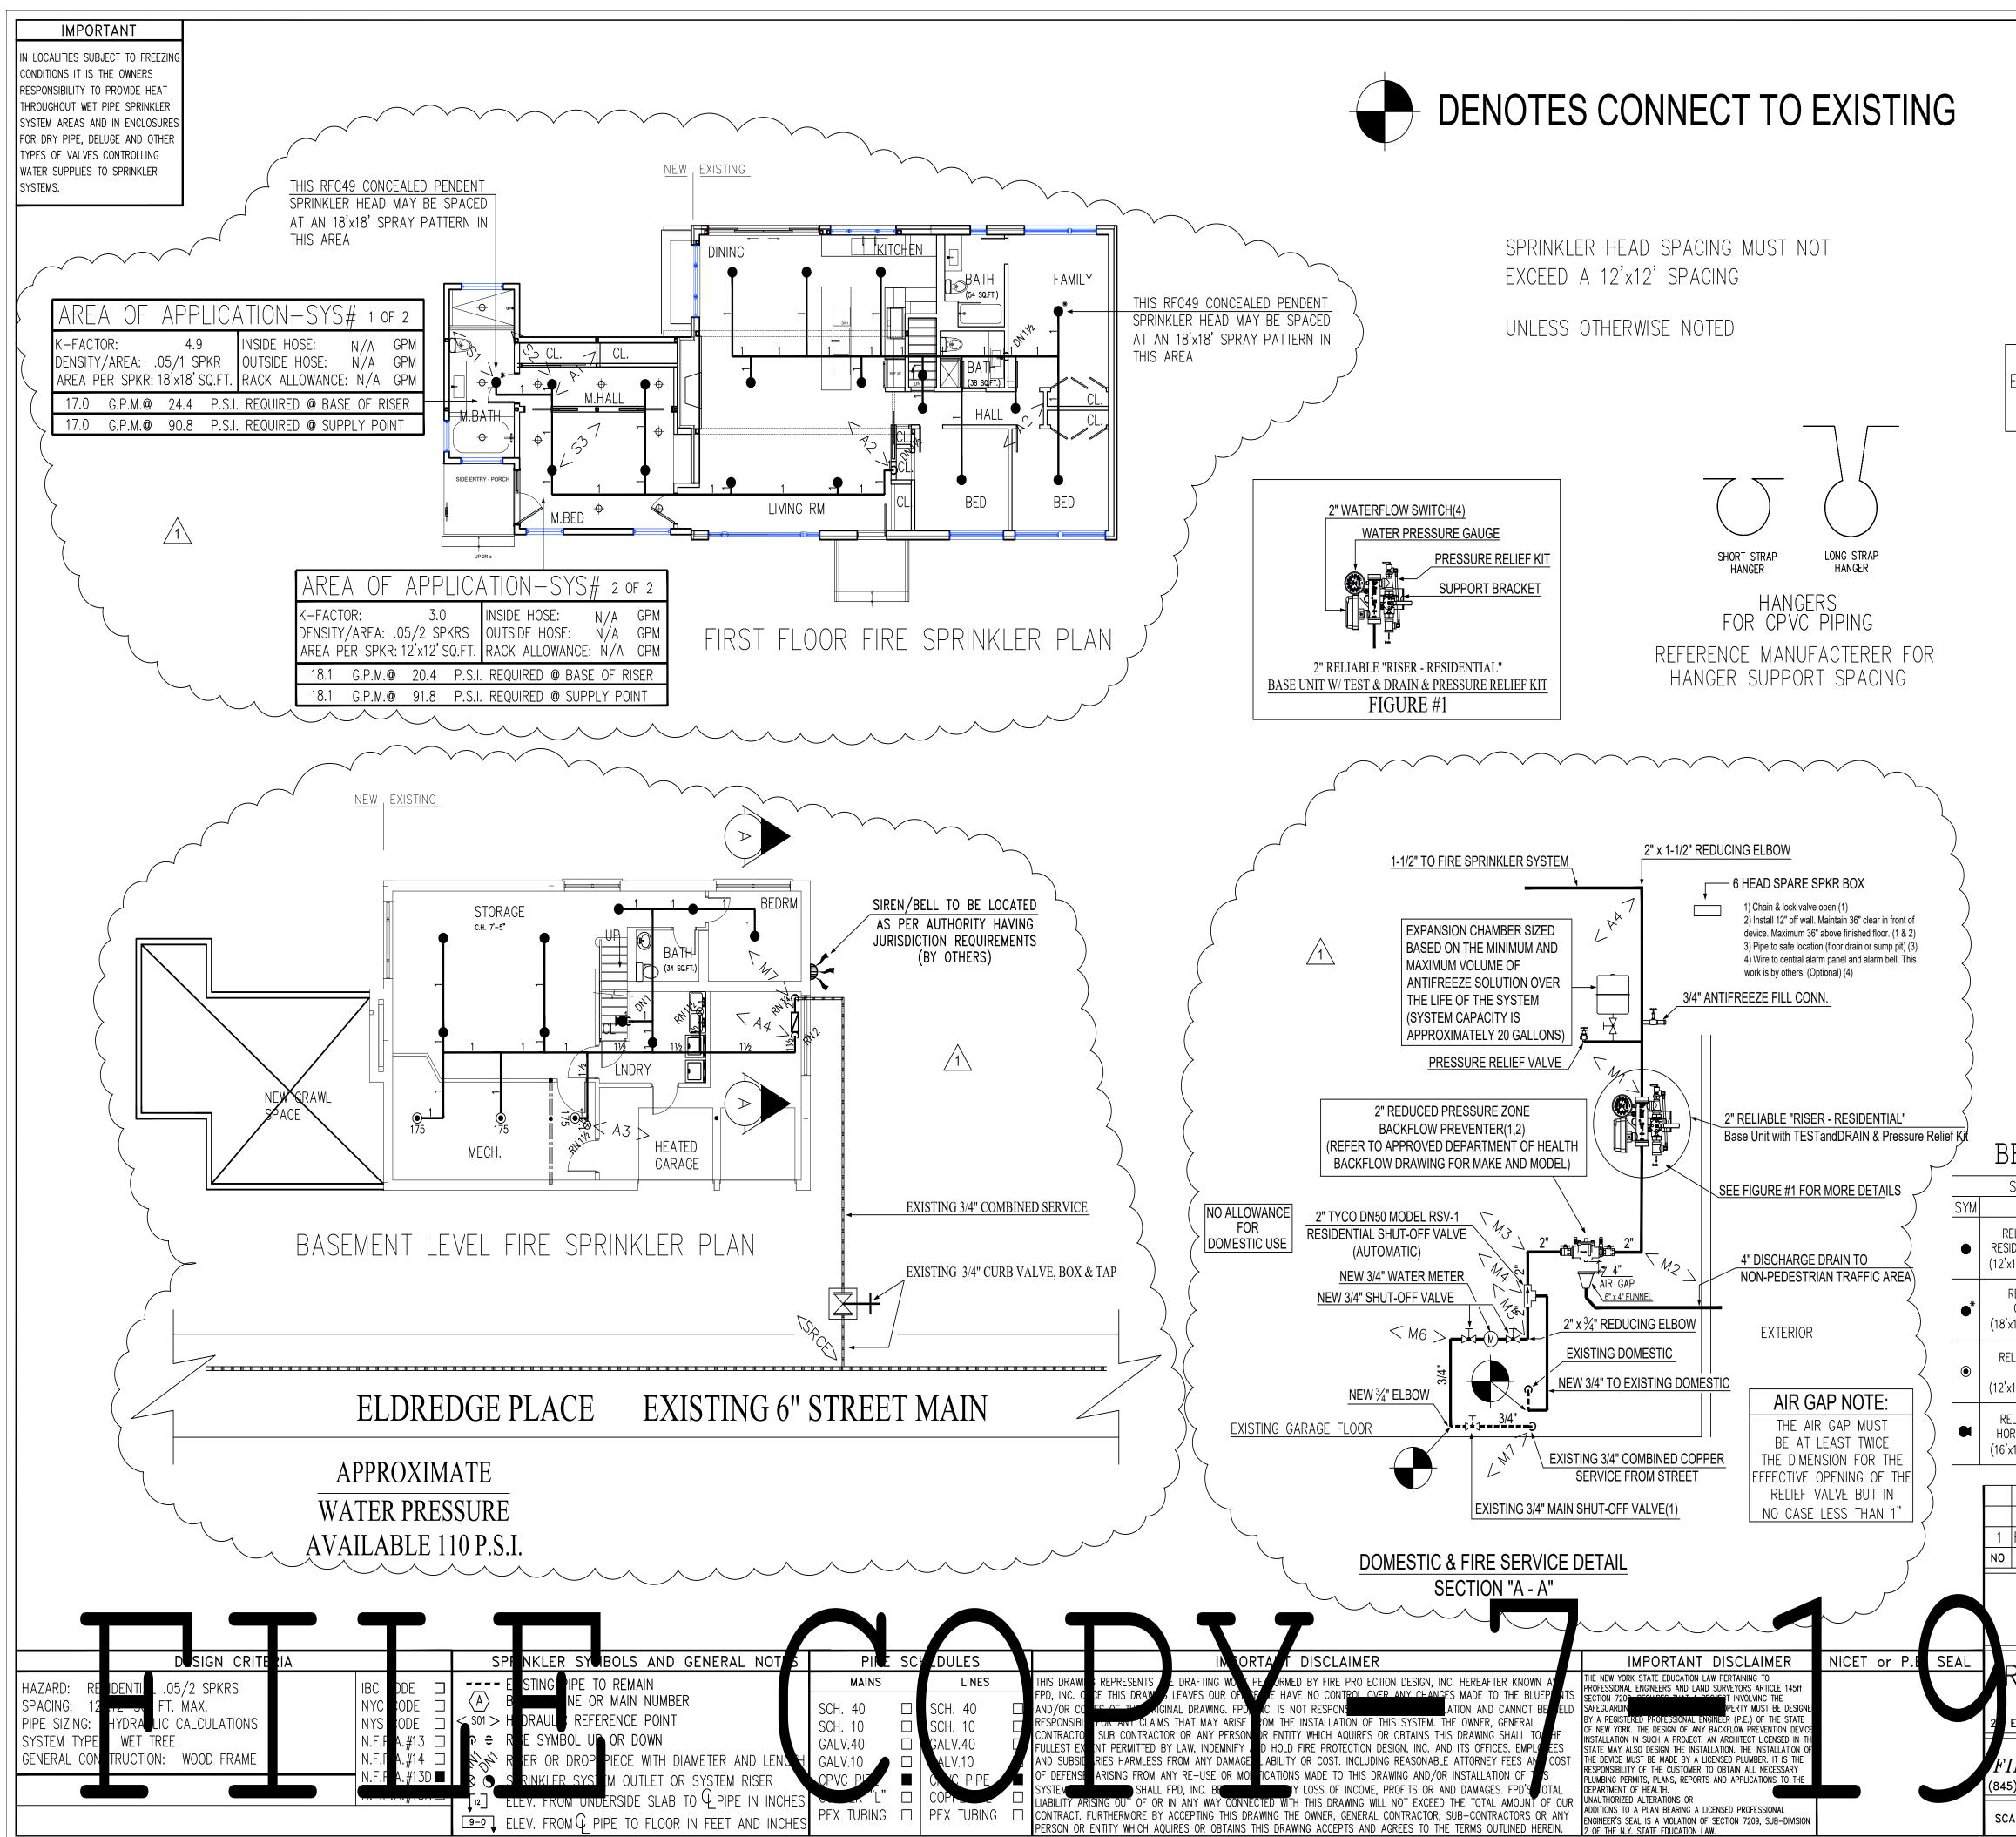
STORMWATER 2 - HEC

FILE NAME:

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	EL F1/Res44 DEWALL SPKR ACING-U.O.N.)	1				3/8"	1⁄2"	4.4	R3531	Michael 145 Palisade St		rchitects PC
										Dobbs Ferry, N tel 914-231-770 info@mlarchite www.mlarchite	VY 10522 10, fax 914-231-72 ect.com	701
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