



Original Scale 1/4" = 1'-0"

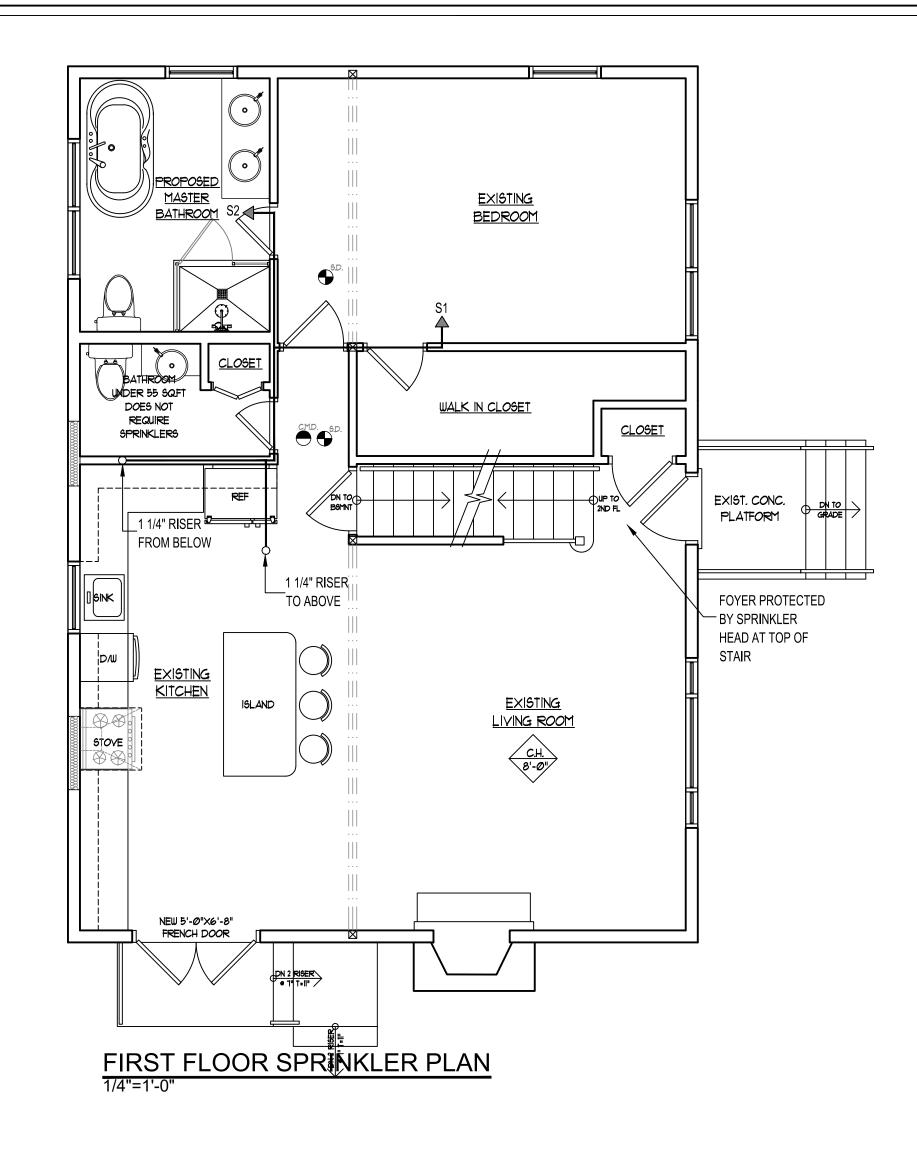

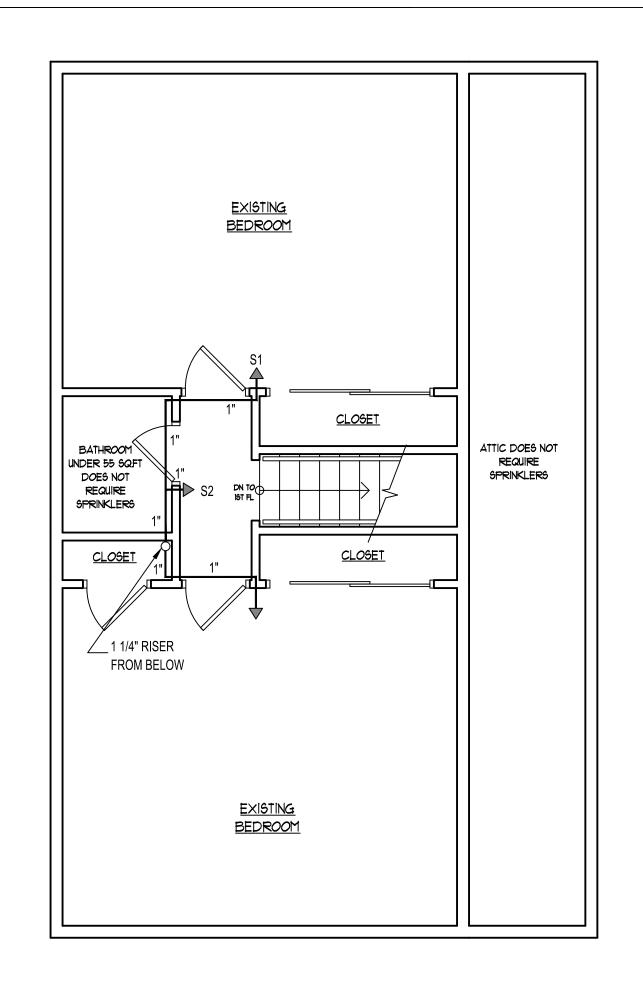

SECOND FLOOR SPRINKLER PLAN

GENERAL NOTES

1. Contractor shall provide a complete, safe and operable automatic fire sprinkler system in accordance with NFPA 13D-2013, these plans and all state, county and local laws governing such installation.

2. Piping shall conform to ASTM A135 Steel Schedule 40, or Copper Type M rated for fire service use. No bends or permitted of any pipe

SIN R3531, deflector 4"-6" below ceiling

Residential concealed sidewall fire sprinkler head, 155 degree F sprinkler temperature rating, 135 degree F cover plate temperature rating, K factor 4.4, Reliable Model F1 Res 44 SWC,

3. All steel connections shall threaded, all copper connections shall be threaded or soldered. Threads shall be NPT and conform to ANSI B.1.20.1.

4. All system components shall be rated for a minimum operating pressure of 175 PSI.

 Sprinkler heads shall not be painted ar atherwise covered with any coating unless applied by the manufacturer. Contractor shall submit shop drawings of substituted components.
 Maintenance of the system shall be the responsibility of the Owner.

8. Miscellaneous components required to properly install and set the sprinkler system in working order, but not explicitly shown on these plans shall be included in the work.

9. These are not as-built drawings

All fire sprinkler piping steel, either exposed or concealed. Or piping may be CPVC concealed.

Contractor shall ensure no strainers or pressure reducing valves are installed between the fire sprinkler system and water main in street, WCDOH allows omission of strainers on backflow prevention devices for fire sprinkler systems with backflow prevention devices 1 1/2" and smaller

Sprinkler head spacing notes:


-16'x16' maximum

-Minimum 8' between heads where more than 1 head in a compartment


Water only in the fire sprinkler system, Contractor shall ensure all piping and heads are within the heated envelope of the building.

Step No.	Size (inch)		Pipe Fittings and Devices	Length (ft)		C=120 (psi/ft)	Pressure Losses (psi)		Location	Pressure (psi)	(gpm)
Sprinkler S1	200 months (100 mm)	9.5	2 Elbows, 0 Tees	Length	8	A SECONDA	Sprinkler	13.22	10.00+34	-0.000	F140-4000-4000-
to	Nominal	1	40	Fitting	10	0.086	Pipe	1.55	S1	13.22	16.00
Sprinkler S2	Exact ID	1.049		Total	18	I	Elevation	0.00	S2	14.77	
1-40	Steel Sch	. 40 Pipe		Equiv.	Pipe	Friction Loss,	30				Flow required
Step No.	Size (inch)		Pipe Fittings and Devices			Pressure Losses (psi)		Location	Pressure (psi)	(gpm)	
Sprinkler S2	155 400 800	47333733	8 Elbows, 4 Tees	Length	95	d alternal	Backflow	6.00	558473	23/3/4/52	14 Millso
to	Nominal	1 1/4	25' Elevation Drop	Fitting	72	0.086	Pipe	14.36	S2	14.77	16.91
Water Meter Outlet	Exact ID	1.380	Backflow Device	Total	167		Elevation	10.83	Water Meter Outlet	45.96	
Prove West	Copper Type K		DEEDA HIDAGE P. APARE AND	Equiv. Pipe		Friction Loss,	Pressure Losses				Flow required
Step No.	Pipe Size (inch)		Pipe Fittings and Devices	Length	(ft)	C=150 (psi/ft)	(gain) (psi)		Location	Pressure (psi)	(gpm)
Water Meter Outlet	52 10 (K)	29.	0.625" Water Meter	Length	50		Meter	26.00	387800 160600 62 5300	0253255	11692710501
to	Nominal	. 1	0 Elbows, 0 Tees	Fitting	0	0.280	Pipe	14.00	Water Meter Outlet	45.96	32.91
Water Main	Exact ID	0.995	0' Elevation Drop	Total	50	T	Elevation	0.00	Water Main	85.96	32.91

Conclusion: Static pressure in municipal water main is 95 PSI, NFPA-13D flow and pressure are provided

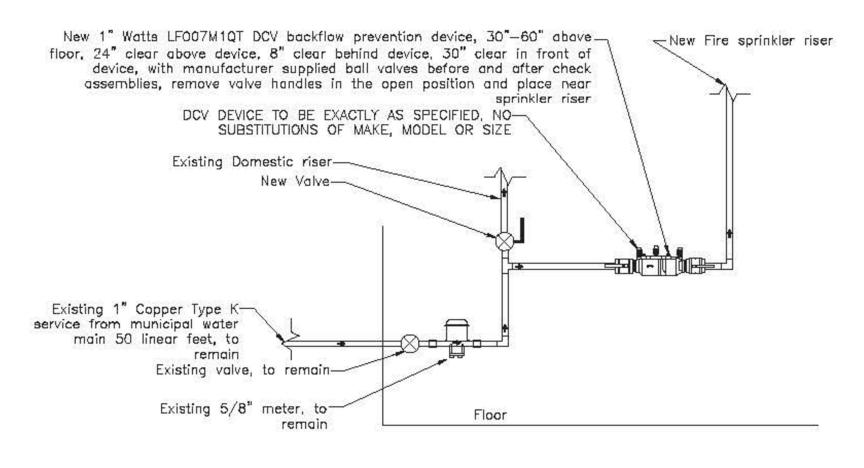

IMPORTANT NOTE: STRAINER PROHIBITED ON FIRE LINE Riser Diagram

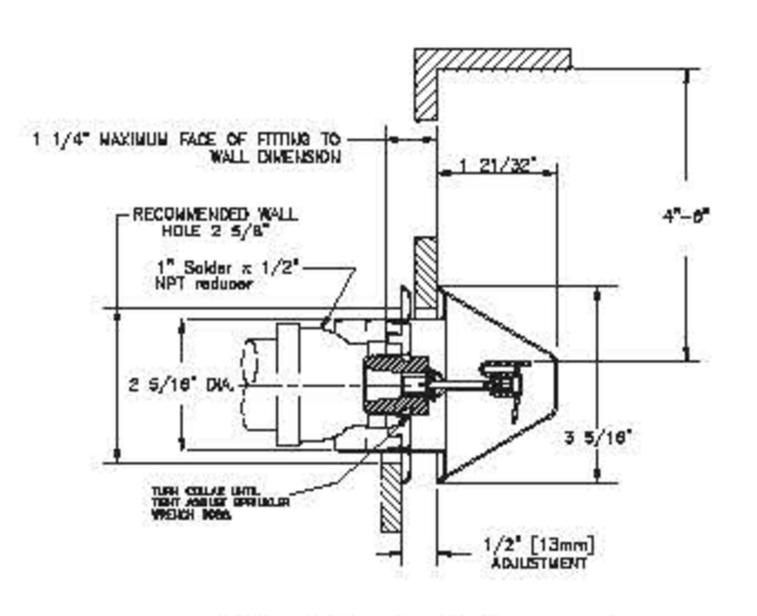

Sidewall head detail, no scale

ZONING DATA 85 VIRGINIA AVENUE, DOBBS FERRY, NEW YORK -10522 BLOCK: 54 SECTION: 3.90 ZONE: OF6 LEGEND EXISTING WALL TO REMAIN EXISTING NON BEARING WALL TO BE REMOVED NEW 2"X4" STUD WALL a 16" O.C. NEW 2"x6" STUD WALL 0.C. W/ NEW R-21 INSULATION AND VINYL SIDING ON EXTERIOR FINISH EXISTING SMOKE DETECTOR EXISTING CARBON MONOXIDE M.V. MECHANICAL VENTILATION 50 CMF EXISTING HEAT DETECTOR

> PETER KLEIN , ASSOCIATES, INC ARCHITECTS - BUILDERS - DEVELOPERS CONSTRUCTION MANAGEMENT 44 WINDING WOOD ROAD

RYE BROOK , NEW YORK 10573

OWNER

MAURICE WILLIAMS

PROJECT

PROPOSED FIRST FLOOR INTERIOR ALTERATION 85 VIRGINIA AVENUE,

DOBBS FERRY, NEW YORK -10522 SECTION: 3.90 BLOCK: 54 ZONE: OF6 LOT: 1

DRAWING LIST

GENERAL NOTES FIRE SPRINKLER PLANS FIRE SPRINKLER DETAILS

SEAL & SIGNATURE PROJECT No: 067-2021 DATE: 04-14-2021 DRAWING BY:L.P CKD BY: .P.K. DWG No: SP-001.00 CAD FILE No: 1 of 1