GENERAL NOTES

- THESE DRAWINGS SHALL MEET OR EXCEED THE APPLICABLE BUILDING CODES AND CODES OF NEW YORK STATE.
- 2. THESE DRAWINGS ARE THE PROPERTY OF THE ARCHITECT, AND SHALL NOT BE REPRODUCED AND / OR COPIED WITHOUT AUTHORIZATION.
- 3. ALL PROJECTS SUPPLYING A COMPONENT TO A BUILDER, SHALL HAVE NOTES WITH REFERENCE TO "IN-FIELD, "ON-SITE" OR "BY-BUILDER ARE PERTAINING TO RESPONSIBILITIES OF THE BUILDER.
- 4. THESE DRAWINGS SHOULD NOT BE SCALED FOR A DIMENSIONAL REFERENCE. DIMENSION LINES AND NOTES SUPERSEDE ANY SUCH REFERENCE.

THIS PROJECT DOES NOT RESULT IN THE CREATION OF IMPERVIOUS SURFACE.

ADDRESS

GENERAL NOTES

- THE ARCHITECT WAS NOT RETAINED FOR SUPERVISION AND DOES NOT ASSUME RESPONSIBILITY FOR CORRECTNESS OF FITNESS
- MINOR DETAILS NOT USUALLY SHOWN OR SPECIFIED, BUT NECESSARY FOR PROPER CONSTRUCTION OF ANY PART OF THE WORK, SHALL BE INCLUDED AS IF THEY WERE INDICATED ON DRAWINGS.
- ANY CHANGES AND / OR SUBSTITUTIONS SHALL BE APPROVED
- IN WRITING PRIOR TO BEING INCORPORATED INTO THE WORK. 4. THE CONTRACTOR SHALL BE RESPONSIBLE FOR ANY CHANGES
- AND DEVIATIONS FROM THE APPROVED PLANS.
- CONTRACTOR SHALL OBTAIN ALL NECESSARY PERMITS. 6. CONTRACTOR SHALL VERIFY ALL CONDITIONS AND DIMENSIONS AT THE SITE PRIOR TO COMMENCEMENT OF WORK AND NOTIFY

ARCHITECT OF DISCREPANCIES, IF ANY.

- 7. ALL WORK SHALL BE DONE IN ACCORDANCE WITH ALL STATE AND LOCAL CODES AND ORDINANCES.
- 8. SUBCONTRACTORS SHALL CO-ORDINATE THEIR WORK WITH ALL OTHER TRADES, SO AS NOT TO CAUSE ANY UNNECESSARY
- DELAYS IN PROJECT. 9. CONTRACTOR SHALL REMOVE ALL RUBBISH FROM SITE RESULTING FROM HIS WORK AND LEAVE THE PREMISES IN A CONDITION SATISFACTORY TO THE OWNER/CLIENT PRIOR TO FINAL INSPECTION.
- 10. CONTRACTOR SHALL BE RESPONSIBLE FOR APPROVALS AND FINAL INSPECTIONS OF HIS WORK BY LOCAL BUILDING INSPECTOR.
- 11. CONTRACTOR SHALL BE OBTAIN CERTIFICATE OF OCCUPANCY OR LETTER OF COMPLIANCE UPON COMPLETION OF WORK OF ALL TRADES.
- 12. ALL WORK PERFORMED SHALL BE OF THE QUALITY EXPECTED OF THE
- 13. CONTRACTOR SHALL GUARANTEE ALL WORK AND MATERIAL TO BE FREE FROM DEFECTS FOR A PERIOD OF ONE YEAR FROM DATE OF COMPLETION.
- 14. CONTRACTOR SHALL PREPARE ALL SURFACE AND INSTALL ALL MATERIALS AS PER MANUFACTURER'S INSTRUCTION & RECOMMENDATIONS.

- 15. ALL LUMBER USED SHALL BE OF GOOD QUALITY AND FREE OF ANY SPLITS, CHECKS OR WARPING.
- 16. ALL LUMBER SHALL BE CONSTRUCTION GRADE DOUG-FIR, NO.2 BETTER
- 17. ALL SELECTIONS OF MATERIALS, FINISHES, STAINS, COLORS ETC. SHALL BE BY OWNER UNLESS OTHERWISE NOTED.
- 18. CONTRACTOR SHALL USE FIGURE DIMENSIONS ONLY AND NO TIME SHALL HE SCALE THE DRAWINGS.

ENERGY CONSERVATION CONSTRUCTION CODE OF N.Y.S. SECTION 101 - SCOPE AND GENERAL REQUIREMENTS


101.4 - EXISTING BUILDINGS EXCEPT AS SPECIFIED IN CHAPTER THIS CODE SHALL NOT BE USED TO REQUIRE THE REMOVAL, ALTERATION OR ABANDONMENT OF, NOR PREVENT THE CONTINUES USE \$ MAINTENANCE OF, AN EXISTING OR BUILDING SYSTEM LAWFULLY IN EXISTENCE AT THE TIME OF ADOPTION OF THIS CODE.

101.4.3 - ADDITIONS, ALTERATIONS OR RENOVATIONS ADDITIONS, ALTERATIONS OR RENOVATIONS TO EXISTING BUILDING, BUILDING SYSTEMS OR PORTION THEREOF SHALL CONFORM TO THE PROVISONS OF THIS CODE AS THEY RELATE TO NEW CONSTRUCTION WITHOUT REQUIRING THE UNALTERED PORIONS TO COMPLY (SEE EXCEPTIONS)

I. EXISTING CEILING, WALL OF FLOOR CAVITIES, IN THE BUILDING ENVELOPE EXPOSED DURING CONSTRUCTION SHALL BE FILLED TO FULL DEPTH WITH INSULATION HAVING A MINMUM R-VALUE OF 3 INCHES.

2 ALL NEWLY INSTALLED VINYL REPLACEMENT WINDOW UNITS SHALL FIT EXISTING OPENINGS AND MEET THE FOLLOWING CRITERIA,: MAXIMUM U-VALUE OF 35 AND MAXIMUM SHGC 40.

3. ANY NEW MECHANICAL SYSTEM SHALL COMPLY WITH NEW YORK STATE ENERGY CODE.

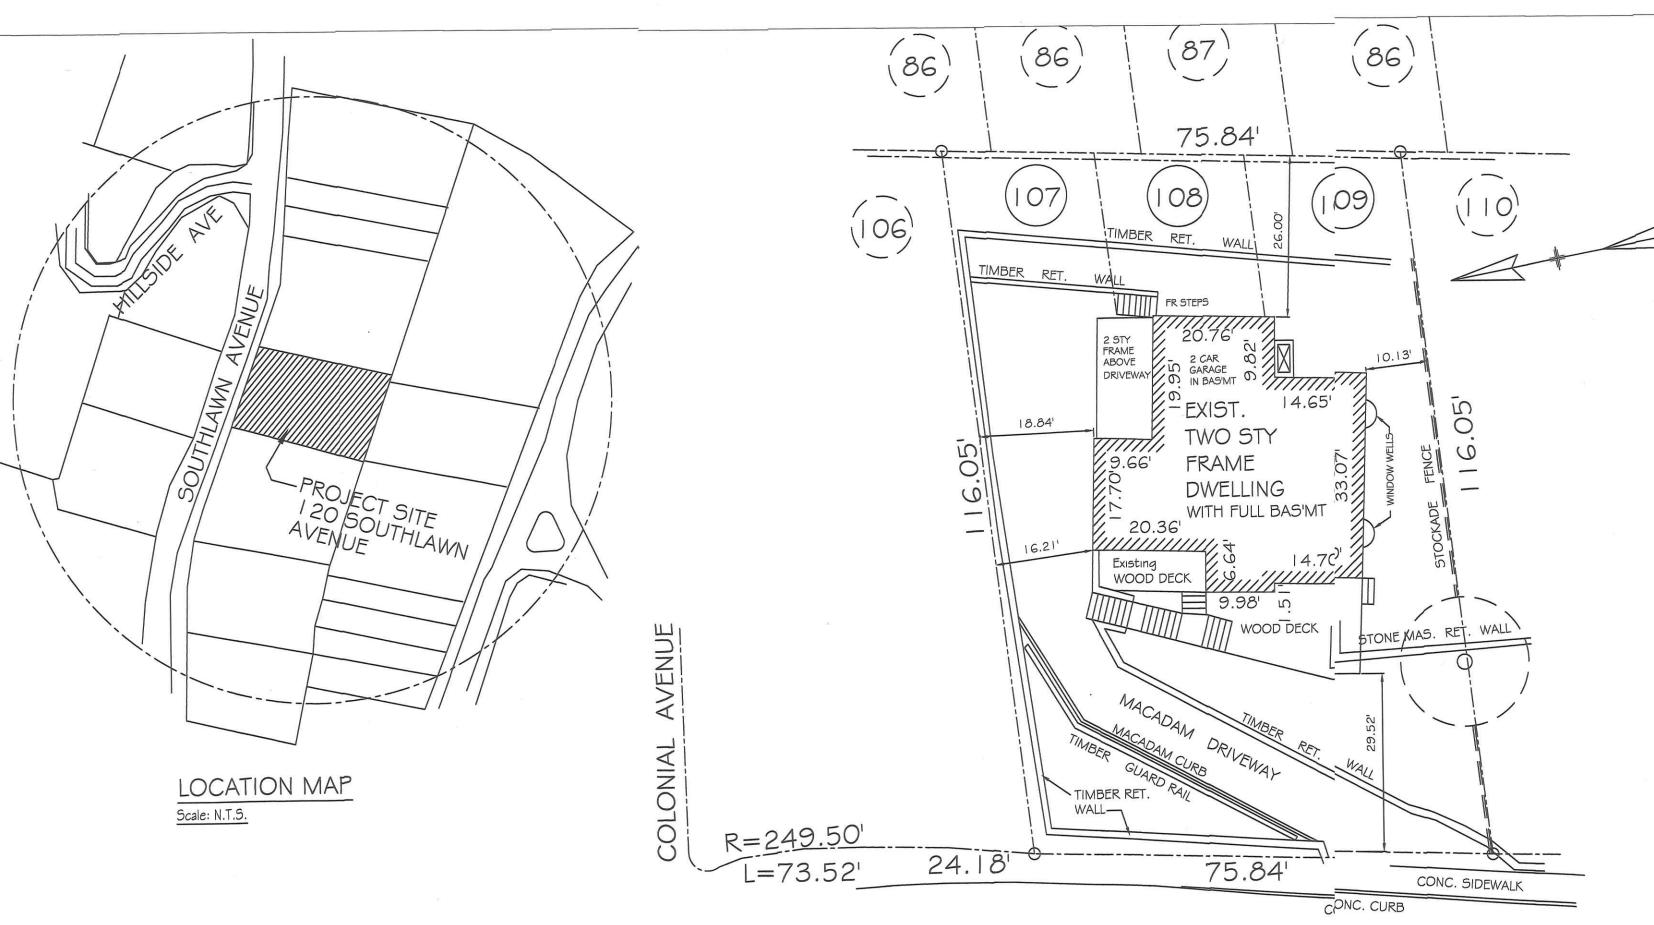


FOR INFORMATION ONLY ZONING CHART NO WORK DONE UNDER THIS APPLICATION TO EXIST. BUILDING INTERIOR OR EXTERIOR

ZONE

120 SOUTHLAWN AVENUE		3.120-113-18			I FAMILY	
				OF-5		
ABLE 1: FLOOR AREA	5					
STORY	EXISTING	AREA	EXISTING HABITABLE AREA	AREA OF RENOVATION	NEW AREA	
2	138	30	2945	-	-	
DECK	56	50	N/A		-	
TOTAL	194	10	N/A			

TABLE 2: BUILDING DIMENSIONS	EXIST. / PROPOSED	MINIMUM ALLOWABLE
LOT AREA (ft²)	8365	7500
LOT WIDTH (ft)	75.84	75
LOT DEPTH (ft)	116.05	100
COVERAGE BY BUILDING (%)	25	22
COVERAGE BY IMPERVIOUS SURFACES (%)	48	44
FRONT YARD SETBACK (ft)	44.4	29
REAR YARD SETBACK (ft)	26	25
SIDE YARD SETBACK, EACH (ft)	19.1	10
SIDE YARD SETBACK, BOTH (ft)	26.34	25

ADLE 3. HEICHT				
ABLE 3: HEIGHT	EXIST. / PROPOSED	ALLOWED		
NUMBER OF STORIES	2	2 1/2		
GRADE TO RIDGE (OF+MDR-1)	32	33		
GRADE TO EAVE (OF+MDR-1)	24	28		
GRADE TO MID-POINT OF ROOF (ALL OTHER)	28	30.5		

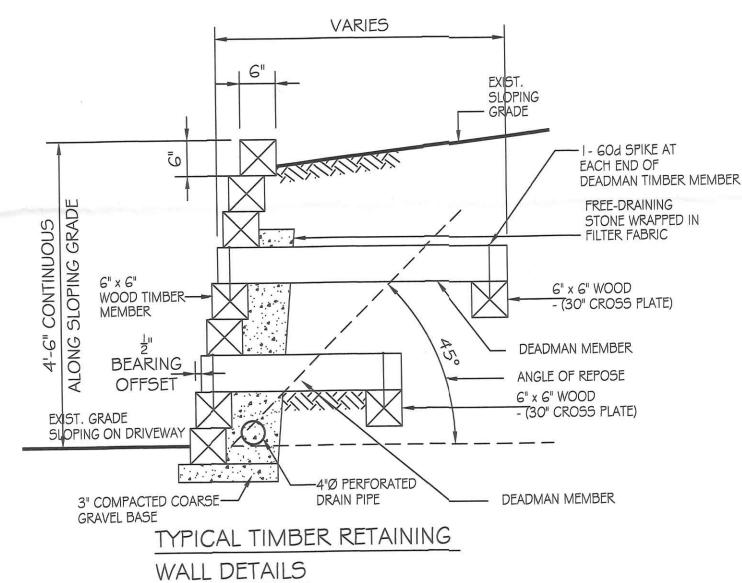

SCALE: 3/4" = 1'-0"

60d SPIKES OR MTL


4"Ø PERFORATED -

DRAIN PIPE

6" x 6" NEADMAN TIMBER MEMBER (TYP.)

BOLTS @ 24" OCS. STAGGERED ——
ALONG EACH COURSE OF
6" x 6" TIMBER MEMBER

___2- 60d SPIKES OR MTL BOLTS

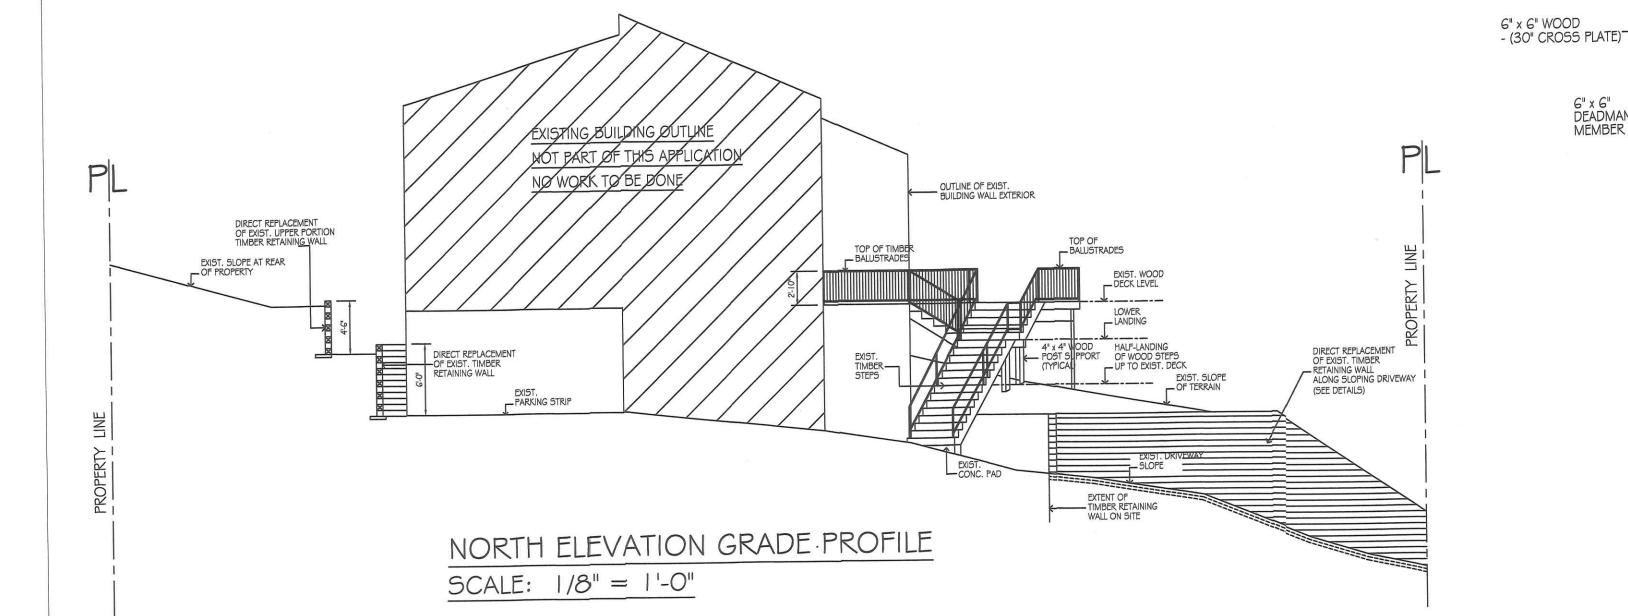

SOUTHLAWN AVENUE PLOT PLAN Scale: 1/16"=1'-0" CONSTRUCTION NOTES \$ SPECIFICATIONS

ALL PROPOSED WORK HAS BEEN DESIGNED AND MUST BE PERFORMED IN COMPLIANCE WITH THE 2020 NYS RESIDENTIAL CODE, VILLAGE OF DOBBS FERRY MUNICIPAL CODE AND ALL APPLICABLE RULES AND REGULATIONS.

2. MINIMUM FOOTING DEPTH SHALL BE 42" AS FER R403.1.4.1 EXCEPTION 3.

MINIMUM CONCRETE STRENGTH FOR FOOTING TO BE 2500 PSI. CONCRETE TO BE AIR ENTRAINED. (R402.2)

ALL FRAMING LUMBER SHALL BE DOUGLAS FIR SELECT STRUCTURAL OR BETTER, (R319 \$ 502.1)

WITH A MINIMUM OF F = 1900 PSI IN EXTREME BENDING. ALL LUMBER EXPOSED TO WEATHER OR IN CONTACT WITH CONCRETE SHALL BE PRESSURE TREATED. (R3 | 9)

DECK STRUCTURAL DESIGN LOADS SHALL BE AS PER R301-5:

LIVE LOADS **DESIGN LOADS:** DECK FLOOR

GUARD RAILS 6. ALL FASTENERS FOR PRESERVATIVE TREATED LUMBERS SHALL BE GALVANIZED STEEL. (R319.3)

7. ALL DECK SUPPORT BEAMS ENDS MUST BEAR ON A SUPPORT AT LEAST 1.5" FOR WOOD. (R502.6.1)

8. GUARDRAILS AT DECK TO BE 3FT HIGH MINIMUM. (R3 | 2.1)

200 PSI

9. THE PROPOSED WORK HAS BEEN DESIGNED IN COMPLIANCE WITH THE 2016 NYS ENERGY CODE. (N1101.4.3.)

RECEIVED

DEC 0 9 2022

VILLAGE OF DOBBS FERRY

SCOPE OF WORK

ROCK RETAINING

-TYPICAL DEADMAN TIMBER

AXONOMETRIC VIEW

SCALE: 1/2" = 1'-0"

NOTE: 51 PCS SLEEPER FRONT FACE

15 PCS FRONT

27 PCS REAR

TIMBER RETAINING WALL

DIRECT REPLACEMENT OF EXISTING TIMBER RETAINING WALL ALONG EXIST. DRIVEWAY UP TO WOOD STAIR AND ON THE NORTH SIDE OF PROPERTY LINE

SITE DATA

HOUSE: 120 SOUTHLAWN AVENUE BLOCK: 113

LOT# : 18

BUILDING DEPARTMENT MAP : 3.120

Table R301.2(1) CLIMATIC AND GEOGRAPHIC DESIGN CRITERIA

Ground	Wind	Seismic	Seismic Subject to Damage From:			Winter Design	ice Shield Underlayment	Flood Hazards	
Snow Load (psf)	Speed (mph)	Design Category	Weathering	Frost Line Depth	Termite	Decay	Temp.	Required	110201003
30	110-130	С	Severe	3'-6"	Moderate To Heavy	Slight To Modera ^{te}	7°	N/A	FIRM 360922 FOR FIRM map dated 9/27/2007

Registered Architects 443 Fifth Avenue

FRED

Pelham, New York 10803 TEL.: 914-235-3022

GEREMIA



FNUE 1052 120 SOUTHLAWN AV DOBBS FERRY, NY. WAL RETAINING MBI **—**

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REPLACEMENT

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actual or designed conditions.

Written dimensions shall govern.

12-07-22 DOB 11-22-22 DOB 11-16-22 DOB 10-04-22 DOB 09-30-22 DOB

> Drawing Title NOTES, SITE PLAN

AXONOMETRIC VIEW RETAINING WALL DETAIL LOCATION MAP

NORTH & EAST ELEVATION ZONING CHART & GENERAL NOTES

ı						
	Project::	Job No:				
İ	Date:	Scale:				
	SEP. 22	AS NOTED				
	Drawn By: EW	Drawing No:				
	Checked By: RWW					