## 156 PALISADE STRET

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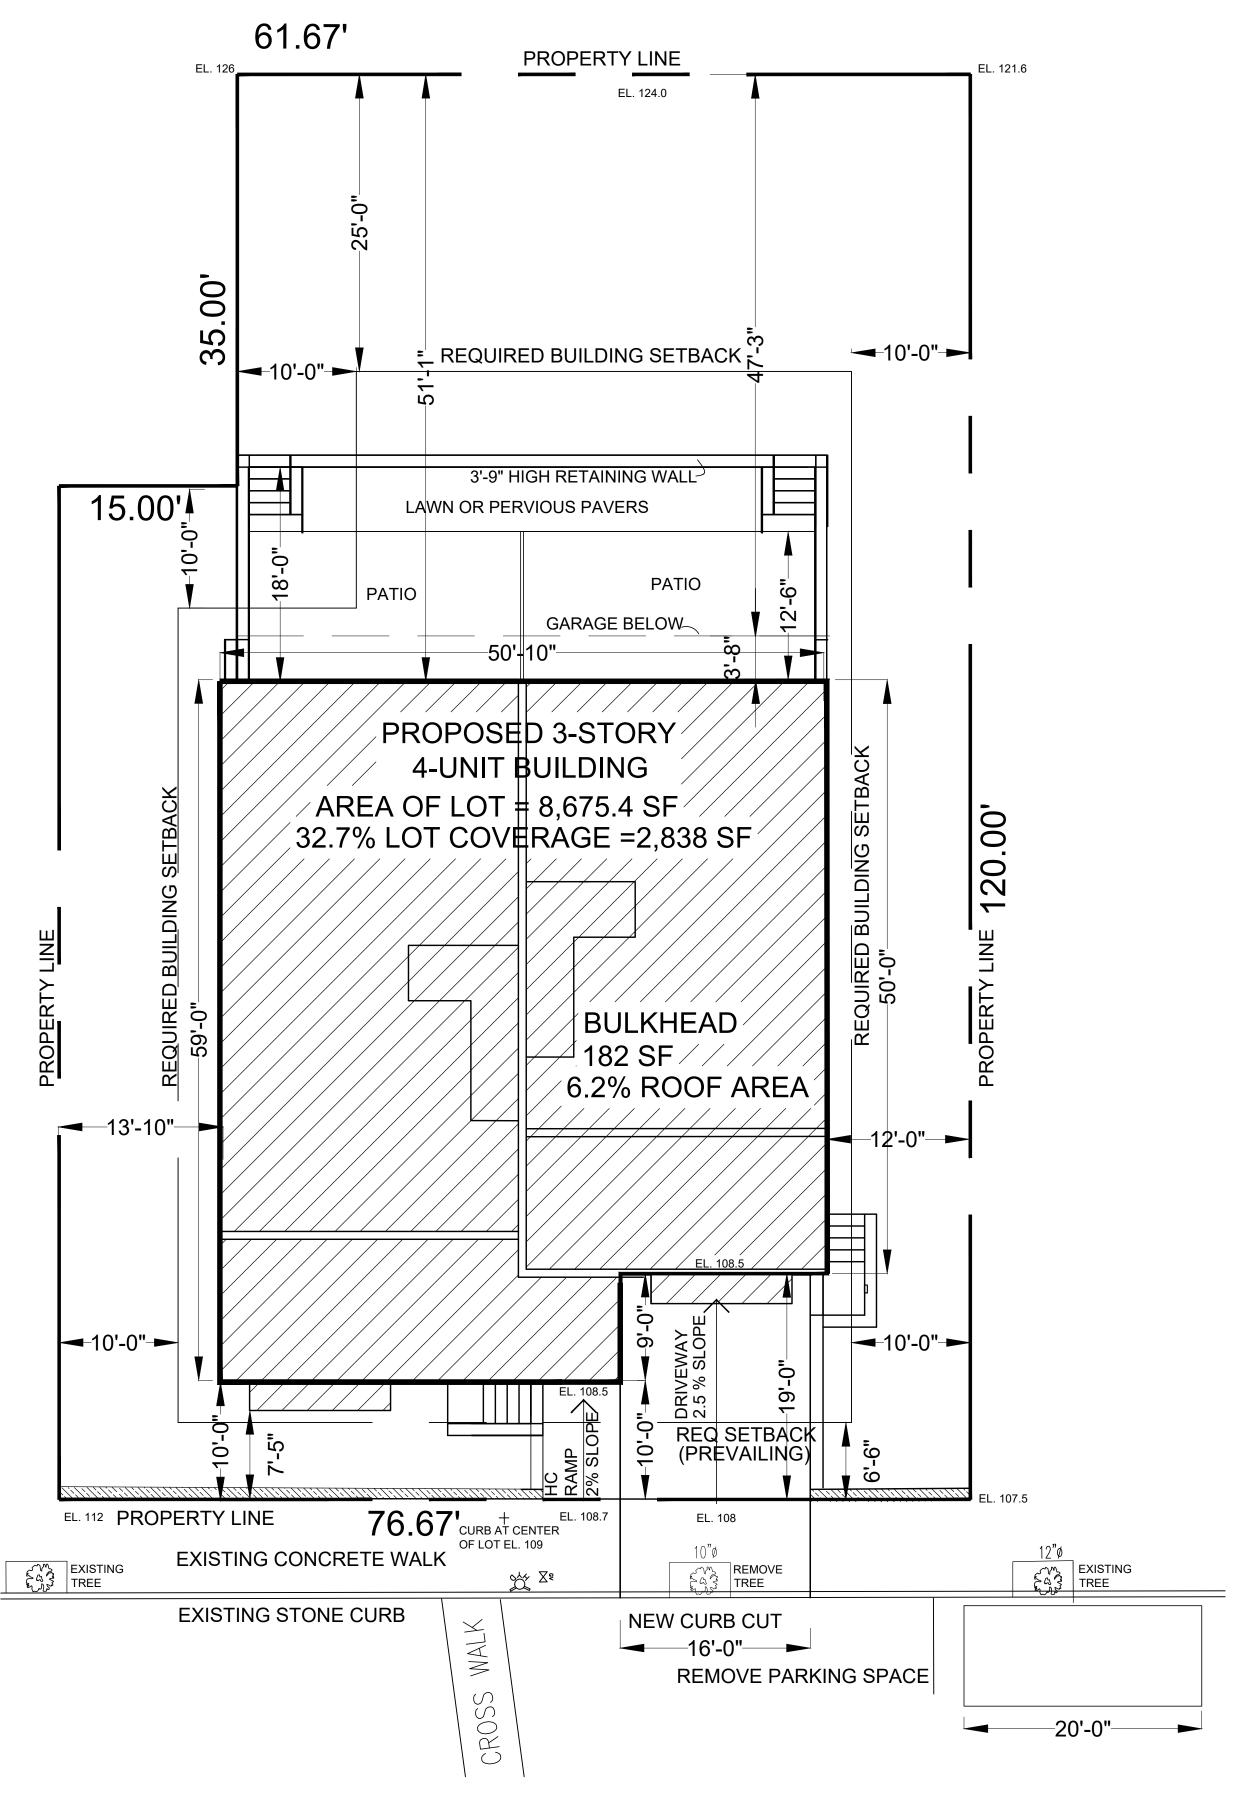
#### CHRISTINAGRIFFINARCHITECT

10 Spring Street, Hastings-on-Hudson, NY 10706



#### PLANNING BOARD SUBMISSION 10-28-21

OWNER	ARCHITECT	CIVIL ENGINEER	LIST of DRAWINGS	DATES	
156 PALISADE STREET, LLC 156 PALISADE STREET DOBBS FERRY, NY 10522 mlangjr@gmail.com	CGA STUDIO ARCHITECTS aka CHRISTINA GRIFFIN ARCHITECT P.C. CHRISTINA GRIFFIN AIA LEED AP CPHC, PRINCIPAL 12 SPRING STREET HASTINGS-ON-HUDSON, NY 10706 914.478.0799 cg@cgastudio.com	HUDSON ENGINEERING & CONSULTING, P.C. MICHAEL F. STEIN, P.E., PRESIDENT 45 KNOLLWOOD ROAD - SUITE 201 ELMSFORD, NEW YORK 10523 914.909.0420 michael@hudsonec.com	TITLE SHEET  S-1 SITE PLAN, TABLE OF ZONING DATA, CALCULATION of PREVAILING FRONT YARD SETBACK  S-2 STREETSCAPE, CONTEXT AREA SITE PLAN, AREA MAP  S-3 AERIAL VIEW of NEIGHBORHOOD  L-1 LANDSCAPING PLAN  E-1 EXTERIOR LIGHTING PLAN  A-2 FIRST & SECOND FLOOR PLANS	PLANNING BOARD SUBMISSION 10-2	-28-21  -28-21  -28-21  -28-21  -28-21  -28-21  -28-21  -28-21  -28-21  -38-21



#### PALISADE STREET



AREA OF FOOTPRINT: 2,838 SF TOTAL FLOOR AREA: 8,769 SF

	REQUIRED	EXISTING	PROPOSED	
	5,000 SF	8,675.4 SF	8,675.4 SF	
	N/A	2-FAMILY RESIDENTIAL	4-UNIT MULTI- FAMILY RESIDENTIAL	
MINIMUM RESIDENTIAL UNIT SIZE	800 SF PER UNIT	-	1,228- 2,400 SF PER UNIT	
MAXIMUM BUILDING COVERAGE	40% X .82 = 32.8% FOR LOTS 7,500-9,999 SF	16% (1,472 SF)	32.7% (2,838 SF)	
MAXIMUM IMPERVIOUS COVERAGE	60% X .82 = 49.2% FOR LOTS 7,500-9,999 SF	28% (2,445 SF)	45.4% (3,942 SF)	
MINIMUM LOT WIDTH FRONTAGE	50 FT	76.67 FT	76.67 FT	
MAXIMUM BUILDING HEIGHT	3 STORIES / 37 FT CENTERLINE OF CURB TO TOP OF FLAT ROOF	2 STORIES / 21 FT	3 STORIES / 40.33 FT * CENTERLINE OF CURB TO TOP OF FLAT ROOF	
FRONT YARD SETBACK	20 FT OR PREVAILING	6.5 FT (PREVAILING)	10 FT	
REAR YARD SETBACK	25 FT	76.25 FT	51.08 FT	
SIDE ONE	10 FT		12 FT	
SIDE TWO	10 FT	30.85 FT	13.83 FT	
TOTAL OF TWO SIDES	20 FT	38.95 FT	25.83 FT	
PARKING REQUIREMENT	PARKING CALCULATION:	(3) ON-STREET FOR	4 TOTAL OFF-STREET PARKING SPACES	
	1 SPACE PER DWELLING UNIT +	2 - FAMILY RESIDENTIAL	2 ON-STREET PARKING SPACES	
	1/4 PER BEDROOM			
			* REQUIRES VARIANCE/WAIVER	

CALCULATION OF PREVAILING FRONT YARD SETBACK				
ADDRESS	FRONT YARD SETBAACK			
83 CEDAR STREET	0 FT			
161 PALISADE STREET	0.5 FT			
154 PALISADE STREET	17.5 FT			
150 & 148 PALISADE STREET	16.5 FT & 4.5 FT			
144 PALISADE STREET	10 FT			
142 PALISADE STREET	1 FT			
138 PALISADE STREET	1 FT			
134 PALISADE STREET	7.5 FT			
TOTAL	58.5 / 9 = 6.5			



RESIDENTIAL BUILDING AT 156 PALISADE STREET


PLANNING BOARD SUBMISSION 8-20-21
REVISED DRAWINGS 9-13-21
REVISED DRAWINGS 9-24-21
REVISED DRAWING BOARD SUBMISSION 9-30-21
AHRB SUBMISSION 10-13-21
PLANNING BOARD SUBMISSION 10-28-21
PLANNING BOARD SUBMISSION 10-28-21
Www.christinagriffinarchitect.

S-1


#### 156 PALISADE STREET 150 PALISADE STREET 148 PALISADE STREET 164 PALISADE STREET 154 PALISADE STREET 142 PALISADE STREET 138 PALISADE STREET 134 PALISADE STREET 144 PALISADE STREET

#### STREETSCAPE

SCALE: NTS

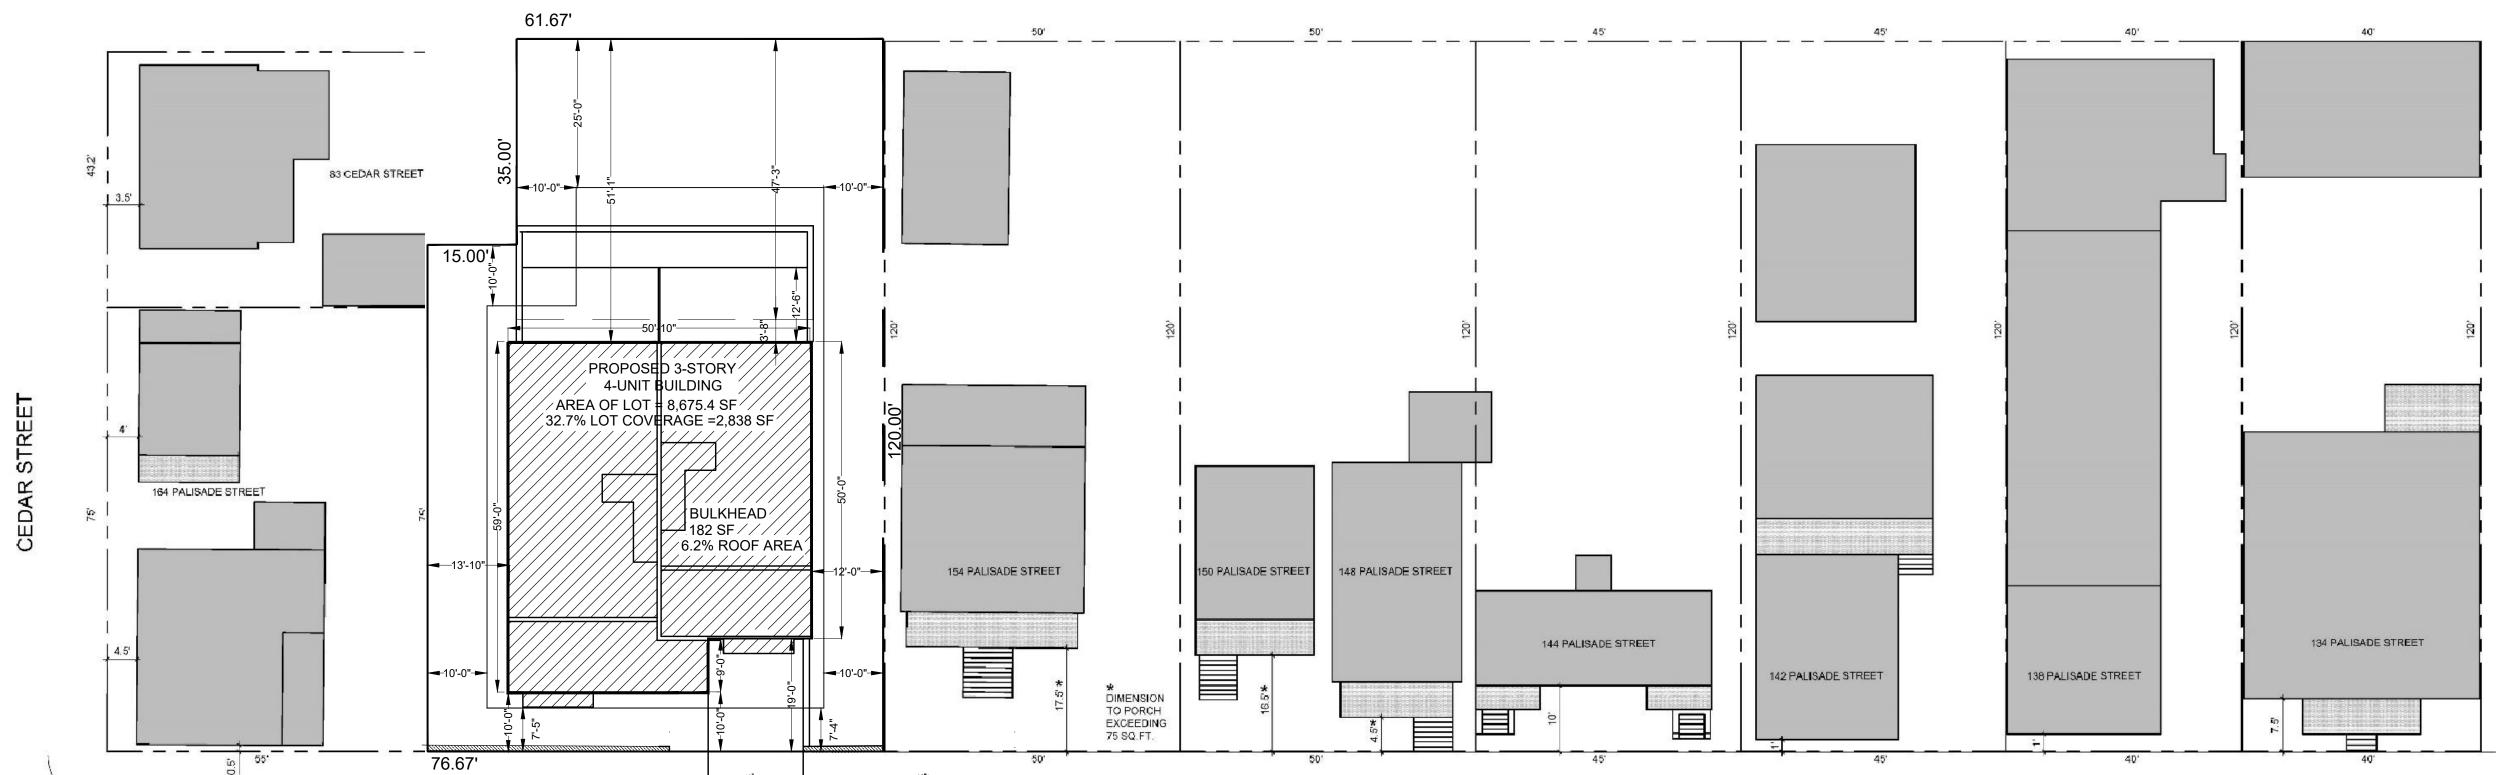



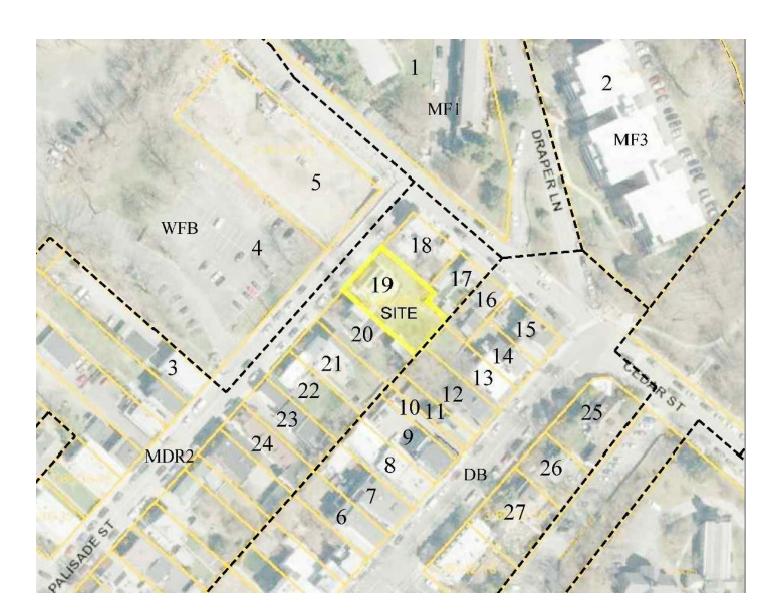



S-2

AREA MAP
SCALE: NTS





PROPOSED BUILDING at 156 PALISADE STREET


# AERIAL VIEW of NEIGHBORHOOD SHOWING PROPOSED BUILDING

SCALE: N.T.S.



SCALE: 1/8" = 1'-0"

#### LANDSCAPING LEGEND

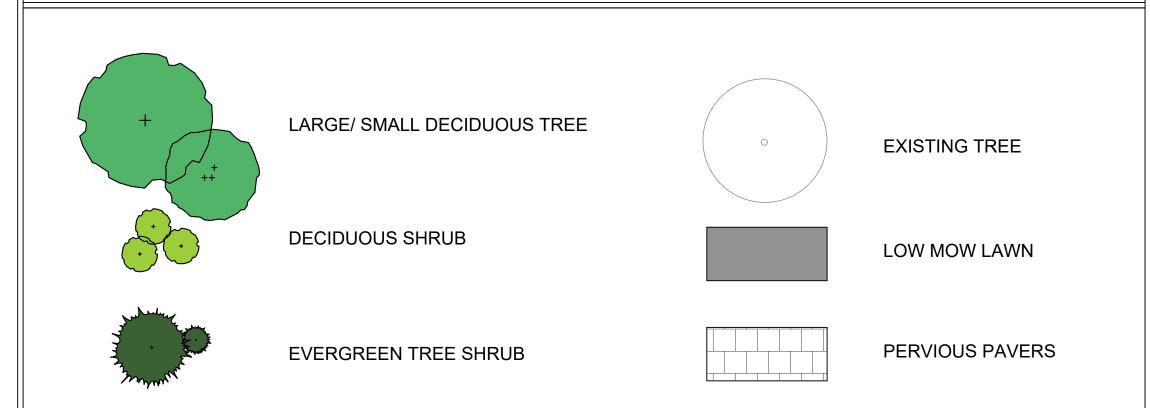

#### LANDSCAPING NOTES

- 1. THE LANDSCAPE CONTRACTOR SHALL COORDINATE THIS WORK WITH OTHER CONTRACTORS PERFORMING
- 2. THE CONTRACTOR SHALL LOCATE AND VERIFY ALL UNDERGROUND UTILITIES PRIOR TO ANY LAWN WORK OR TREE AND SHRUB PLANTING AND SHALL IMMEDIATELY REPORT ANY CONFLICTS TO THE PROJECT SITE ENGINEER.
- 3. THE CONTRACTOR SHALL SUPPLY ALL PLANT MATERIAL IN QUANTITIES SUFFICIENT TO COMPLETE THE PLANTING
- SHOWN ON THE DRAWING. QUANTITIES IN PLANT SCHEDULE ARE FOR REFERENCE ONLY.
  4. NO PLANT OR CULTIVAR SUBSTITUTIONS WILL BE ACCEPTABLE WITHOUT APPROVAL OF THE LANDSCAPE ARCHITECT.
- 5. OWNER'S LANDSCAPE ARCHITECT SHALL INSPECT PLANT MATERIAL FOR ACCEPTANCE PRIOR TO PLANTING. 6. LOCATION OF NEW PLANT MATERIAL SHALL BE STAKED OR SET OUT BY CONTRACTOR AND APPROVED BY OWNER'S
- LANDSCAPE ARCHITECT PRIOR TO PLANTING. 7. REFER TO PLANTING DETAILS AND SPECIFICATIONS FOR INFORMATION RELATING TO PLANTING PIT DIMENSIONS AND
- 8. THE CONTRACTOR SHALL REMOVE ALL PLASTIC MATERIAL FROM AROUND THE ROOT BALLS OF THE PLANTS AFTER POSITIONING IN THE PLANT PITS. REMOVE BURLAP. ROPE. AND WIRE FROM AROUND THE TRUNK SUFFICIENTLY SO THAT NO BURLAP, ROPE OR WIRE WILL BE EXPOSED AFTER BACKFILLING.
- 9. CONTRACTOR SHALL EXERCISE EXTREME CARE IN WORKING IN AREA OF EXISTING TREES. EXISTING TREES TO REMAIN
- 10. ALL AREAS THAT HAVE BEEN DISTURBED BY PLANTING ACTIVITY SHALL BE RESTORED TO A NEAT CONDITION. AREAS
- WITH BARE SOIL SHALL BE TOPSOILED AND SEEDED WITH NATIVE EROSION CONTROL SEED MIX.
- NEEDED DURING THE FIRST GROWING SEASON.

  12. ALL NEW PLANTING SHOWN WITHIN OR NEAR THE DRIPLINE OF THE 32" SUGAR MAPLE SHALL BE LOCATED IN THE FIELD BY OWNER'S LANDSCAPE ARCHITECT OR ARBORIST AND INSTALLED UNDER THE DIRECT SUPERVISION OF OWNER'S LANDSCAPE ARCHITECT OR ARBORIST TO ENSURE PROTECTION OF EXISTING TREE ROOTS.

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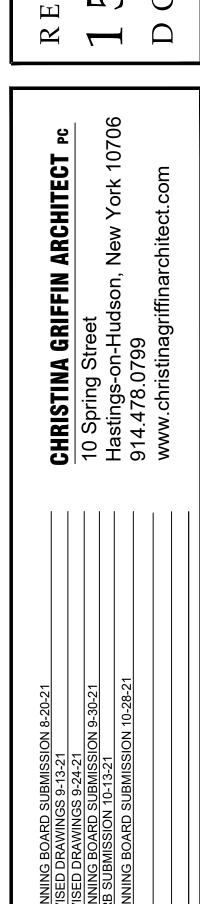








E-1





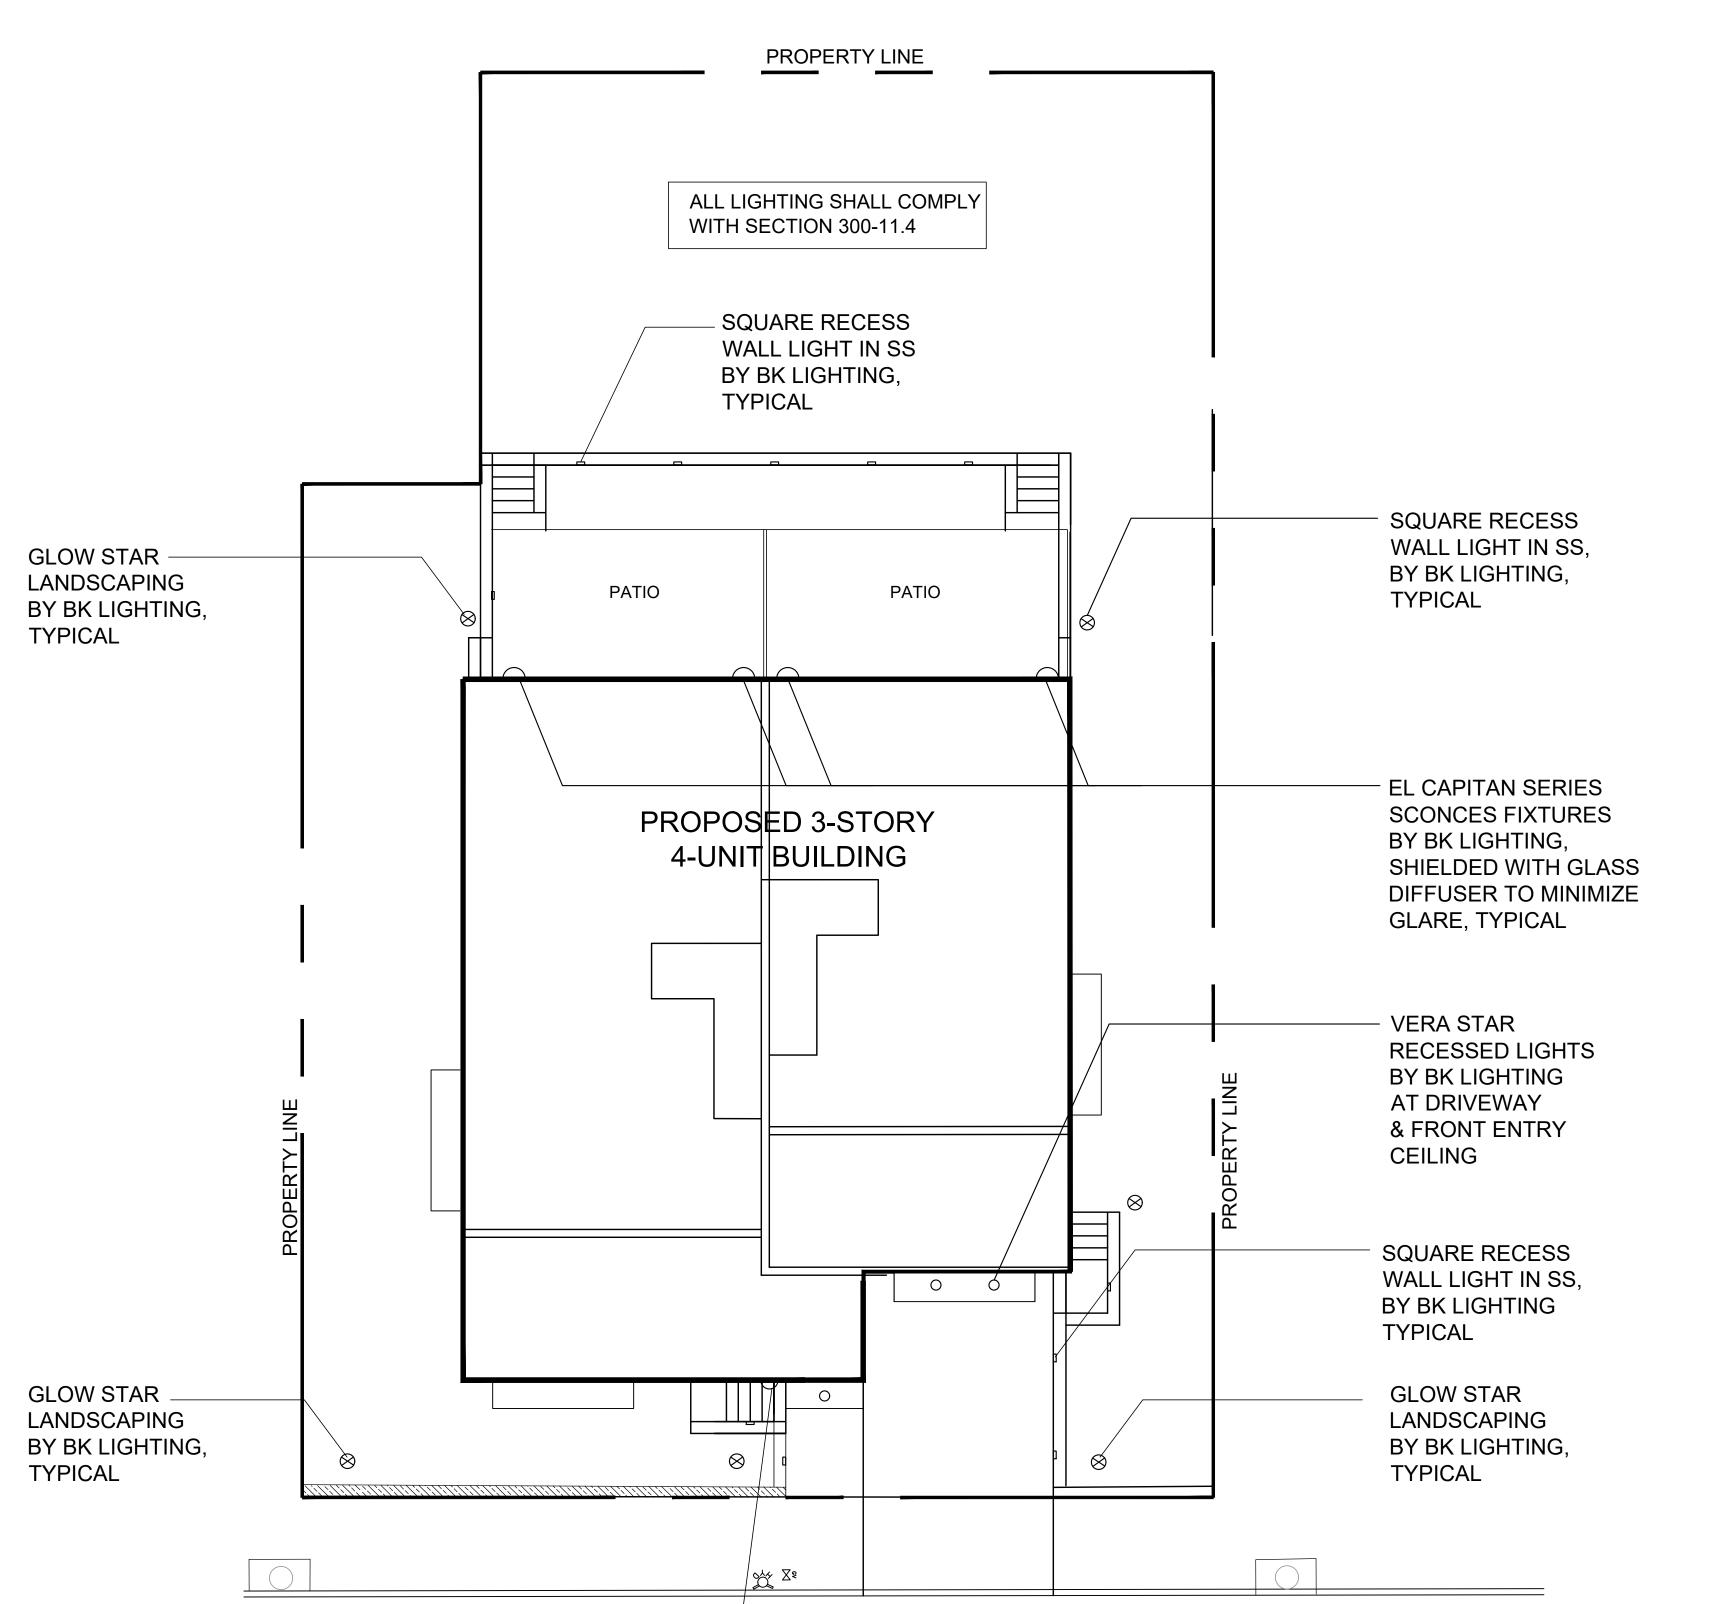

PALISADE STREET

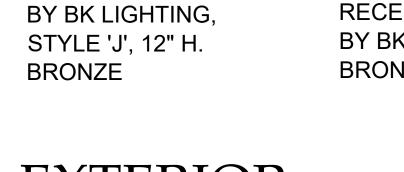

#### **EXTERIOR** LIGHT FIXTURES

PHOENIX DAY

18" H x 9" W x 7 1<sub>2" D</sub>

<sup>4</sup> 12" X 14" BACKPLATE

DARK ANTIQUE FINISH

OUTDOOR SCONCE, #3110E

SCALE: N.T.S.

**EL CAPITAN** 

**BRONZE** 

SERIES SCONCE

BY BK LIGHTING,



PHOENIX DAY SCONCE

SHIELDED WITH METAL DIFFUSER

TO MINIMIZE GLARE, TYPICAL


BY BK LIGHTING,



RECESSED LIGHT

BY BK LIGHTING,


**BRONZE** 

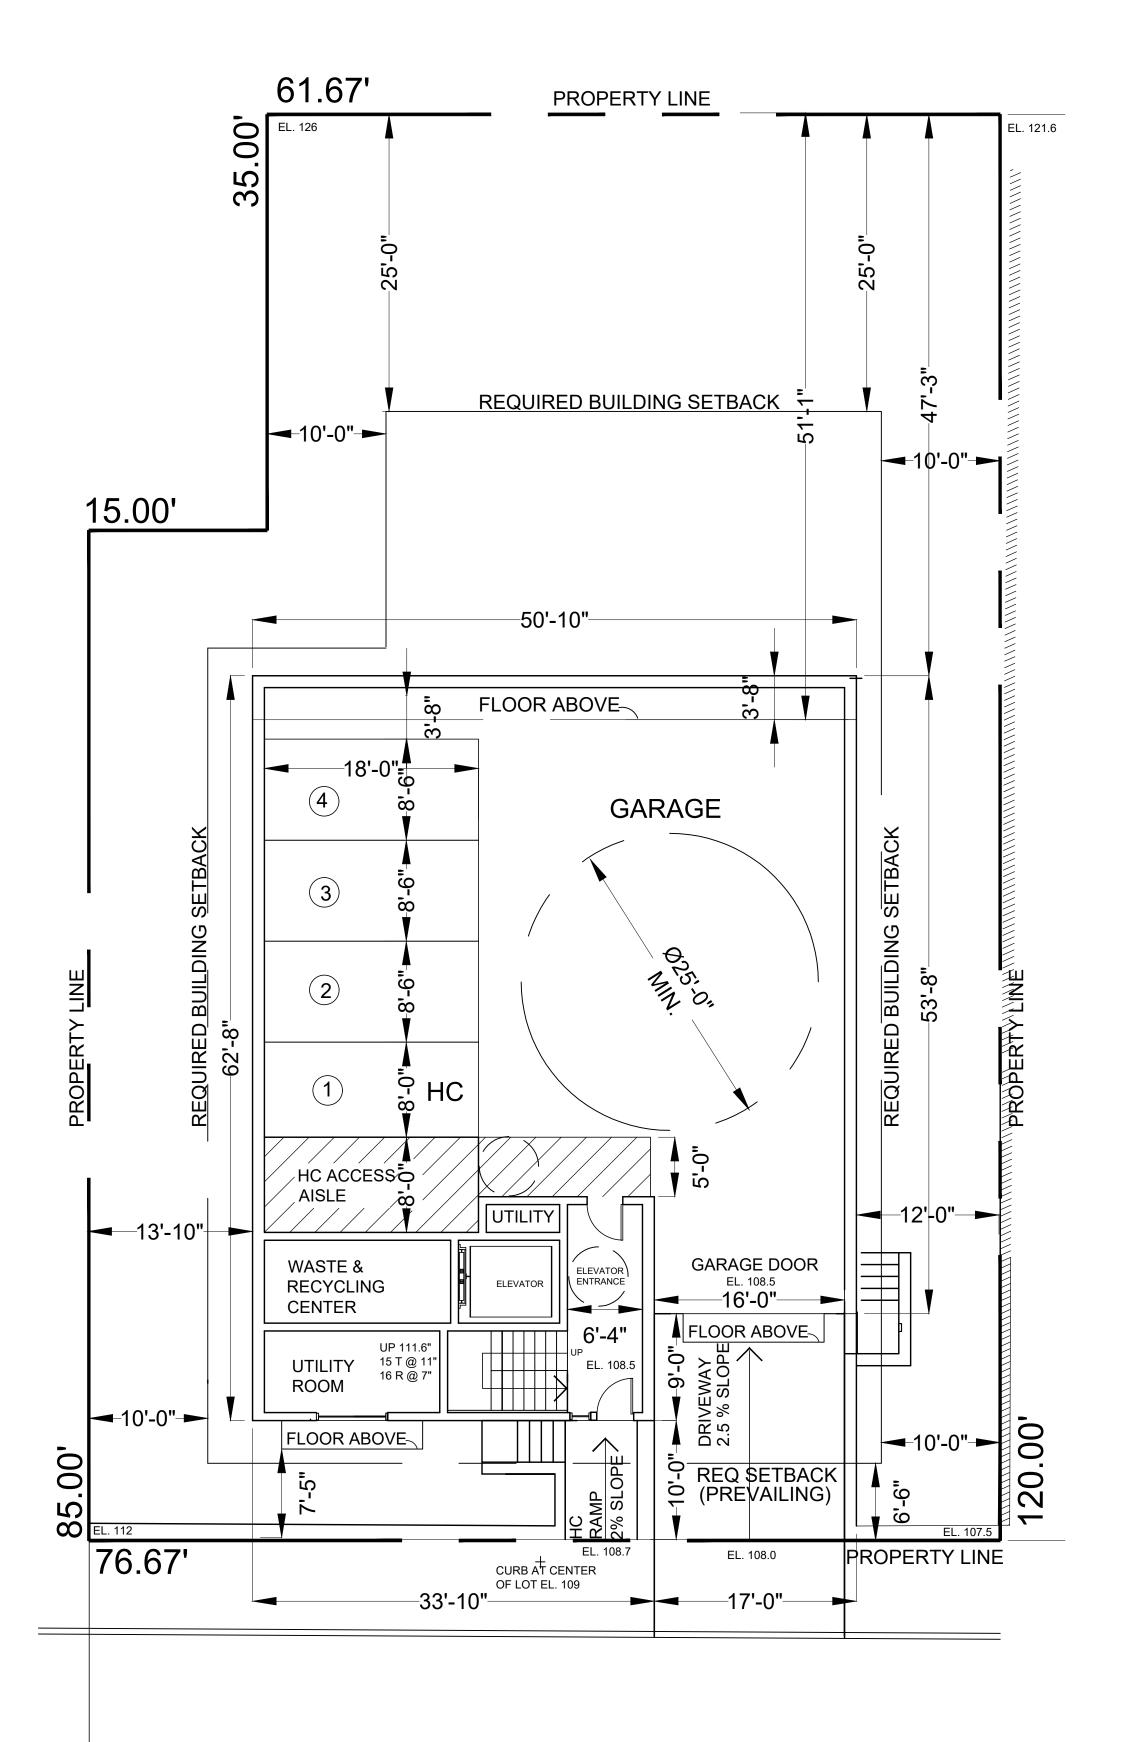

FLOOR AREA OF FINISHED SPACE: 851 SF

#### GARAGE FLOOR PLAN

SCALE: 1/8" = 1'-0"

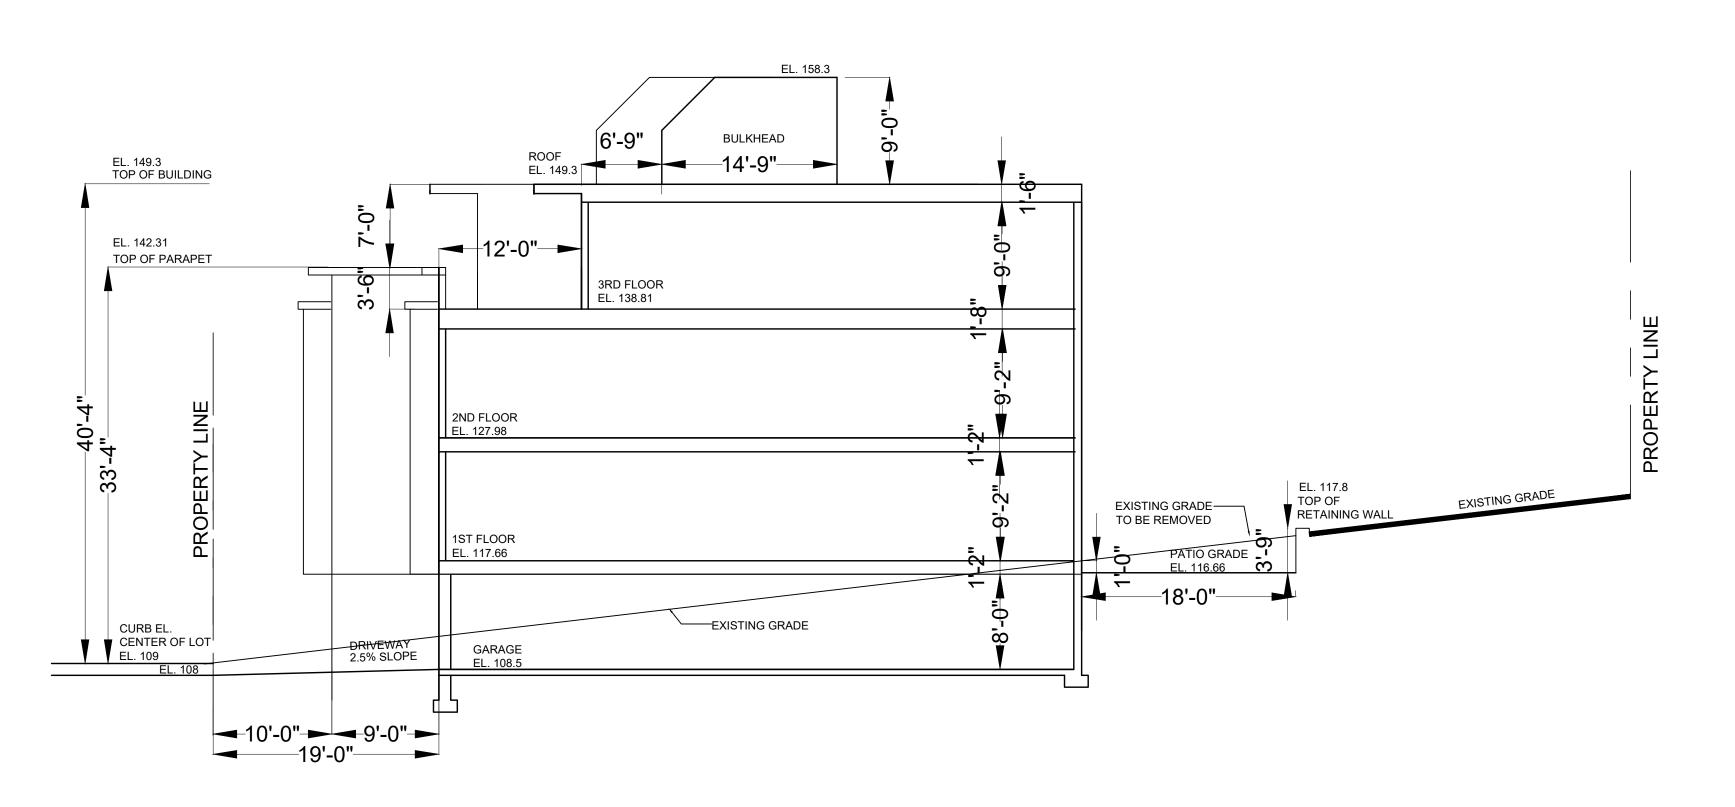

#### BUILDING SECTION

SCALE: 1/8" = 1'-0"



CHRICARAGE PLAN

GARAGE PLAN

REVISED DRAWINGS 9-13-21

SECTION

REVISED DRAWINGS 9-24-21

REVISED DRAWINGS 9-24-21

PLANNING BOARD SUBMISSION 10-28-21

Scale:

AS SHOWN


BLANNING BOARD SUBMISSION 10-28-21

Scale:

ANWW.

#### FLOOR AREA: 2,897 SF FIRST FLOOR PLAN

SCALE: 1/8" = 1'-0"

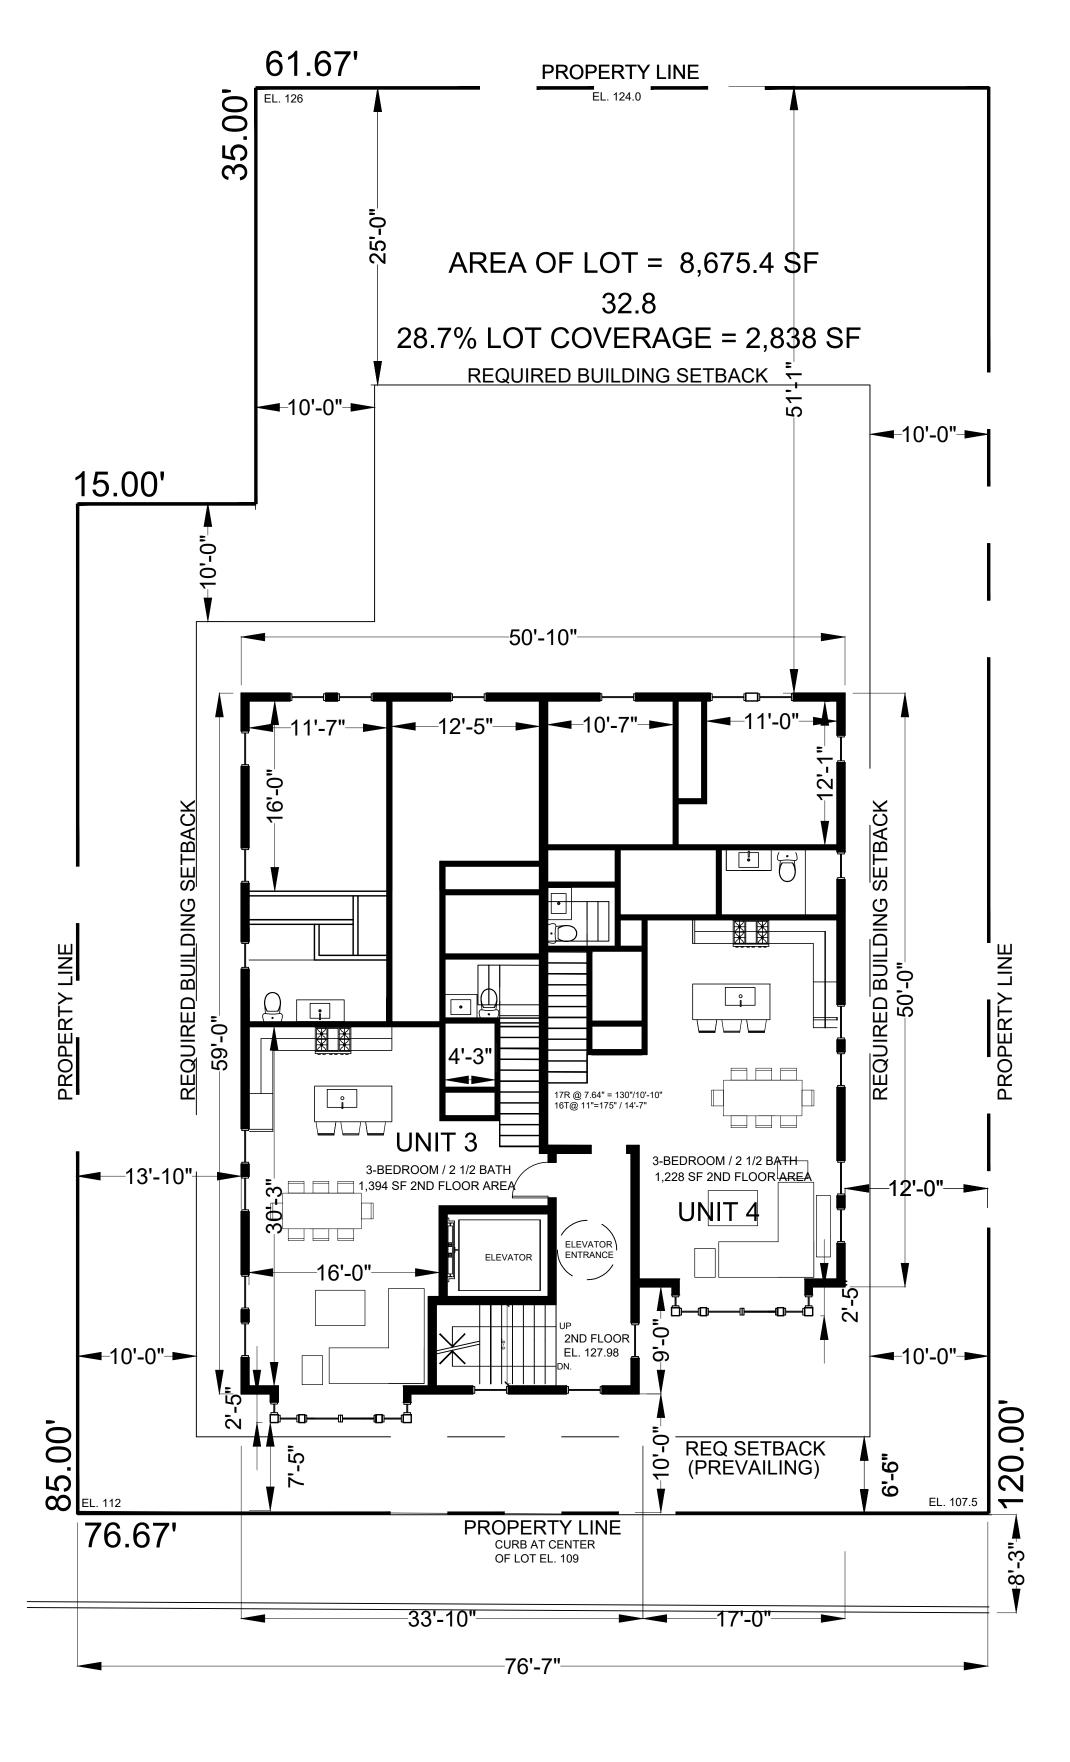

FLOOR AREA: 2,897 SF

#### SECOND FLOOR PLAN

SCALE: 1/8" = 1'-0"



ARCHITECT PG RESIDENTIAL BUILDING AT New York 10706 156 PALISADE STREET

Date

1ST FLOOR PLAN

REVISED DRAWINGS 9-13-21
SECOND FLOOR PLAN

REVISED DRAWINGS 9-24-21
PLANNING BOARD SUBMISSION 10-28-21
Scale:


ARS SHOWN

BY FLOOR PLAN

REVISED DRAWINGS 9-13-21
PLANNING BOARD SUBMISSION 10-28-21
Scale:

ARS SHOWN


CHRISTINA (CHRISTINA (CHRISTINA) (CHRISTINA

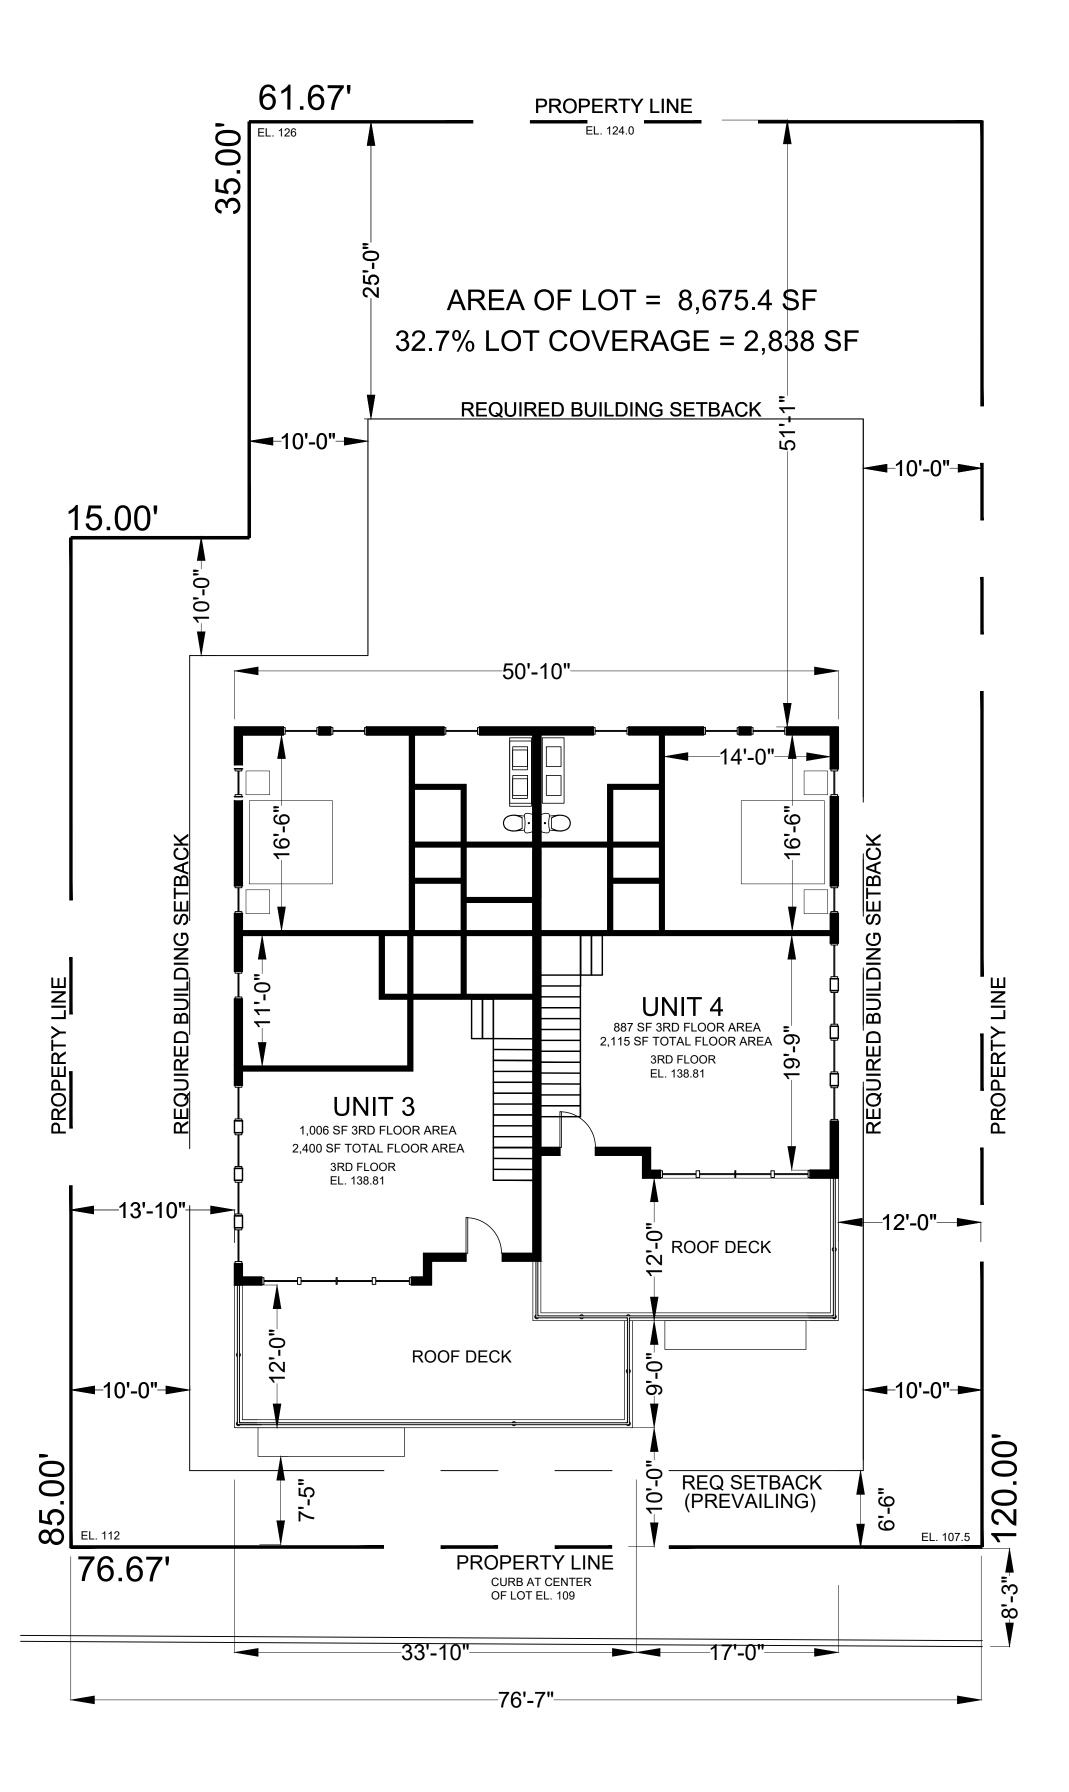

FLOOR AREA: 2,124 SF

#### THIRD FLOOR PLAN

SCALE: 1/8" = 1'-0"

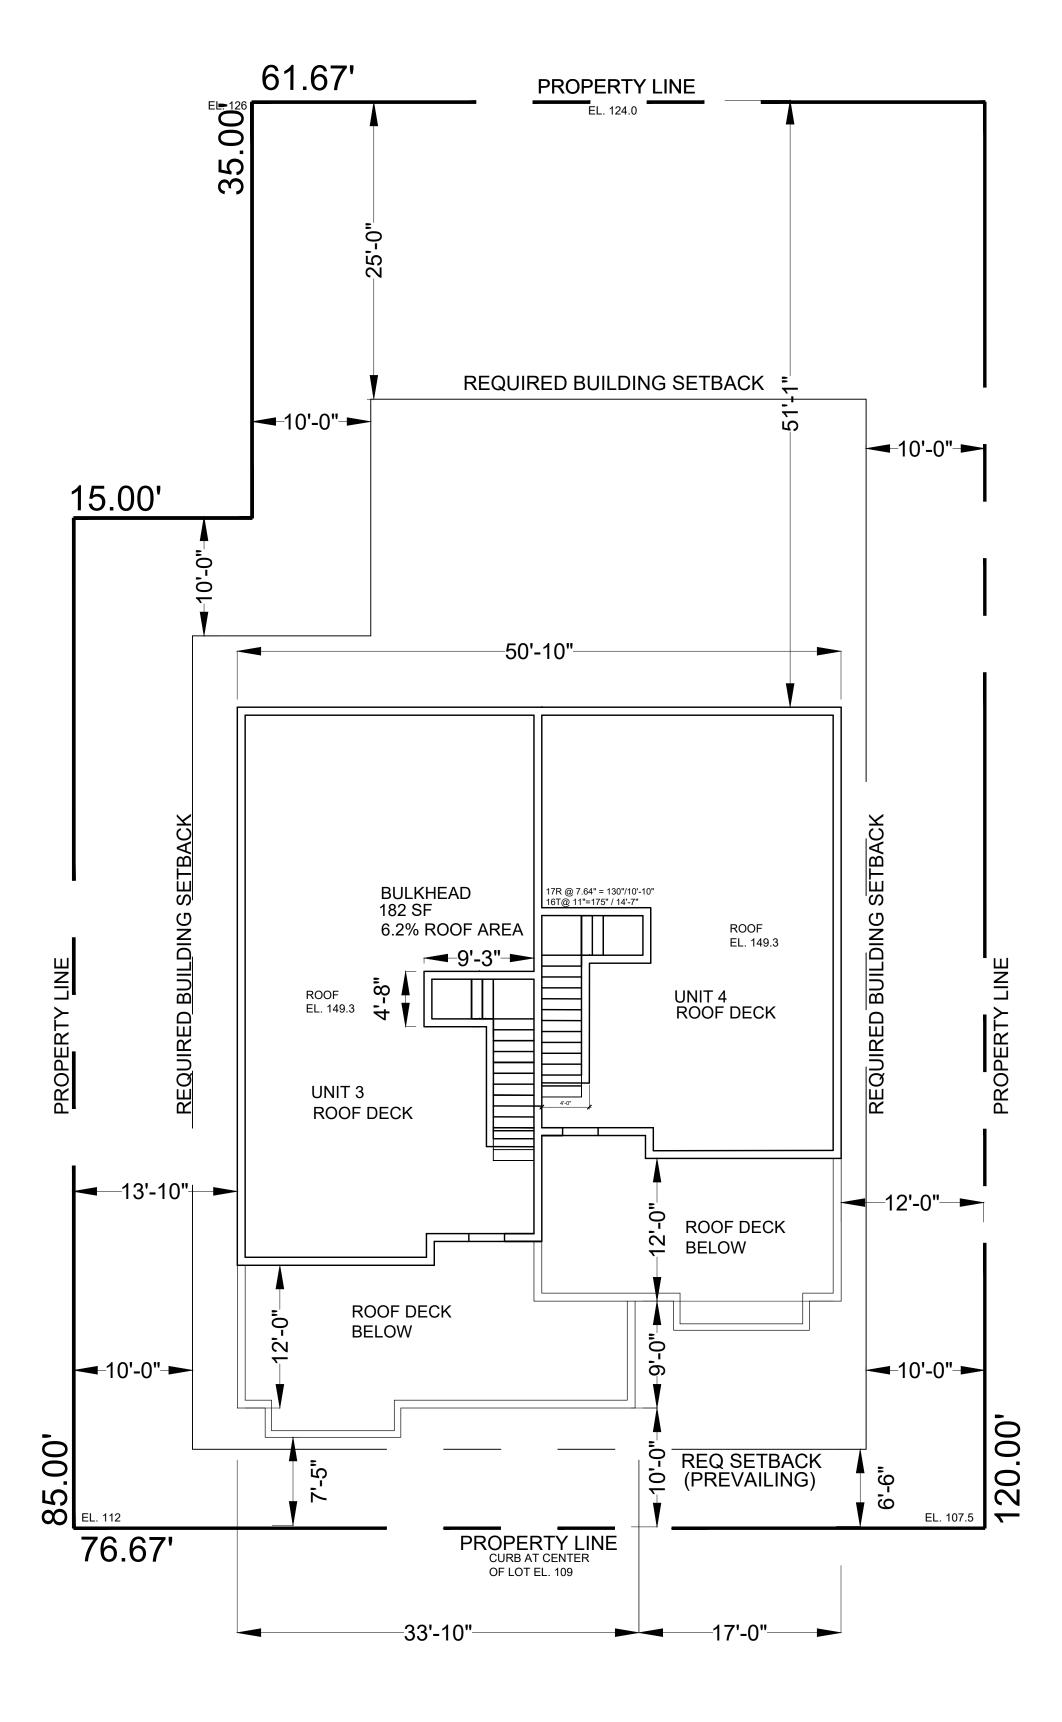


#### ROOF PLAN

SCALE: 1/8" = 1'-0"




CHRISTINA GRIFFIN ARCHITECT PC
REVISED DRAWINGS 9-13-21
RESTIDE
TO Spring Street
Hastings-on-Hudson, New York 10706
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DOBB

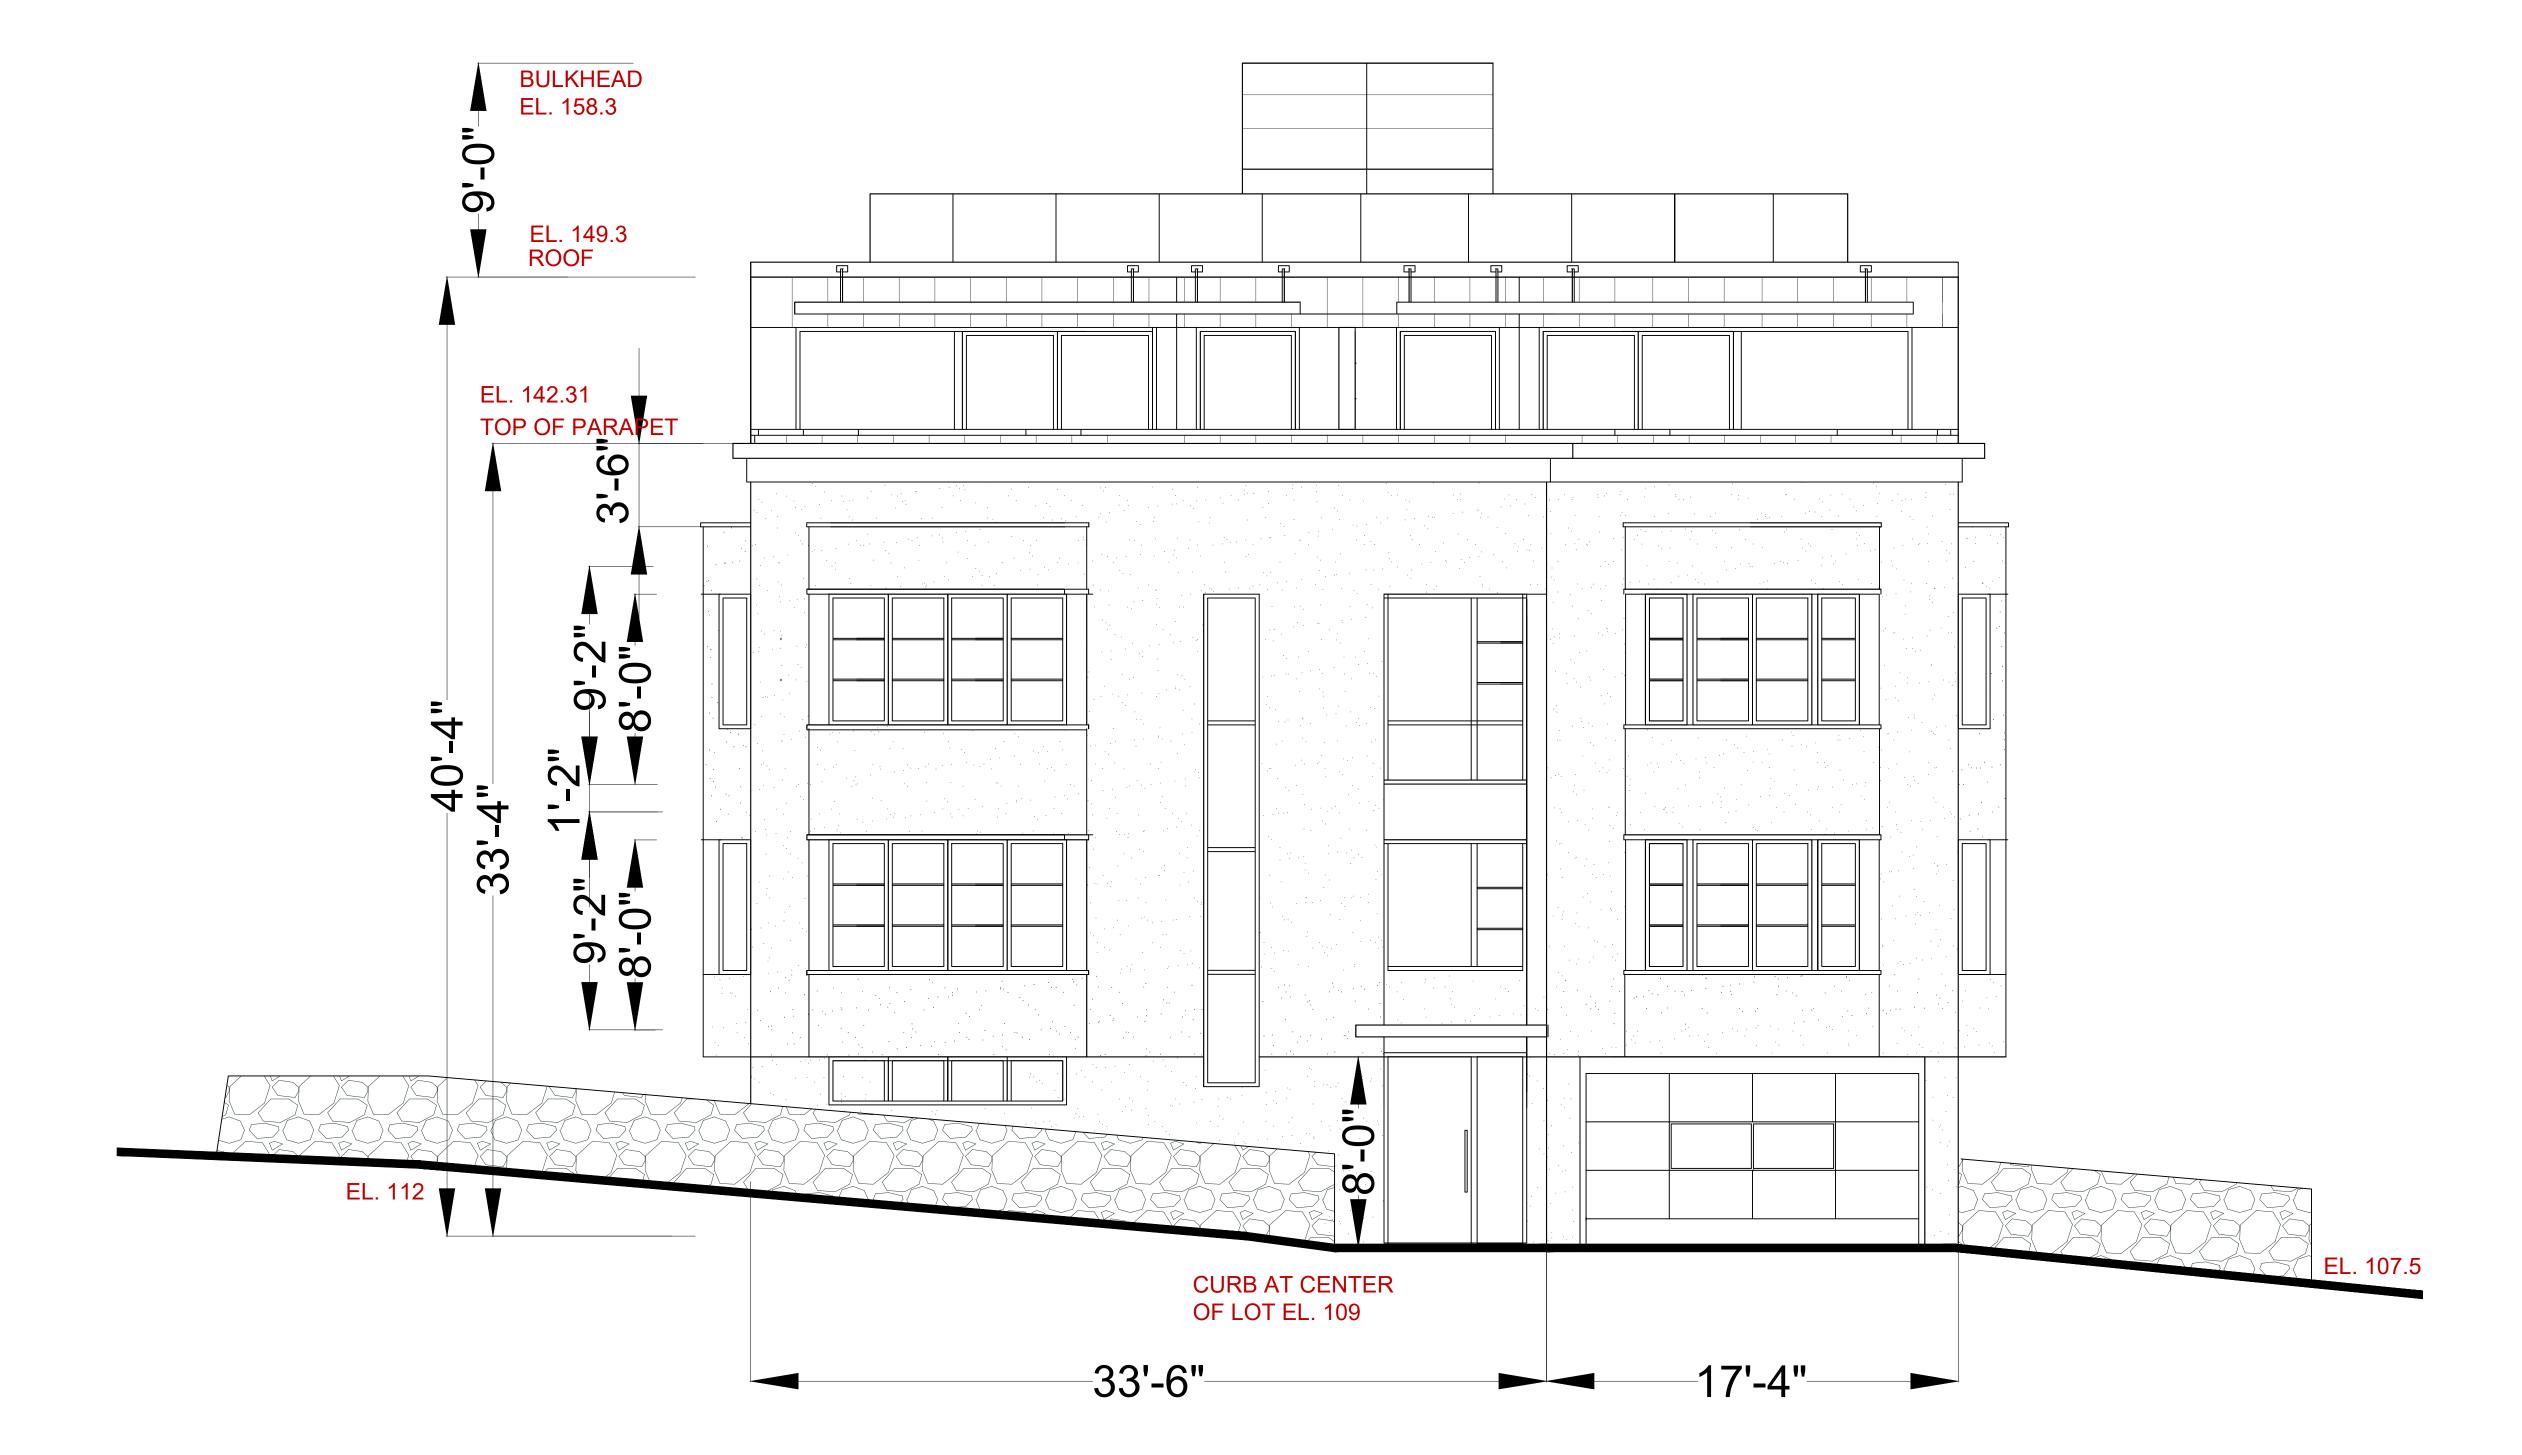

#### WEST ELEVATION

SCALE: 1/4" = 1'-0"



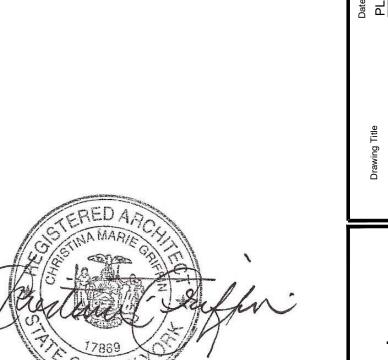

SOUTH ELEVATION

SCALE: 1/4" = 1'-0"



### EAST ELEVATION


SCALE: 1/4" = 1'-0"



Drawing Title
EAST ELEVAT





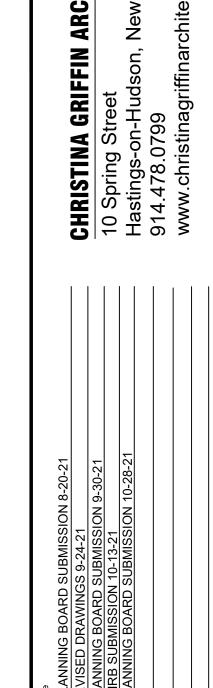



#### NORTH ELEVATION

BULKHEAD

SCALE: 1/4" = 1'-0"

BULKHEAD EL. 158.3

3RD FLOOR EL. 138.81

2ND FLOOR EL. 127.98

1ST FLOOR EL. 117.66

**18'-0"** 

**4**..0-.8

9'-0"

1-8-

1'-2"

2

EXISTING GRADE TO BE REMOVED

PATIO GRADE

EL. 116.66

3'-6"



TOP OF BUILDING

TOP OF PARAPET

EL. 142.31

LINE


<u>-</u>

EL. 149.3

4"-40'-

33'-



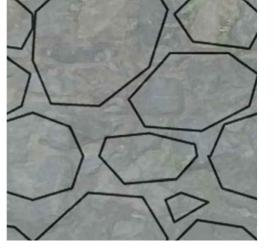

**EXISTING** 

STONE

WALL







GRAY **METAL** SIDING



GRAY BRICK SMOOTH



CORNICE BENJAMIN MOORE BENJAMIN MOORE NIGHTTRAIN #1567



METAL OVERHANG at ENTRY



MARVIN WINDOWS WITH **EBONY** CLAD



METAL RAILING at THIRD FLOOR



GARAGE & FRONT DOORS



CEDAR TRELLIS

#### COLOR SCHEME of WEST & SOUTH ELEVATIONS

SCALE: N.T.S.