MARFIONE-BASU RESIDENCE 253 JUDSON AVENUE, DOBBS FERRY, NY 10522

C H R I S T I N A G R I F F I N A R C H I T E C T

12 Spring Street, Hastings-on-Hudson, NY 10706



GENERAL NOTES

- 1. These documents remain the exclusive property of the Architect, and may not be used for any purpose whatsoever without written consent of the Architect.
- 2. All construction shall comply fully with the 2020 Residential code of NYS, local building code, fire department regulations, and all other agencies having jurisdiction over project.
- 3. Approved stamped set of building plans must be present 14. All construction sites shall conform to the 2020 New on site for all inspections.
- 4. A current Westchester County licensed and insured contractor must be on file with current building permit until Certificate of Occupancy is issued. If contractor of record has been removed from the project, a stop work order will be issued untill a new Westchester County licensed and insured contractor is retained.
- 5. General Contractor shall carry property damage insurance, public liability insurance, workman's compensation, auto insurance, and general liability as required by Federal, State, and Local Codes and as Owner requires.
- 6. Licensed electrician to file separate electrical permit.
- 7. Licensed plumber to file separate plumbing permit. 8. All health, safety, fire, zoning and environmental
- regulations shall be adhered to at all times by the Owner and/or occupant. 9. The contractor shall become familiar with conditions of
- the site, and the work as shown on the construction documents, prior to submitting a bid for construction. 10. Contractors shall coordinate all work procedures and
- working hours with local authorities, neighborhood associations, and any other governing authorities. 11. The contractor shall be responsible for providing all labor
- and materials to complete the project, in accordance with the construction documents, tested and ready for owner's use.
- 12. All indicated Survey material is for general reference only. The Architect assumes no responsibility for the

accuracy or the correctness of any of the indicated material.

- 13. Contractors shall be responsible for protection of all existing and new conditions and materials with and adjacent to the construction area. Any damage caused by the execution of the work indicated or implied herein shall be repaired or replaced to the Owner's satisfaction.
- York State Property Maintenance Code. All rubbish garbage and construction debris shall be disposed of in an onsite dumpster or removed off site immediately. Materials shall be stacked in orderly fashion as to not create a blight on the community. The village right of way must be kept clear and maintained at all times.
- 15. General contractor shall be responsible for the removal 23. The drawings and notes are intended to be complete. of construction debris, rubbish and offsite disposal in a responsible manner.
- permits, and pay all necessary permit fees required by the local building department and all other agencies having jurisdiction over the project, such as plumbing, electrical & HVAC, except for the building permit, which shall be obtained by the Architect. The contractor shall obtain the certificate of occupancy for the project when construction is complete.
- 17. Contractor shall keep work site free from debris and accumulated refuse, and shall have sole responsibility for protecting all dangerous areas from entry by unauthorized parties.
- 18. Drawings may be rough scaled for estimating and general purposes, but are not to be scaled for construction locations, dimensions, or any other purposes. Dimensions shown shall govern over measurements scaled from plans. Wall dimensions are given to finished surfaces. Contractor to consult with the Architect for questions regarding final dimensions and locations.
- 19. All dimensions and conditions shown and assumed on the drawings must be verified at the site by contractor

- before ordering any material or doing any work. the co interio 20.Contractor is to design and install adequate and code broom approved shoring and bracing where needed to safely complete structural work. Contractor to assume full and 28. The contractor to assume full and sole responsibility for structural adequacy of the shoring that n and for any injuries, damages, cracks, or defects caused come t by shoring or bracing, and shall repair all such damage receiv at his sole expense. or as I
- 21. The Architect is not responsible for workmanship, 29.New construction methods, or any omissions or derivations from the drawings during construction.
- 22.Materials and products indicated on drawings shall be installed in accordance with manufacturer's requirements.
- Should anything be omitted from the drawings necessary to the proper construction of the work herein described, it 31.If blow 16. The contractor shall obtain all inspections, approvals and shall be the duty of the contractor to notify the Architect. The builder shall visit the site and inform the Architect of thickn any discrepancies of field conditions that may interfere with the total completion of all work included within the contract and verify all conditions prior to the ordering of materials and the start of construction.
 - 24.Minor details not usually shown or specified, but necessary for proper and acceptable construction, installation or operation of any part of the work shall be 32. All wo included in the work the same as specified or indicated.
 - 25. The contractor shall supervise and direct the work using his best skill and attention, he shall be solely responsible for all construction means, methods, sequences and procedures and for coordination of all portions of the work.
 - 26. The use of the words "provide" or "provided" in connection with any item specified is intended to mean that such item be furnished and installed and connected where required.
 - 27.Contractor shall maintain a sealed enclosure between work area and other areas of the residence. In addition,

		INSU REC	
VD SPEED (MPH)	U-FA 0. MASS R-V/ 8/1. re minimums kness of the ration U-fact eans R-10 co wall. "15/19" he basemen R-5 continuou ion shall be in alue is cavity plus R-5 continuou shall be in a of the mass DESIC WIND E UND E	TRATION CTOR ^b .32 WALL ALUE ¹ 3(g) s. U-factors insulation, tor column ontinuous in insulation provided un the table. The sufficient f insulation, tinuous ins accordance s wall. CODE GN RI CODE GN RI CODE GN RI	s a transition of the second s



JLATION AND FENESTRATION QUIREMENT BY COMPONENT

SKYLIGHT _b U-FACTOR	GLAZED FENESTRATION SHGC ^{b,e}	CEILING R-VALUE	WOOD FRAME WALL R-VALUE
0.55	0.40	49	20 or 13+5 °
FLOOR R-VALUE	BASEMENT [©] WALL R-VALUE	SLAB ^d R-VALUE & DEPTH	CRAWL SPACE WALL R-VALUE
19	10/13(c)	10, 2FT(d)	10/13(c)

and SHGC are maximums. Where insulation is installed in a cavity that is less than the label or the installed R-value of the insulation shall be not less than the R-value specified in the table. xcludes skylights. The SHGC column applies to all glazed fenestration.

sulation on the interior or exterior of the home or R-13 cavity insulation on the interior of the continuous insulation on the interior or exterior of the home or R-19 cavity insulation at the natively, compliance with "15/19" shall be R-13 cavity insulation on the interior of the basement n on the interior or exterior of the home. Ider the full slab area of a heated slab in addition to the required slab edge insulation R-value for e slab edge insulation for heated slabs shall not be required to extend below the slab.

o fill the framing cavity and providing not less than an R-value of R-19. the second value is continuous insulation. Therefore, as an example, "13+5" means R-13 cavity

with Section R402.2.5. The second R-value applies where more than half of the insulation is on

EQUIREMENTS for the 2020 RESIDENTIAL OF NEW YORK STATE CLIMATIC & EOGRAPHIC DESIGN CRITERIA


		SUBJECT TO DAMAGE FROM						
WIND BORNE DEBRIS ZONE	SEISMIC DESIGN CATAGORY	WEATHERING	FROST LINE DEPTH	TERMITE	ICE SHIELD UNDERLAY REQUIRED	AY FLOOD	AIR FREEZING INDEX	MEAN ANNUAL TEMP.
NO	В	SEVERE	42"	MODERATE TO HEAVY	YES	N/A	2000	51.6

DATES

PLANNING BOARD SUBMISSION 10-28-21

LIST of DRAWINGS

TLE IEET	GENERAL NOTES, CLIMATIC & GEOGRAPHIC CRITERIA, DATES, LIST OF DRAWINGS
1	SITE PLAN, ZONING COMPLIANCE, COVERAGE CALCULATIONS, LOCATION MAP
2	STREETVIEW, CONTEXT AREA SITE PLAN
1	FIRST FLOOR PLAN
2	SECOND FLOOR PLAN
3	EXTERIOR ELEVATIONS
4	EXTERIOR ELEVATIONS

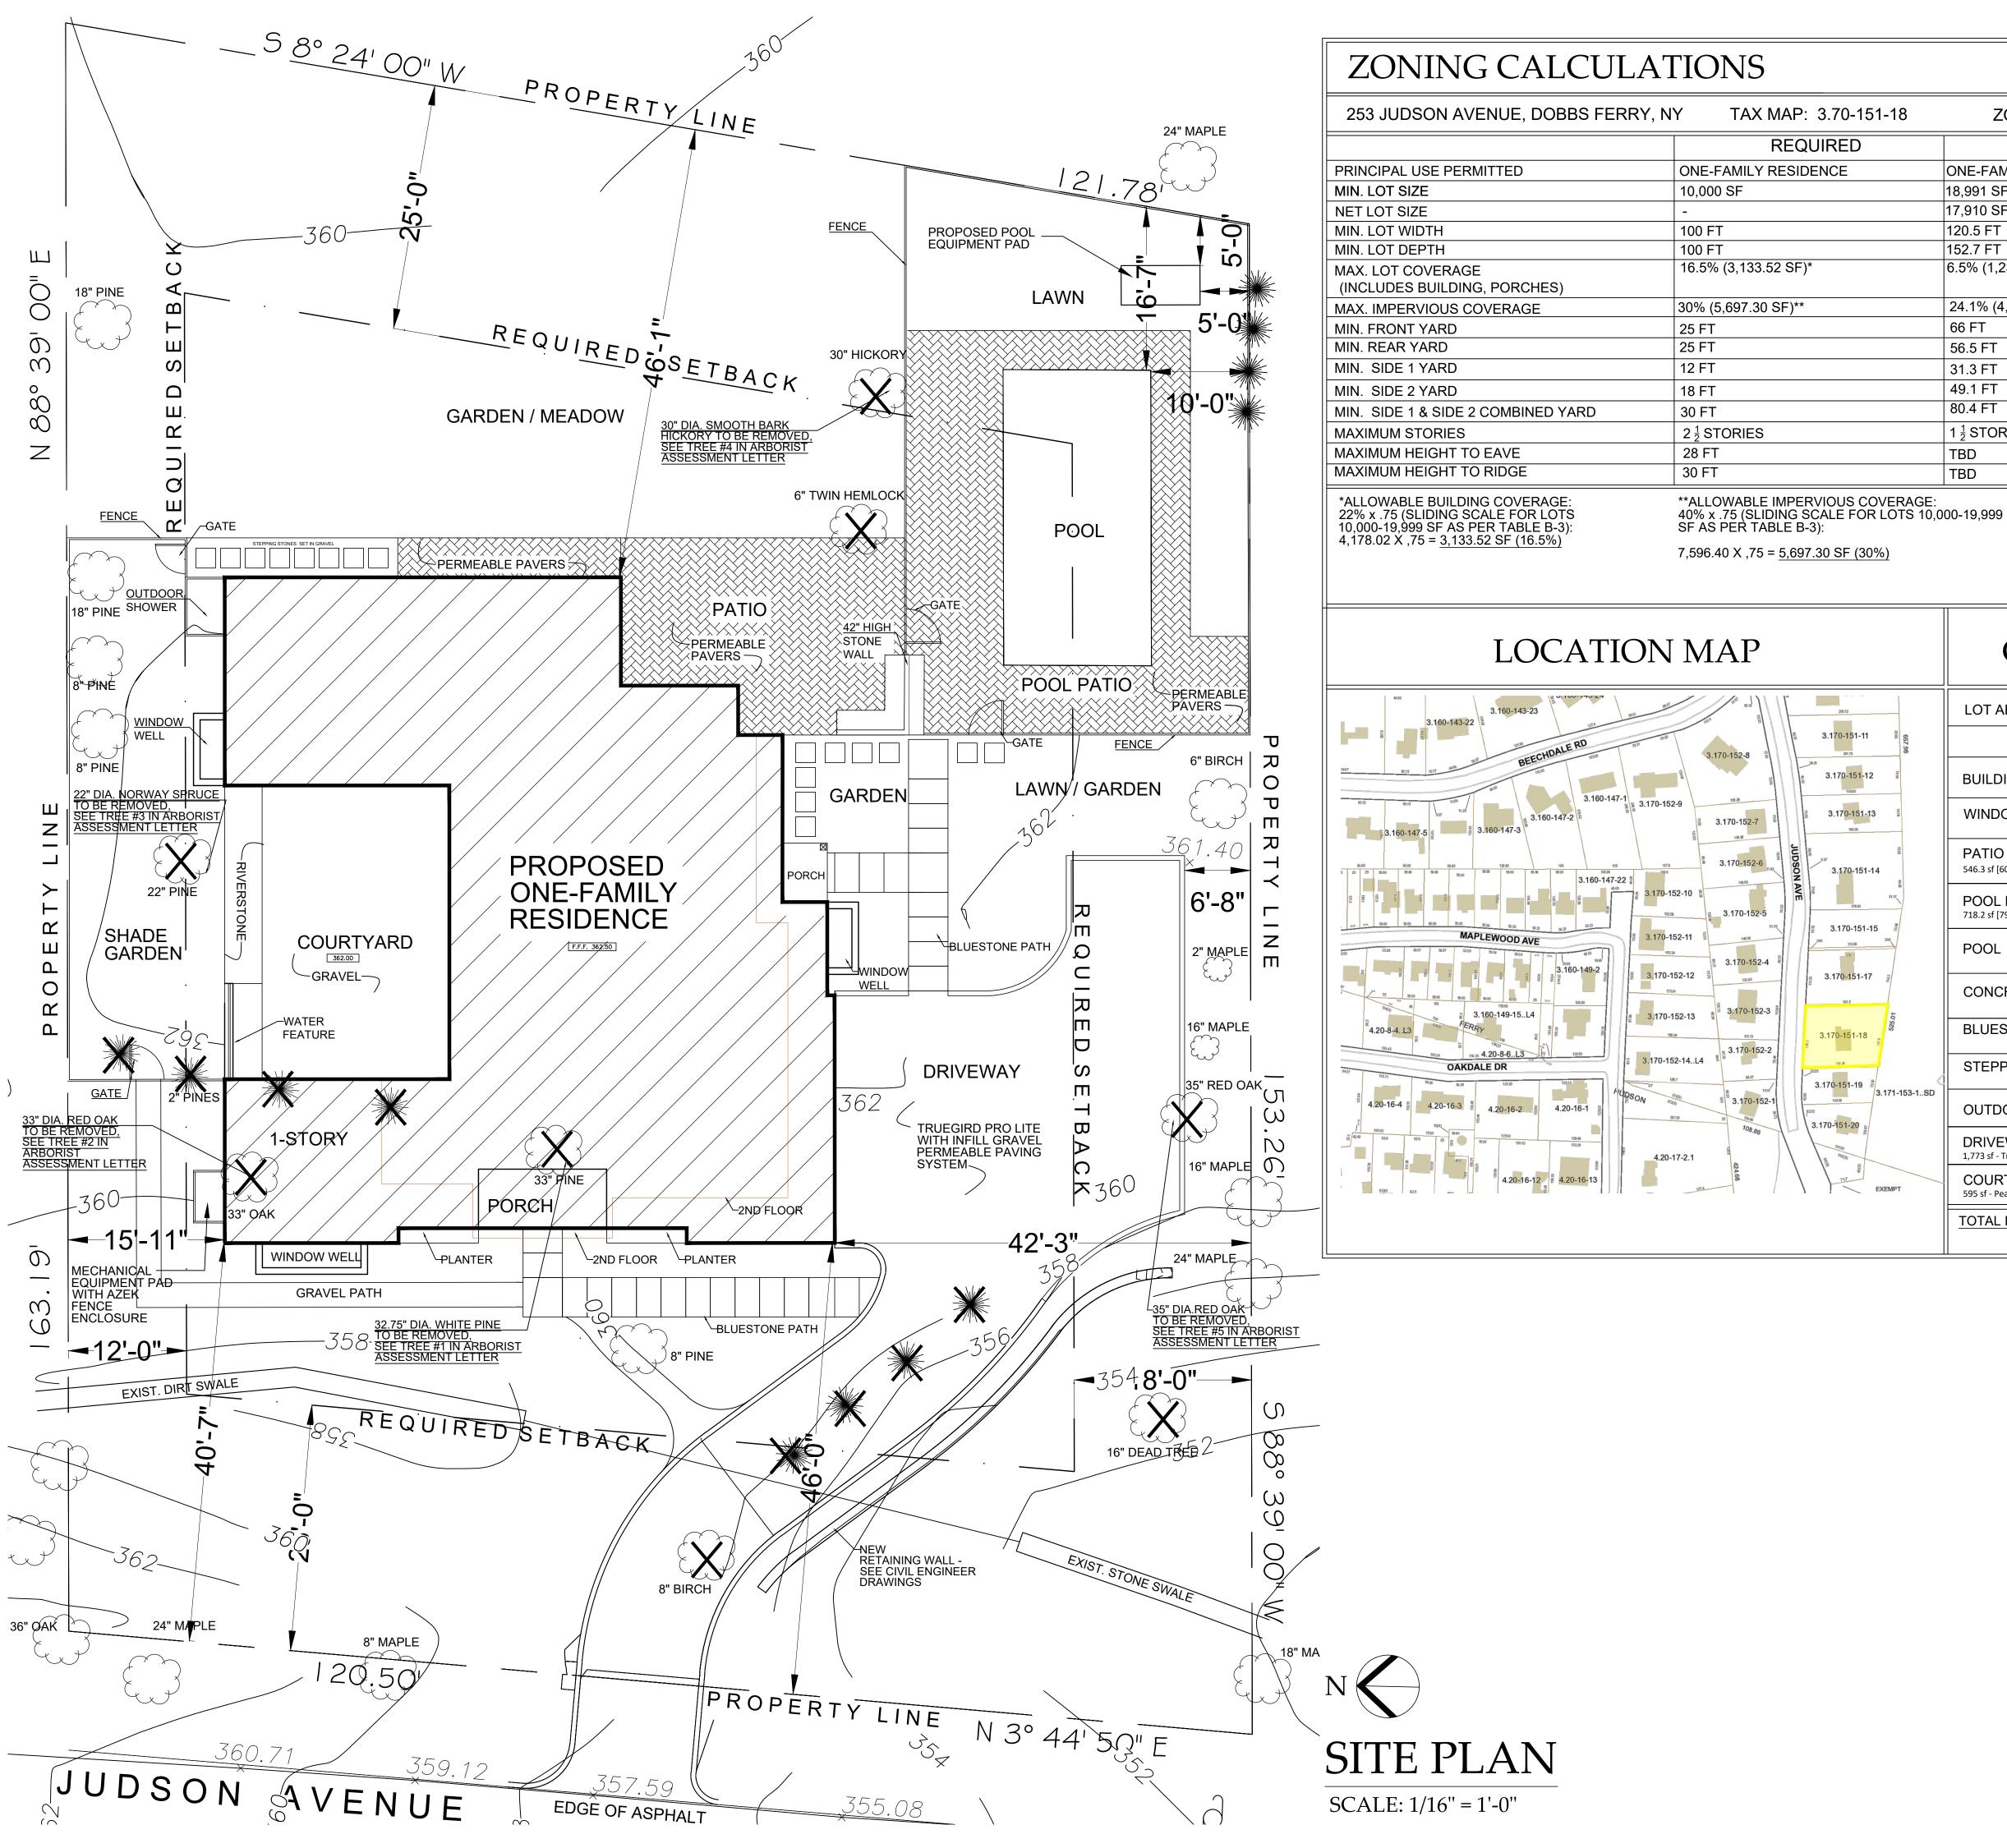

ZONING DISTRICT: OF	4
EXISTING	PROPOSED
ONE-FAMILY RESIDENCE	ONE-FAMILY RESIDENCE
18,991 SF	18,991 SF
17,910 SF	17,910 SF
120.5 FT	120.5 FT
152.7 FT	152.7 FT
6.5% (1,239 SF)	16.4% (3,110 SF)
24.1% (4,580 SF)	28.1 % (5,343.5 SF)
66 FT	40.6 FT
56.5 FT	46.1 FT
31.3 FT	42.3 FT
49.1 FT	15.9 FT
80.4 FT	58.2 FT
1 ¹ / ₂ STORIES	
TBD	21.3 FT
TBD	29.1 FT

SITE PLAN BASED ON SURVEY BY TC MERRITTS LAND SURVEYORS

	COVERAGE CALCULATIONS				
	LOT AREA	18,991 SF			
657,98		PROPOSED			
	BUILDING & PORCHES	3,110 SF			
	WINDOW WELLS	82 SF			
	PATIO 546.3 sf [607 Total pervious pavers - 10 % pervious = 546.3 sf impervious]	546.3 SF			
	POOL PATIO 718.2 sf [798 sf pervious pavers - 10 % pervious = 718.2 sf impervious]	718.2 SF			
	POOL	450 SF			
	CONCRETE PADS FOR MECHANICAL/POOL	47 SF			
	BLUESTONE PATHS (NOT INCL. GRAVEL)	166 SF = 132 SF = 298 SF			
¢	STEPPING STONES	4 SF X 17 = 68 SF			
3-1SD	OUTDOOR SHOWER	24 SF			
	DRIVEWAY 1,773 sf - TrueGrid with Gravel Infill - 100% Pervious - See Specifications	0 SF			
PT	COURTYARD 595 sf - Pea Gravel - 100% Pervious	0 SF			
	TOTAL IMPERVIOUS COVERAGE	5,343.5 SF			



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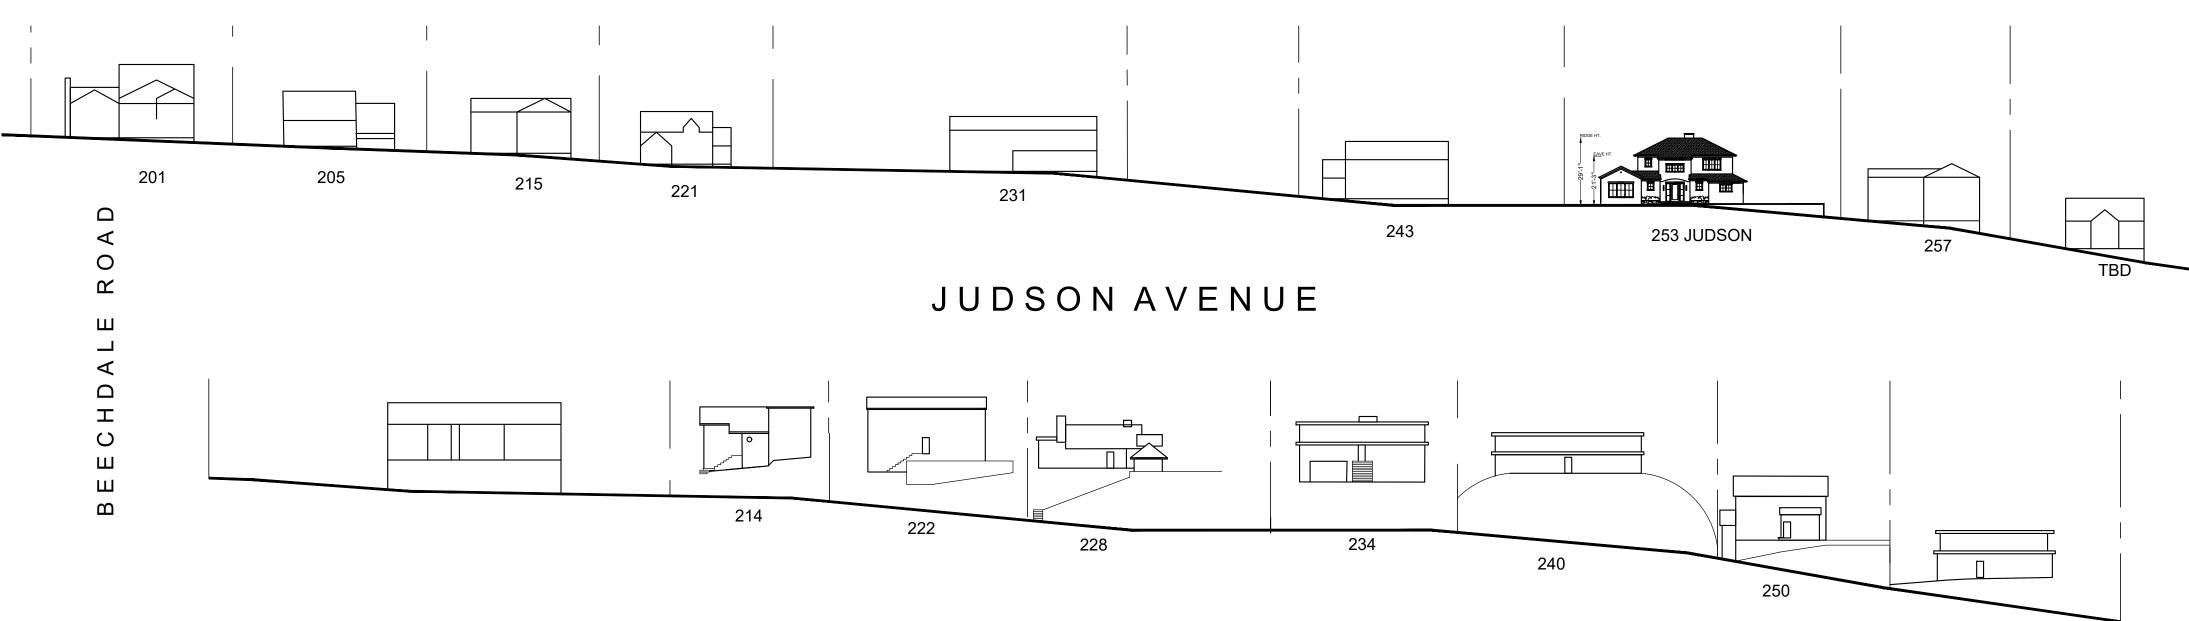
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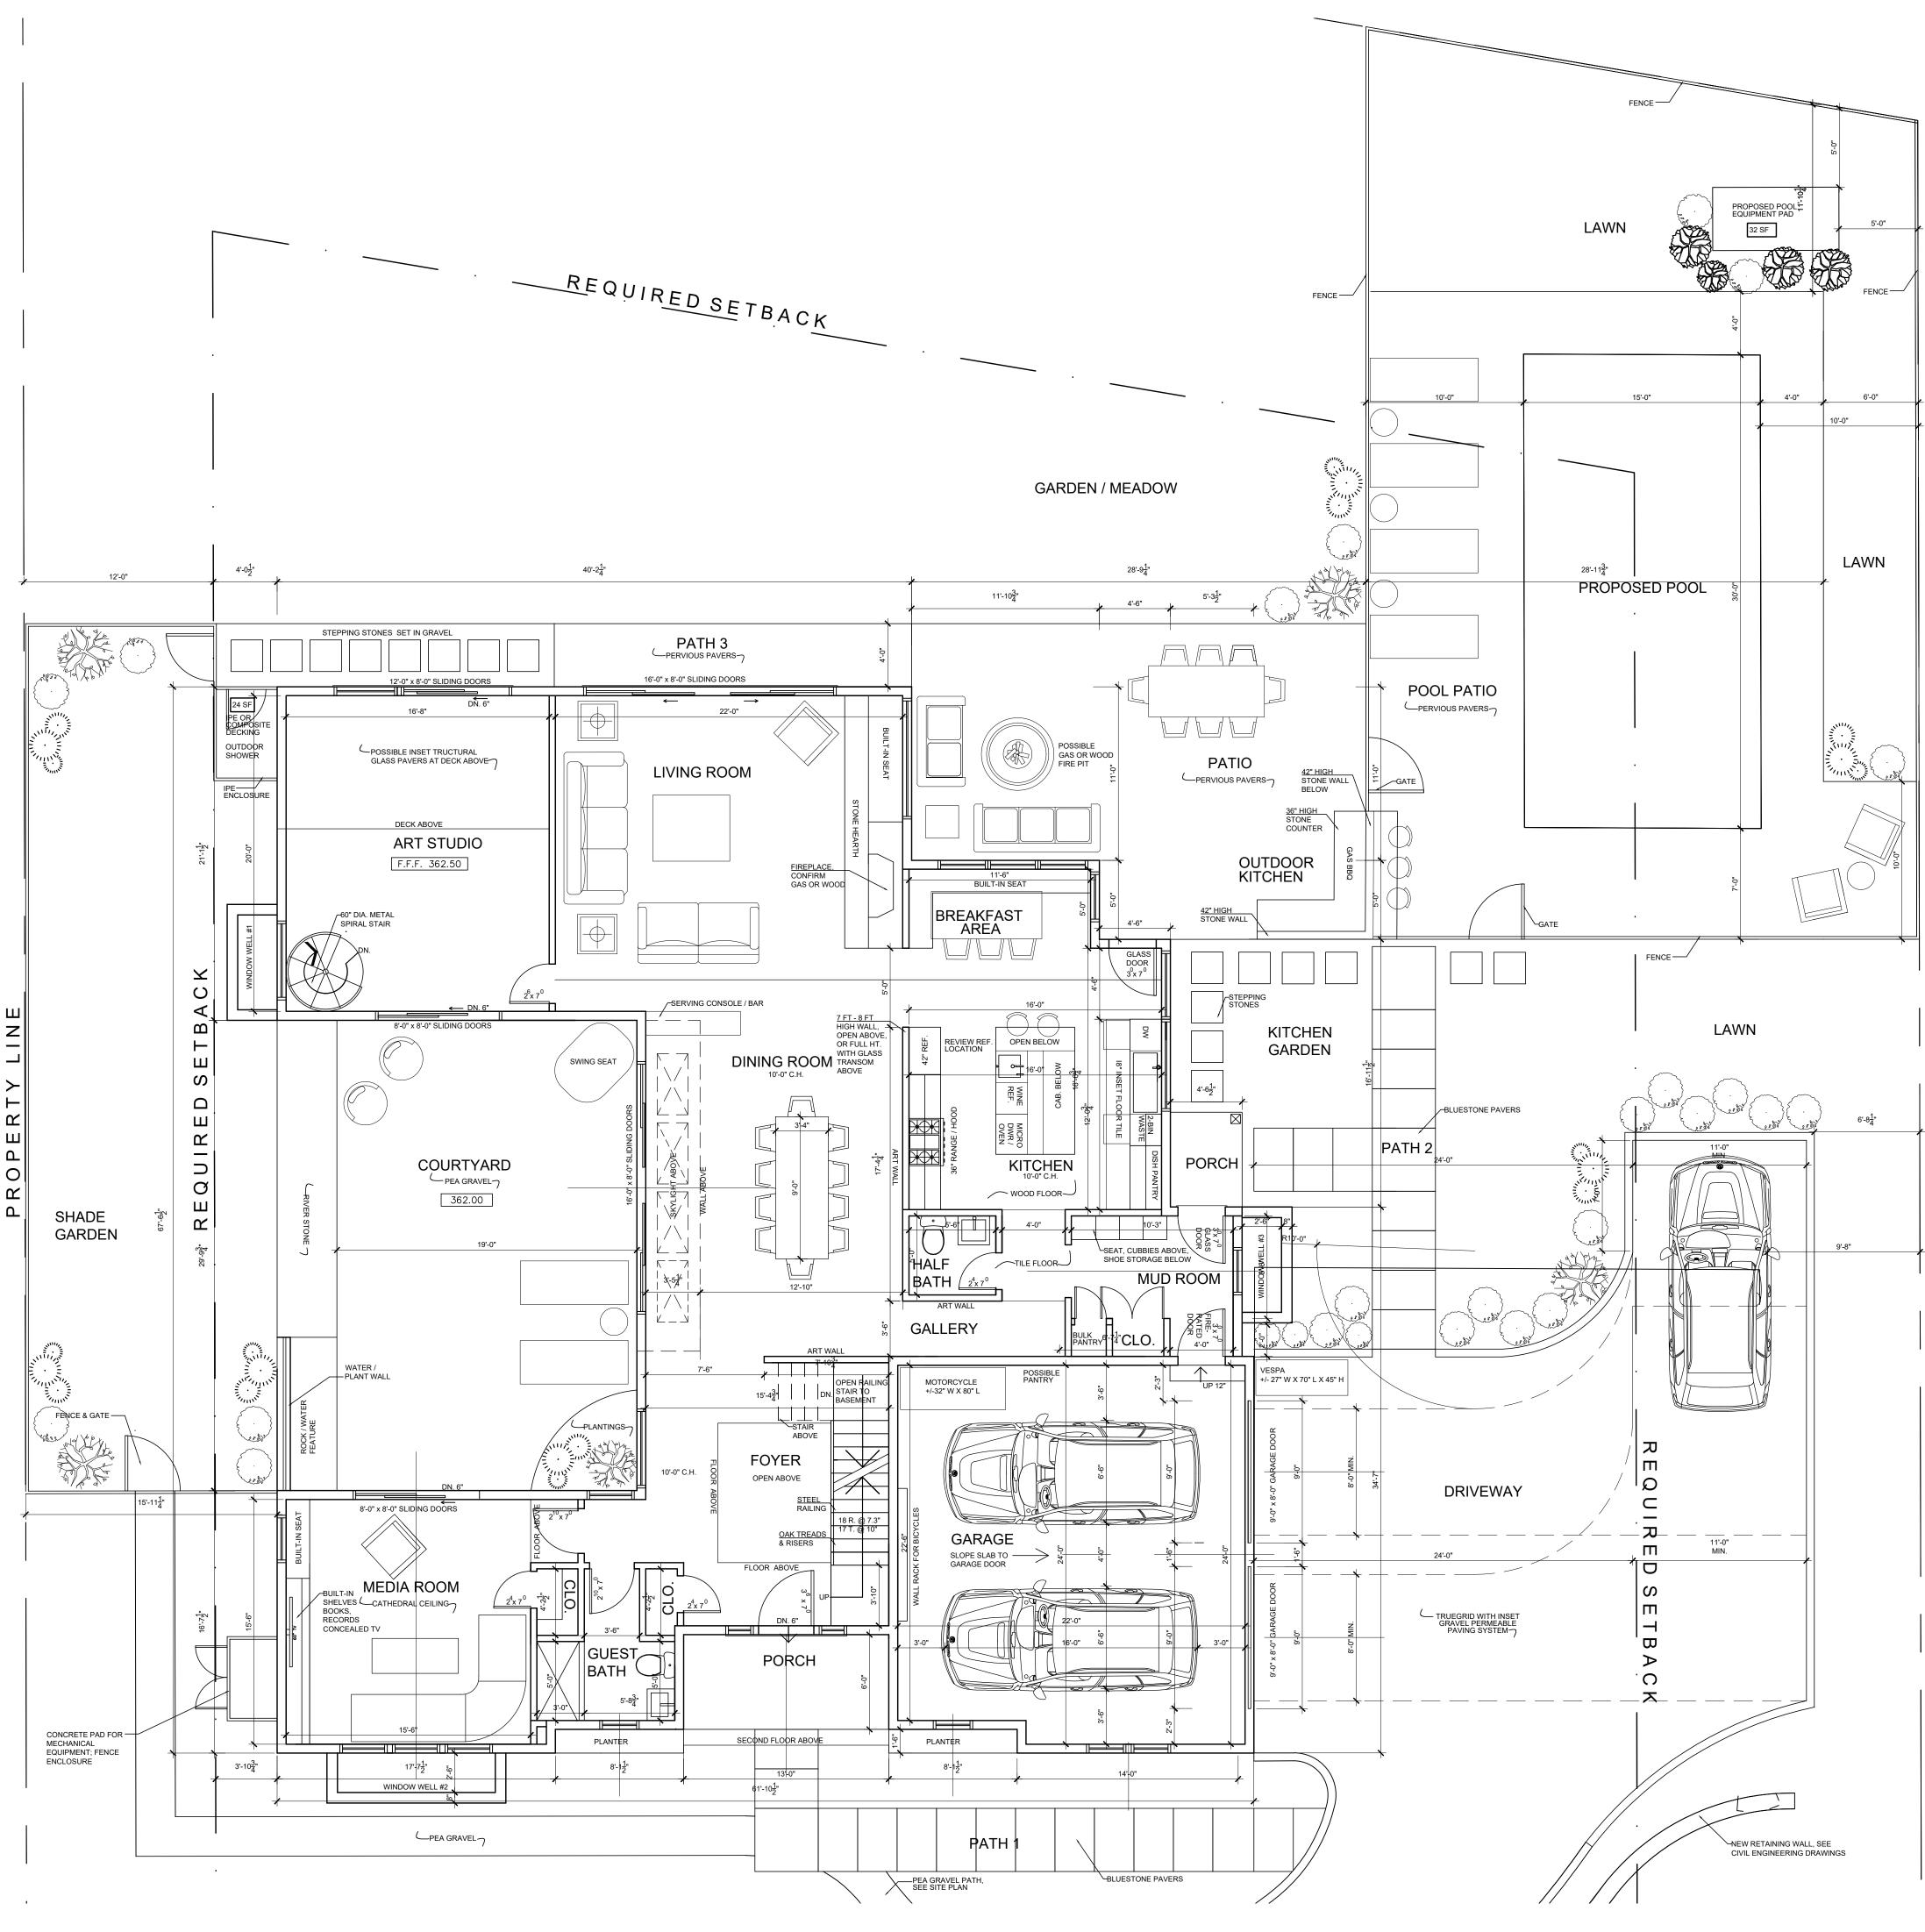
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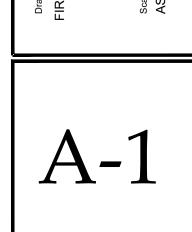















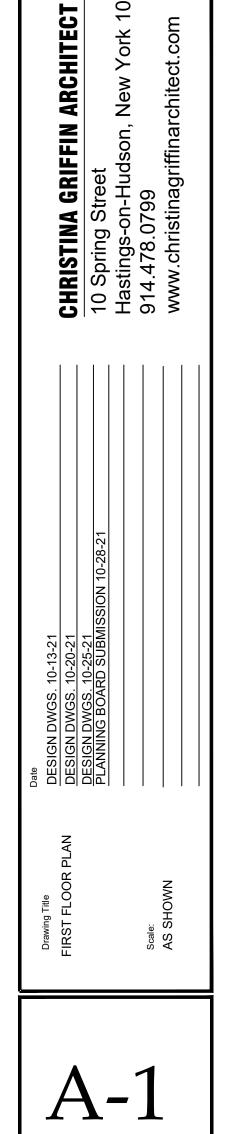


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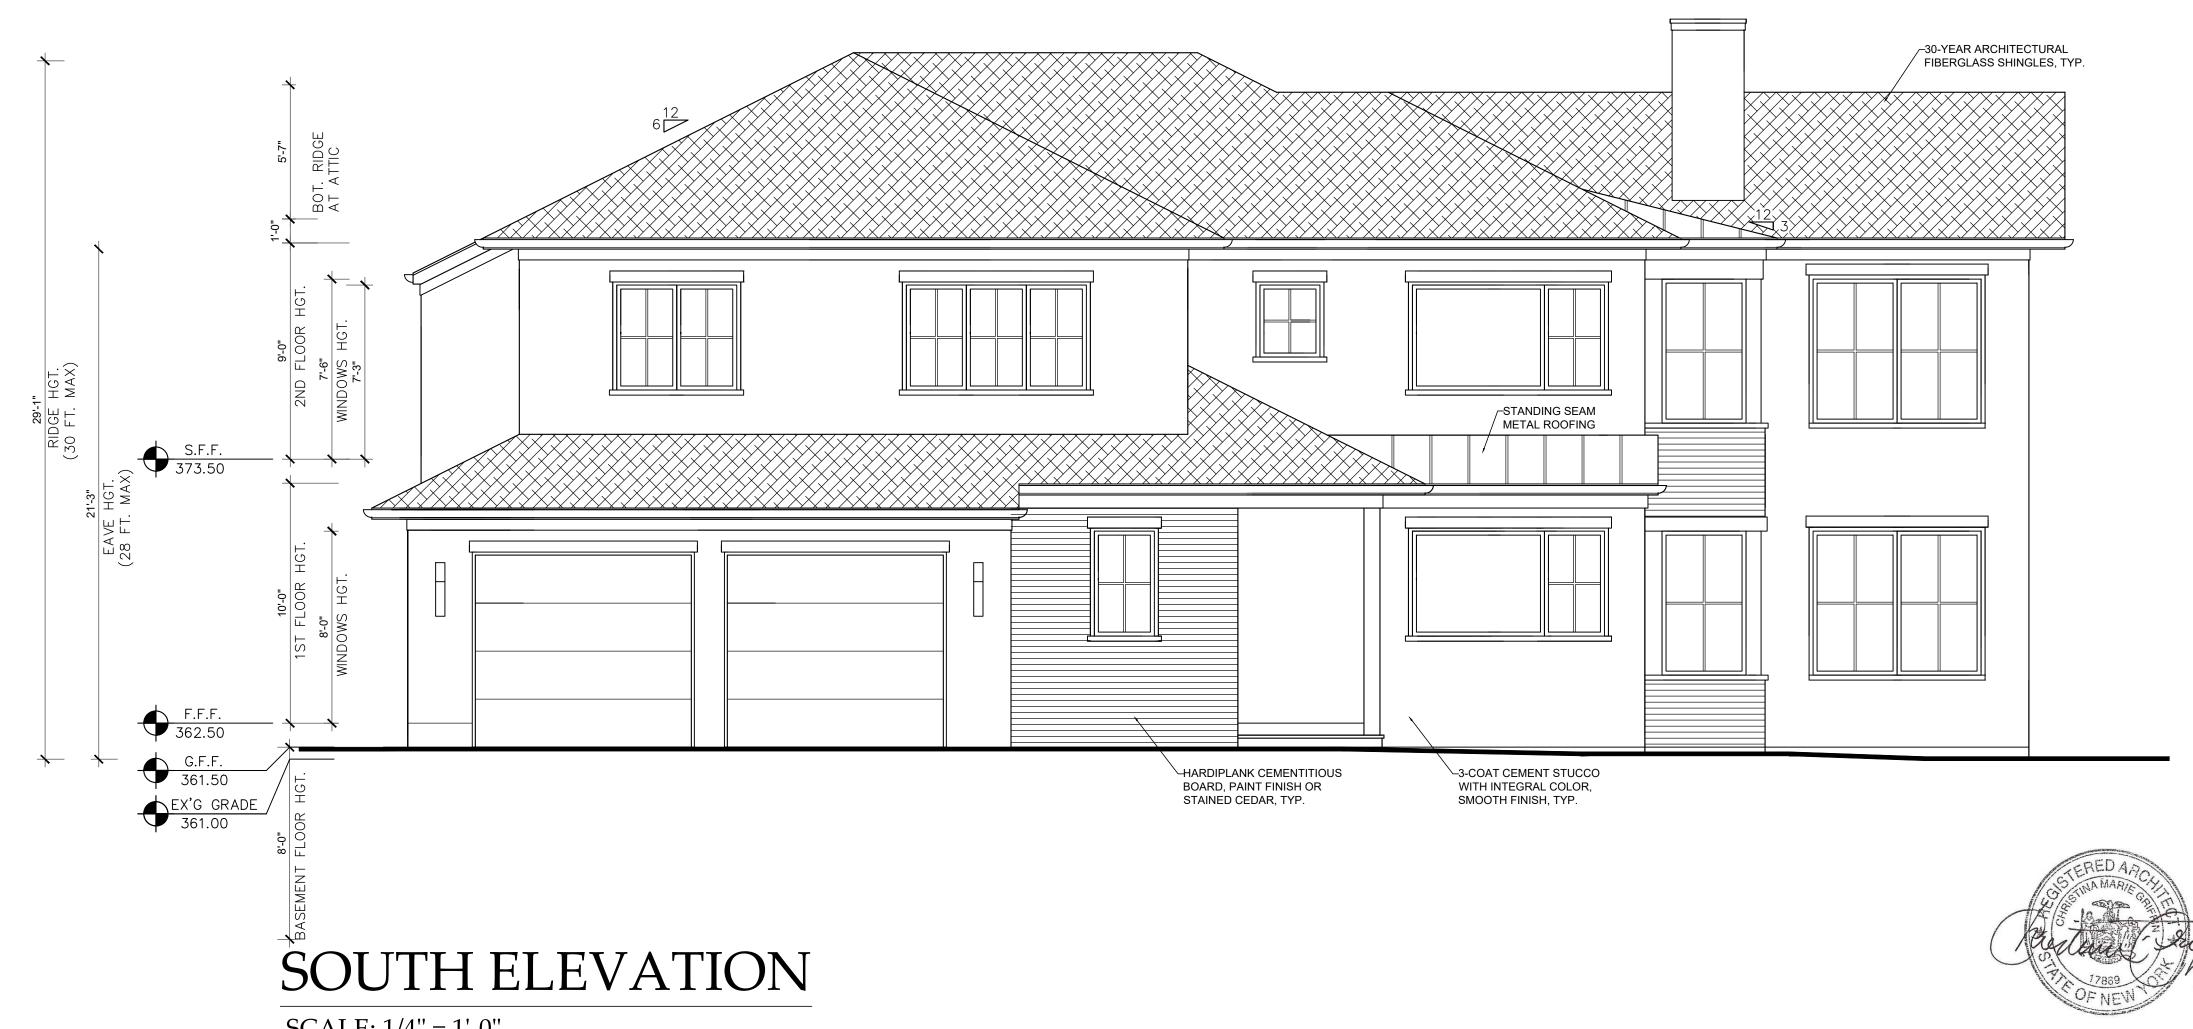


		N E W O N E - F A M I L Y R E S I D E N C E MARFIONE-BASU RESIDENCE 253 JUDSON AVENUE, DOBBS FERRY, NY 10522
	REQUIRED SETBACK	CHRISTINA GRIFFIN ARCHITECT CHRISTINA GRIFFIN ARCHITECT 10 Spring Street Hastings-on-Hudson, New York 10706 914.478.0799 www.christinagriffinarchitect.com
94-1-	TERED ARCINING	Drawing Title Date Drawing Title Deate SECOND FLOOR PLAN DESIGN DWGS. 10-13-21 DESIGN DWGS. 10-20-21 DESIGN DWGS. 10-23-21 DESIGN DWGS. 10-25-21 DESIGN DWGS. 10-28-21 PLANNING BOARD SUBMISSION 10-28-21 DESIGN DWGS. 10-28-21 Scale: Scale: Scale: Scale:
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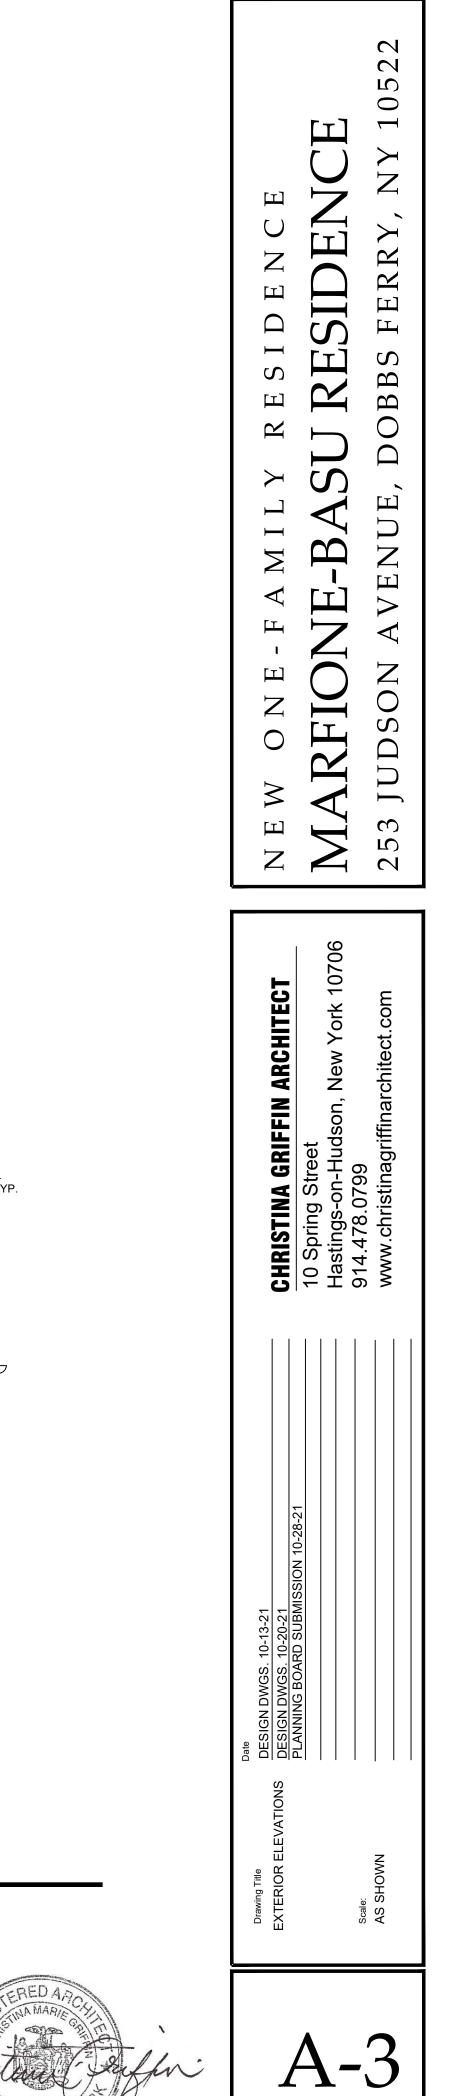


SCALE: 1/4" = 1'-0"

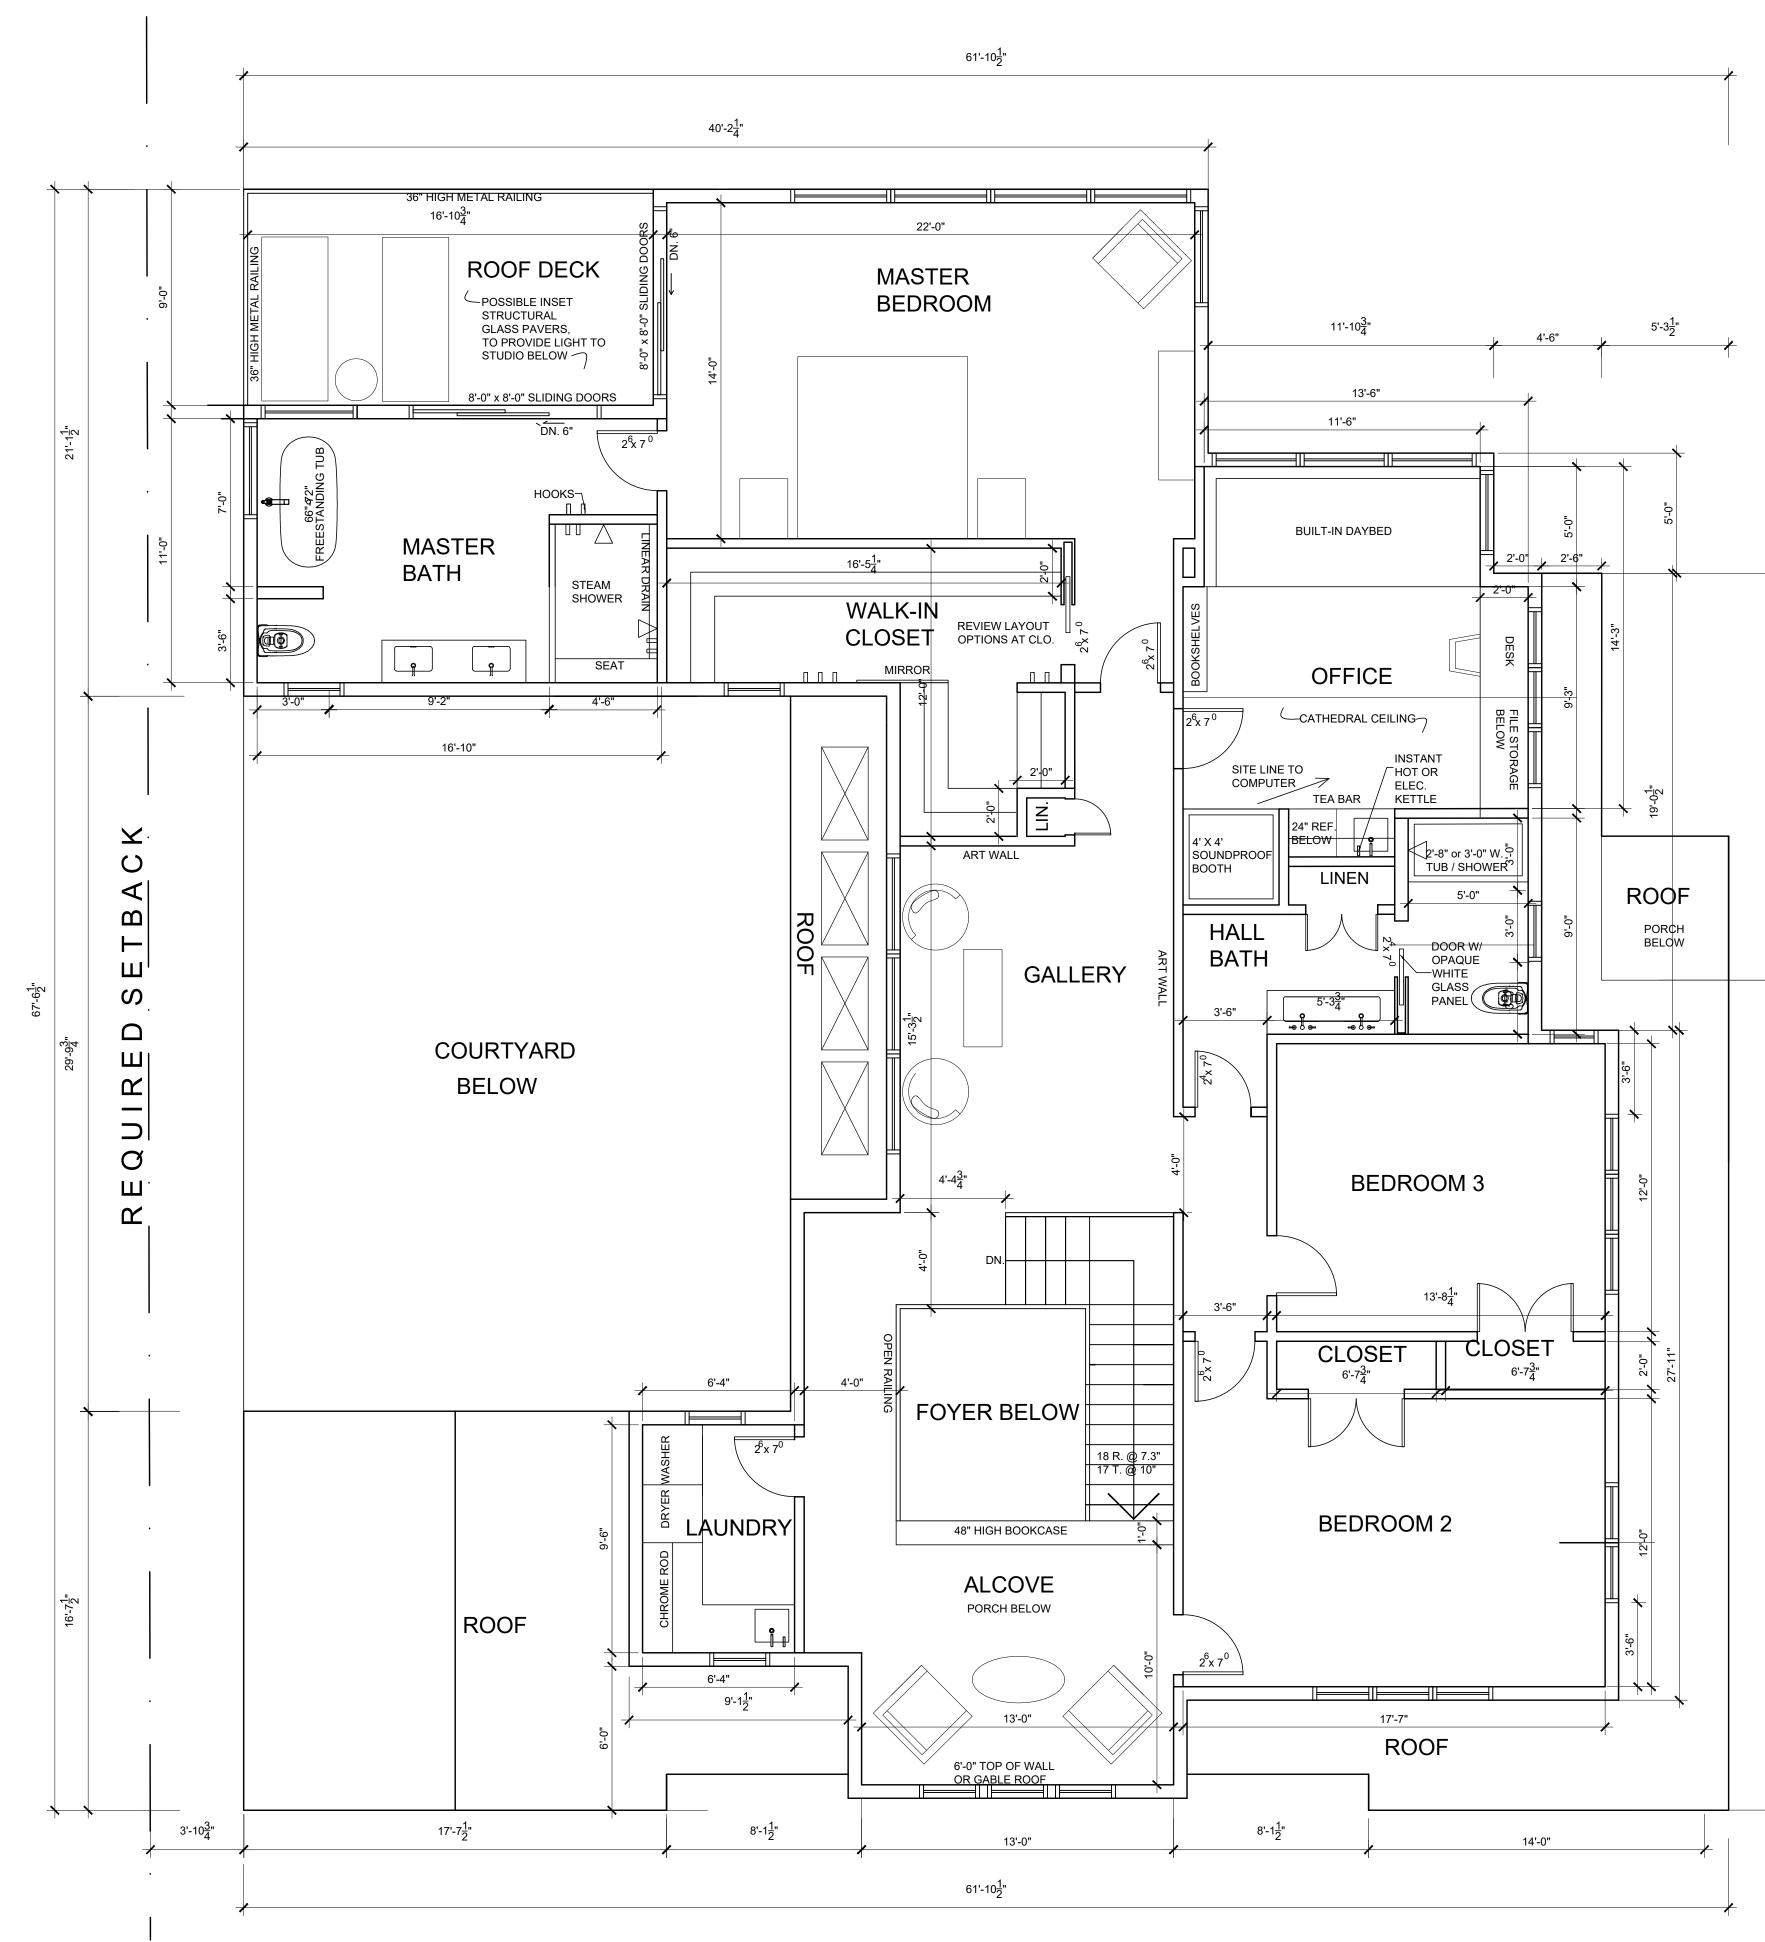

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SCALE: 1/4" = 1'-0"





NEW ONE-FAMILY RESIDENCE	MARFIONE-BASU RESIDENCE	253 JUDSON AVENUE, DOBBS FERRY, NY 10522
CHRISTINA GRIFFIN ARCHITECT	 10 Spring Street Hastings-on-Hudson, New York 10706 014 478 0700 	www.christinagriffinarchitect.com
Drawing Title DesiGN DWGS. 10-13-21 EXTERIOR ELEVATIONS DESIGN DWGS. 10-20-21 DENIMIC POAD SUBMISSION 10 28 24		Scale: AS SHOWN
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