# RESIDENCES AT 34 CLINTON AVENUE

DOBBS FERRY, NEW YORK 10522

## CGA STUDIO ARCHITECTS

12 SPRING STREET, HASTINGS.ON.HUDSON, NY 10706





## PLANNING BOARD SUBMISSION 1-19-23


OWNER	ARCHITECT	CONSULTING ARCHITECT	LANDSCAPE ARCHITECT	CIVIL ENGINEER	DATES		LIST OF DRAWINGS	LIST OF DRAWINGS
LANDMARK BUILDING & DEVELOPMENT, LLC JOHN SARAIVA, 73 BAJART PLACE YONKERS, NY 10705 914.906.1364 john@strelacore.com	CGA STUDIO CHRISTINA GRIFFIN AIA LEED AP CPHC 10 SPRING STREET HASTINGS-ON-HUDSON, NY 10706 914.478.0799 cg@cgastudio.com	DIPTI SHAH ARCHITECTS DIPTI SHAH AIA LEED AP 1 MAIN STREET DOBBS FERRY, NY 10522 914.967.0557 dipti@pbarchgroup.com	LOUIS FUSCO LANDSCAPE ARCHITECTS LOUIS C. FUSCO PLA ASLA PO BOX 362 POUND RIDGE, NY 10576 914.764.9123 louisfusco.com	HUDSON ENGINEERING & CONSULTING MICHAEL F. STEIN, P.E., PRESIDENT 45 KNOLLWOOD ROAD - SUITE 201 ELMSFORD, NEW YORK 10523 914.909.0420 michael@hudsonec.com	BUILDING DEPARTMENT SUBMISSION PLANNING BOARD SUBMISSION PLANNING BOARD PRESENTATION PLANNING BOARD SUBMISSION	11-7-22 12-13-22 01-05-23 01-19-23	TITLE TITLE SHEET, PROJECT IMAGERY, LIST OF DRAWINGS  S-1 ZONING DATA & AREA MAP S-2 EXISTING CONDITION PHOTOS S-3A-B NEIGHBORHOOD CONTEXT S-4A-B SITE PLAN, DEMOLITION SITE PLAN & STEEP SLOPE SITE ANALYSIS  A-1 BASEMENT FLOOR PLAN A-2 FIRST FLOOR PLAN A-3 SECOND FLOOR PLAN A-4 THIRD FLOOR PLAN A-5 ROOF PLAN A-6 EAST (FRONT) ELEVATION A-7 NORTH (SIDE) ELEVATION A-8 WEST (REAR) ELEVATION A-9 EXIST. SOUTH ELEVATION A-10 COURTYARD SOUTH ELEVATION	LANDSCAPE DRAWINGS SP-1 LANDSCAPE SITE PLAN PL-1 PLANTING PLAN & RENDERED SITE PLAN PL-2 RENDERED VIEWS OF THE SITE  CIVIL ENGINEERING DRAWINGS C-1 STORMWATER MANAGEMENT PLAN C-2 STORMWATER DETAILS  SURVEY DRAWINGS TOPOGRAPHICAL SURVEY SLOPES SURVEY

## ZONING CALCULATIONS

## 34 CLINTON AVENUE, DOBBS FERRY NY 10522

ZONING DISTRICT: MDR-H	TAX DESIGNATION: SECTION 3.80:	BLOCK: 46 LOT: 4
20111110 010 11110 1111011111	17 17 15 15 15 17 11 15 14 15 15 15 15 15 15 15 15 15 15 15 15 15	

	ZONING DISTRICT: MDR-H; TAX DESIGNATION: SECTION 3.80; BLOCK: 46, LOT: 4					
	REQUIRED	EXISTING	PROPOSED			
GROSS LOT AREA	10,000 SF	29,908 SF	29,908 SF			
AREA OF SLOPES OVER 25% [EXCL. SLOPE AREAS UNDER 150 SF]	-	3,428 SF	3,428 SF			
AREA OF SLOPES OVER 15-25% [EXCL. SLOPE AREAS UNDER 150 SF]	_	1,724 SF	1,724 SF			
NET LOT AREA AFTER STEEP SLOPE REDUCTION PER SECTION 300-34.A(2)	LOT AREA- [50% AREA OF SLOPES OVER 25% + 25% AREA OF SLOPES 15-25%] 10,000 SF MIN.	29,908 - [50%(3,428) + 25% (1,724)] = 27,763 SF	29,908 - [50%(3,428) + 25% (1,724)] = 27,763 SF			
NUMBER OF DWELLING UNITS	-	(3) RESIDENTIAL UNITS (2) 2-BEDRM & (1) 5-BEDRM	(11) 2-BEDROOM UNITS			
MINIMUM LOT AREA PER DWELLING UNIT	2,500 SF	29,908 / 3 = 9,969 SF	29,908 / 11 = 2,719 SF			
NUMBER OF AFFORDABLE DWELLING UNITS PER 300-40.A(1) AND REQUIRED UNIT AREA SEE UNIT SF CHART	10% OF UNITS: (10%) X 11 = 1.1 1 UNIT RQD; MINIMUM UNIT SF = 80% OF AVERAGE MARKET RATE UNIT SF AVERAGE MARKET RATE UNIT: 1,361 SF 80% OF AVG MARKET RATE UNIT: 1,089 SF	N/A	(1) 2-BEDROOM AFFORDABLE UNIT UNIT AREA: UNIT 1: 1,091 SF > 1,089 SF RQD INCL. 1/3 OF UNIT 1 PATIO			
MINIMUM RESIDENTIAL UNIT SIZE	N/A FOR THIS DISTRICT	N/A FOR THIS DISTRICT	N/A FOR THIS DISTRICT			
DRIVEWAYSLOPE	12%	3%	9%			
PARKING REQUIREMENT	1 SPACE PER DWELLING UNIT + 1/4 PER BEDROOM = 17 SPACES REQUIRED FOR 11 x (2-BEDROOM UNITS)	N/A	17 SPACES PROVIDED: 7 SPACES IN ENCLOSED GARAGE (1 OF WHICH IS ADA COMPLIANT) & 10 OUTDOOR SPACES			
BUILDING COVERAGE	30% x 0.67 = 20.1% OF 29,908 SF	8%	20.1%			
FOR LOTS 20,000-40,000 SF	6,011 SF MAX.	2,412 SF	6,011 SF			
IMPERVIOUS COVERAGE FOR LOTS 20,000-40,000 SF	60% x 0.67 = 40.2% OF 29,908 SF 12,023 SF MAX.	29% 8,578 SF	39.9% 11,946 SF			
MINIMUM LOT WIDTH [TABLE B-3]	100 FT	148.5 FT	148.5 FT			
MINIMUM LOT DEPTH [TABLE B-3]	125 FT	193 FT / 221.26 FT	193 FT / 221.26 FT			
FRONT YARD SETBACK [LOT DEPTH (193+221)/2 = 207 FT OVER 150 FT]	40 FT	80.9 FT	80.9 FT			
REAR YARD SETBACK [LOT DEPTH (193+221)/2 = 207 FT OVER 150 FT]	40 FT	55.25 FT	40 FT			
SIDE SETBACK (#1) [TABLE B-4]	15 FT	54.8 FT	15 FT			
SIDE SETBACK (#2) [TABLE B-4]	20 FT	23.5 FT	20 FT			
TOTAL OF TWO SIDE SETBACKS [TABLE B-4]	35 FT	78.3 FT	35 FT			
MAXIMUM STORIES	3 STORIES	2.5 STORIES	3 STORIES			
MAXIMUM HEIGHT TO EAVE [ROOF PITCH 0.5]	28 FT	EXISTING	TO MATCH EXISTING; 26.4 FT ABOVE NEW GRADEPLANE EL: 228			
MAXIMUM BUILDING HGT TO MIDPOINT OF ROOF [ROOF PITCH 0.5]	35 FT	EXISTING	TO MATCH EXISTING; 34.42 FT ABOVE NEW GRADEPLANE EL: 228			
ELEVATOR BULKHEAD AREA (FOR BULKHEAD EXCEEDING MAX. BUILDING HGT) PER SECTION 300-34-C(1)	UNDER 20% OF ROOF AREAS 20% (6,452 SF) = 1,290 SF	-	80 SF (1.25 % OF ROOF AREA)			

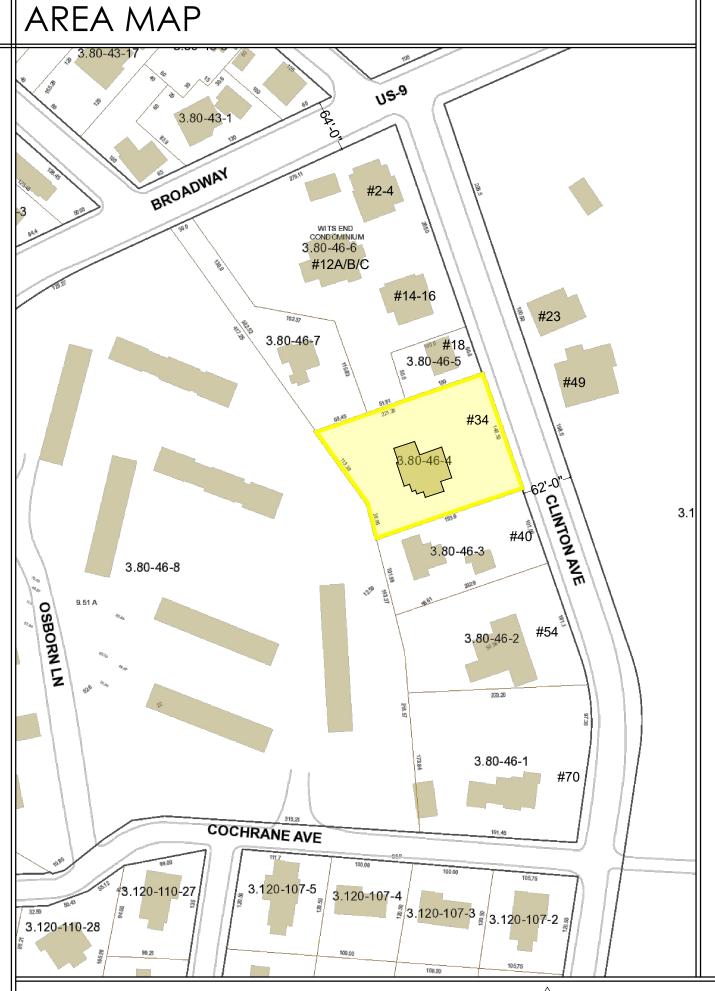

# GRADE PLANE CALCULATION 1

## AVG FAÇADE AVG GRADE x GRADE LENGTH (FT) FAÇADE LENGTH EAST (FRONT) ELEVATION (@ NEW BUILDING) 225.3 SOUTH ELEVATION (@ NEW BUILDING FROM CTYD) 41.6 23.3 EAST ELEVATION (@ NEW BUILDING FROM CTYD) NORTH ELEVATION (@ EXIST BUILDING FROM CTYD) 232.8 EAST (FRONT) ELEVATION (@ EXIST BUILDING) 231.6

11,754 228.5 10,852 SOUTH ELEVATION (@ EXIST BUILDING) 26.16 WEST (REAR) ELEVATION (@ EXIST BUILDING) 5,873 SOUTH ELEVATION (@ NEW BUILDING FROM REAR) 225.3 6,759 WEST (REAR) ELEVATION (@ NEW BUILDING) 225.0 15,368 NORTH (SIDE) ELEVATION (@ NEW BUILDING) 225.7 69.16 15,606 438.27 99,970

**GRADE PLANE** 

(AVG GRADE x FAÇADE LENGTH/TOTAL LENGTH)

228.10

FIRST FLOOR - GRADE PLANE = 234 - 228 = 5.90 < 6 FT

## COVERAGE CALCULATIONS

EXISTING BUILDING COVERAGE	
EXISTING BUILDING	1582
EXISTING COVERED SIDE PORCH	317
REAR ONE-STORY PORTION	230
REAR OVERHANG	111
SIDE ONE-STORY PORTION + ROOFED PORCH	125
SHED	47
TOTAL BUILDING COVERAGE	2,412
	8%

EXISTING IMPERVIOUS COVERAGE	
DRIVEWAY	4,124
FRONT TERRACE+STEPS	340
DECK	545
STEPS, WALK NEAR DECK & REAR STEPS	279
WALK & METAL STEPS TO SIDE PORCH	258
REAR PATIO	560
REAR STEPS DOWN TO REMAIN	60
IMPERVIOUS COVERAGE	6,166
TOTAL IMPERVIOUS COVERAGE INCL. BUILDING	8,578
	29%

PROPOSED BUILDING COVERAGE	
EXISTING BUILDING	1,582
NEW COVERED PORCH AT MAIN ENTRY	138
BUILDING ADDITION (INCL. FRONT, REAR BAY & TOWER)	4,291
TOTAL BUILDING COVERAGE	6,011
	20%

	<u> </u>
PROPOSED IMPERVIOUS COVERAGE	
NEW DRIVEWAY & OUTDOOR PARKING SPOTS	5,220
DEDUCT 45% OF 2,955 SF AREA PAVED WITH	
PERMEABLE PAVERS (SEE SITE PLAN)	(1,330)
NEW COURTYARD	766
NEW FRONT ENTRY PLATFORM	75
NEW REAR PATIO (FOR UNIT 1)	352
RETAINING WALLS	483
REAR STEPS (EXIST. TO REMAIN)	60
NEW STEPPING STONES PATH	309
IMPERVIOUS COVERAGE	5,935
TOTAL IMPERVIOUS COVERAGE INCL. BUILDING	11,946
	39.9%

# CHART OF RESIDENTIAL UNITS

UNIT#	DESCRIPTION	SF
UNIT 1	2BR AFFORDABLE	966
	UNIT 1 PATIO	352
UNIT 1 INCLUDING 1	/3 PATIO SF	1,083
I. I. II. A	lann I	4.005
JUNII 2	2BR	1,365
UNIT 3	2BR	1,330
UNIT 4	2BR	1,295
UNIT 5	2BR DUPLEX	1,506
UNIT 6	2BR	1,365
UNIT 7	2BR	1,330
UNIT 8	2BR	1,295
UNIT 9	2BR	1,016
UNIT 10	2BR	1,361
UNIT 11	2BR	1,513
<b>AVERAGE MARKET</b>	RATE UNIT	1,338
80% AVERAGE MAR	1,070	
	UNIT 1 INCLUDING 1 UNIT 2 UNIT 3 UNIT 4 UNIT 5 UNIT 6 UNIT 7 UNIT 8 UNIT 9 UNIT 10 UNIT 11 AVERAGE MARKET	UNIT 1  2BR AFFORDABLE  UNIT 1 PATIO  UNIT 1 INCLUDING 1/3 PATIO SF  UNIT 2  2BR  UNIT 3  2BR  UNIT 4  2BR  UNIT 5  2BR DUPLEX  UNIT 6  2BR  UNIT 7  2BR  UNIT 7  2BR  UNIT 9  2BR

# ARCHITECTS

12 SPRING STREET HASTINGS.on.HUDSON N.Y. 10706 914.478.0799 cg@cgastudio.com christinagriffinarchitect.com

10,024

BUILDING PERMIT SUBMISSION 11-7-22 PLANNING BOARD SUBMISSION 12-13-22 ADDED CHART PB PRESENTATION 1-5-23 PLANNING BOARD SUBMISSION 1-19-23

 $\mathbb{R}$ 

Project Submitted

Drawing Title ZONING DATA & AREA MAP


# EXISTING CONDITIONS





# EXISTING AERIAL SITE VIEWS



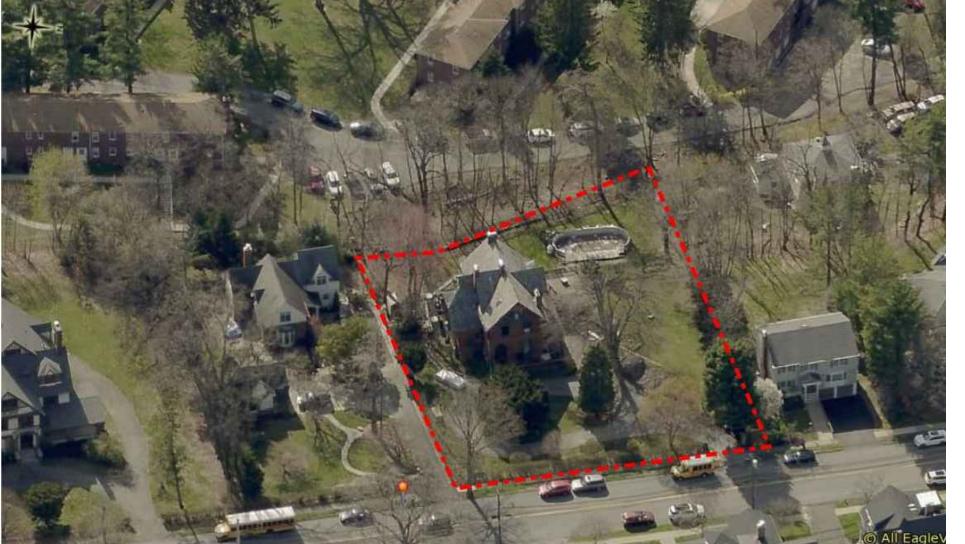



# GGA Studio ARCHITECTS

12 SPRING STREET HASTINGS.on.HUDSON N . Y . 1 0 7 0 6 9 1 4 . 4 7 8 . 0 7 9 9 cg@cgastudio.com christinagriffinarchitect.com

# Y/ENUE

SACION A CONTRACT A CO

BUILDING PERMIT SUBMISSION 11-7-22
PLANNING BOARD SUBMISSION 12-13-22
PLANNING BOARD SUBMISSION 1-19-23




Scale As Sho

Drawing Title

EXISTING CONDITION PHOTOS

S-2

Sheet Number

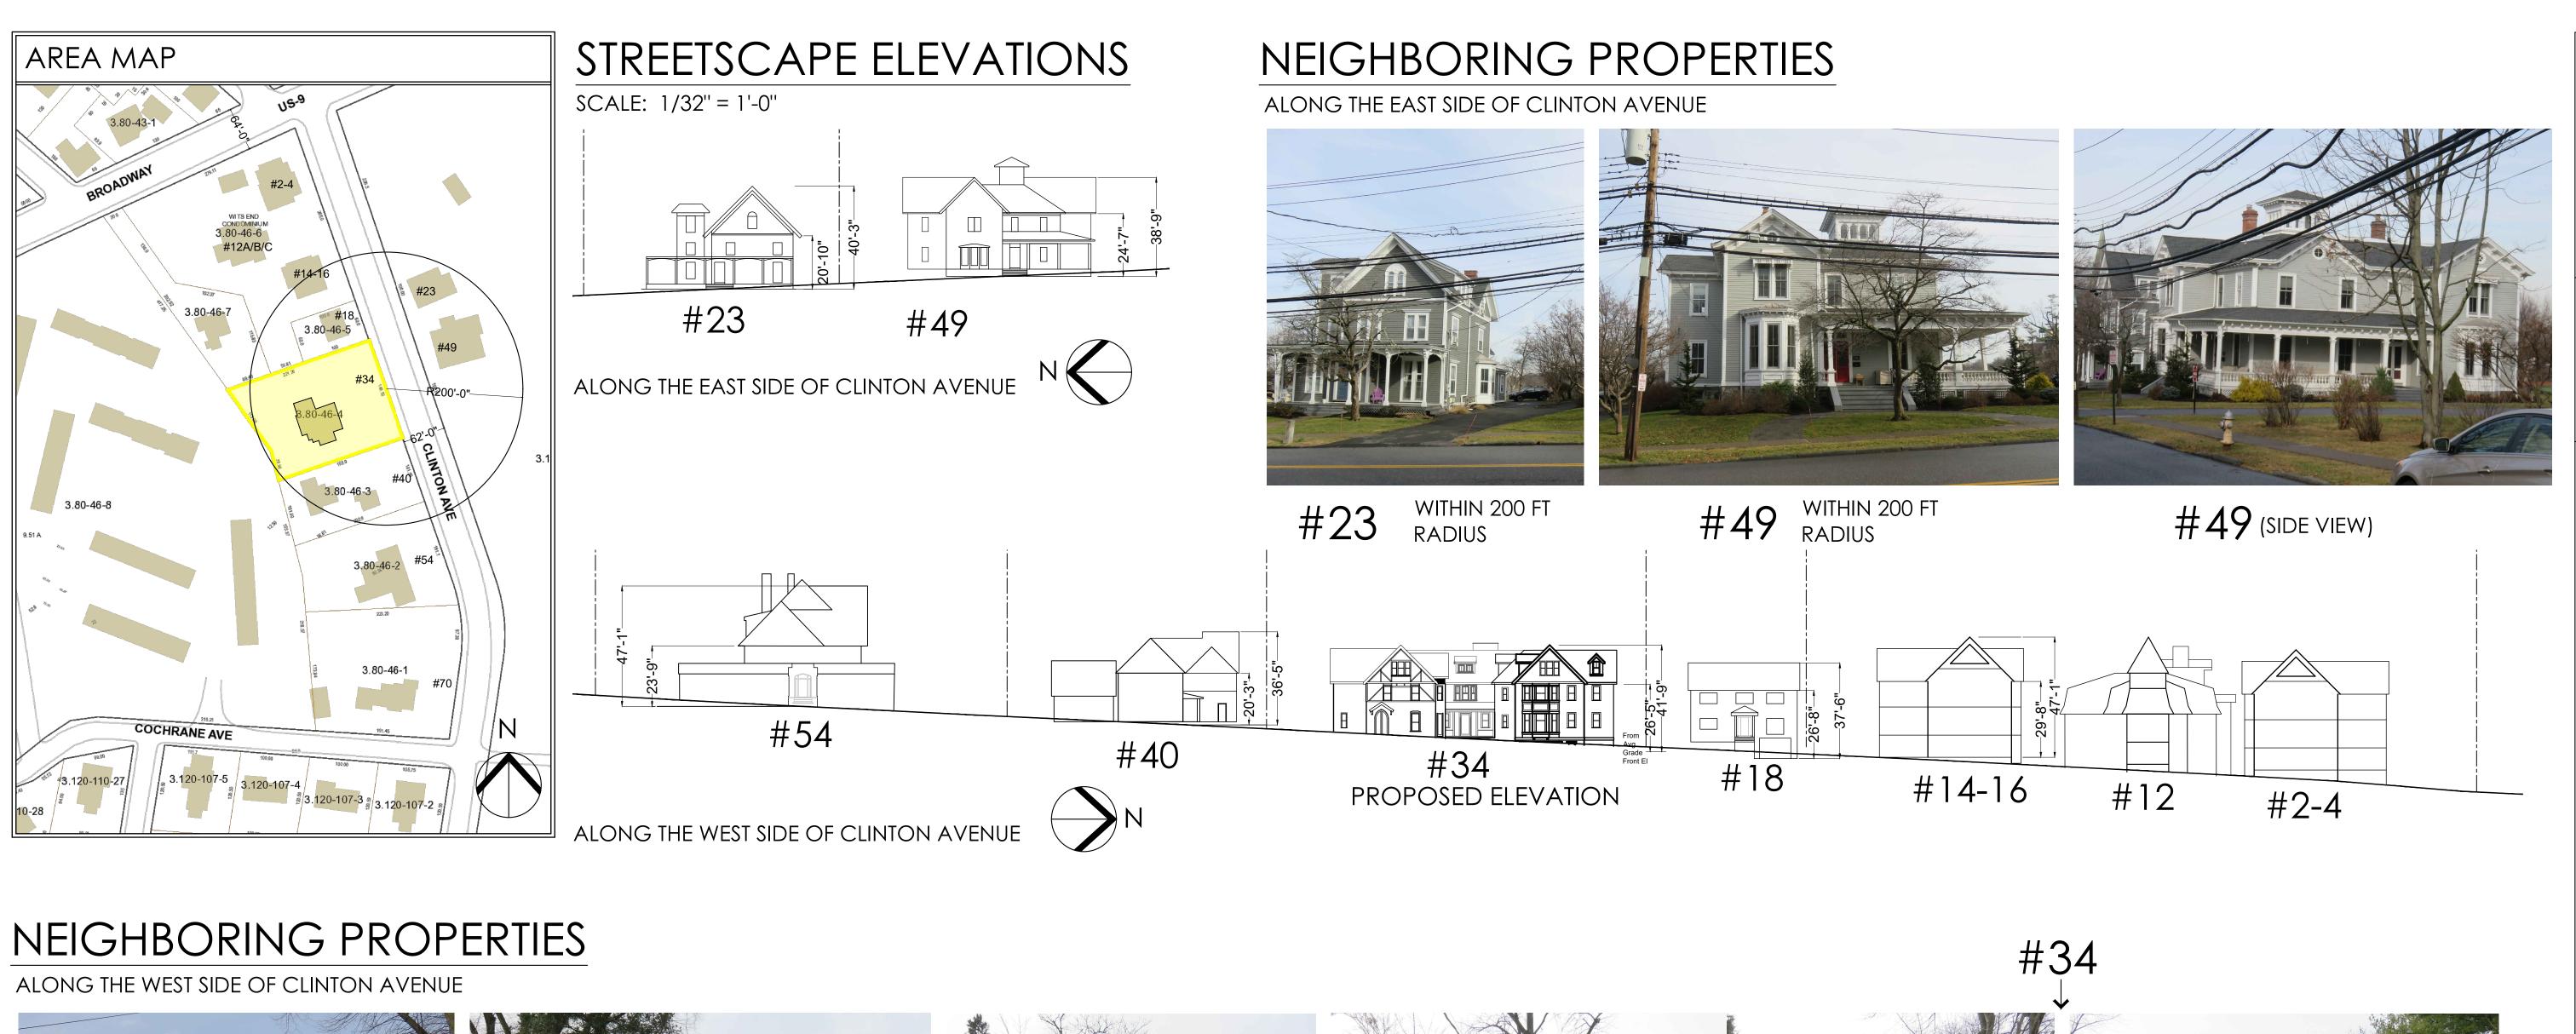













#70

#14-16

#54

#2-4

WITHIN 200 FT 40 RADIUS

WITHIN 200 FT RADIUS #40

WITHIN 200 FT RADIUS #18

ALONG THE WEST SIDE OF CLINTON AVENUE

#78



WITHIN 200 FT #14-16 RADIUS



#12





ARCHITECTS

12 SPRING STREET HASTINGS.on.HUDSON N.Y. 10706 914.478.0799 cg@cgastudio.com christinagriffinarchitect.com




Drawing Title


NEIGHBORHOOD CONTEXT

#2-4

# 

# AERIAL VIEW OF NEIGHBORING PROPERTIES

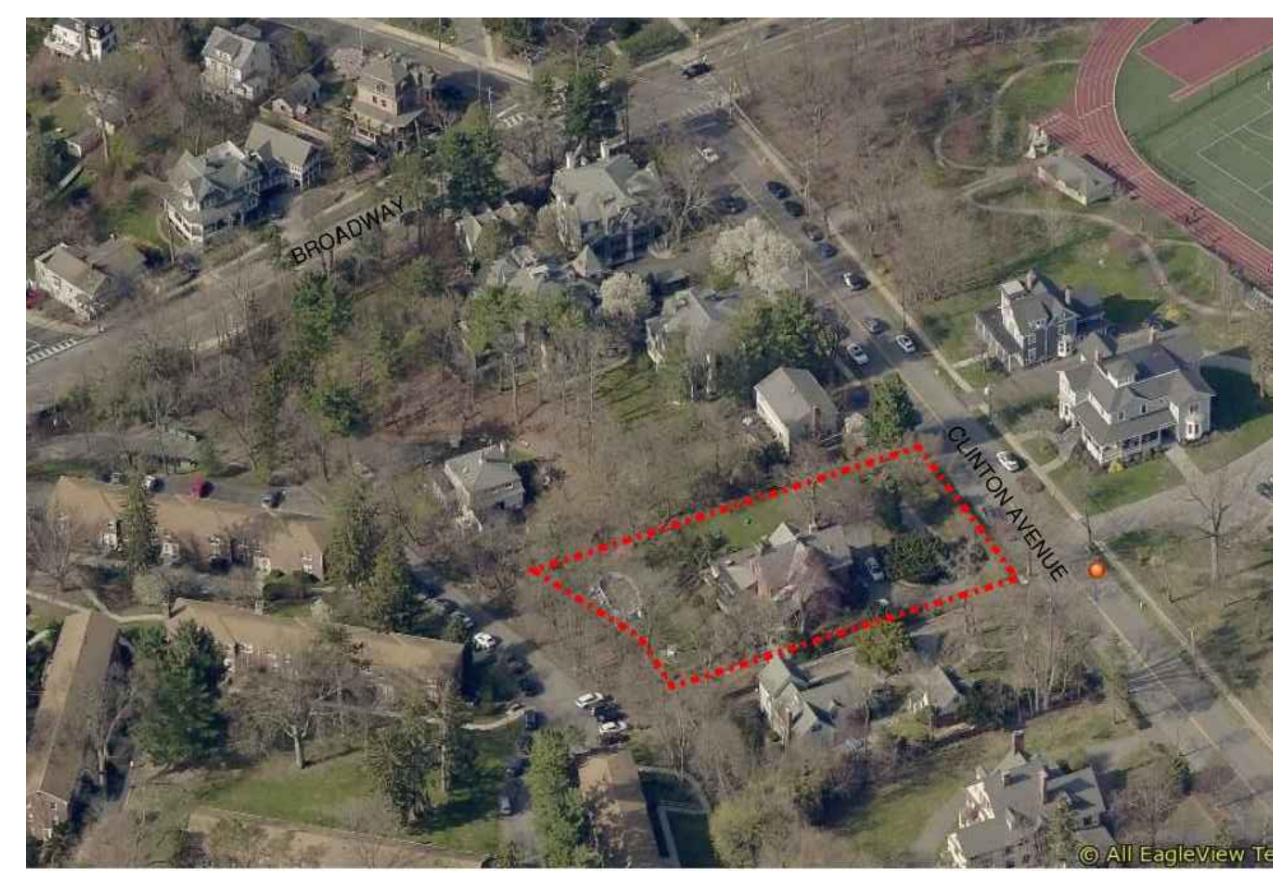

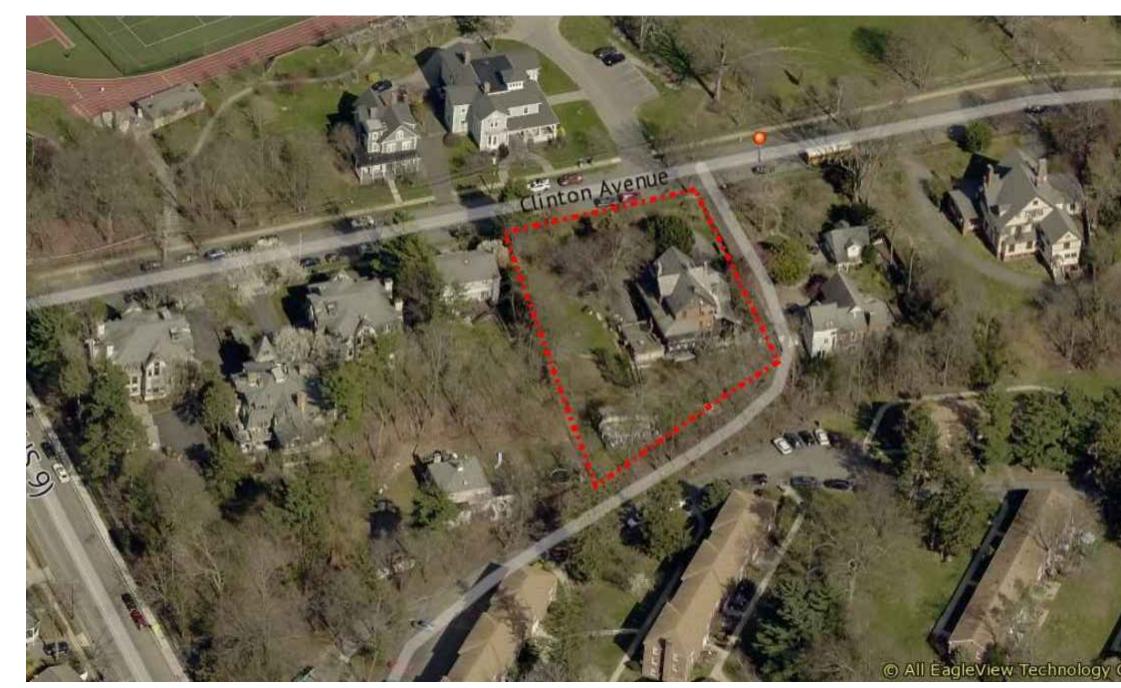

# CONTEXT BASED HEIGHT LIMITS

INCLUDES PROPERTIES WITHIN 200 FT. OF 34 CLINTON AVENUE				
	EAVE	RIDGE		
ADDRESS	HEIGHT (FT)	HEIGHT (FT)		
CLINTON AVENUE - WEST SIDE				
14-16 CLINTON AVENUE	29.75	47.00		
18 CLINTON AVENUE	26.75	37.50		
40 CLINTON AVENUE	20.25	36.50		
54 CLINTON AVENUE	23.75	47.08		
CLINTON AVENUE - EAST SIDE				
23 CLINTON AVENUE	20.83	40.25		
49 CLINTON AVENUE	24.58	38.75		
AVERAGE PREVAILING HEIGHT	24.32	41.18		
x MULTIPLIER PER ZONING CODE TABLE B-7	AVERAGE x 1.15	AVERAGE x 1.25		
CONTEXT-BASED PREVAILING HEIGHT	28	51		

PROPOSED FOR 34 CLINTON	26.4 FT	41.75 FT
MEASURED RELATIVE TO GRADE PLANE	TO MATCH EXIST.	TO MATCH EXIST.



12 SPRING STREET HASTINGS.on.HUDSON N.Y. 10706 914.478.0799 cg@cgastudio.com christinagriffinarchitect.com

# SENCES AT CLINTON AVENUE

Project Submitted

JILDING PERMIT SUBMISSION 11-7-22

LANNING BOARD SUBMISSION 12-13-22

LANNING BOARD SUBMISSION 1-19-23

PLITTINGS TO THE OF NEW YORK

Scale As Shown

Drawing Title


NEIGHBORHOOD CONTEXT


S-3B


# STREETSCAPE ELEVATIONS


SCALE: 1/32" = 1'-0"



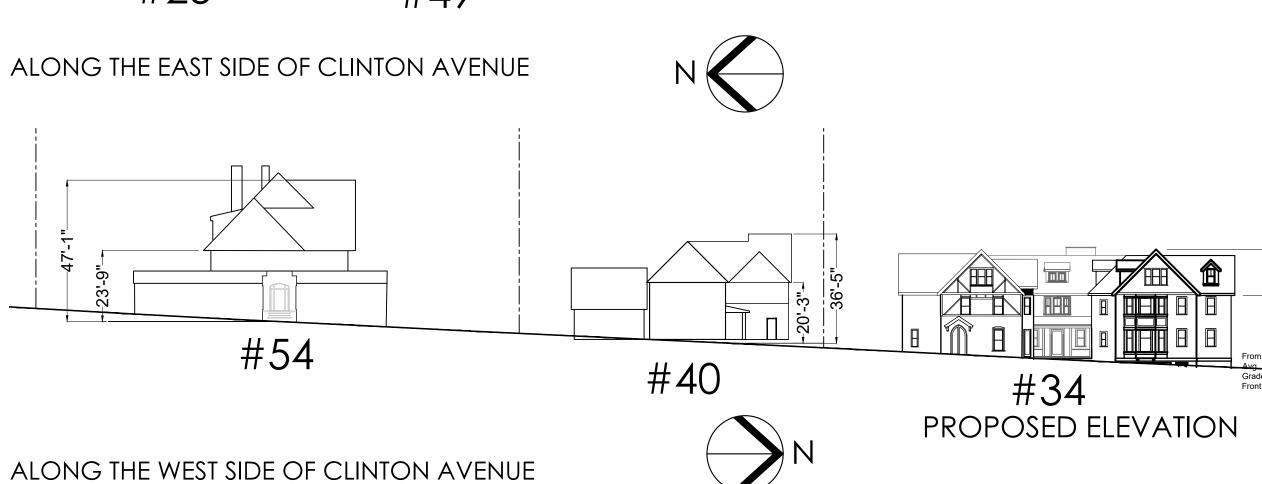

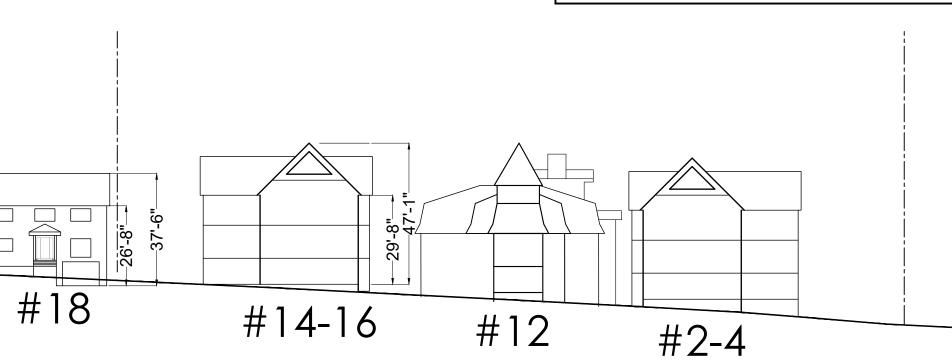

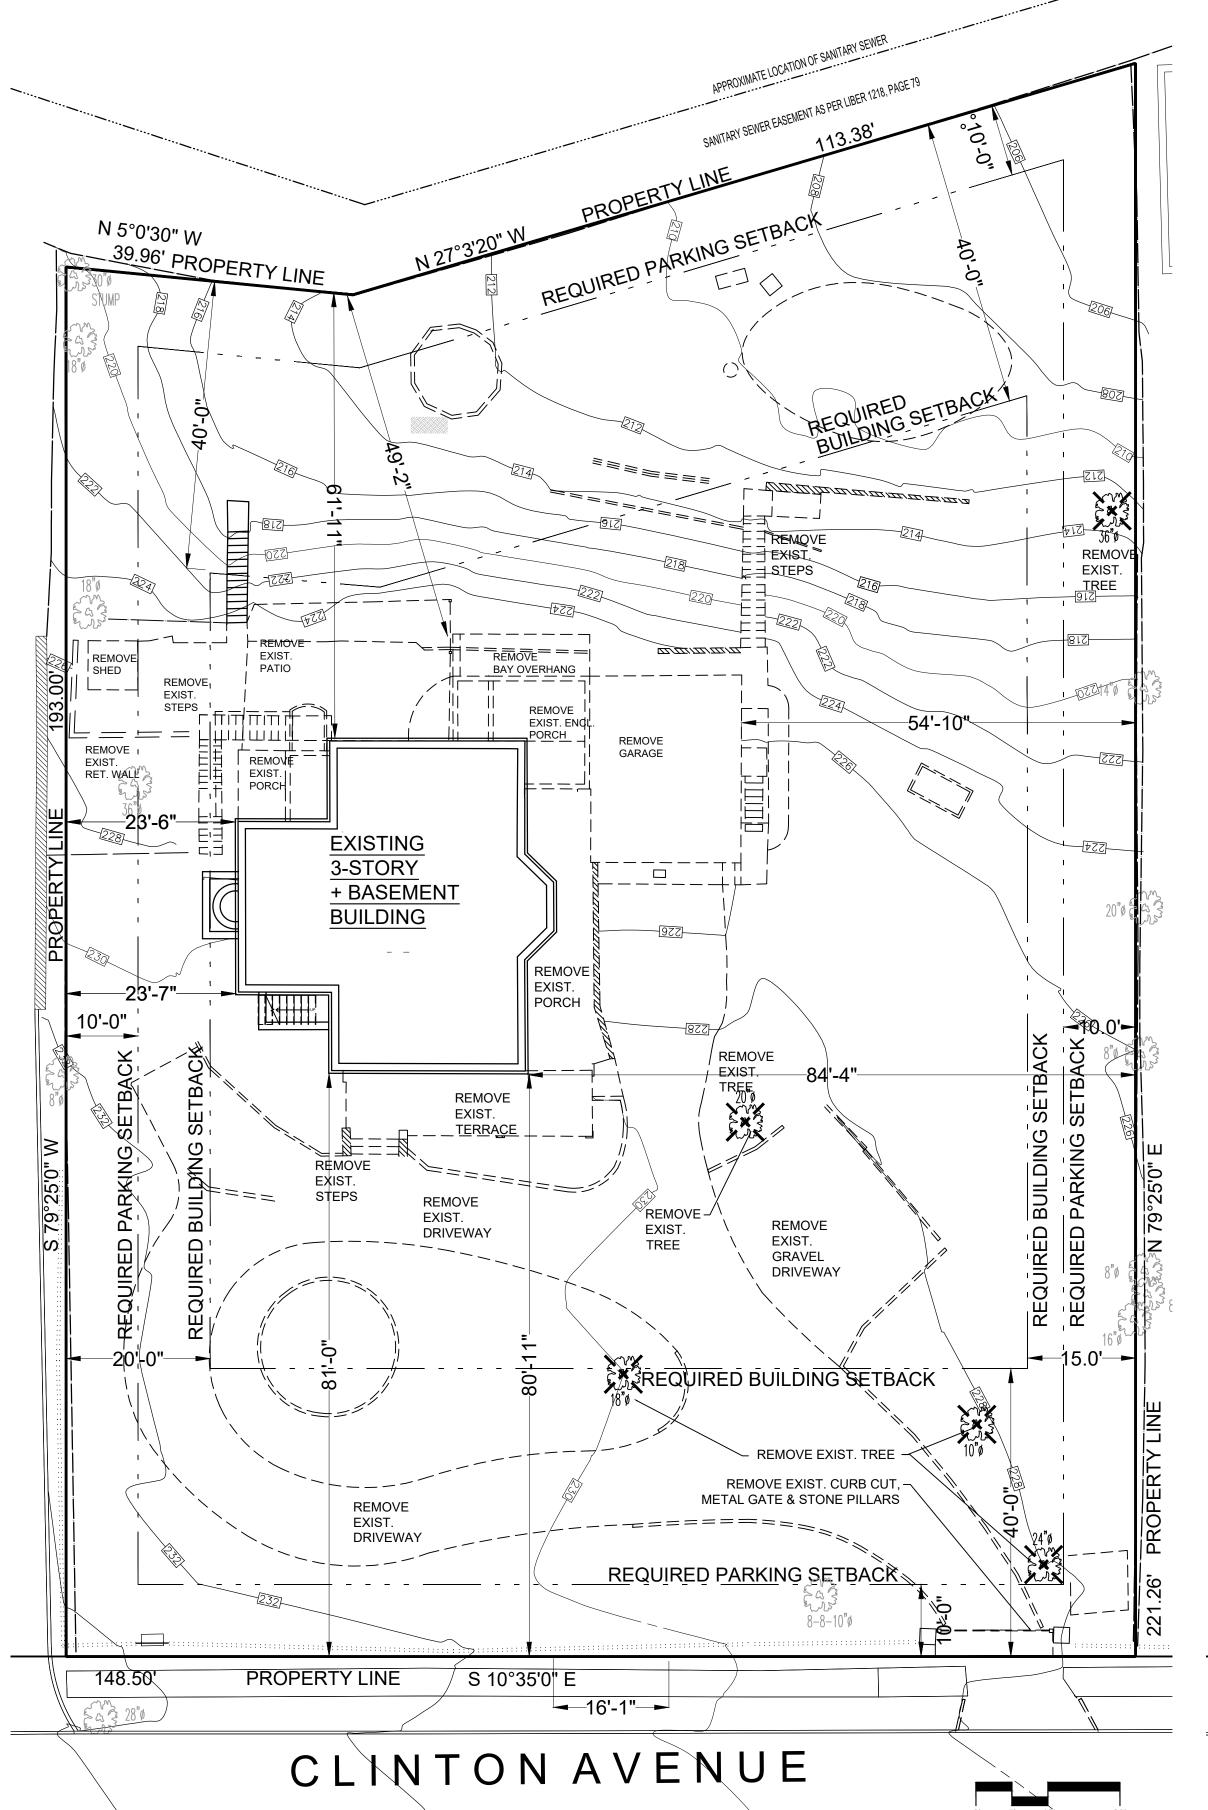

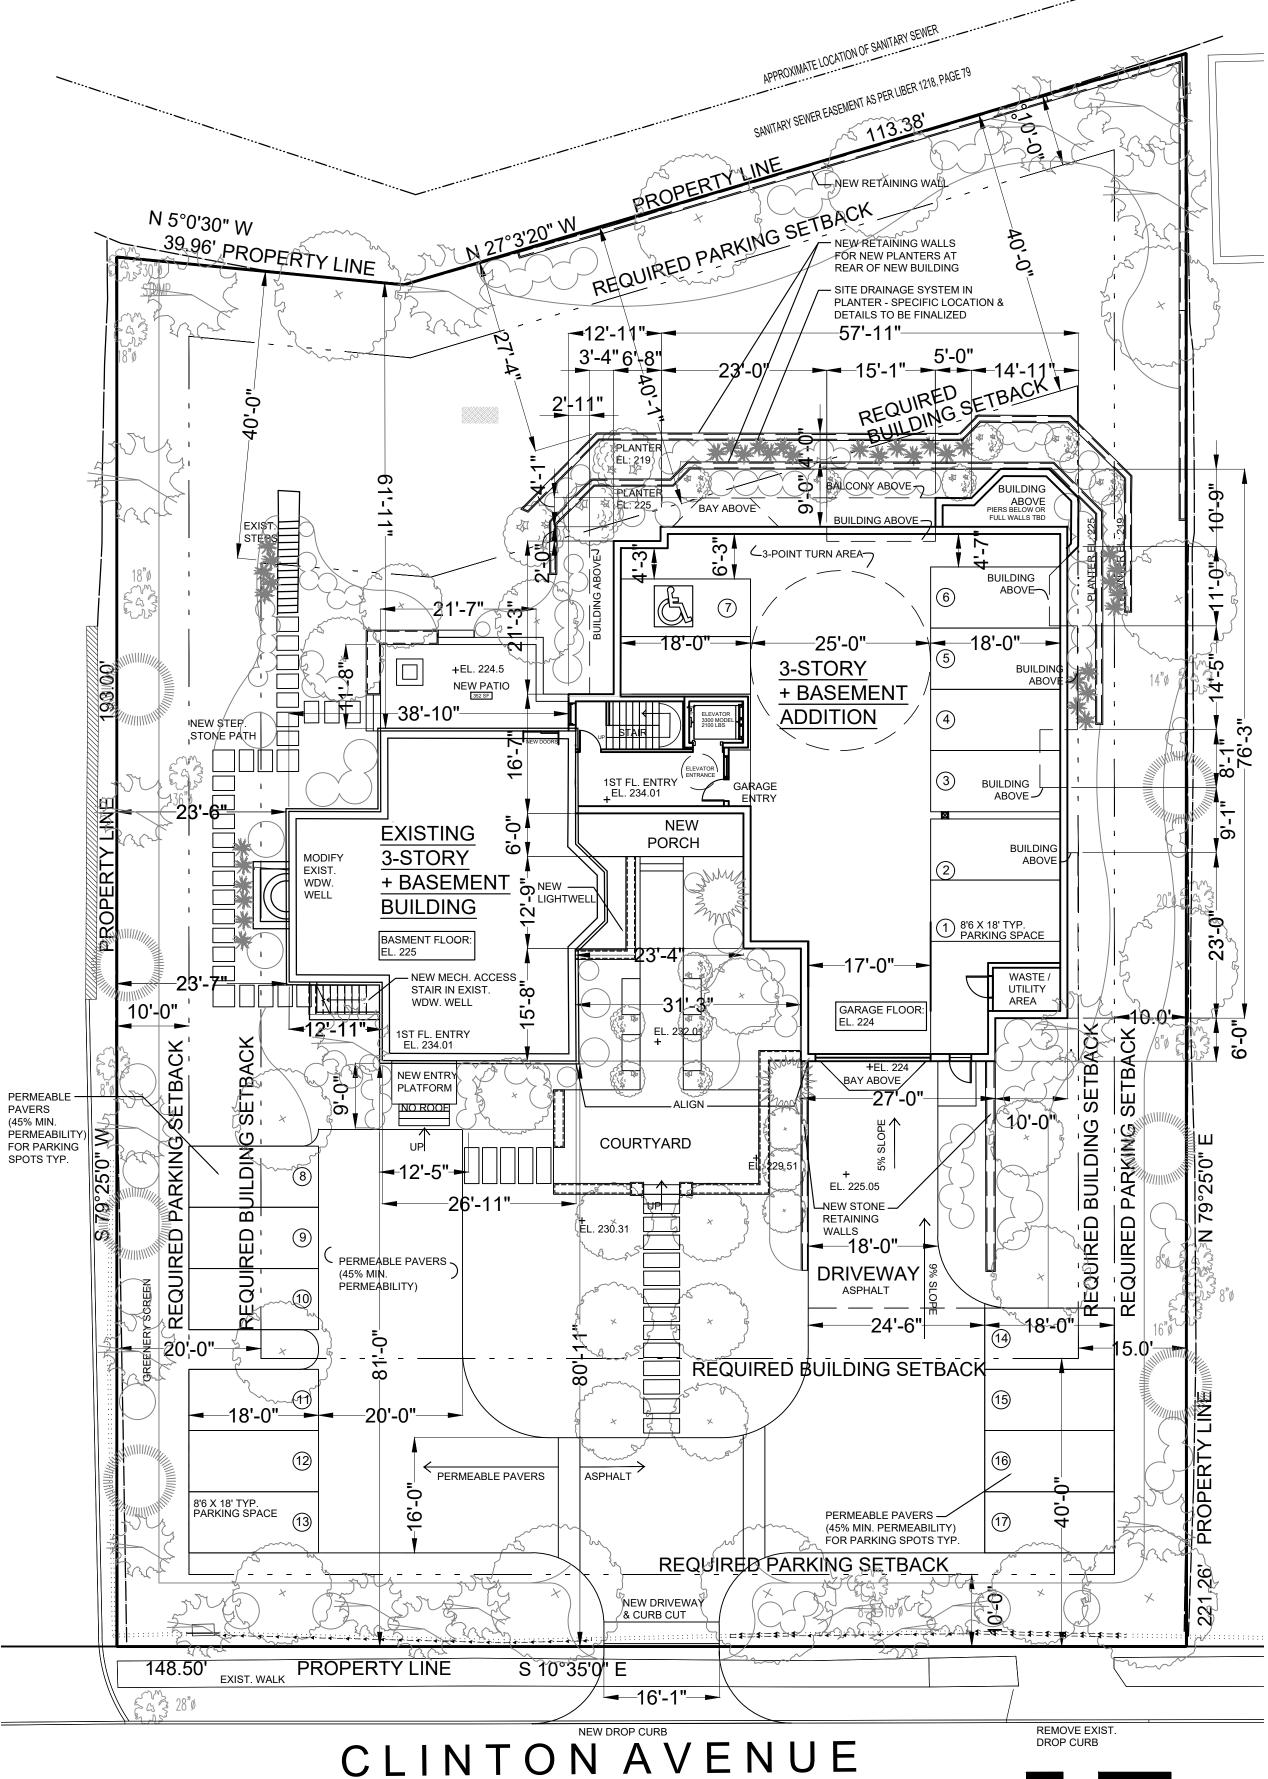

ARCHITECTS

12 SPRING STREET HASTINGS.on.HUDSON N.Y. 10706914.478.0799cg@cgastudio.comchristinagriffinarchitect.com

ARCHITECTS

12 SPRING STREET HASTINGS.on.HUDSON N.Y. 10706914.478.0799cg@cgastudio.comchristinagriffinarchitect.com

Project Submitted

BUILDING PERMIT SUBMISSION 11-7-22

PLANNING BOARD SUBMISSION 12-13-2

PLANNING BOARD SUBMISSION 12-13-2
PLANNING BOARD SUBMISSION 1-19-23



Scale As Shown
Drawing Title

S-4A

SITE PLAN

PROPOSED SITE PLAN

TOTAL BUILDING COVERAGE 2,412 8% **EXISTING IMPERVIOUS COVERAGE** DRIVEWAY 4,124 340 545 FRONT TERRACE+STEPS STEPS, WALK NEAR DECK & REAR STEPS 279 WALK & METAL STEPS TO SIDE PORCH 258 REAR PATIO 560 60 REAR STEPS DOWN TO REMAIN IMPERVIOUS COVERAGE 6,166 TOTAL IMPERVIOUS COVERAGE INCL. BUILDING 8,578 PROPOSED BUILDING COVERAGE 1,582 EXISTING BUILDING NEW COVERED PORCH AT MAIN ENTRY 138 4,291 BUILDING ADDITION (INCL. FRONT, REAR BAY & TOWER) 6,011 TOTAL BUILDING COVERAGE 20%

COVERAGE CALCULATIONS

1582

317

230

5,220

(1,330)

766

75

352

483

60

309 **5,935** 

11,946

39.9%

**EXISTING BUILDING COVERAGE** 

EXISTING COVERED SIDE PORCH

PROPOSED IMPERVIOUS COVERAGE

PERMEABLE PAVERS (SEE SITE PLAN)

NEW FRONT ENTRY PLATFORM

NEW REAR PATIO (FOR UNIT 1)

IMPERVIOUS COVERAGE

REAR STEPS (EXIST. TO REMAIN)
NEW STEPPING STONES PATH

NEW COURTYARD

RETAINING WALLS

NEW DRIVEWAY & OUTDOOR PARKING SPOTS

DEDUCT 45% OF 2,955 SF AREA PAVED WITH

TOTAL IMPERVIOUS COVERAGE INCL. BUILDING

SIDE ONE-STORY PORTION + ROOFED PORCH

REAR ONE-STORY PORTION

EXISTING BUILDING

REAR OVERHANG

DEMOLITION SITE PLAN

SHOWING TOPOGRAPHY

N 5°0'30" 39.96' PAD PAD. SAND AREA <u>OVERHANG</u> SHED STEPS TITE PLAT WOOD DECK 2½ STORY BRICK AND FRAME WALK TAX LOT TERRACE SETBACK DRIVEWAY BUILDING REQ REQ BUILDING SETBACK WALK WALK S 1/0°35'0" E 148.50 DROP CURB CB <u>l=227.9</u> 16"ø PIPE APPROXIMATE LOCATION O

N 5°0'30" W
39.96' PROPERTY LINE 35%++ 283 S.F. 35%++ 1068 S.F 3-STORY + BASEMENT ADDITION NEW PORCH **EXISTING** 3-STORY + BASEMENT **BUILDING** 1 8'6 X 18' TYP. PARKING SPACE NEW ENTRY PLATFORM COURTYARD DRIVEWAY ŘEQUIRED BUĪLDING SETBACK PARKING AREA 8'6 X 18' TYP. PARKING SPACE REQUIRED PARKING SETBACK S 10°35'0" E 148.50' PROPERTY LINE CLINTON AVENUE

GGA Studio ARCHITECTS

12 SPRING STREET HASTINGS.on.HUDSON N.Y. 10706 914.478.0799 cg@cgastudio.com christinagriffinarchitect.com

ZENUE VENUE

RESIDENCES AT

34 CLINTON A

POBBS FERRY, NEW YORK 10522

Project Submitted

BUILDING PERMIT SUBMISSION 11-7-22

PLANNING BOARD SUBMISSION 12-13-2

PLANNING BOARD SUBMISSION 12-13
PLANNING BOARD SUBMISSION 1-19-2

SETBACK

REQUIRED BUILDING S REQUIRED PARKING S



Scale As Shown

Drawing Title

S-4B

SITE PLAN

PROPOSED SITE PLAN

SHOWING STEEP SLOPES

EXISTING SITE PLAN

SHOWING STEEP SLOPES

DRAIN LINE

TOTAL AREA OF SLOPES

AREA OF SLOPES OVER 35%

DISTURBED BY BUILDING:

TOTAL DISTURBANCE OF

SLOPES OVER 35% TO BE

STEEP SLOPE CALCULATIONS

1,923 SF

1,505 SF

1,724 SF

1,140 SF

901 SF

568 SF

LESS THAN 1,500 SF

[ONLY COUNTING AREAS 150 SF OR MORE]

[ONLY COUNTING AREAS 150 SF OR MORE]

[ONLY COUNTING AREAS 150 SF OR MORE]

**BUILDING OVERLAP WITH SLOPES OVER** 

BUILDING OVERLAP WITH SLOPES OVER

BUILDING OVERLAP WITH SLOPES OVER

AREA OF SLOPES OVER 25% (25-35%)


AREA OF SLOPES OVER 15% (15-25%)

AREA OF SLOPES OVER 35%

OVER 35% ON SITE:

1,923 SF

1,140 SF

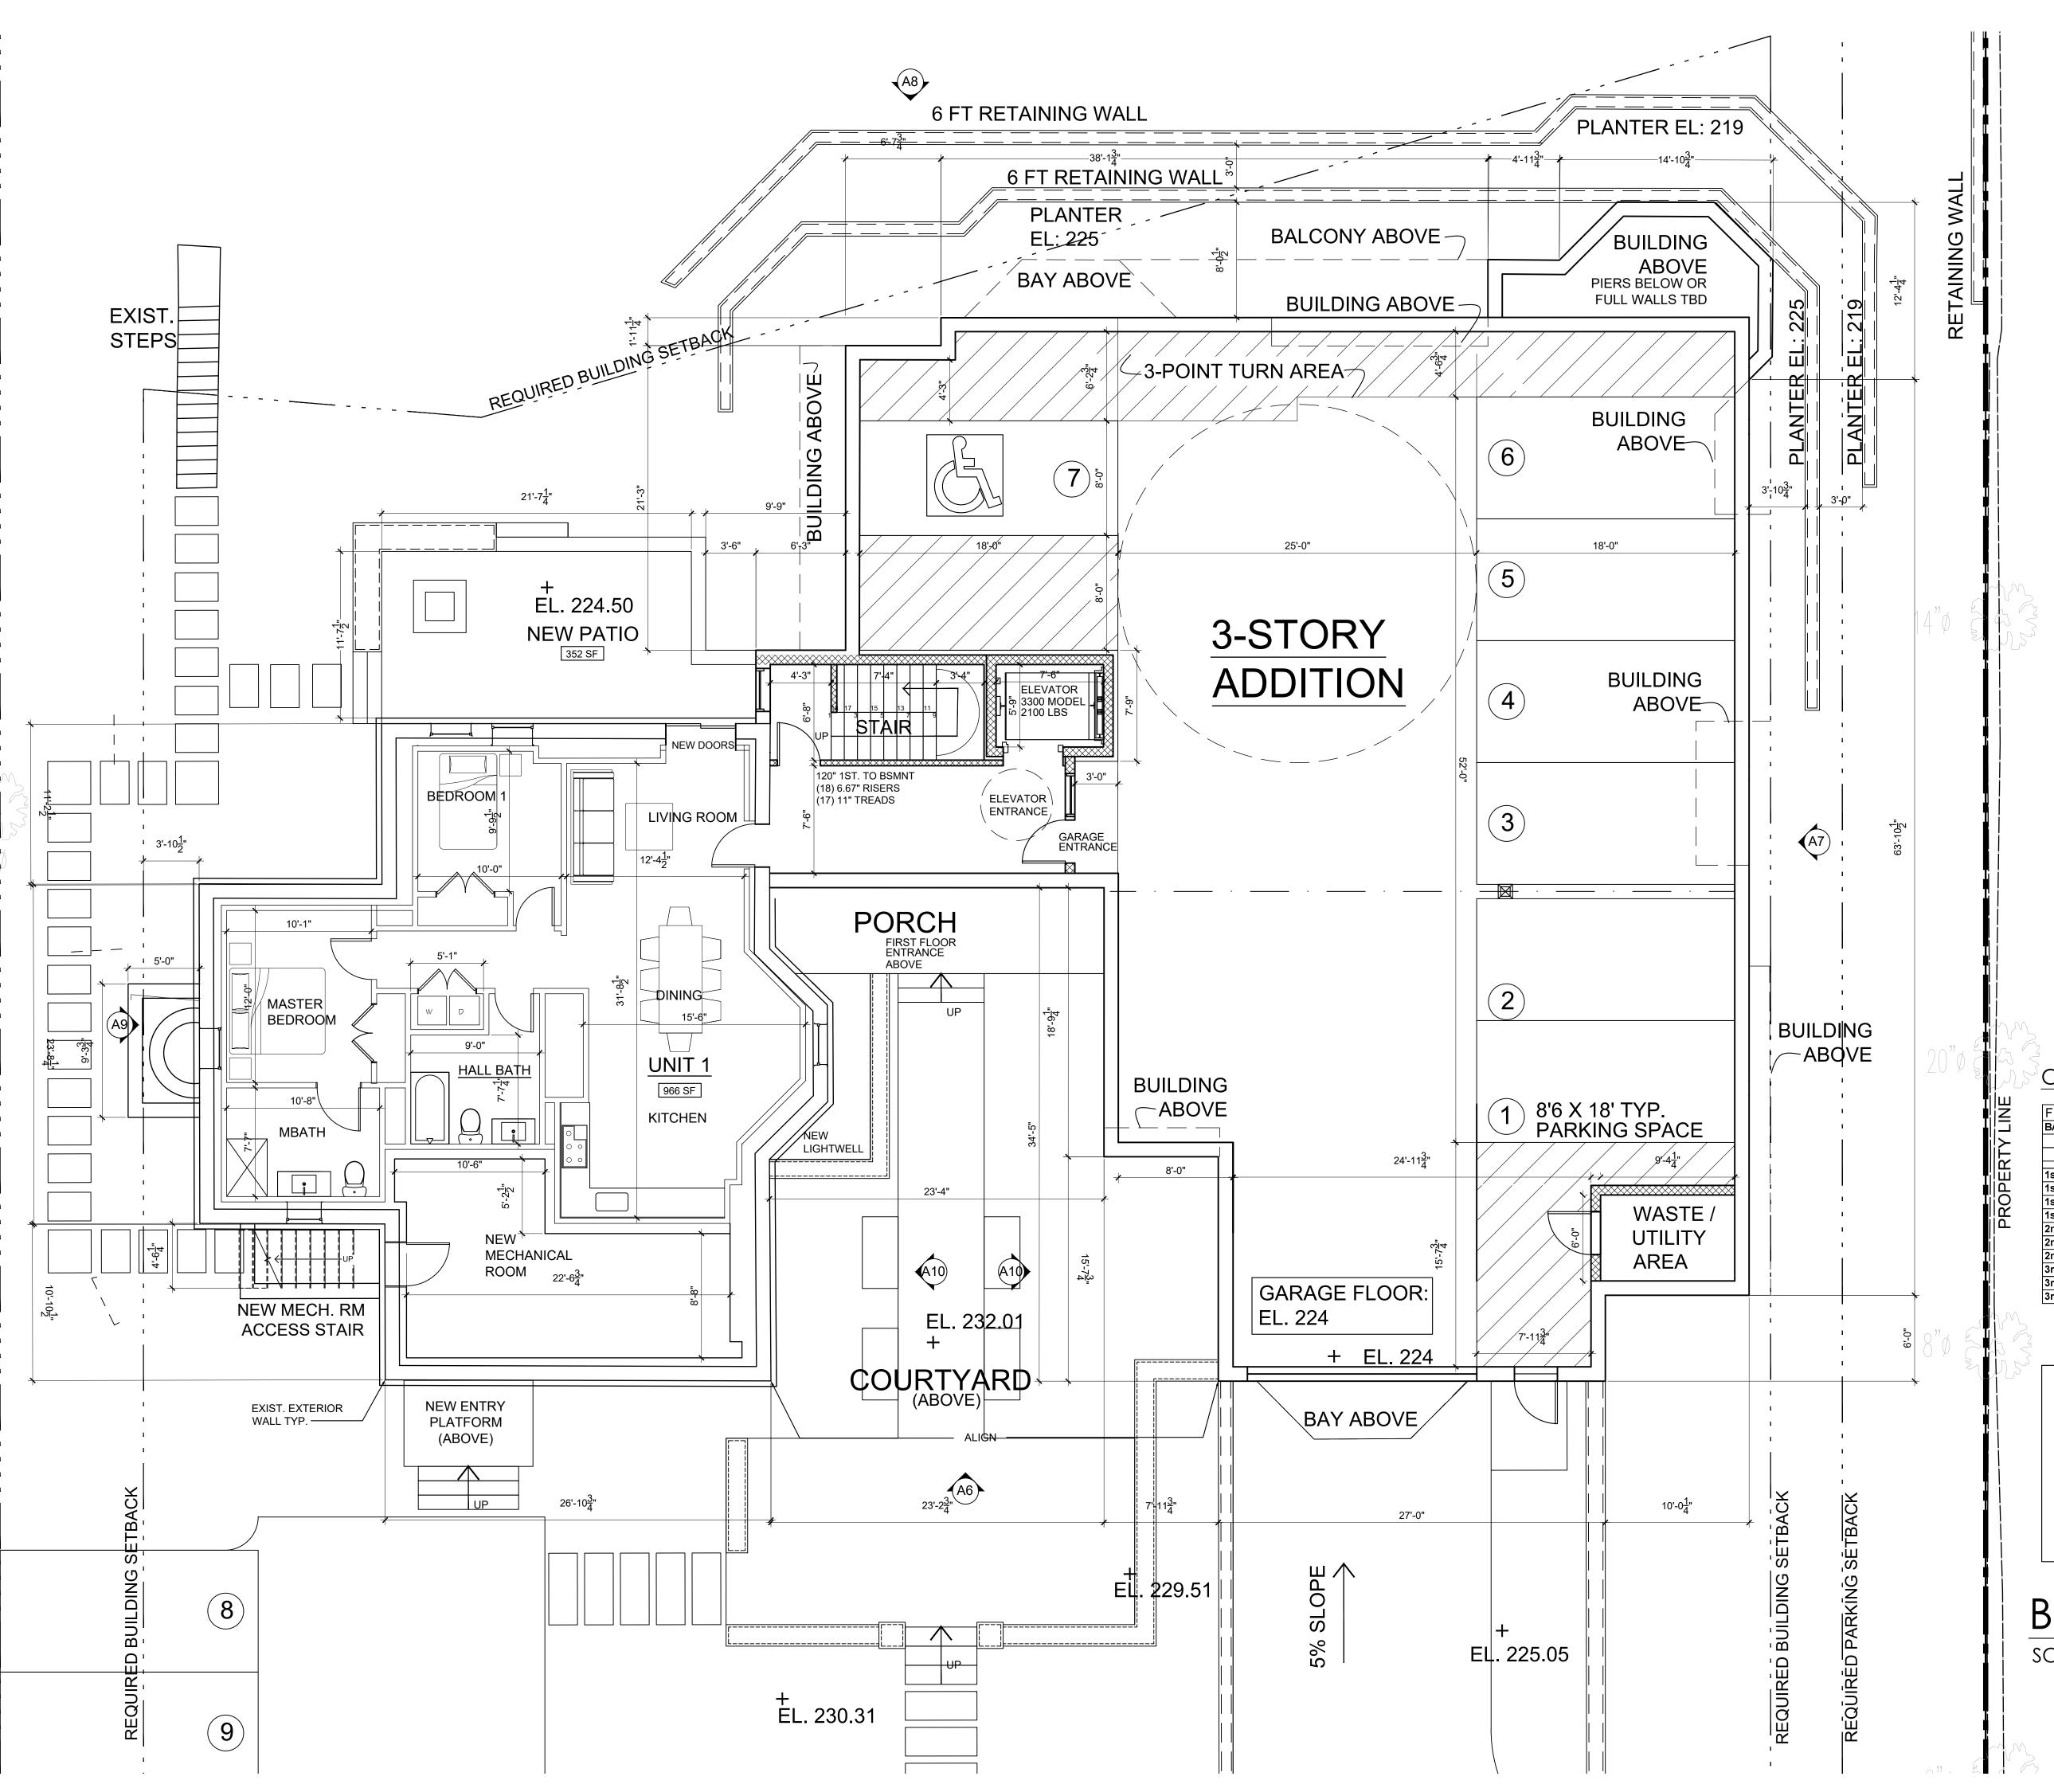



12 SPRING STREET HASTINGS.on.HUDSON N.Y. 10706 914.478.0799 cg@cgastudio.com christinagriffinarchitect.com

# FNUE

RESIDENCES AT

34 CLINTON AV

DOBBS FERRY, NEW YORK 10522

Project Submitted

BUILDING PERMIT SUBMISSION 11-7-22

PLANNING BOARD SUBMISSION 12-13-2

PLANNING BOARD SUBMISSION 1-19-23

CHART OF RESIDENTIAL UNITS

FLOOR	UNIT#	DESCRIPTION	SF
BASEMENT	UNIT 1	2BR AFFORDABLE	966
		UNIT 1 PATIO	352
	UNIT 1 INCLUDING 1	/3 PATIO SF	1,083
1st FLOOR	UNIT 2	2BR	1,365
1st FLOOR	UNIT 3	2BR	1,330
1st FLOOR	UNIT 4	2BR	1,295
1st-2nd FLOOR	UNIT 5	2BR DUPLEX	1,506
2nd FLOOR	UNIT 6	2BR	1,365
2nd FLOOR	UNIT 7	2BR	1,330
2nd FLOOR	UNIT 8	2BR	1,295
3rd FLOOR	UNIT 9	2BR	1,016
3rd FLOOR	UNIT 10	2BR	1,361
3rd FLOOR	UNIT 11	2BR	1,513
	AVERAGE MARKET	1,338	
	80% AVERAGE MAR	1,070	

EXISTING BUILDING: UNIT 1 (AFFORDABLE 2BR): 966 SF & 350 SF TERRACE

PROPOSED BUILDING: 7 PARKING SPOTS INCLUDING 1 ADA COMPLIANT

BASEMENT PLAN

SCALE: 3/16" = 1'-0"






Scale As Shown

Drawing Title

BASEMENT FLOOR PLAN

A-1

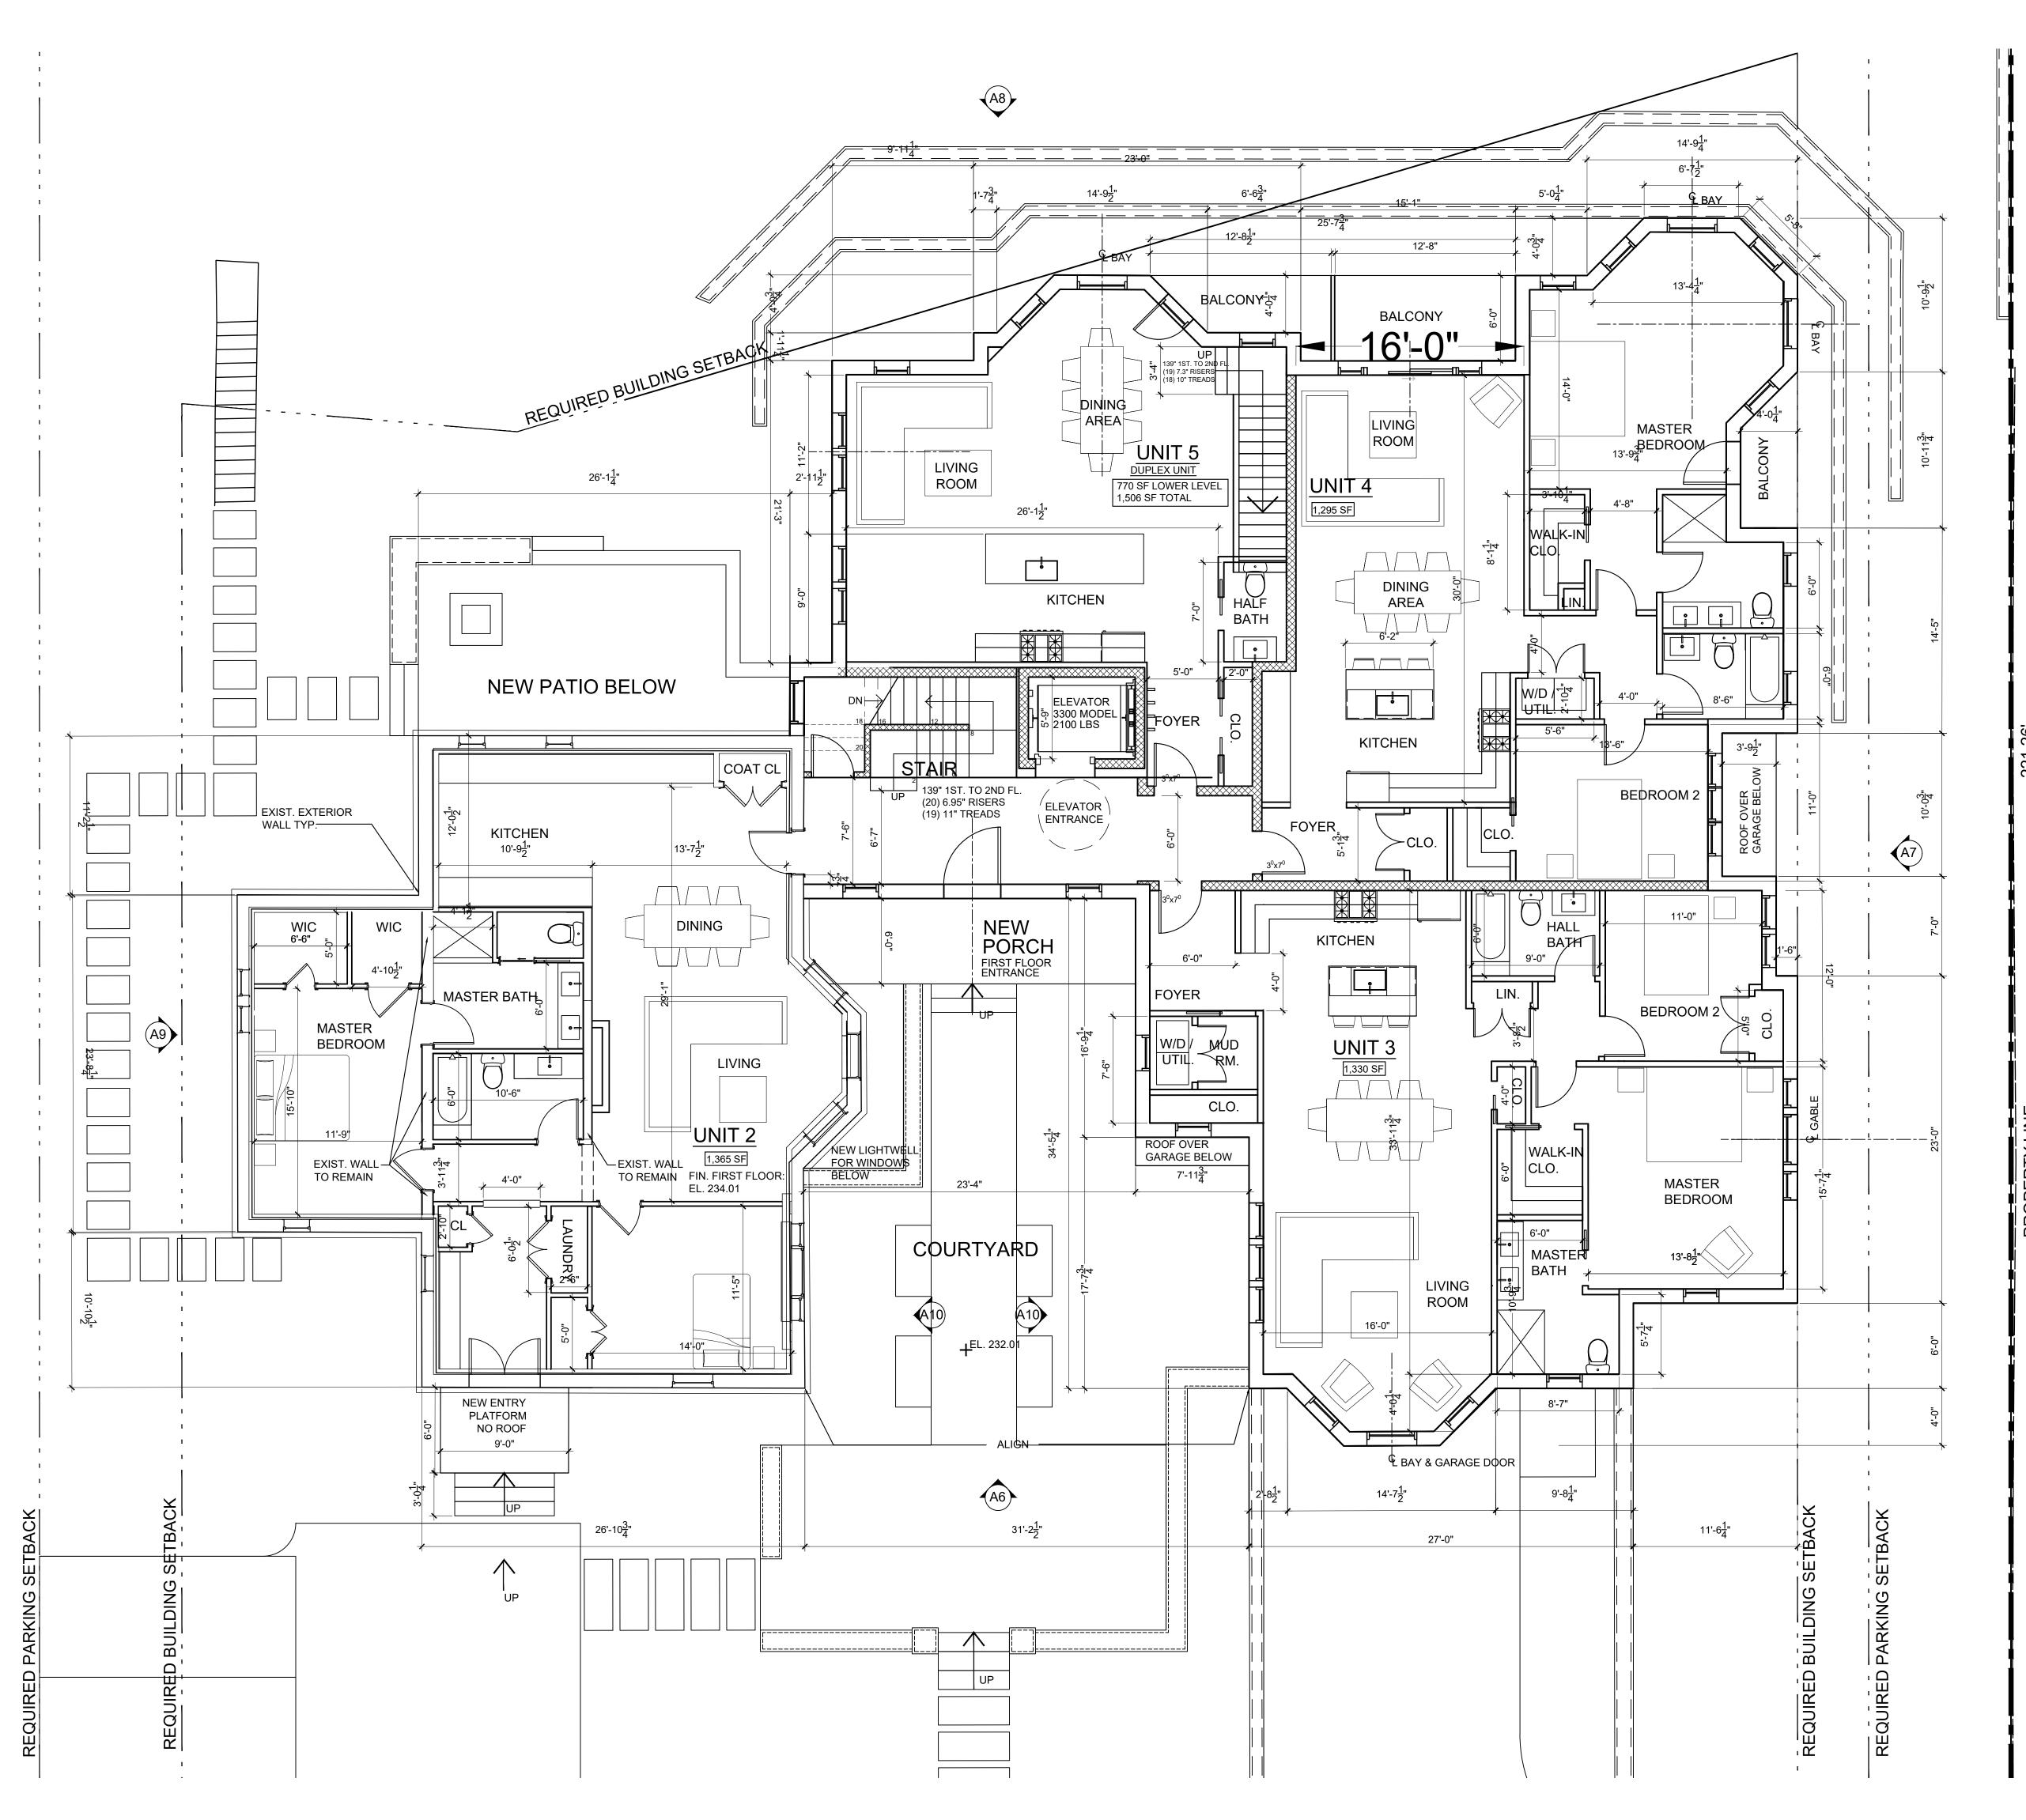



12 SPRING STREET HASTINGS.on.HUDSON N . Y . 1 0 7 0 6 9 1 4 . 4 7 8 . 0 7 9 9 cg@cgastudio.com

# cg@cgastudio.com christinagriffinarchitect.com

RESIDENCES AT

34 CLINTON AVEN

Project Submitted

BUILDING PERMIT SUBMISSION 11-7-22

PLANNING BOARD SUBMISSION 12-13-2

PLANNING BOARD SUBMISSION 1-19-23

CHART OF RESIDENTIAL UNITS

CHART	JI KLJIDLI	INTIAL OTHER	<u> </u>
FLOOR	UNIT#	DESCRIPTION	SF
BASEMENT	UNIT 1	2BR AFFORDABLE	96
		UNIT 1 PATIO	35
	UNIT 1 INCLUDING 1	/3 PATIO SF	1,08
1st FLOOR	UNIT 2	2BR	1,36
1st FLOOR	UNIT 3	2BR	1,33
1st FLOOR	UNIT 4	2BR	1,29
1st-2nd FLOOR	UNIT 5	2BR DUPLEX	1,50
2nd FLOOR	UNIT 6	2BR	1,36
2nd FLOOR	UNIT 7	2BR	1,33
2nd FLOOR	UNIT 8	2BR	1,29
3rd FLOOR	UNIT 9	2BR	1,01
3rd FLOOR	UNIT 10	2BR	1,36
3rd FLOOR	UNIT 11	2BR	1,51
	AVERAGE MARKET	RATE UNIT	1,33
	80% AVERAGE MAR	RKET RATE UNIT	1,07

EXISTING BUILDING: UNIT 2: 1,365 SF

PROPOSED BUILDING:
UNIT 3: 1,330 SF
UNIT 4: 1,295 SF
UNIT 5 (DUPLEX): 1,506 SF TOTAL
770 SF THIS FLOOR

FIRST FLOOR PLAN


SCALE: 3/16" = 1'-0"





Drawing Title

A-2

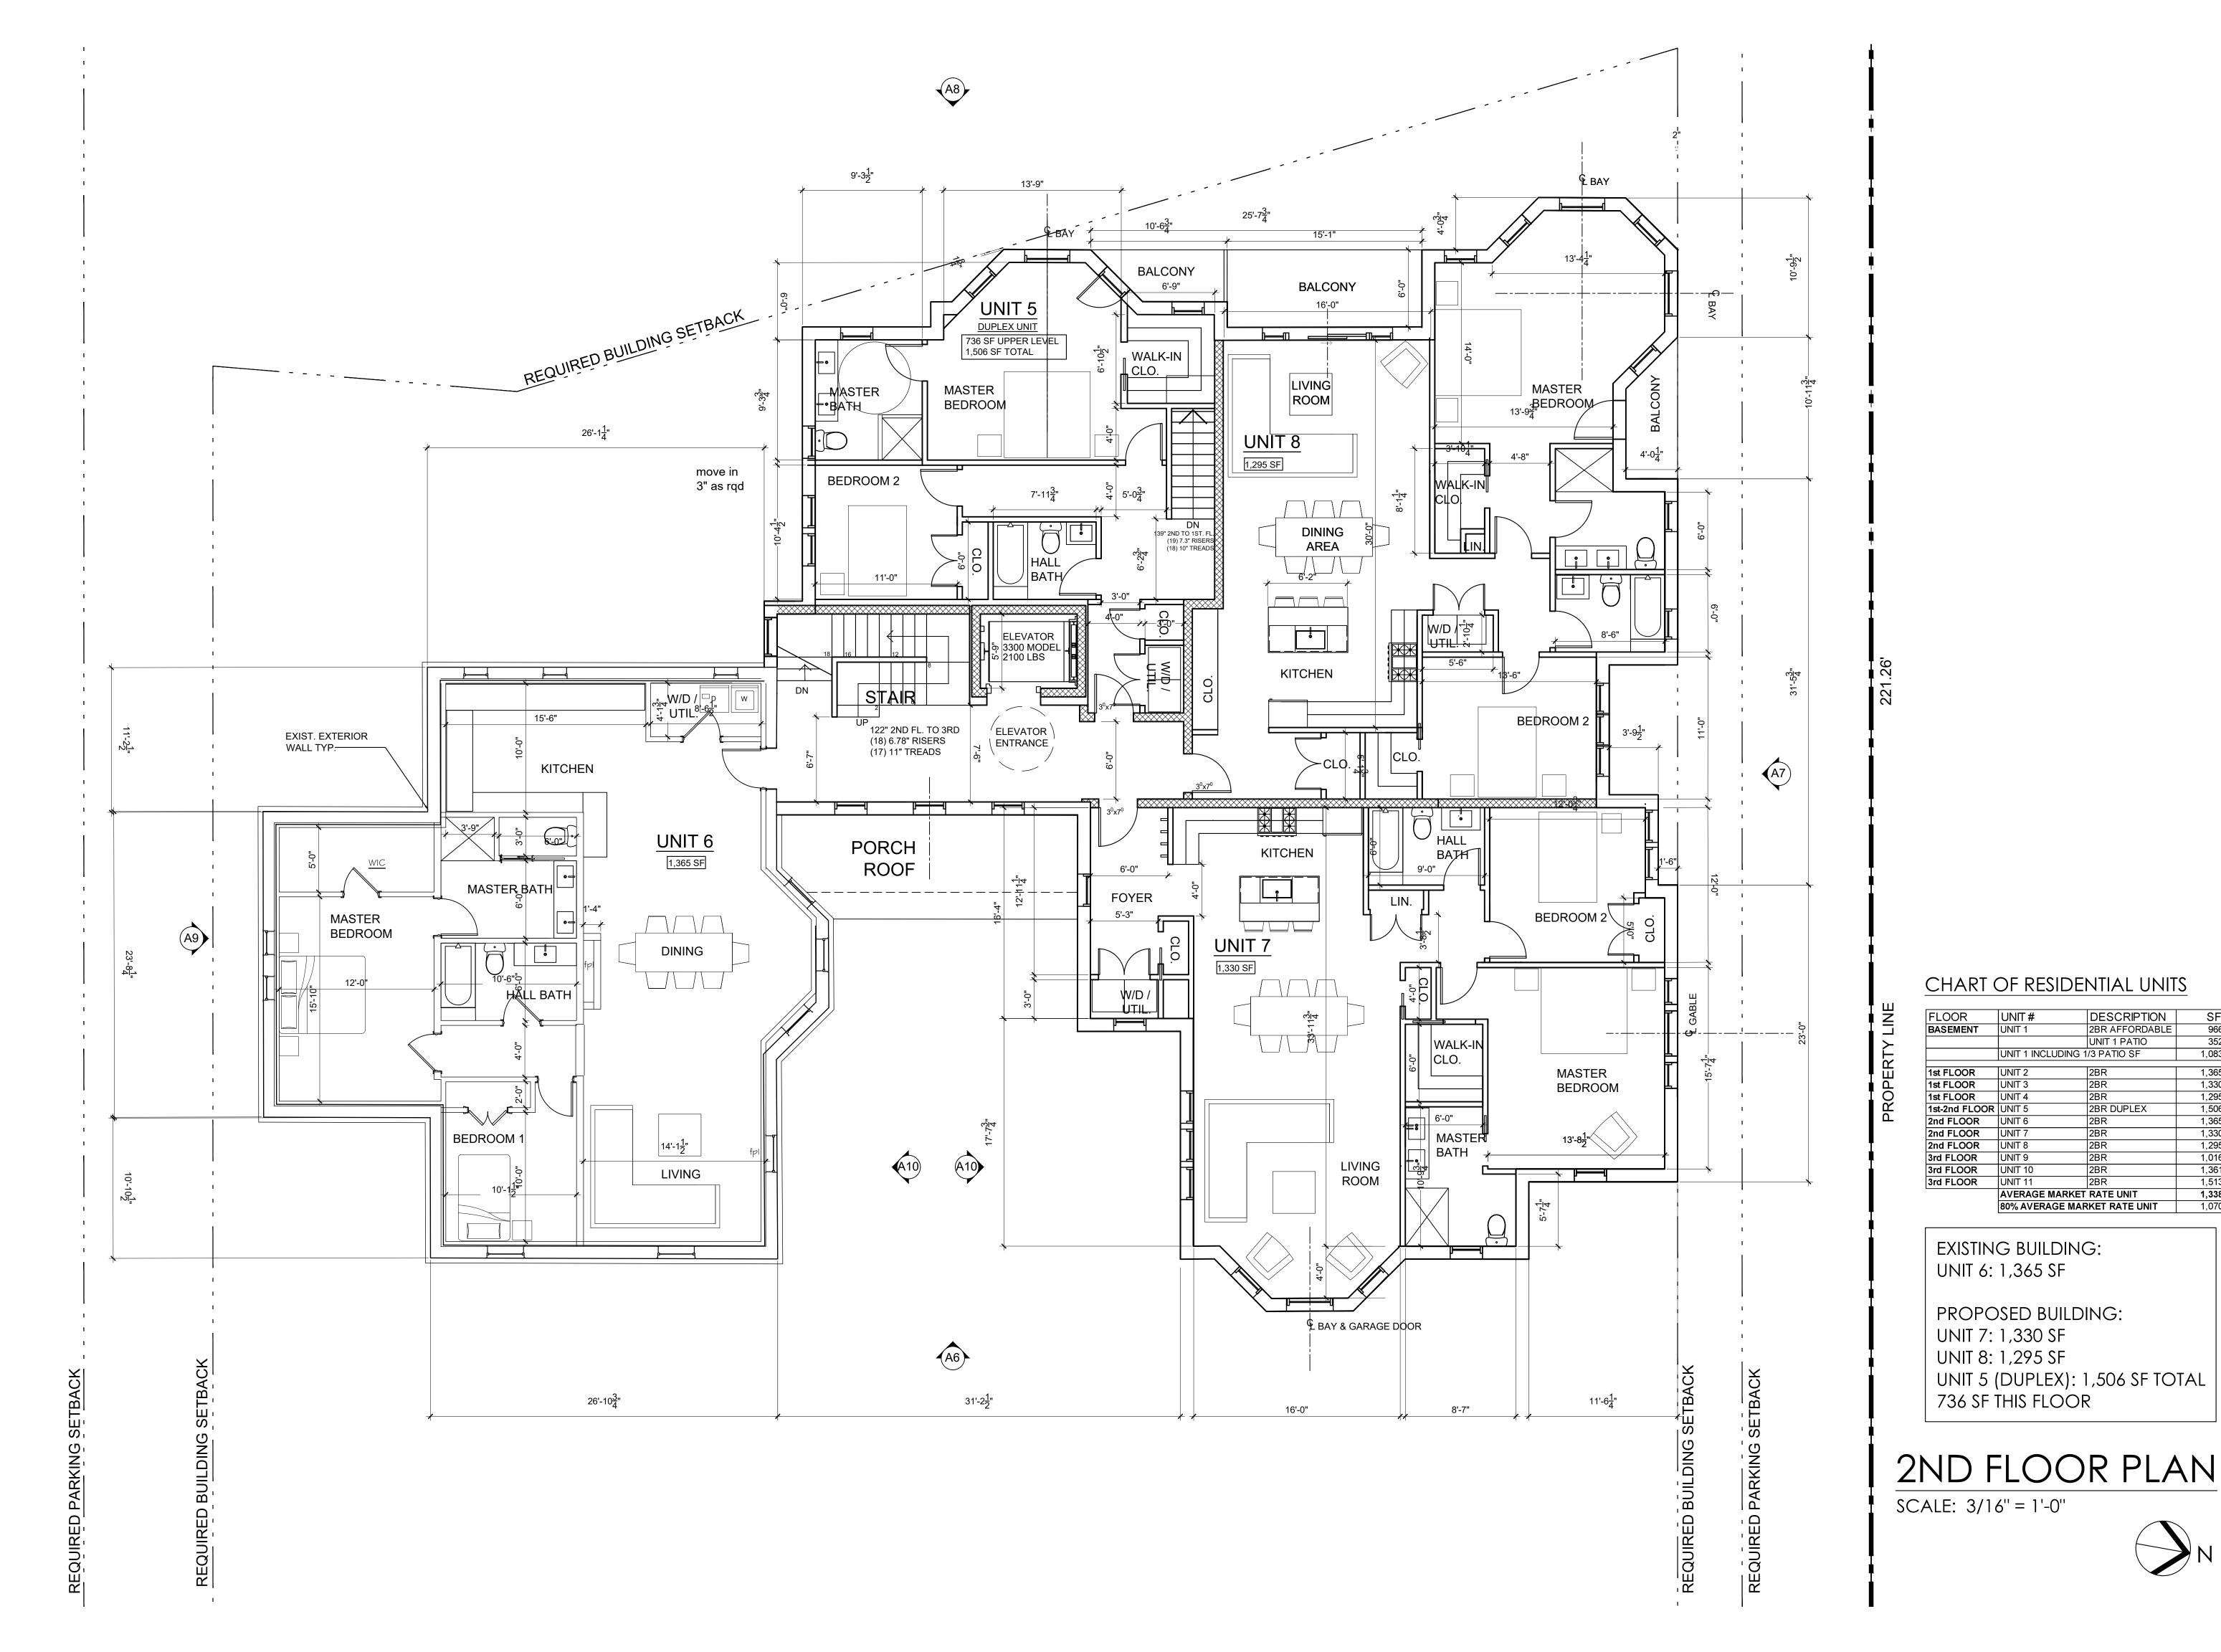

ARCHITECTS

12 SPRING STREET HASTINGS.on.HUDSON N.Y. 10706 914.478.0799 cg@cgastudio.com

christinagriffinarchitect.com

**以**の Project Submitted

UNIT # DESCRIPTION
UNIT 1 2BR AFFORDABLE
UNIT 1 PATIO
UNIT 1 INCLUDING 1/3 PATIO SF

AVERAGE MARKET RATE UNIT

80% AVERAGE MARKET RATE UNIT

2BR DUPLEX

1,506

1,295

UNIT #

EXISTING BUILDING:

PROPOSED BUILDING:

UNIT 5 (DUPLEX): 1,506 SF TOTAL

UNIT 6: 1,365 SF

UNIT 7: 1,330 SF

UNIT 8: 1,295 SF

736 SF THIS FLOOR

BUILDING PERMIT SUBMISSION 11-7-22 PLANNING BOARD SUBMISSION 12-13-2

As Shown Drawing Title

SECOND FLOOR PLAN

12 SPRING STREET HASTINGS.on.HUDSON N.Y. 10706 914.478.0799 cg@cgastudio.com

christinagriffinarchitect.com

Project Submitted

BUILDING PERMIT SUBMISSION 11-7-22 LANNING BOARD SUBMISSION 12-13-2 PLANNING BOARD SUBMISSION 1-19-23

EXISTING BUILDING: UNIT 9: 1,016 SF

PROPOSED BUILDING: UNIT 10: 1,361 SF UNIT 11: 1,513 SF

3RD FLOOR PLAN SCALE: 3/16" = 1'-0"



As Shown Drawing Title THIRD FLOOR PLAN



of Residei	NTIAL UNITS	;
		_
UNIT#	DESCRIPTION	- ;
UNIT 1	2BR AFFORDABLE	
	UNIT 1 PATIO	
UNIT 1 INCLUDING 1	/3 PATIO SF	1,
LINIT O	lann I	- 1
		1,
JUNIT 3	2BR	1,
UNIT 4	2BR	1,
UNIT 5	2BR DUPLEX	1,
UNIT 6	2BR	1,
UNIT 7	2BR	1,
UNIT 8	2BR	1,
UNIT 9	2BR	1,
UNIT 10	2BR	1,
UNIT 11	2BR	1,
AVERAGE MARKET	RATE UNIT	1,
80% AVERAGE MAR	RKET RATE UNIT	1,
	UNIT # UNIT 1 UNIT 1 INCLUDING 1 UNIT 2 UNIT 3 UNIT 4 UNIT 5 UNIT 6 UNIT 7 UNIT 8 UNIT 9 UNIT 10 UNIT 11 AVERAGE MARKET	UNIT 1



12 SPRING STREET HASTINGS.on.HUDSON N.Y. 10706 914.478.0799 cg@cgastudio.com christinagriffinarchitect.com

RESIDENCES
34 CLINTOI
DOBBS FERRY, NEW YOR

BUILDING PERMIT SUBMISSION 11-7-22
PLANNING BOARD SUBMISSION 12-13-22
PLANNING BOARD SUBMISSION 1-19-23

Project Submitted



Scale As Shown

Drawing Title

ROOF PLAN

A-5

ROOF PLAN

SCALE: 3/16" = 1'-0"

# GGA Studio ARCHITECTS

12 SPRING STREET HASTINGS.on.HUDSON N.Y. 10706 914.478.0799 cg@cgastudio.com christinagriffinarchitect.com

ES AT
ON AVENUE

Sago Submitted Submitted

PLANNING BOARD SUBMISSION 11-7-22
PLANNING BOARD SUBMISSION 12-13-22
PLANNING BOARD SUBMISSION 1-19-23

RED ARCHAMAR CHAMAR CHA

Scale As Shown

Drawing Title

ELEVATIONS

A-6

eet Number

EAST ELEVATION

SCALE: 3/16" = 1'-0"



# NORTH ELEVATION

SCALE: 3/16" = 1'-0"



12 SPRING STREET HASTINGS.on.HUDSON N.Y. 10706 914.478.0799 cg@cgastudio.com christinagriffinarchitect.com

BUILDING PERMIT SUBMISSION 11-7-2
LANNING BOARD SUBMISSION 12-13-

Project Submitted

PLANNING BOARD SUBMISSION 1-19-23



As Shown Drawing Title **ELEVATIONS** 



WEST ELEVATION

SCALE: 3/16" = 1'-0"

# CGA Studio ARCHITECTS

12 SPRING STREET HASTINGS.on.HUDSON N.Y. 10706 914.478.0799 cg@cgastudio.com christinagriffinarchitect.com

# RESIDENCES AT 34 CLINTON AVENUE

BUILDING PERMIT SUBMISSION 11-7-22
PLANNING BOARD SUBMISSION 12-13-22
PLANNING BOARD SUBMISSION 1-19-23

Project Submitted

MUNICIPAL TO NEW 102

Scale As Shown

Drawing Title

ELEVATIONS

A-8

Sheet Number



GGA Studio ARCHITECTS

12 SPRING STREET HASTINGS.on.HUDSON N.Y. 10706 914.478.0799 cg@cgastudio.com christinagriffinarchitect.com

# RESIDENCES AT 34 CLINTON AVENUE Broject Snippel

PLANNING BOARD SUBMISSION 11-7-22
PLANNING BOARD SUBMISSION 12-13-22
PLANNING BOARD SUBMISSION 1-19-23





Scale As Shown
Drawing Title

ELEVATIONS EXISTING BUILDING

A-9

Sheet Number

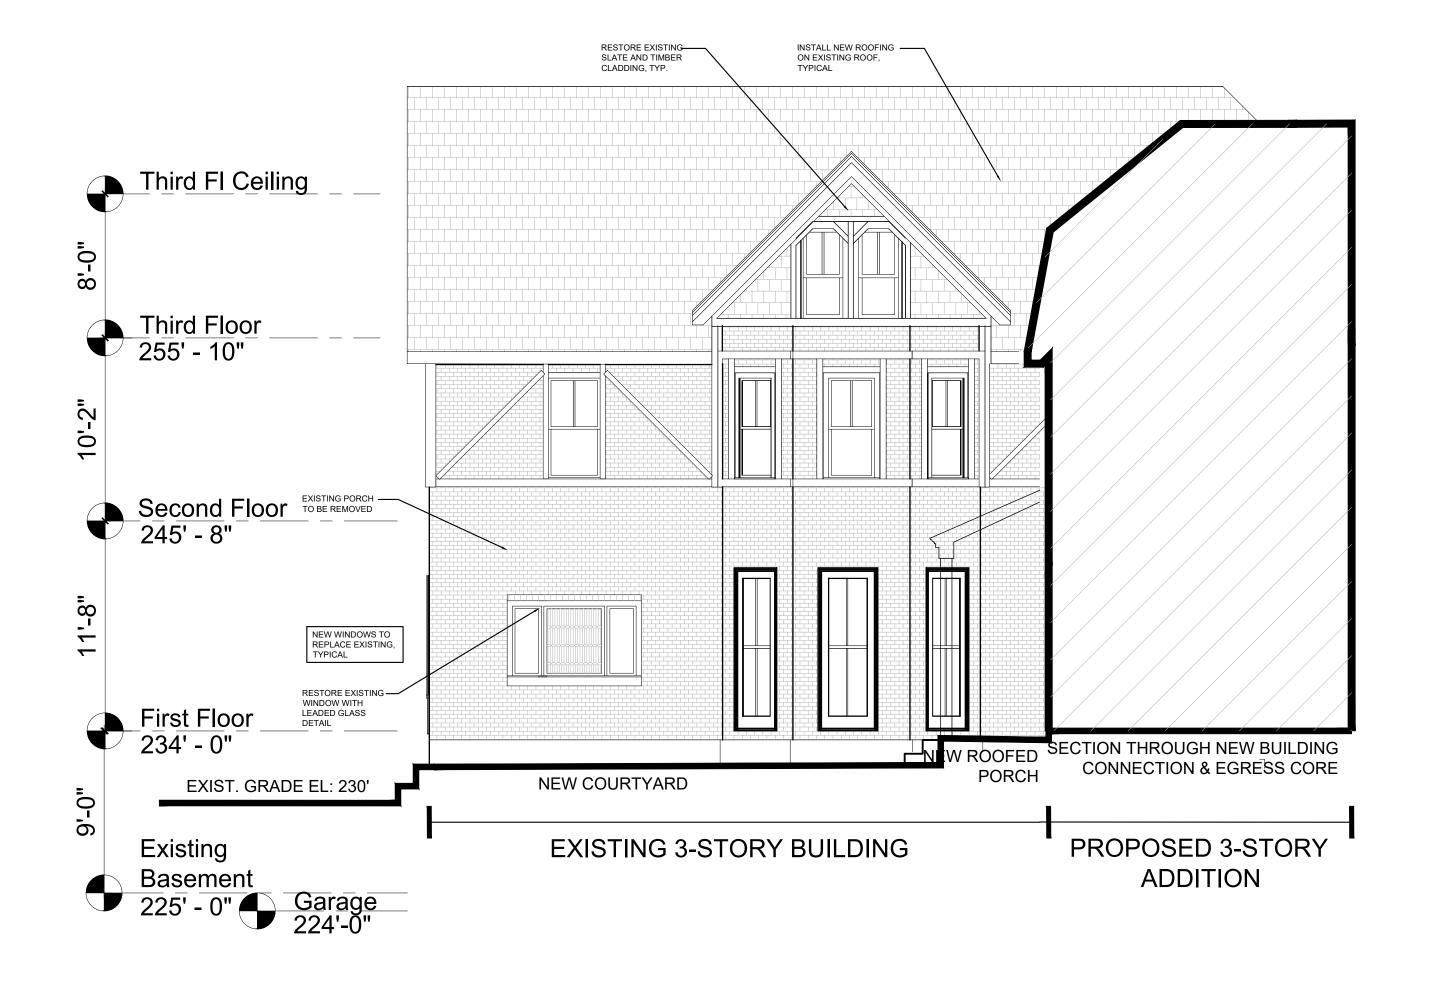

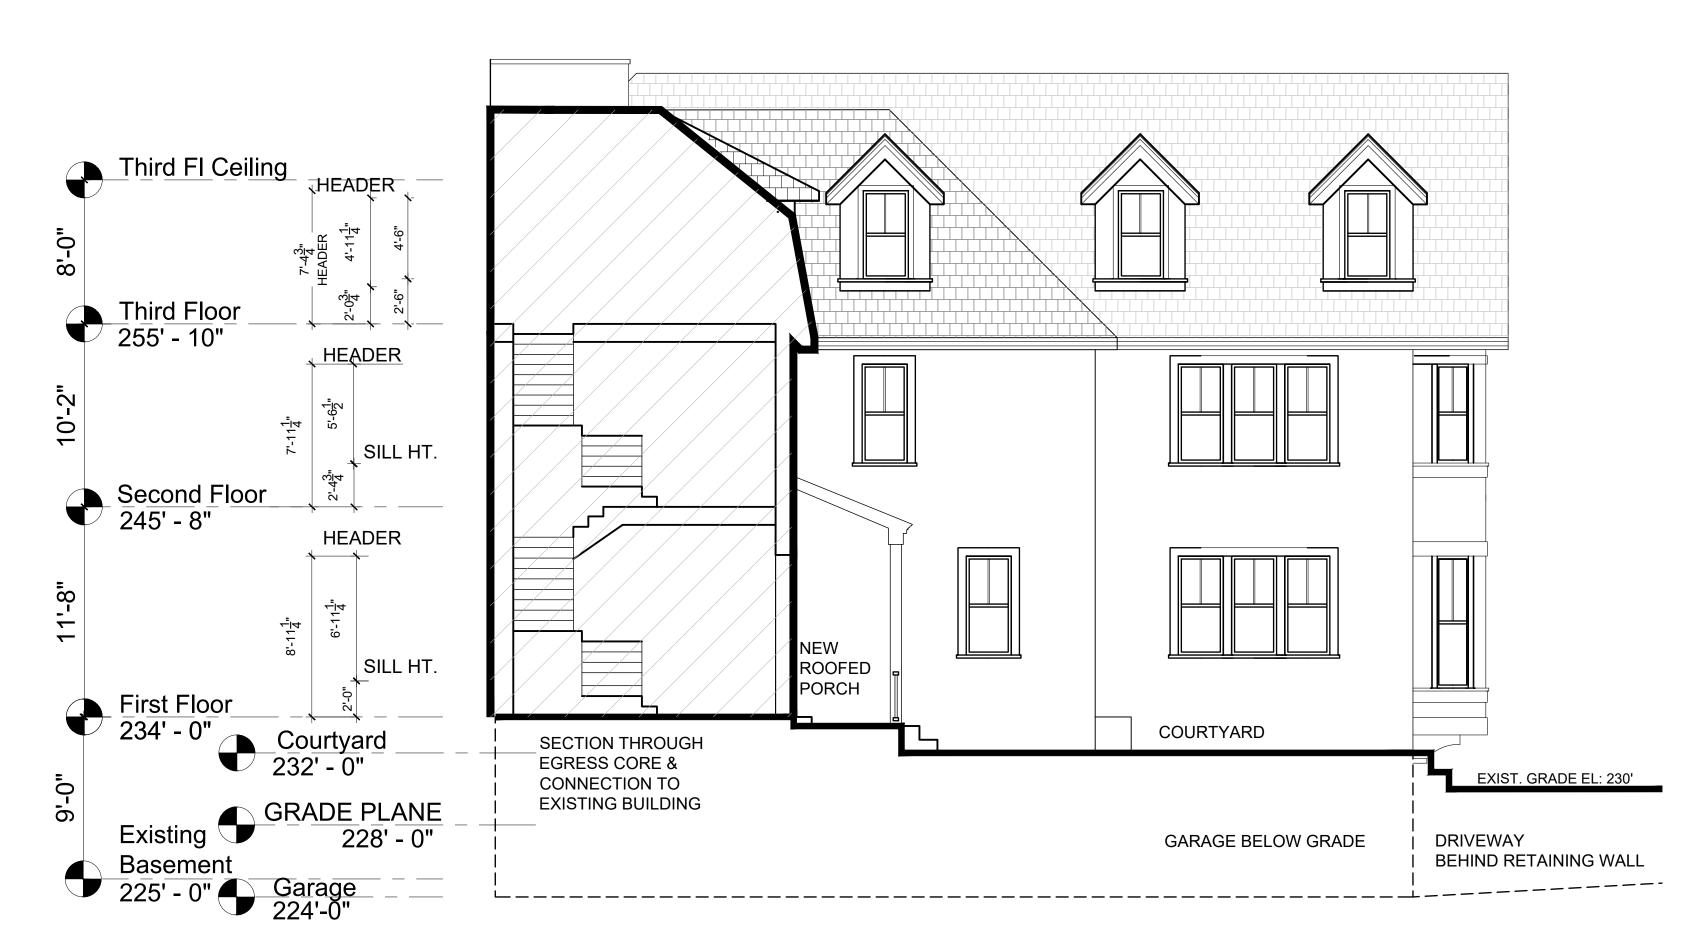

PROPOSED 3-STORY ADDITION

## NORTH ELEVATION COURTYARD VIEW

SCALE: 3/16" = 1'-0"

# SOUTH ELEVATION COURTYARD VIEW

SCALE: 3/16" = 1'-0"



12 SPRING STREET HASTINGS.on.HUDSON N.Y. 10706 914.478.0799 cg@cgastudio.com christinagriffinarchitect.com

ESIDENCES AT 4 CLINTON AVENUI

PLANNING BOARD SUBMISSION 11-7-22
PLANNING BOARD SUBMISSION 12-13-22
PLANNING BOARD SUBMISSION 1-19-23

Project Submitted


HUTTINGS ACTIONS OF NEW YORK


Scale As Shown

Drawing Title

ELEVATIONS

A-10

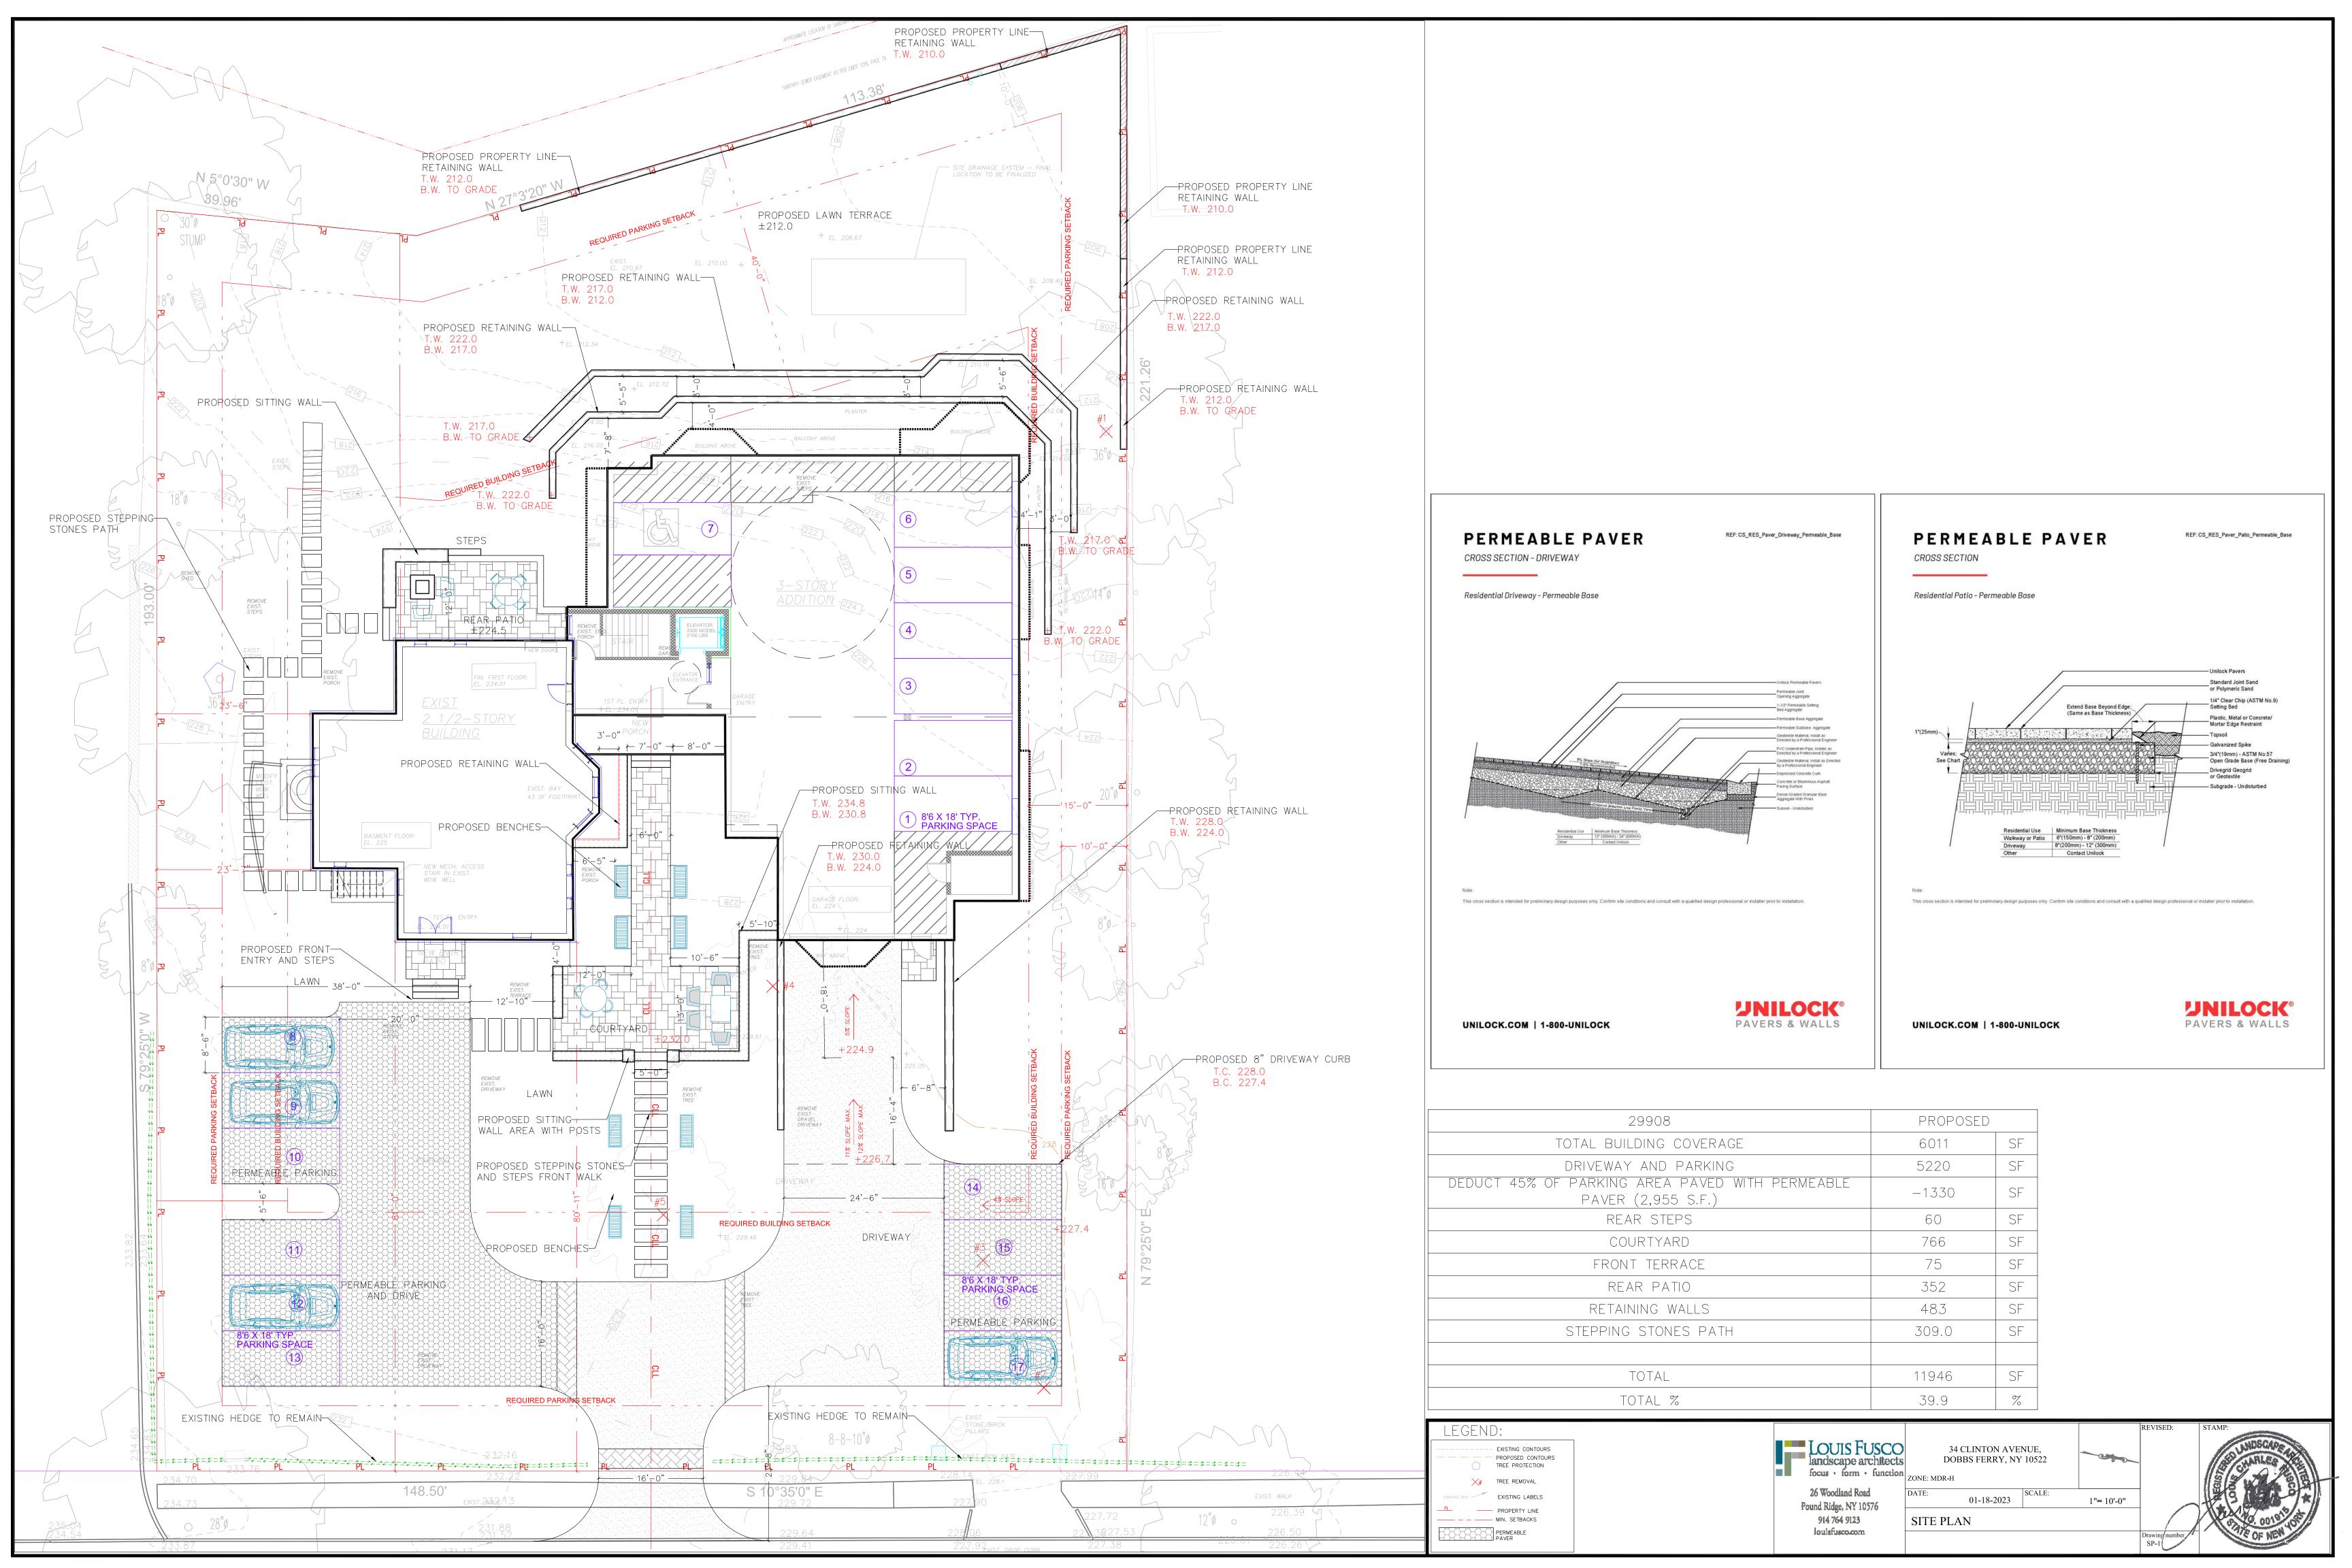

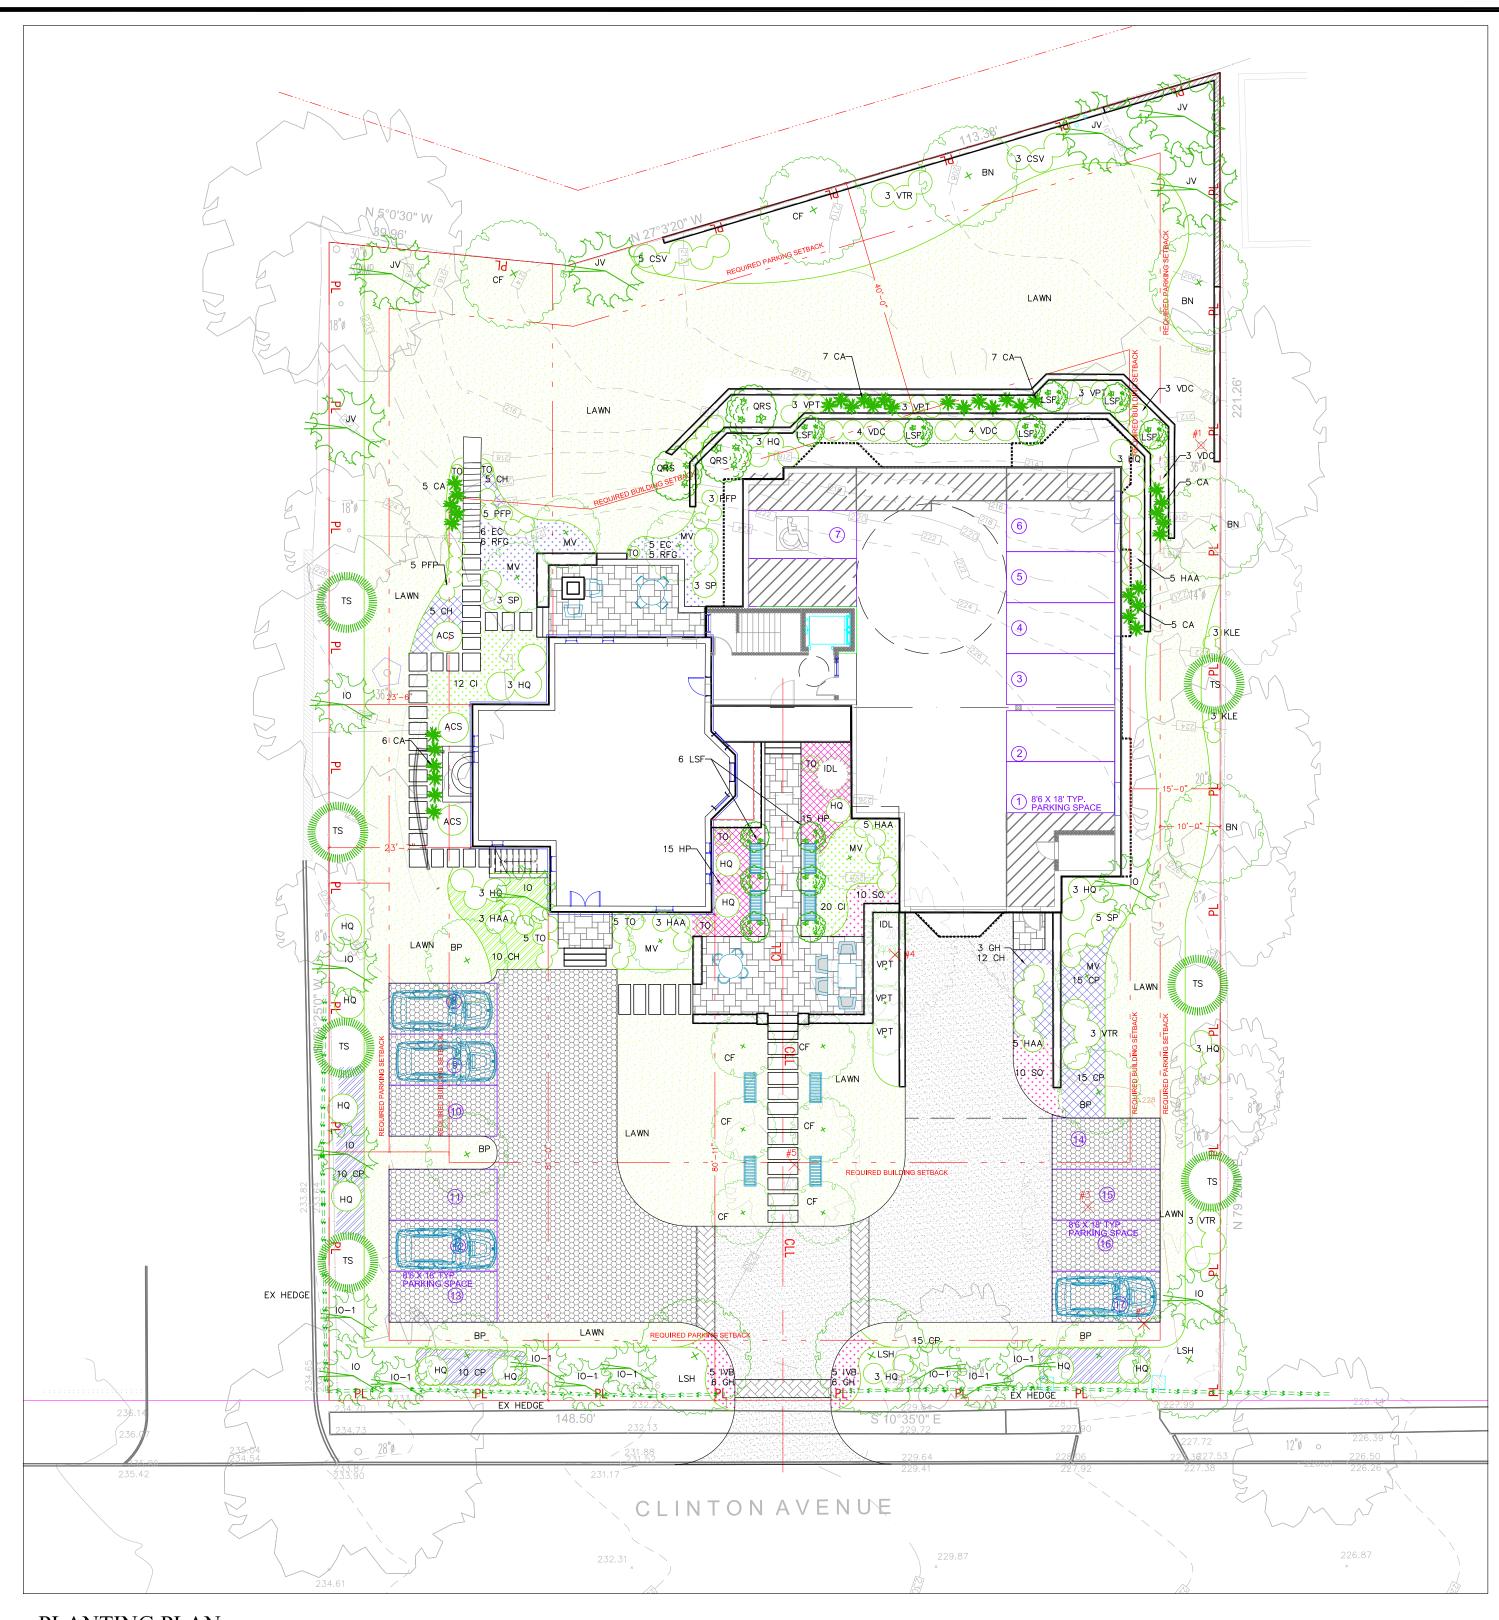



## PLANTING PLAN

SCALE: 1" = 16'-0"

2023-01-16 PLANTING - 34 CLINTON AVENUE				
Symbol	Latin Name	Common Name	Quantity	Size
		TREES	-	
ACS	Amelanchies Canadensis	Canadian Serviceberry	3	B & B 2 1/2" cal.
BN	Betula nigra 'Heritage'	River Birch	4	B & B 10-12'
ВР	Betula papyrifera 'OENCI'	Oasis Paper Birch	5	B & B 12-14'
CF	Cornus florida	White Flowering Dogwood	8	B & B 2 1/2-3" cal.
IDL	llex x meservae 'Dragon Lady'	Dragon Lady Holly	2	B & B 7-8'
10	llex opaca	American Holly	7	B & B 8-9'
10-1	llex opaca	American Holly	8	B & B 5-6'
JV	Juniperus virginiana	Eastern Red Cedar	6	B & B 8-9'
LSF	Liquidambar styraciflua 'Slender Silhouette'	Fastigiata Sweetgum	13	B & B 2 1/2-3" cal.
LSH	Liquidambar styraciflua Happidaze	Happidaze Sweetgum	3	B & B 4" cal.
MV	Magnolia virginiana	Sweet Bay Magnolia	6	B & B 6-8'
QRS	Quercus robur 'Skyrocket'	Fastigiata English Oak	3	B & B 3 " cal.
TS	Thuja standishii x plicata 'Green Giant'	Arborvitae 'Green Giant'	7	B & B 8-9' cal.

## RENDERED PLAN

SCALE: 1'' = 16'-0''

	SHRUBS				
CSV	Cornus stolonifera 'Variegata'	Variegated Redtwig Dogwood	8	7 gal.	
HAA	Hydrangea arborescens 'Annabelle'	Annabelle Hydrangea	19	7 gal.	
HQ	Hydrangea quercifolia	Oakleaf Hydrangea	25	10 gal.	
IVS	Itea virginica 'Little Henry'	Virginia sweetspire	6	5 gal.	
KLE	Kalmia latifonia 'Elf' or 'Minuet'	Mountain Laurel	6	5 gal.	
PFP	Potentilla fruticosa 'Pink Beauty'	Happy Face Pink	13	3 gal.	
SP	Syringa patula 'Miss Kim'	Dwarf Lilac	19	5 gal.	
TO	Thuja occidentalis 'Boboxam'	Mr. Bowling Ball	18	5 gal.	
VDC	Viburnum dentatum 'Christom'	Blue Muffin Arrowwood Viburnum	12	7 gal.	
VPT	Viburnum P. tomentosum 'Shasta'	Doublefile Viburnum Summer Shasta	9	B & B 4-4 1/2" cal.	
VTR	Viburnum trilobum	Highbush Cranberry	12	B & B 24-36"	

PERENNIALS AND GRASSES				
CA	Calamagrostis x acutiflora 'Karl Foerster'	Feather-reed Grass	32	2 gal.
СН	Carex hobb	Hobb Sedge	72	2 gal.
CI	Carex morrowii 'Ice Dance'	Ice Dance Sedge	51	2 gal.
СР	Carex pensylvanica	Pennsylvania Sedge	95	2 gal.
EC	Echinacea purpurea	Purple Coneflower	11	2 gal.
GH	Geranium 'Rozanne'	Hardy Geranium Rozanne	41	2 gal.
HP	Helleborus purpurascens 'Waldst.& Kit.'	Helleborus	87	2 gal.
I∨B	Iris virginica	Blue Flag Iris	37	2 gal.
RFG	Rudbeckia fulgida 'Goldstrum'	Black Eyed Susan	11	2 gal.
SO	Schizachyrium scoparium 'Standing Ovation'	Little Bluestem Grass	22	2 gal.

- EXISTING CONTOURS PROPOSED CONTOURS TREE PROTECTION X# TREE REMOVAL EXISTING LABELS PL PROPERTY LINE ——— — MIN. SETBACKS

TREE REMOVAL LIST: 1. 36" MAPLE TREE

2. 24" PINE TREE 3. 10" JAPANESE MAPLE TREE

4. 42" BEECH TREE 5. 18" SPRUCE TREE

TREE PRESERVATION:

- Total number of over 8" DBH trees to be removed =130 **Total DBH** (5 trees)

- Total number of required tree replanting's per code section 300-51I (50% minimum) = 65" Total DBH. - Total Proposed Trees 2.5" DBH or greater = 170.5" Total DBH (131%, 52 trees)

-The cultivated soil should be irrigated regularly following treatment to keep the soil moist if adequate rainfall does not occur.

NEW PLANTINGS TO BE WATERED AND MAINTAINED IN GOOD HEALTH FOR MINIMUM OF 2 YEARS. ANY PLANT MATERIAL THAT DOES NOT SURVIVE OR IN POOR CONDITION AFTER 2 YEARS SHALL BE REPLACED IN KIND AND QUALITY OF ORIGINAL SPECIFICATION.
 EXISTING TREES TO REMAIN SHALL RECEIVE TREE PROTECTION PER DRAWINGS BY HUDSON ENGINEERING.
 LANDSCAPE ARCHITECT TO APPROVE TREE PROTECTION INSTALLATION EXTENDING PROTECTED AREA PAST DRIP LINE OF TREE WHERE POSSIBLE.

- EXISTING TREE TO REMAIN SHALL ALSO RECEIVE ROOT INVIGORATION POST CONSTRUCTION:


- Air-Spade to improve soil health and promote root development and function. A radius of approximately 3 feet from outside the dripline of the tree will be cultivated to a depth of 6-8 inches.

-Organic matter from degraded mulch will be incorporated into the soil during cultivation. - Incorporate compost and other amendments per soil analysis report. - Mulch should be applied to the treated area immediately after treatment.

The existing 4' Ht. hedge is to remain wherever possible and supplement as necessary with new plantings

LOUIS FUSCO 134 CI DOBB 134 CI 34 CLINTON AVENUE, DOBBS FERRY, NY 10522 01-18-2023 SCALE: 26 Woodland Road Pound Ridge, NY 10576 914 764 9123 PLANTING PLAN

louisfusco.com

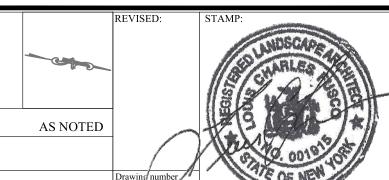








VIEWS OF LANDSCAPE BUFFER

VIEWS OF ENTRY APPROACH

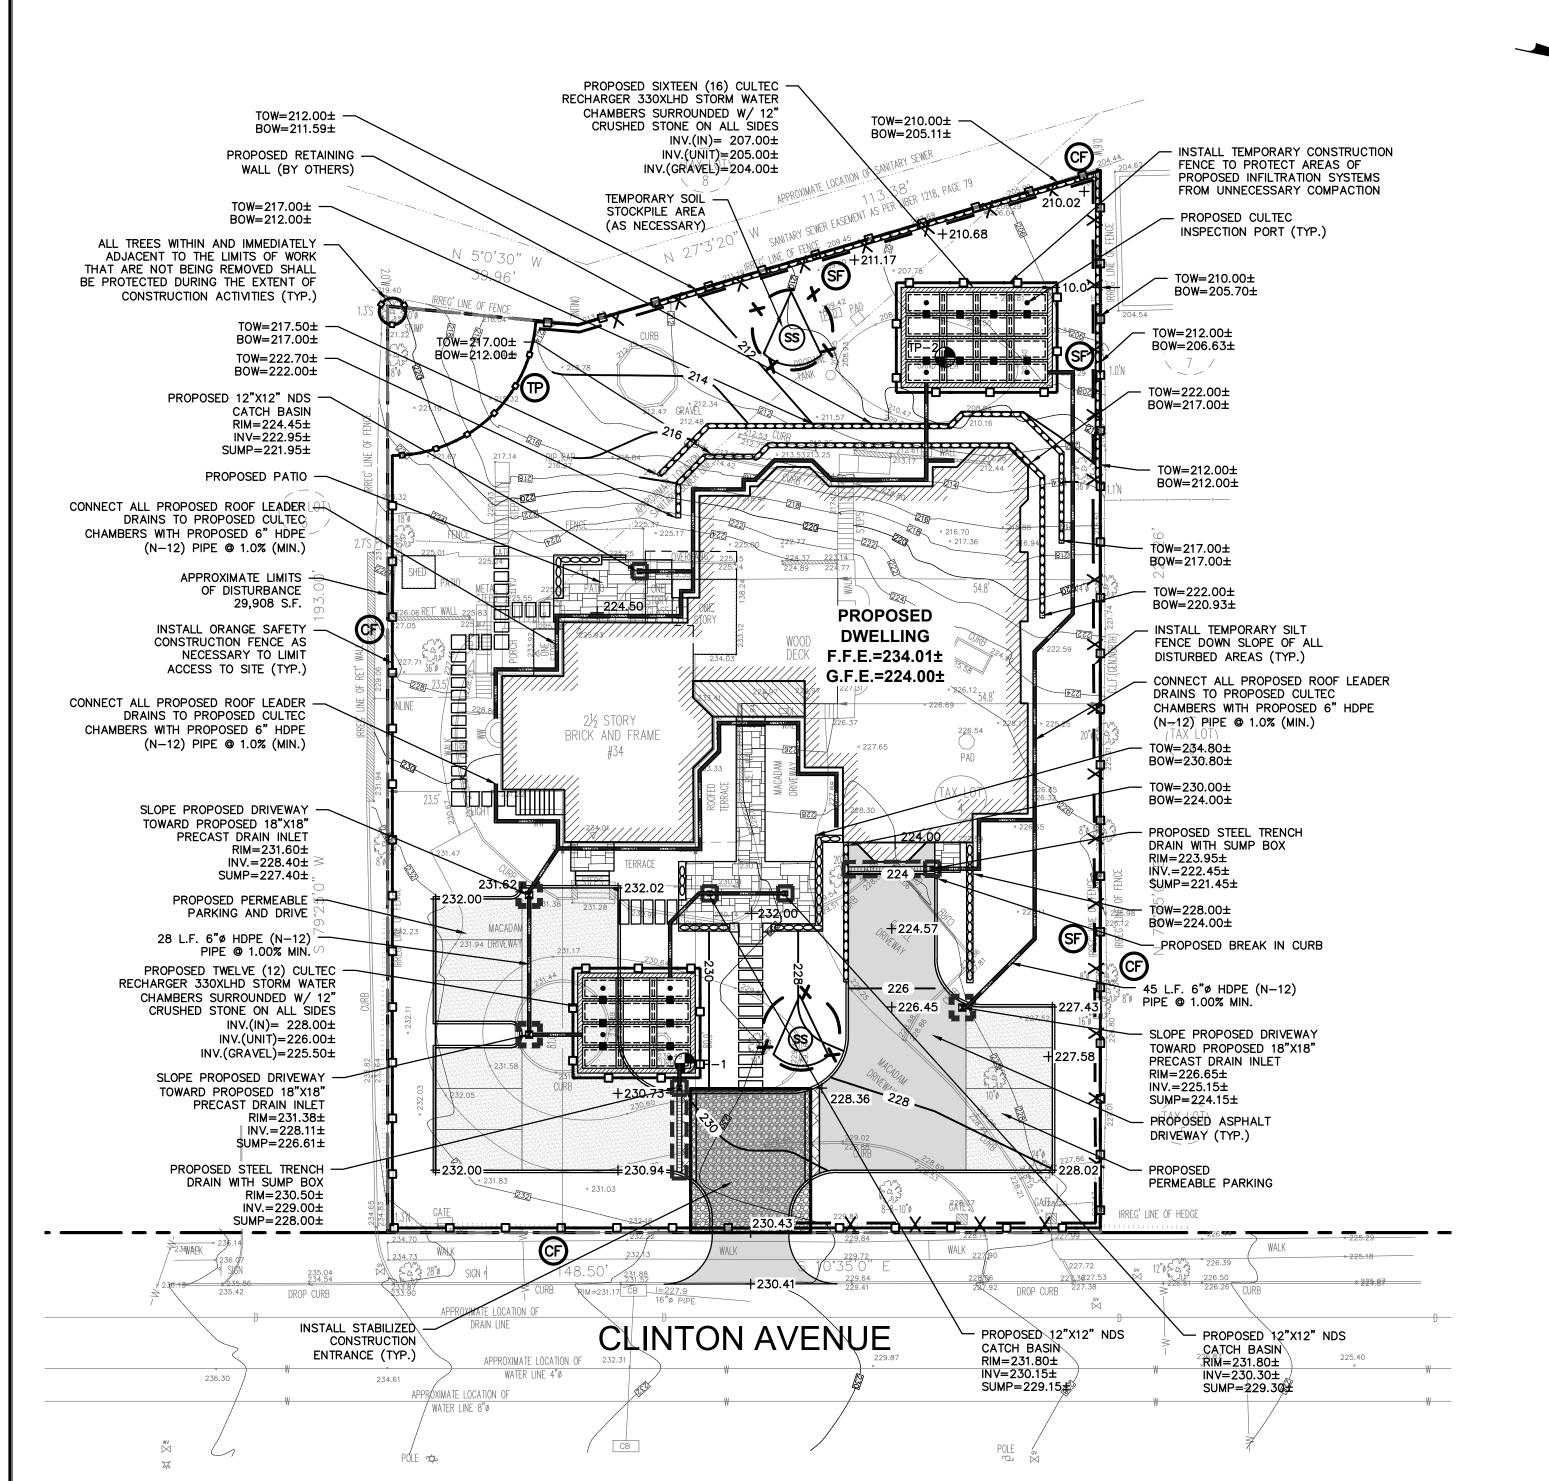

## LEGEND

PROPERTY LINE PROPOSED BELGIAN BLOCK CURB PROPOSED ASPHALT DRIVEWAY PROPOSED WALKWAY/PATIO PROPOSED PERMEABLE DRIVEWAY PROPOSED STONE MASONRY WALL PROPOSED CONTOUR PROPOSED SPOT +226.50 GRADE PROPOSED STORM PIPE PROPOSED DRAIN PROPOSED TRENCH DRAIN TEMPORARY INLET PROTECTION TEMPORARY SIL TEMPORARY CONSTRUCTION FENCE TEMPORARY SOIL STOCKPILE AREA STABILIZED CONSTRUCTION ENTRANCE LOCATION PROPOSED LIMIT OF DISTURBANCE PROPOSED TREE PROTECTION EXISTING TREE REMOVED

. SHOULD ROCK BLASTING BE REQUIRED, A PERMIT APPLICATION IN ACCORDANCE WITH CHAPTER 125 - BLASTING OF THE DOBBS DERRY VILLAGE CODE MUST BE SUBMITTED TO THE VILLAGE BY THE

APPLICANT FOR REVIEW/APPROVAL. 2. THE VILLAGE ENGINEER MAY REQUIRE ADDITIONAL EROSION CONTROL MEASURES IF DEEMED APPROPRIATE TO MITIGATE UNFORESEEN

SILTATION AND EROSION OF DISTURBED SOILS. 3. AS-BUILT PLANS OF THE PROPOSED DRAINAGE IMPROVEMENTS SHALL

BE SUBMITTED TO THE VILLAGE ENGINEER FOR REVIEW PRIOR TO ISSUANCE OF CERTIFICATE OF OCCUPANCY. 4. FILL MATERIAL IMPORTED TO THE SITE SHALL BE CERTIFIED IN WRITING BY A NEW YORK LICENSED PROFESSIONAL ENGINEER AS

CLEAN, NON-CONTAMINATED FILL SUITABLE FOR THE INTENDED USE. 5. "BEFORE THE SITE PLAN IS SIGNED BY THE CHAIRMAN OF THE PLANNING BOARD, THE APPLICANT SHALL BE REQUIRED TO POST A PERFORMANCE BOND OR OTHER TYPE OF ACCEPTABLE MONETARY GUARANTY WHICH SHALL BE IN AN AMOUNT DETERMINED BY THE PLANNING BOARD AND THE VILLAGE ENGINEER AND IN A FORM SATISFACTORY TO THE VILLAGE ATTORNEY".

6. THE APPLICANT SHALL NOTIFY THE BUILDING DEPARTMENT OR VILLAGE'S CONSULTING ENGINEER IN WRITING AT LEAST 48 HOURS BEFORE ANY OF THE FOLLOWING SO THAT ANY INSPECTION MAY BE

6.1. START OF CONSTRUCTION.

6.2. INSTALLATION OF SEDIMENT AND EROSION CONTROL MEASURES.


6.3. COMPLETION OF SITE CLEARING. 6.4. COMPLETION OF ROUGH GRADING.

6.5. INSTALLATION OF SMP'S. 6.6. COMPLETION OF FINAL GRADING AND STABILIZATION OF

DISTURBED AREAS. 6.7. CLOSURE OF CONSTRUCTION.

6.8. COMPLETION OF FINAL LANDSCAPING; AND 6.9. SUCCESSFUL ESTABLISHMENT OF LANDSCAPING IN PUBLIC

7. A STREET OPENING PERMIT SHALL BE OBTAINED FOR ALL WORK WITHIN THE RIGHT-OF-WAY.

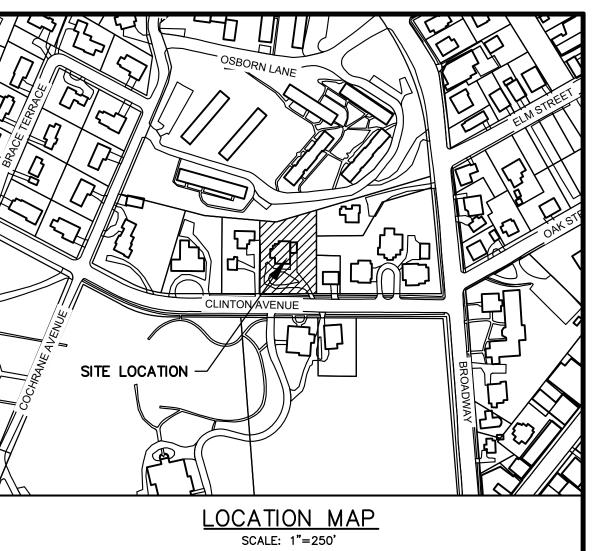

## **GENERAL NOTES:**

1. THE ENGINEER SHALL NOT BE RESPONSIBLE FOR THE SUPERVISION OF THE

NO CHANGES SHALL BE MADE TO THESE PLANS EXCEPT AS PER NYS LAW CHAPTER 987 3. ALL WORK AND MATERIALS SHALL COMPLY WITH ALL APPLICABLE CODES, INCLUDING BUT NOT LIMITED TO ACI, AISC, ZONING, AND THE NEW YORK STATE BUILDING CODE.

ENGINEER SHALL BE IMMEDIATELY NOTIFIED OF ANY DISCREPANCIES. 5. ALL CHANGES MADE TO THE PLANS SHALL BE APPROVED BY THE ENGINEER AND ANY SUCH CHANGES SHALL BE FILED AS AMENDMENTS TO THE ORIGINAL BUILDING PERMIT. 6. THE CONTRACTOR SHALL SUPERVISE AND DIRECT THE WORK USING HIS BEST SKILL AND ATTENTION. HE SHALL BE SOLELY RESPONSIBLE FOR ALL CONSTRUCTION MEANS, METHODS, TECHNIQUES, SEQUENCES AND PROCEDURES AND FOR COORDINATING ALL

4. ALL CONDITIONS, LOCATIONS AND DIMENSIONS SHALL BE FIELD VERIFIED AND THE

PORTIONS OF THE WORK UNDER THE CONTRACT. 7. THE CONTRACTOR SHALL BE RESPONSIBLE TO THE OWNER FOR THE ACTS AND OMISSIONS OF HIS EMPLOYEES, SUBCONTRACTORS AND THEIR AGENTS AND EMPLOYEES, AND OTHER PERSONS PERFORMING ANY OF THE WORK UNDER A CONTACT WITH THE

8. SAFETY DURING CONSTRUCTION SHALL BE THE RESPONSIBILITY OF THE CONTRACTOR AND SHALL CONFORM TO ALL LOCAL, STATE AND FEDERAL AGENCIES IN EFFECT DURING THE PERIOD OF CONSTRUCTION.

9. THE CONTRACTOR AND HIS SUBCONTRACTORS SHALL MAKE APPLICATION TO RECEIVE ALI NECESSARY PERMITS TO PERFORM THE WORK UNDER CONTRACT. THE CONTRACTOR AND HIS SUBCONTRACTORS SHALL BE LICENSED TO DO ALL WORK AS REQUIRED BY THE LOCAL, COUNTY, AND STATE AGENCIES WHICH MAY HAVE JURISDICTION OVER THOSE TRADES, AND SHALL PRESENT THE OWNER WITH COPIES OF ALL LICENSES AND INSURANCE CERTIFICATES.

10. FINAL GRADING AROUND THE BUILDING AREA SHALL SLOPE AWAY FROM THE STRUCTURE 11. ALL WRITTEN DIMENSIONS ON THE DRAWINGS SHALL TAKE PRECEDENCE OVER ANY

DELIVERED NOT LESS THAN 10 DAYS PRIOR TO THE SCHEDULED STARTING DATE OF THE

SCALED DIMENSIONS. 12. ADJOINING PUBLIC AND PRIVATE PROPERTY SHALL BE PROTECTED FROM DAMAGE DURING CONSTRUCTION, REMODELING AND DEMOLITION WORK. PROTECTION MUST BE PROVIDED FOR FOOTINGS, FOUNDATIONS, PARTY WALLS, CHIMNEYS, SKYLIGHTS AND ROOFS. PROVISIONS SHALL BE MADE TO CONTROL WATER RUNOFF AND EROSION DURING CONSTRUCTION OR DEMOLITION ACTIVITIES. THE PERSON MAKING OR CAUSING AN EXCAVATION TO BE MADE SHALL PROVIDE WRITTEN NOTICE TO THE OWNERS OF ADJOINING BUILDINGS ADVISING THEM THAT THE EXCAVATION IS TO BE MADE AND THAT THE ADJOINING BUILDING SHOULD BE PROTECTED. SAID NOTIFICATION SHALL BE

**EXCAVATION.** 13. OWNER SHALL INSURE THAT THE INSURANCE PROVIDED BY THE CONTRACTOR HIRED TO PERFORM THE WORK SHALL BE ENDORSED TO NAME HUDSON ENGINEERING & CONSULTING, P.C., AND ANY DIRECTORS, OFFICERS, EMPLOYEES, SUBSIDIARIES, AND AFFILIATES, AS ADDITIONAL INSURED ON ALL POLICIES AND HOLD HARMLESS DOCUMENTS, INSURANCE OR SELF-INSURANCE MAINTAINED BY HUDSON ENGINEERING & CONSULTING, P.C., SHALL BE EXCESS ONLY AND SHALL NOT BE CALLED UPON TO CONTRIBUTE WITH THIS INSURANCE. ISO ADDITIONAL INSURED ENDORSEMENT FORM NUMBER CG2010 1185 UNDER GL. COPIES OF THE INSURANCE POLICIES SHALL BE SUBMITTED TO HUDSON ENGINEERING & CONSULTING, P.C., FOR APPROVAL PRIOR TO THE SIGNING OF THE

14. INDUSTRIAL CODE RULE 753: THE CONTRACTOR SHALL NOTIFY ALL UTILITY COMPANIES 72 HOURS PRIOR TO THE START OF HIS OPERATIONS AND SHALL COMPLY WITH ALL THE LATEST INDUSTRIAL CODE RULE 753 REGULATIONS.

## INSTALLATION & MAINTENANCE OF EROSION CONTROL:

CONSTRUCTION SCHEDULE

CONTRACT

NOTIFY APPROPRIATE MUNICIPAL AGENCY HAVING JURISDICTION AT LEAST 5 DAYS PRIOR TO START.

EROSION CONTROL MEASURES INSTALL ALL EROSION CONTROL MEASURES PRIOR TO START OF CONSTRUCTION. CALL FOR INSPECTION FROM THE APPROPRIATE MUNICIPAL AGENCY HAVING JURISDICTION AT LEAST 2 DAYS PRIOR TO FINISH.

## INSPECTION BY MUNICIPALITY MAINTENANCE (TO BE PERFORMED DURING ALL PHASES OF CONSTRUCTION)

AFTER ANY RAIN CAUSING RUNOFF, CONTRACTOR TO INSPECT HAYBALES, ETC. AND REMOVE ANY EXCESSIVE SEDIMENT AND INSPECT STOCKPILES AND CORRECT ANY PROBLEMS WITH SEED ESTABLISHMENT. INSPECTIONS SHALL BE DOCUMENTED IN WRITING AND SUBMITTED TO THE APPROPRIATE MUNICIPAL AGENCY HAVING JURISDICTION.

## INSPECTION BY MUNICIPALITY — FINAL GRADING REMOVE UNNEEDED SUBGRADE FROM SITE.

CALL FOR INSPECTION FROM THE APPROPRIATE MUNICIPAL AGENCY HAVING JURISDICTION AT LEAST 2 DAYS PRIOR TO FINISH.

## INSPECTION BY MUNICIPALITY - LANDSCAPING

SPREAD TOPSOIL EVENLY OVER AREAS TO BE SEEDED. HAND RAKE LEVEL. BROADCAST 1.25 LB. BAG OF JONATHAN GREEN "FASTGROW" MIX OR EQUAL OVER AREA TO BE SEEDED. APPLY STRAW MULCH AND WATER WITHIN 2 DAYS OF COMPLETION OF TOPSOILING. CALL FOR INSPECTION FROM THE APPROPRIATE MUNICIPAL AGENCY HAVING JURISDICTION AT LEAST 2 DAYS PRIOR TO FINISH.

## INSPECTION BY MUNICIPALITY - FINAL LANDSCAPING

GRASS ESTABLISHED. CALL FOR INSPECTION FROM THE APPROPRIATE MUNICIPAL AGENCY HAVING JURISDICTION AT LEAST 2 DAYS PRIOR TO FINISH.

## INSPECTION BY MUNICIPALITY - FINAL INSPECTION

ALL EROSION CONTROL MEASURES REMOVED AND GRASS ESTABLISHED. CALL FOR INSPECTION FROM THE APPROPRIATE MUNICIPAL AGENCY HAVING JURISDICTION AT LEAST 2 DAYS PRIOR TO FINISH.



PROPOSED MULTI-FAMILY RESIDENCE 34 CLINTON AVENUE VILLAGE OF DOBBS FERRY WESTCHESTER COUNTY - NEW YORK




Designed By: A.Y.

Checked By: M.S.

STORMWATER MANAGEMENT PLAN



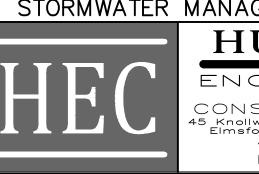

GRAPHIC SCALE

CONTRACTOR SHALL CONTACT DESIGN ENGINEER TO SCHEDULE A SITE INSPECTION PRIOR TO BACKFILLING INFILTRATION/ATTENUATION SYSTEM(S). ALL CONNECTIONS SHALL BE INSTALLED IN ACCORDANCE WITH MANUFACTURER'S SPECIFICATIONS AND VISIBLE AT TIME OF INSPECTION. SHOULD THE CONTRACTOR

BACKFILL PRIOR TO INSPECTION, THE CONTRACTOR

SHALL EXPOSE THE SYSTEM AT THEIR OWN EXPENSE.

ANY ALTERATIONS OR REVISIONS OF THESE PLANS, UNLESS DONE BY OR UNDER THE DIRECTION OF THE NYS LICENSED AND REGISTERED ENGINEER THAT PREPARED THEM, IS A VIOLATION OF THE NYS EDUCATION LAW.


**TEST HOLE DATA:** TEST HOLE #1 DEPTH - "96"

0-12" TOPSOIL 30-36" CLAY" 36-96" SANDY LOAM NO GROUNDWATER NO LEDGE ROCK PERC. = 75.95 INCHES/HOUR

TEST HOLE #2 DEPTH - 96" 0-12" TOPSOIL 30-36" CLAY" 36-96" SILTY LOAM NO GROUNDWATER NO LEDGE ROCK PERC. = 31.91 INCHES/HOUR

EXISTING INFORMATION SHOWN HEREON PROVIDED BY SUMMIT LAND SURVEYING P.C. DATED SEPTEMBER 3, 2022

( IN FEET ) 1 inch = 20 ft.

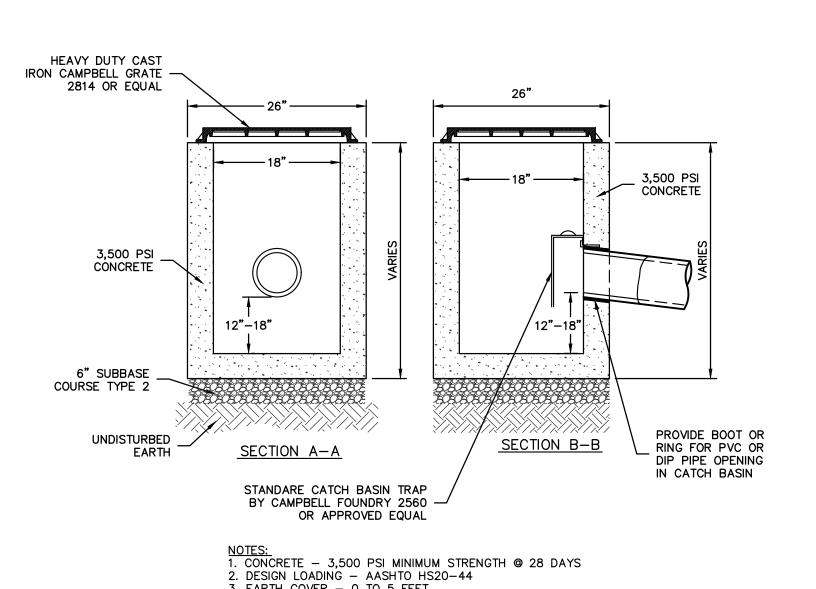

3. EARTH COVER - 0 TO 5 FEET 4. CONSTRUCTION JOINT - LAPPED

STORAGE PROVIDED =  $11.32 \text{ CF/FT } [1.05 \text{ m}^3/\text{m}] \text{ PER DESIGN}$ 


GUIDELINES.

INSTALLATION INSTRUCTIONS

REFER TO CULTEC, INC.'S CURRENT RECOMMENDED INSTALLATION

THE CHAMBER WILL BE DESIGNED TO WITHSTAND TRAFFIC LOADS WHEN INSTALLED ACCORDING TO CULTEC'S RECOMMENDED

## 18"X18" PRECAST CONCRETE CATCH BASIN

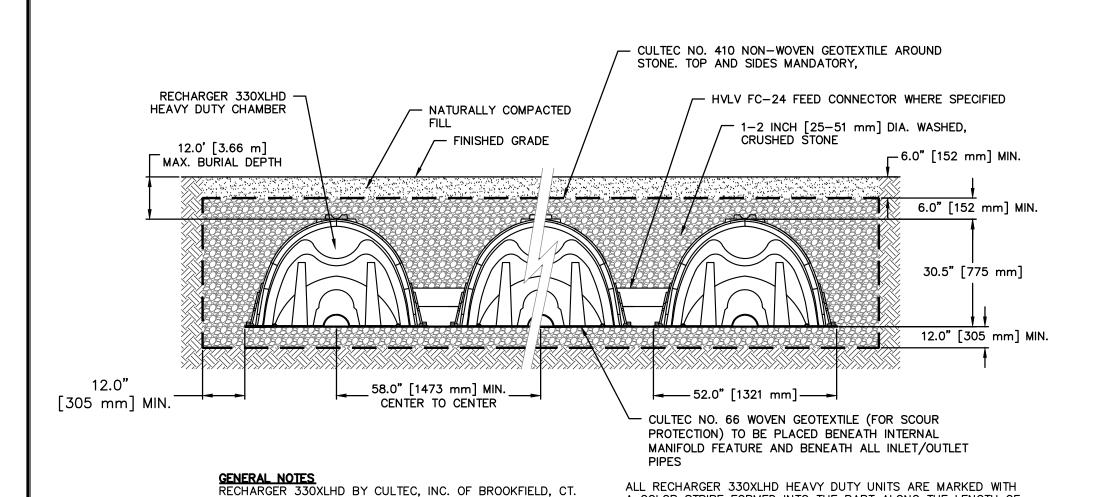

## CULTEC RECHARGER 330XLHD


THE CHAMBER.

REGULATIONS


A COLOR STRIPE FORMED INTO THE PART ALONG THE LENGTH OF


ACCORDANCE WITH ALL APPLICABLE LOCAL, STATE AND FEDERAL

ALL RECHARGER 330XLHD CHAMBERS MUST BE INSTALLED IN

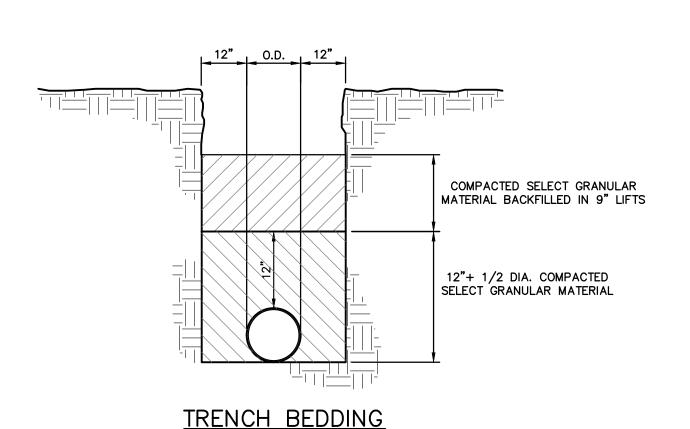

CONTRACTOR SHALL CONTACT DESIGN ENGINEER TO SCHEDULE A SITE INSPECTION PRIOR TO BACKFILLING INFILTRATION/ATTENUATION SYSTEM(S). ALL CONNECTIONS SHALL BE INSTALLED IN ACCORDANCE WITH MANUFACTURER'S SPECIFICATIONS AND VISIBLE AT TIME OF INSPECTION. SHOULD THE CONTRACTOR BACKFILL PRIOR TO INSPECTION, THE CONTRACTOR SHALL EXPOSE THE SYSTEM AT THEIR OWN EXPENSE.

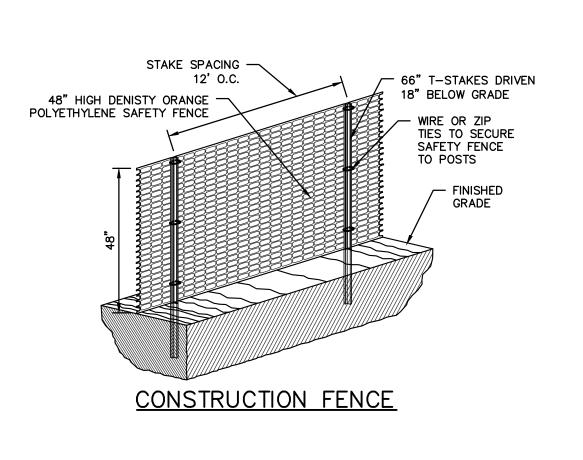

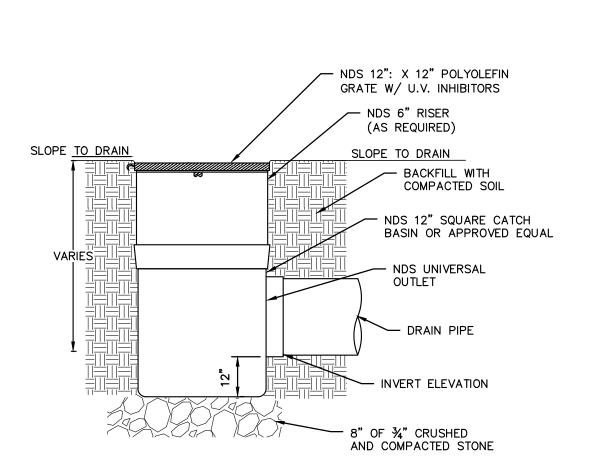


NDS SQUARE CATCH BASIN


## 6" SCH. 40 PVC OR SDR-35 PVC PIPE SEE PAVED SURFACE -FLOOR BOX FRAME AND LID INSTALLATION DETAIL FOR NEENAH R-7506 OR EQUAL INSTALLATION IN TRAFFIC AREAS. RISER WITH SCREW CAP W/ S.S. CAP SCREW LID -6" SDR-35/SCH.40 6" BELOW SURFACE PVC ENDCAP 6" SCH. 40 PVC OR-PAVEMENT -FINISHED GRADE -CLEAN-OUT ADAPTER SDR-35 PVC PIPE 95% COMPACTED FILL W/ SCREW-IN CAP NATURALLY COMPACTED FILL-(SEE NOTE 1) 12" CLASS "C" CONCRETE COLLAF REFER TO RECOMMENDED " INTERNAL MIN. – MAX. BURIAL COUPLING REQUIREMENTS PAVED SURFACE INSTALLATION DETAIL CULTEC NO. 410 NON-WOVEN-GEOTEXTILE AROUND STONE. TOP AND SIDES MANDATORY, 1. WHEN ACCESS PORT IS UTILIZED AS SYSTEM OVERFLOW, INSTALL NDS BOTTOM PER ENGINEER'S MODEL 50 GRATE. GRATE TO BE SET 1/2" ABOVE ADJACENT GRADE. DESIGN PREFERENCE ADJACENT GRADE TO PITCH AWAY FROM ACCESS PORT IN ALL DIRECTION. 2. INSPECTION PORT NOT TO SERVE AS OVERFLOW WHEN INSTALLED IN 1 - 2 IN. DIA. WASHED, -PAVED/TRAFFIC AREAS. CRUSHED STONE SURROUNDING CHAMBER 6" INTERNAL COUPLING TYPICAL CULTEC CHAMBER AND INSPECTION PORT ASSEMBLY FROM INSPECTION PORT-BOTTOM TO FINAL ELEVATION (THIS CHAMBER ONLY)


## CULTEC INSPECTION PORT

INSTALLATION DETAIL

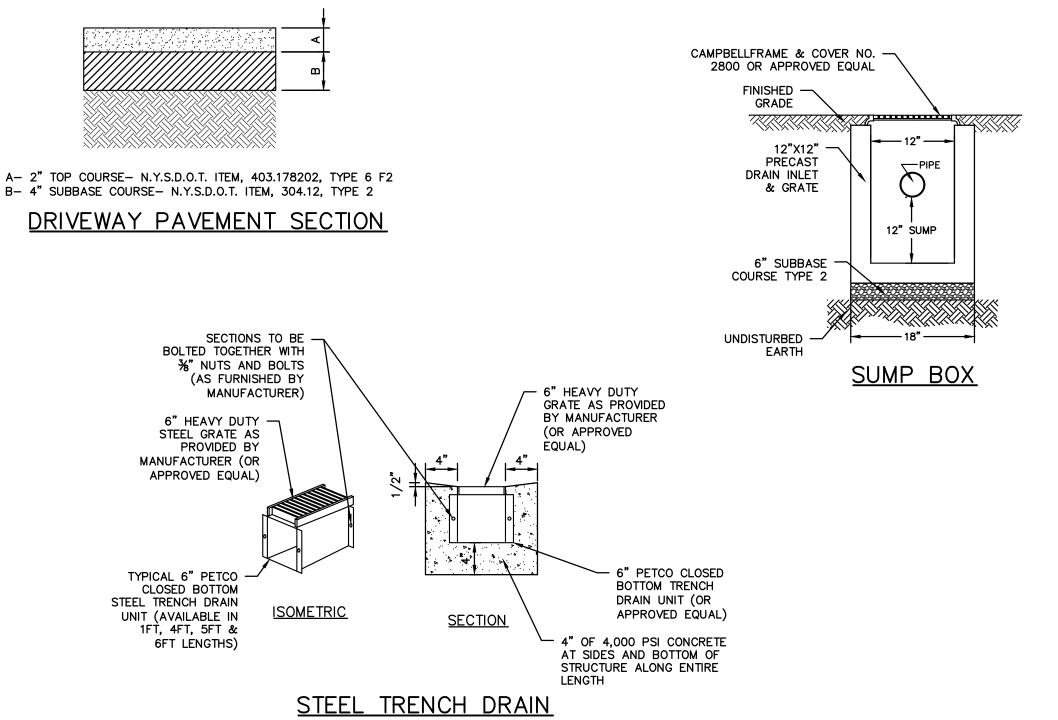

## STONE & BLOCK DROP INLET PROTECTION

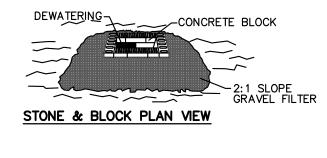

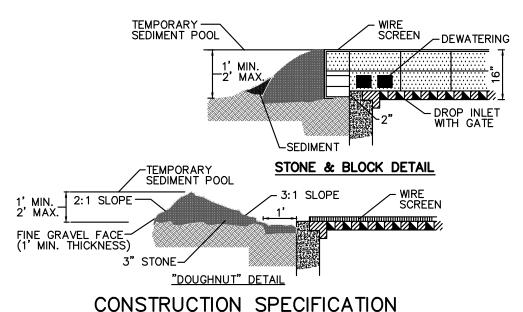


- 1. LAY ONE BLOCK ON EACH SIDE OF THE STRUCTURE ON ITS SIDE FOR DEWATERING. FOUNDATION SHALL BE 2 INCHES MINIMUM BELOW REST OF INLET AND BLOCKS SHALL BE PLACED AGAINST INLET FOR SUPPORT.
- HARDWARECLOTH OR 1/2" WIRE MESH SHALL BE PLACED OVER BLOCK OPENINGS
  TO SUPPORT STONE.
   USE CLEAN STONE OR GRAVEL 1/2-3/4 INCH IN DIAMETER PLACED 2 INCHES BELOW
  TOP OF BLOCK ON A 2:1 SLOPE OR FLATTER.
- TOP OF BLOCK ON A 2:1 SLOPE'OR FLATTER.

  4. FOR STONE STRUCTURES ONLY, A 1 FOOT THICK LAYER OF THE FILTER STONE WILL BE PLACED AGAINST THE 3 INCH STONE AS SHOWN ON THE DRAWINGS.

  MAXIMUM DRAINAGE AREA 1 ACRE.


## FENCING AND ARMORING

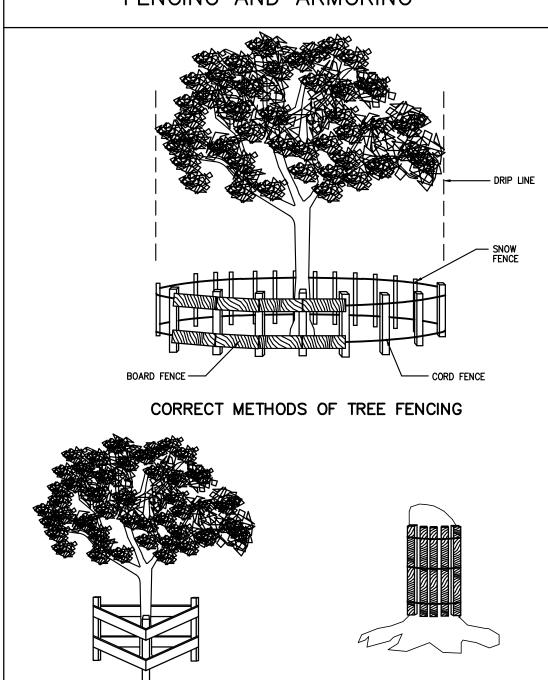

TRIANGULAR BOARD FENCE

CORRECT TRUNK ARMORING

# SOIL STOCKPILING STABILIZE ENTIRE PILE

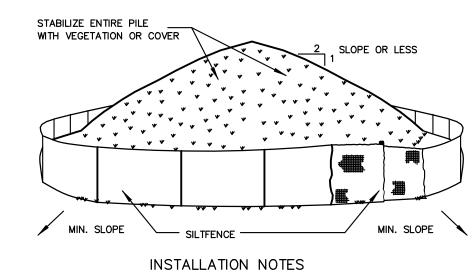

INSTALLATION NOTES:

1. AREA CHOSEN FOR STOCKPILING OPERATIONS SHALL BE DRY AND STABLE.

2. SOILS OR FILL TO BE STOCKPILED ON SITE DURING CUTTING AND FILLING ACTIVITIES SHOULD BE LOCATED ON LEVEL PORTIONS OF THE SITE WITH A MINIMUM OF 50-75 FOOT SETBACKS FROM TEMPORARY DRAINAGE SWALES.


3. MAXIMUM SLOPE OF STOCKPILE SHALL BE 1: 2.

4. UPON COMPLETION OF SOIL STOCKPILING, EACH PILE SHALL BE SURROUNDED WITH EITHER SILT FENCING OR STRAWBALES, THEN STABILIZED WITH VEGETATION OR COVERED.

5. STOCKPILES REMAINING IN PLACE FOR MORE THAN A WEEK SHOULD BE SEEDED AND MULCHED OR COVERED WITH GEOTEXTILE FABRIC SURROUNDED BY SILT FENCE.

## SILT FENCE

6. SEE SPECIFICATIONS (THIS MANUAL) FOR INSTALLATION OF SILT FENCE.

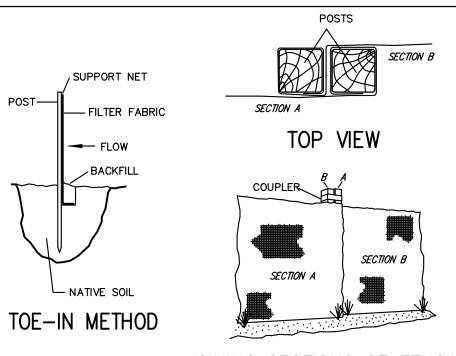


## JOINING SECTIONS OF FENCING

INSTALLATION NOTES:

1. EXCAVATE A 4 INCH \* 4 INCH TRENCH ALONG THE LOWER PERIMETER OF THE SITE.
2. UNROLL A SECTION AT A TIME AND POSITION THE POSTS AGAINST THE BACK
(DOWNSTREAM)WALL OF THE TRENCH (NET SIDE AWAY FROM DIRECTION OF FLOW).
3. DRIVE THE POST INTO THE GROUND UNTIL THE NETTING IS APPROXIMATELY 2 INCHES FROM THE TRENCH BOTTOM.
4. LAY THE TOE—IN FLAP OF FABRIC ONTO THE UNDISTURBED BOTTOM OF THE TRENCH, BACKFILL THE TRENCH AND TAMP THE SOIL. STEEPER SLOPES REQUIRE AN INTERCEPT TRENCH.
5. JOIN SECTIONS AS SHOWN ABOVE.

## STABILIZED CONSTRUCTION ENTRANCE

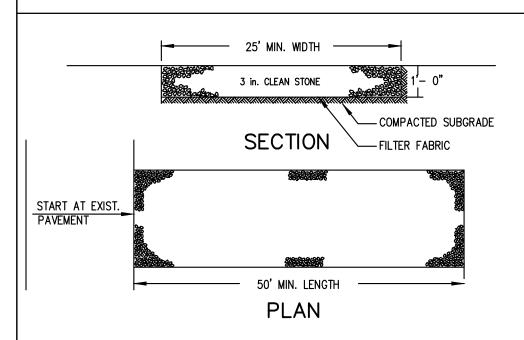

INSTALLATION NOTES:

1. STONE SIZE — USE 3" STONE, OR RECLAIMED OR RECYCLED CONCRETE EQUIVALENT.

2. LENGTH — AS REQUIRED, BUT NOT LESS THAN 50 FEET (EXCEPT ON A SINGLE RESIDENCE LOT WHERE A 30 FOOT MINIMUM LENGTH WOULD APPLY.

3. THICKNESS — NOT LESS THAN SIX (6) INCHES.

4. WDTH — 25 FOOT MINIMUM, BUT NOT LESS THAN THE FULL WIDTH AT POINTS WHERE INGRESS OR EGRESS OCCUR.


5. FILTER CLOTH — WILL BE PLACED OVER THE ENTIRE AREA PRIOR TO PLACING OF STONE. FILTER CLOTH WILL NOT BE REQUIRED ON A SINGLE FAMILY RESIDENCE LOT.

6. SURFACE WATER — ALL SURFACE WATER FLOWING OR DIVERTED TOWARD CONSTRUCTION ENTRANCES SHALL BE PIPED ACROSS THE ENTRANCE. IF PIPING IS IMPRACTICAL, A MOUNTABLE BERM WITH 5:1 SLOPES WILL BE PERMITTED.

7. MAINTENANCE — THE ENTRANCE SHALL BE MAINTAINED IN A CONDITION WHICH WILL PREVENT TRACKING OR FLOWING OF SEDIMENT ONTO PUBLIC RIGHT OF WAY THIS MAY REQUIRE PERIODIC TOP DRESSING WITH ADDITIONAL STONE AS CONDITIONS DEMAND AND REPAIR AND/OR CLEANOUT OF ANY MEASURES USED TO TRAP SEDIMENT. ALL SEDIMENT SPILLED, DROPPED, WASHED OR TRACKED ONTO PUBLIC RIGHT OF WAY MUST BE REMOVED IMMEDIATELY.

8. WASHING — WHEELS SHALL BE CLEANED TO REMOVE SEDIMENT PRIOR TO ENTRANCE ONTO PUBLIC RIGHT OF WAY, WHEN WASHING IS REQUIRED, IT SHALL BE DONE ON AN AREA STABILIZED WITH STONE AND WHICH DRAINS INTO AN APPROVED SEDIMENT TRAPPING DEVICE.

9. PERIODIC INSPECTION AND NEEDED MAINTENANCE SHALL BE PROVIDED AFTER EACH RAIN.

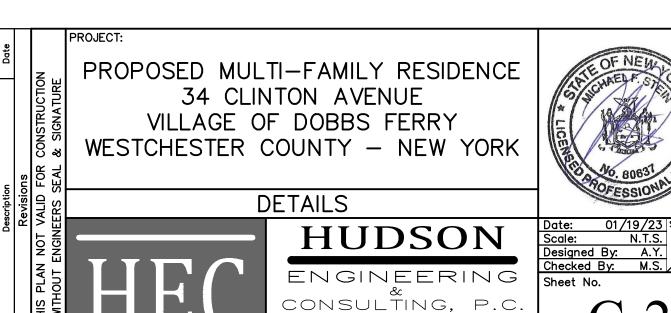

Knollwood Road — Suite 20 Elmsford, New York 10523

© 2023

T: 914-909-0420 F: 914-560-2086

ANY ALTERATIONS OR REVISIONS OF THESE PLANS, UNLESS DONE BY OR UNDER THE DIRECTION OF THE NYS LICENSED AND REGISTERED ENGINEER THAT PREPARED THEM, IS A VIOLATION OF THE NYS EDUCATION LAW.

