GENERAL REQUIREMENTS

1. Related Documents: Drawings, Specifications and General Conditions of the Contract for Construction apply to Work of this Project.

2. Scope of Work: Includes all items described in Drawings & Specifications, verbally & graphically, with more stringent and / or costly items assumed in all cases of discrepancy.

3. All new construction shall adhere to the 2020 Residential Code of New York State and the 2020 Energy Conservation Code of New York State. Notify Architect of any inadvertent noncompliance with Codes regarding information contained in Drawings and Specifications, with no Work to be performed knowingly in noncompliance with Code.

4. The General Contractor (G.C.) shall coordinate all work procedures w/ requirements of Local Authorities. Prior to commencement of Construction, the G.C. shall be responsible for the acquisition of a Building Permit and pay all fees required by Governing Agencies. The G.C. shall be responsible for calling for Inspections and Sign-offs of all Work, including Plumbing & Electrical, as required by Governing Agencies.

5. The G.C., Subcontractors, and all others working for Owner shall comply with National, State, and Local Laws and Regulations relating to insurance for work under this Contract. The following insurance policies shall be in force and copies shall be submitted to Architect prior to signing Agreement Between Owner and Contractor: Workman's Compensation & Unemployment Insurance as required by law, Contractor's Liability Coverage in the amount required by applicable Governing Agencies, & Liability Coverage for damages & uninstalled materials. The G.C. shall submit to the Owners, Insurance Certificates naming Owner as Additional Insured. All insurance shall be at Contractor's expense.

6. All Terms & Conditions laid out in the A.I.A. Standard Form Of General Conditions shall apply to the G.C. & to all of his Sub-Contractors.

7. The G.C. & Subcontractors shall attend regular job meetings as required by the Architect.

DIVISION 01: PROJECT REQUIREMENTS

1. The G.C. shall verify all Dimensions & Conditions in the field prior to Construction. Any discrepancies are to be brought to the attention of the Architect prior to work. The G.C. shall be responsible for Field Fit & Quality of all Work, whether by the G.C. or by Subcontractors. No allowances shall be made on behalf of the G.C. for any error or neglect on his part. Under no circumstances are the Drawings to be scaled for location of Work. G.C. shall verify all clearances & locations prior to installation including requirements for appliances, fixtures, or equipment.

2. Retain licensed Surveyor to mark site before beginning construction and to verify location of foundation and slab-on-grade formwork before pouring concrete. Verify that all work conforms to zoning requirements including all setbacks and yard requirements.

3. The G.C. shall be responsible for the protection of all new & existing Work, Owner's Property, Building, and its Premises from damage & dirt or dust.

4. Plumbing & Electrical Work shall be performed by Contractors licensed in their trade. G.C. shall be licensed to perform the Work as required.

5. The G.C. shall maintain at the Site one Record Copy of all Drawings, Clarification Sketches, Approved Shop Drawings, Approved Samples, and Change Orders continuously updated to record all changes during Construction. G.C. shall fully correct, at no additional expense, all Work wrongly constructed or materials wrongly ordered from obsolete Drawings.

6. Details not usually shown or specified, but necessary for proper construction on any part of the work shall be included as if they were indicated in the Drawings.

7. Architectural Drawings shall be Followed as closely as actual Field Conditions & the work of other trades permit. Any piping, wiring, or materials not specifically shown or specified but required to complete Work shall be deemed to be part of Work & shall be furnished & installed by the G.C. 8. G.C. shall prepare schedule for completion of Work prior to commencement and submit to Architect for approval. Contractor shall follow approved

schedule and immediately notify Architect of any deviations from the approved schedule.

9. The G.C. must submit all Engineering & Shop Drawings (including Millwork) & cut sheets of all equipment, plumbing & electrical fixtures, hardware & accessories to the Architect for approval prior to Fabrication, Ordering and/or Construction. Shop Drawings shall be revised per Architect's instruction if required prior to approval.

10. The G.C. shall supervise & be solely responsible for all aspects of the Work, including Site Safety, maintenance of exit clearances & fire extinguishers as required by Code. The G.C. shall have sole responsibility for any damage or injuries caused by or during the execution of the Work.

11. The G.C. shall be responsible for demolition & safe removal from the Site of all materials that must be removed to enable completion of Work and occupation of the Premises. All removed materials shall be disposed of regularly in a legal manner.

12. All piping & wiring to be demolished shall be removed to a point of concealment & shall be properly capped or plugged.

13. The G.C. shall do all cutting, patching & repairing as required to perform all Work required to complete the Job. All patching where new construction occurs shall match existing adjacent or as indicated on the Drawings.

14. All new construction shall be laid-out in field for Architect's approval prior to starting construction.

15. No changes to approved layouts shall be made without Written Consent Of The Architect

16. When "Approved Equal", "Equal To", "Similar" or other general qualifying terms are used, it shall be subject to final review by the Architect. There shall

be no substitutions unless agreed upon in writing by the Architect. 17. The G.C. shall verify all equipment dimensions, locations & hook-ups with Manufacturer's Specifications whether the G.C. or Others supply the equipment

18. All items noted "Furnished By Owner" shall be installed by the G.C. under this Contract as per Manufacturers' Specifications & industry standards. Wall reinforcement & all other requirements required to incorporate Owner furnished items shall be provided & coordinated by the G.C.

19. G.C. shall employ experienced workers or professional cleaners for final cleaning prior to request of inspection for Certificate of Substantial Completion.

STRETCH ENERGY CODES

1. This design is in compliance with requirements of 2020 Energy Conservation Code of NYS, the 2020 Residental Code

of NYS, and the 2020 NYStretch Code. 2. Contractor shall perform all work in accordance with applicable codes listed above.

3. Updated Table R420.1.4 below showing updated values prevails where applicable.

WESTCHESTER NY: CLIMATE ZONE 4A

2020 ENERGY CONSERVATION CODE OF NEW YORK STATE

49

49

Table R40)2.1.2 – Env	elope (U-fa	ctor Table	R402.1.4 ch	anged acco	ordingly. Pre	scriptive,	e.g., can be t	raded.)	
Climate	Fen	SkyLt	SHGC	Ceiling	Wood	Mass	Floor	Bsmt	Slab	Crawl Sp
Zone 4	U-Factor	U-Factor		R-Val	Wall	Wall	R-Val	Wall	R-Value/	Wall

Zone 4	U-Factor	U-Factor	SHGC R-V		Vall R-Value	R-Value	R-Val	Wa R-va	alue R-Va		all Value
Stretch Code	0.27	0.50	.04 49	2	21 or 20+5 or 3+10	15/20	30ª	15/1	9 10, 4	ft. 15.	/19
INSULATION AND FENESTRATION REQUIREMENTS BY COMPONENT ^a											
CLIMATE ZONE	FENESTRATION <i>U</i> -FACTOR ^b	SKYLIGHT [®] U-FACTOR	LEENEGTDATION	CEILING <i>R</i> -VALUE	WO FRAME <i>R</i> -VA		MASS WALL <i>R</i> -VALUE	FLOOR <i>R</i> -VALUE	BASEMENT [®] WALL <i>R</i> -VALUE	SLAB ^d <i>R</i> -VALUE & DEPTH	CRAWL SPACE [°] WALL <i>R</i> -VALUE
1	NR	0.75	0.25	30	1	3	3/4	13	0	0	0
2	0.40	0.65	0.25	38	1	3	4/6	13	0	0	0
-	0.40	0.05	0.25	50	-	5	-10	10	U U	U U	

0.30 7 and 8 0.30

0.32 _0.27_

0.30

0.55

0.55

0.55

0.55

For SI: 1 foot = 304.8 mm.

4 except

Marine

Marine 4

5 and

NR = Not Required.

a. R-values are minimums. U-factors and SHGC are maximums. Where insulation is installed in a cavity that is less than the label or design thickness of the insulation, the installed *R*-value of the insulation shall be not less than the *R*-value specified in the table. b. The fenestration U-factor column excludes skylights. The SHGC column applies to all glazed fenestration.

20 or $13 + 5^{h}$

20 or $13 + 5^{h}$ 13/17

49 $20 + 5^{h} \text{ or } 13 + 10^{h}$ 15/20 30^{g}

8/13

10/13

15/19

10, 2 ft | 10/13

10, 2 ft | 15/19

15/19 10,4 ft 15/19

19

30^g

 $49 \quad 20 + 5^{h} \text{ or } 13 + 10^{h} \quad 19/21 \quad 38^{g} \quad 15/19 \quad 10, 4 \text{ ft} \quad 15/19$

c. "10/13" means R-10 continuous insulation on the interior or exterior of the home or R-13 cavity insulation on the interior of the basement wall. "15/19" means R-15 continuous insulation on the interior or exterior of the home or R-19 cavity insulation on the interior of the basement wall. Alternatively, compliance with "15/19" shall be R-13 cavity insulation on the interior of the basement wall plus R-5 continuous insulation on the interior of the home.

d. R-5 insulation shall be provided under the full slab area of a heated slab in addition to the required slab edge insulation *R*-value for slabs, as indicated in the table. The slab edge insulation for heated slabs shall not be required to extend below the slab. e. Reserved.

f. Reserved

g. Alternatively, insulation sufficient to fill the framing cavity providing not less than an R-value of R-19.

0.40

NR

NR

NR


h. The first value is cavity insulation, the second value is continuous insulation. Therefore, as an example, "13+5" means R-13 cavity insulation plus R-5 continuous insulation i. Mass walls shall be in accordance with Section N1102.2.5. The second *R*-value applies where more than half of the insulation is on the interior of the mass

wall.

1. This design is in compliance with requirements of 2020 Residential Code of New York State and the 2020 Energy **Conservation Code of New York State.**

2. Contractor shall perform all work in accordance with applicable codes as listed in the 2020 NYS Code Books.



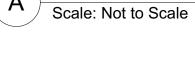

GENERAL CONDITIONS

SITE AT ALL TIMES.

PROVIDE STRAPPING AS REQUIRED TO RESIST HIGH WIND AND UPLIFT FORCES TO BE IN COMPLIANCE WITH TABLE R802.11 OF THE NY STATE RESIDENTIAL CODE. USE TENSION TIES EQUAL TO SIMPSON MODEL # H2 OR AS INDICATED AT ALL POST-PLATE-RAFTER CONNECTIONS.

OF TYPE-V CONSTRUCTION.

CLIMATE AND GEOGRAPHIC DESIGN CRITERIA

2020 INTERNATIONAL RESIDENTIAL CODE **CHAPTER 3 - BUILIDING PLANNING** SECTION R301 DESIGN CRITERIA WESTCHESTER, NY: CLIMATE ZONE 4

GROUND WIND SNOW SPEED LOAD (MPH) 30 PSF 115-120

STRUCTURAL & LOADING NOTES

Soil Bearing Capacity: Design bearing capacity of soil shall be 2,000 PSI in accordance with 2020 Residential Code of New York State R401.4.1 for Sand, Silty Sand, Clayey Sand **Concrete Compressive Strength** Shall be Min. 3,000 PSI at exposed exterior walls; shall be Min. 2,500 PSI at basement slabs; and shall be Min. 3,500 PSI at horizontal surfaces exposed to the weather including porches, steps, walks, and garage floor slabs, all to be in compliance with the 2020 Residential Code of New York State


Required Placard

Architect.

High Wind Connections all post-plate-rafter connections.

Modifications to 164 PALISADE STREET

APPLICATION # A 2022 - 0449

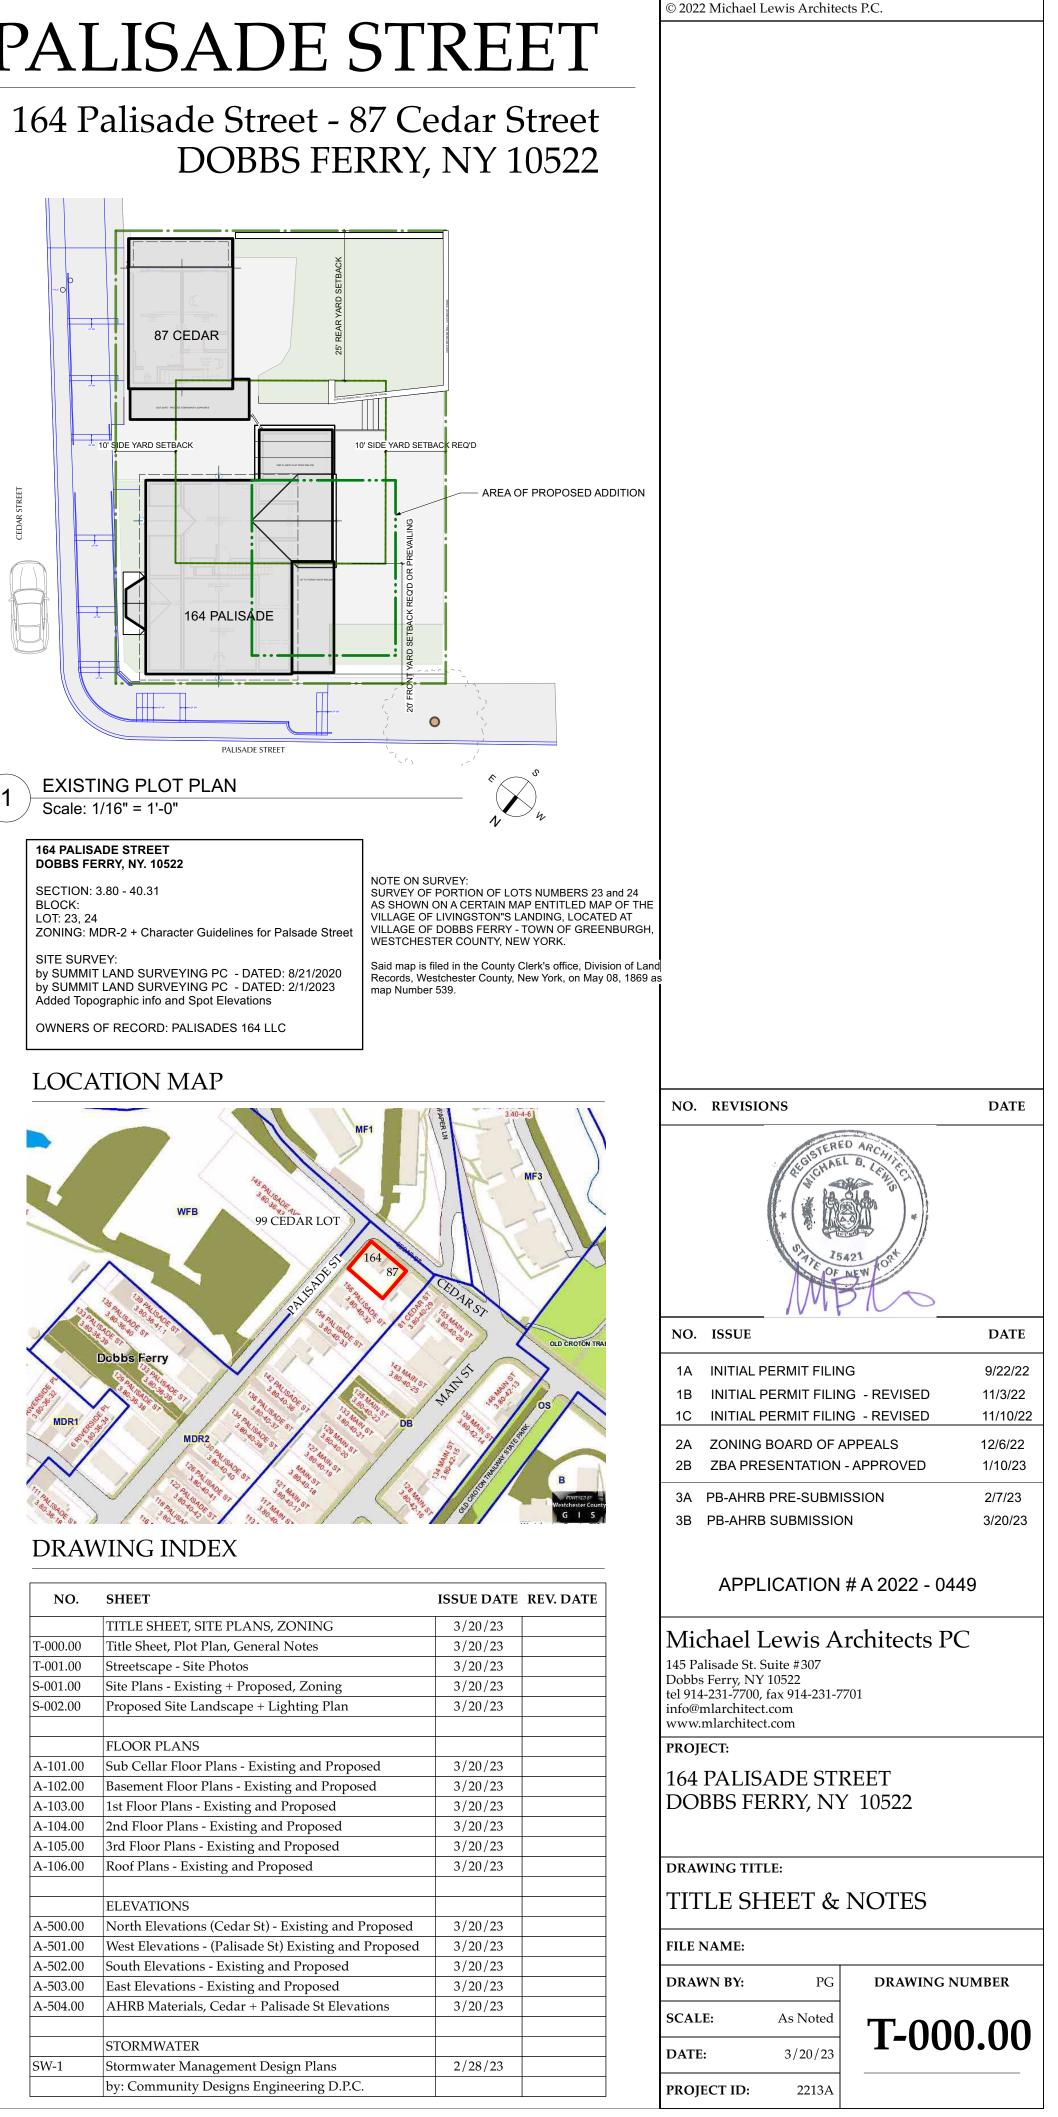

1. APPROVED STAMPED SET OF BUILDING PLANS MUST BE PRESENT ON

2. LICENSED ELECTRICIAN TO FILE ELECTRICAL PERMIT

HIGH WIND CONNECTIONS

PRE-ENGINEERED WOOD PLACARDING

CONTRACTOR SHALL PROVIDE PLACARD AS REQUIRED BY CODE, 6" DIA. CIRCLE WITH RED REFLECTIVE PRINT ON WHITE BACKGROUND,


INDICATING THAT PRE-ENGINEERED WOOD HAS BEEN USED IN CONSTRUCTION. PLACARD SHALL BE PLACED AT EXTERIOR ON OR NEAR ELECTRIC METER IN PLAIN VIEW AND INDICATE THAT PRE-ENGINEERED WOOD HAS BEEN USED FOR ROOF AND FLOOR SUPPORT IN THE BUILDING


TABLE R301.2(1) CLIMATIC AND GEOGRAPHIC DESIGN CRITERIA

TOPOGRAPHIC	SPECIAL	WIND-BORNE	SEISMIC	SUBJECT TO DAMAGE FROM		WINTER	ICE BARRIER	FLOOD	AIR	MEAN	
EFFECTS	WIND REGION	DEBRIS ZONE	DESIGN CATEGORY	WEATHERING	FROST DEPTH	TERMITE	DESIGN TEMP	UNDERLAYMENT REQUIRED	HAZARDS	FREEZING INDEX	ANNUAL TEMP
NO	YES	NO	С	SEVERE	3'6"	MODERATE/ HEAVY	15°F	YES	NO	2000	51.6°F

Provide exterior placard as required by code indicating that engineered lumber is used for roof support in a Class V structure. Placard is to be permanentlymounted for display as required near electrical meter or as directed in field by

Provide strapping as required to resist high wind and uplift forces to be in compliance with table R802.11 of the Code. Use tension tie equal to Simpson model # HTT22 at all footing-post connections and equal to Simpson model #H2 at

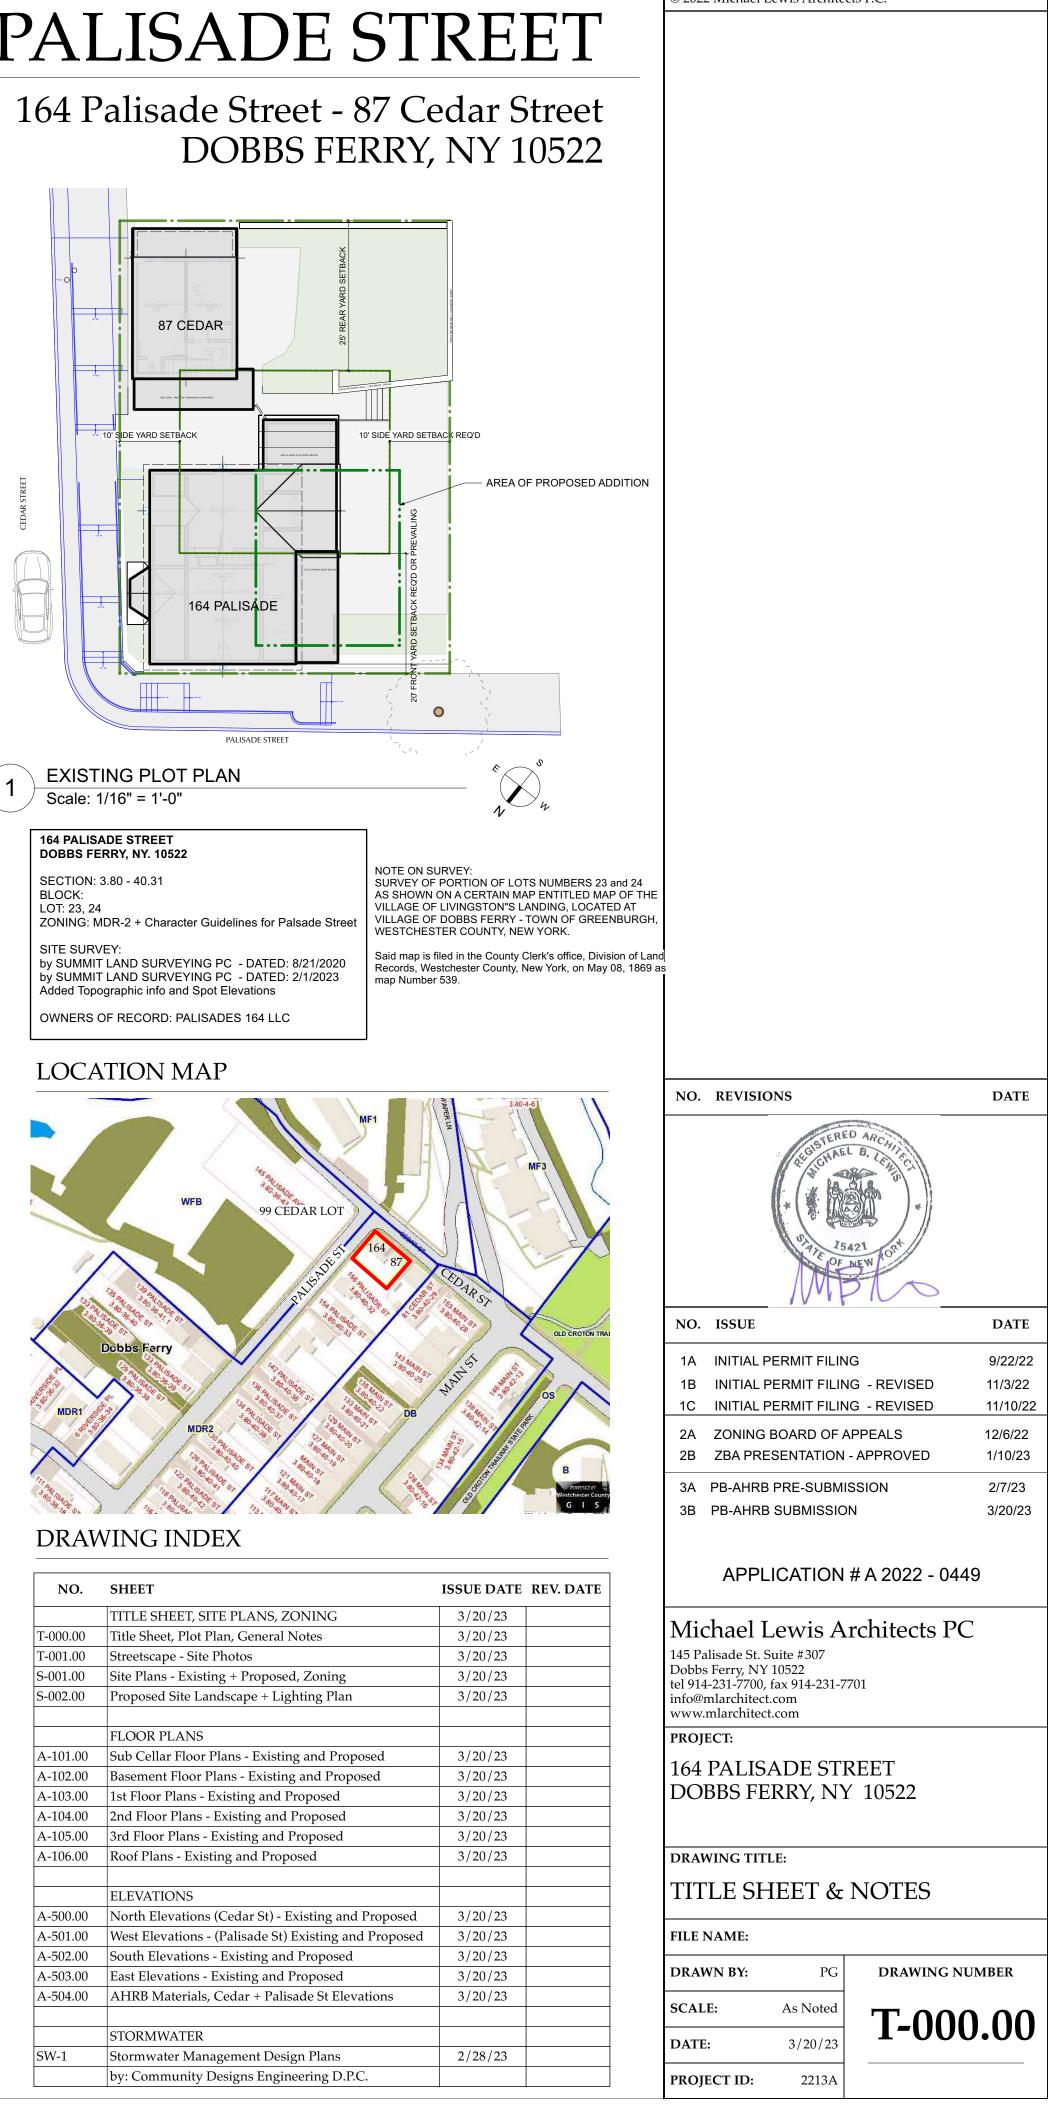

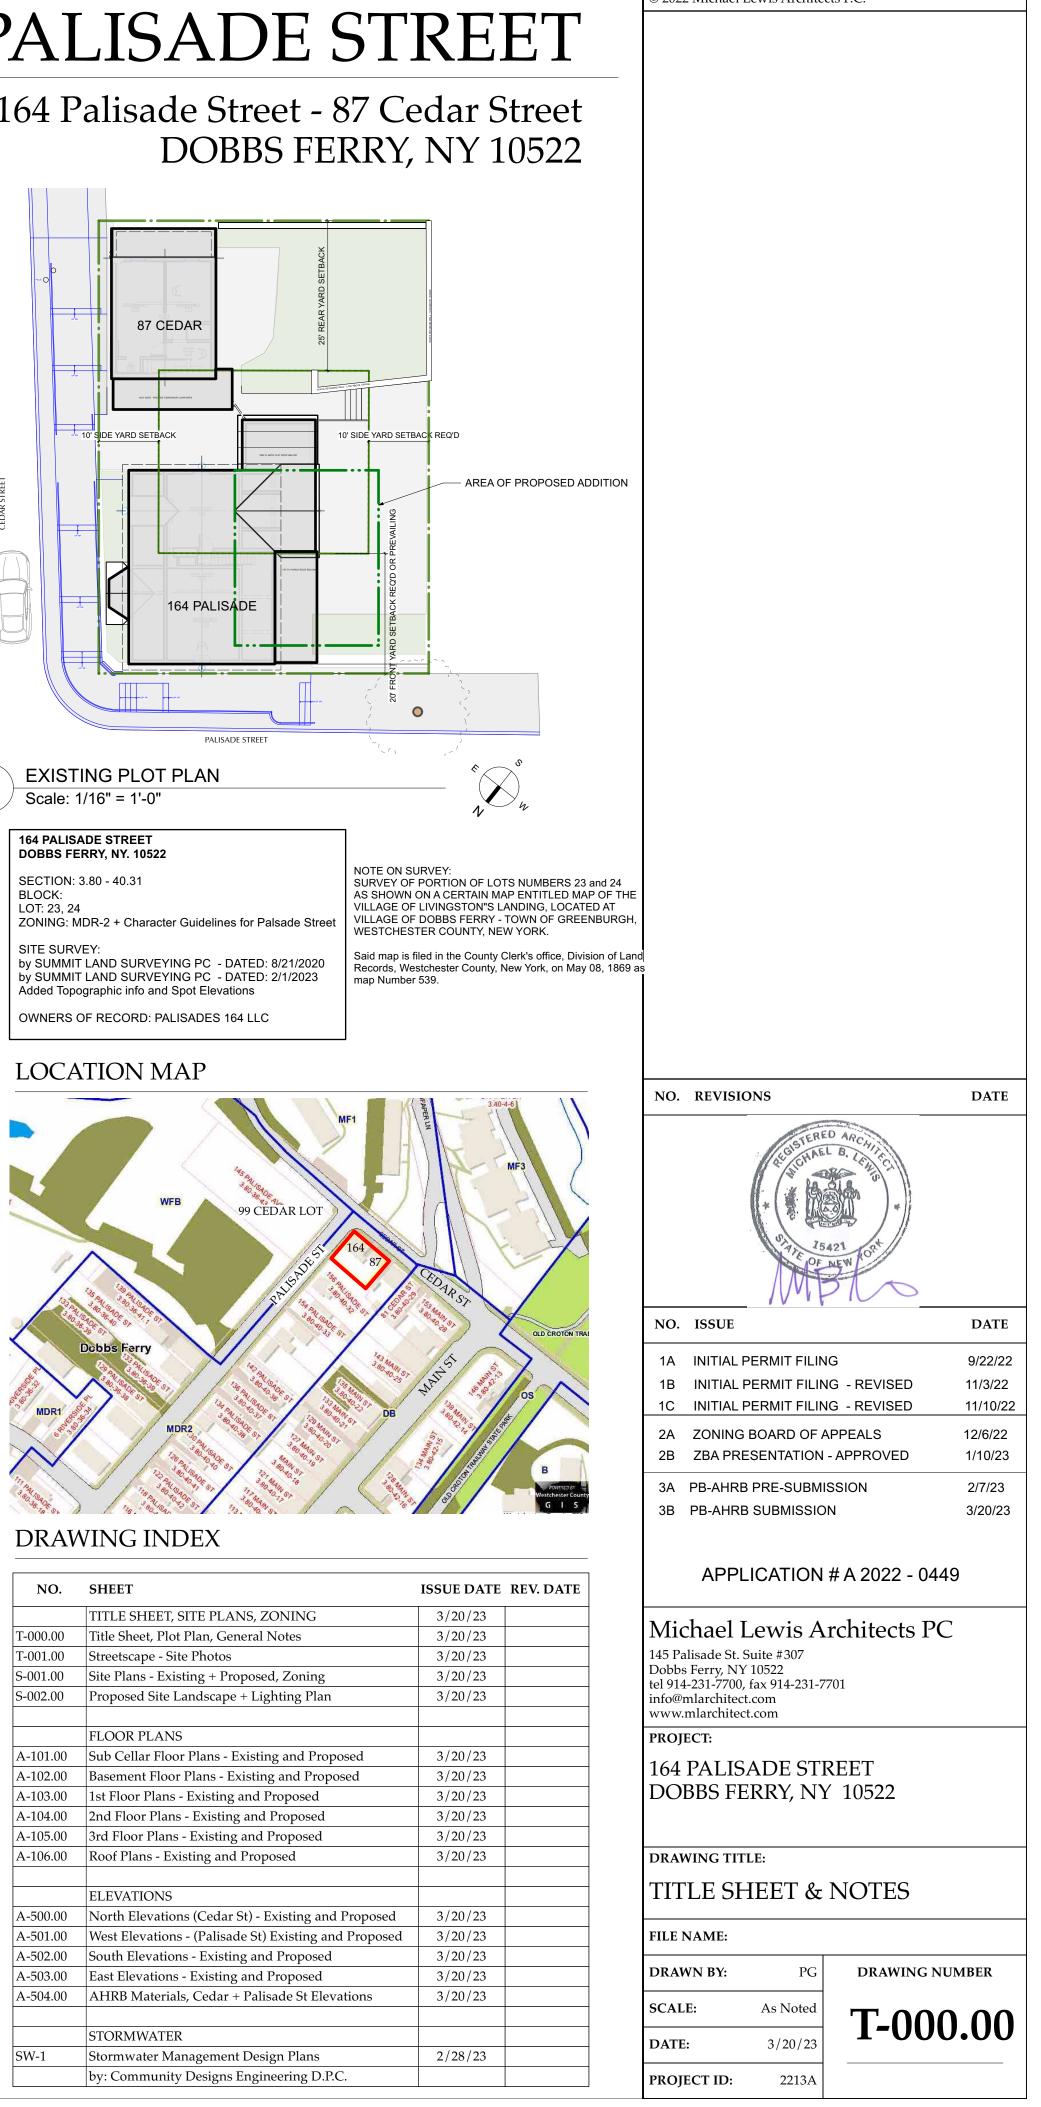



LOOKING UP CEDAR ST - toward Main St

81 CEDAR ST



LOOKING UP CEDAR at 164 PALISADE ST



CORNER OF CEDAR ST and PALISADE ST



CORNER OF CEDAR ST and PALISADE ST - above



SIDEYARD - Looking toward Cedar St from above 156 Palisade St

© 2022 Michael Lewis Architects P.C. Modifications to 164 PALISADE STREET APPLICATION # A 2022 - 0449 164 Palisade Street - 87 Cedar Street DOBBS FERRY, NY 10522 164 PALISADE ST - CEDAR ST SIDE 87 CEDAR ST 164 PALISADE ST 87 CEDAR ST 164 PALISADE ST NO. REVISIONS DATE 164 PALISADE STREET - in front of 156 Palisade St 164 PALISADE STREET - in front of 154 Palisade St NO. ISSUE DATE 1A INITIAL PERMIT FILING 9/22/22 1B INITIAL PERMIT FILING - REVISED 11/3/22 1C INITIAL PERMIT FILING - REVISED 11/10/22 2A ZONING BOARD OF APPEALS 12/6/22 2B ZBA PRESENTATION 1/10/23 3A PB-AHRB PRE-SUBMISSION 2/7/23 3B PB-AHRB SUBMISSION 3/20/23 APPLICATION # A 2022 - 0449 Michael Lewis Architects PC 145 Palisade St. Suite #307 Dobbs Ferry, NY 10522 tel 914-231-7700, fax 914-231-7701 info@mlarchitect.com www.mlarchitect.com PROJECT: 164 PALISADE STREET DOBBS FERRY, NY 10522 **DRAWING TITLE:** STREETSCAPE - SITE PHOTOS REAR YARD - Looking down toward Palisade St REAR YARD - Looking at 164 Palisade St and 87 Cedar St FILE NAME: DRAWING NUMBER DRAWN BY: SCALE: As Noted **T-001.00** 3/20/23 DATE: **PROJECT ID:** 2213A

STREETSCAPE PHOTOS - CEDAR STREET





83 CEDAR ST

83 CEDAR ST


STREETSCAPE PHOTOS - CEDAR to PALISADE STREET

164 PALISADE STREET - FRONT

SITE + BUILDING PHOTOS

CEDAR ST - Looking down Cedar St - 99 Cedar Lot below



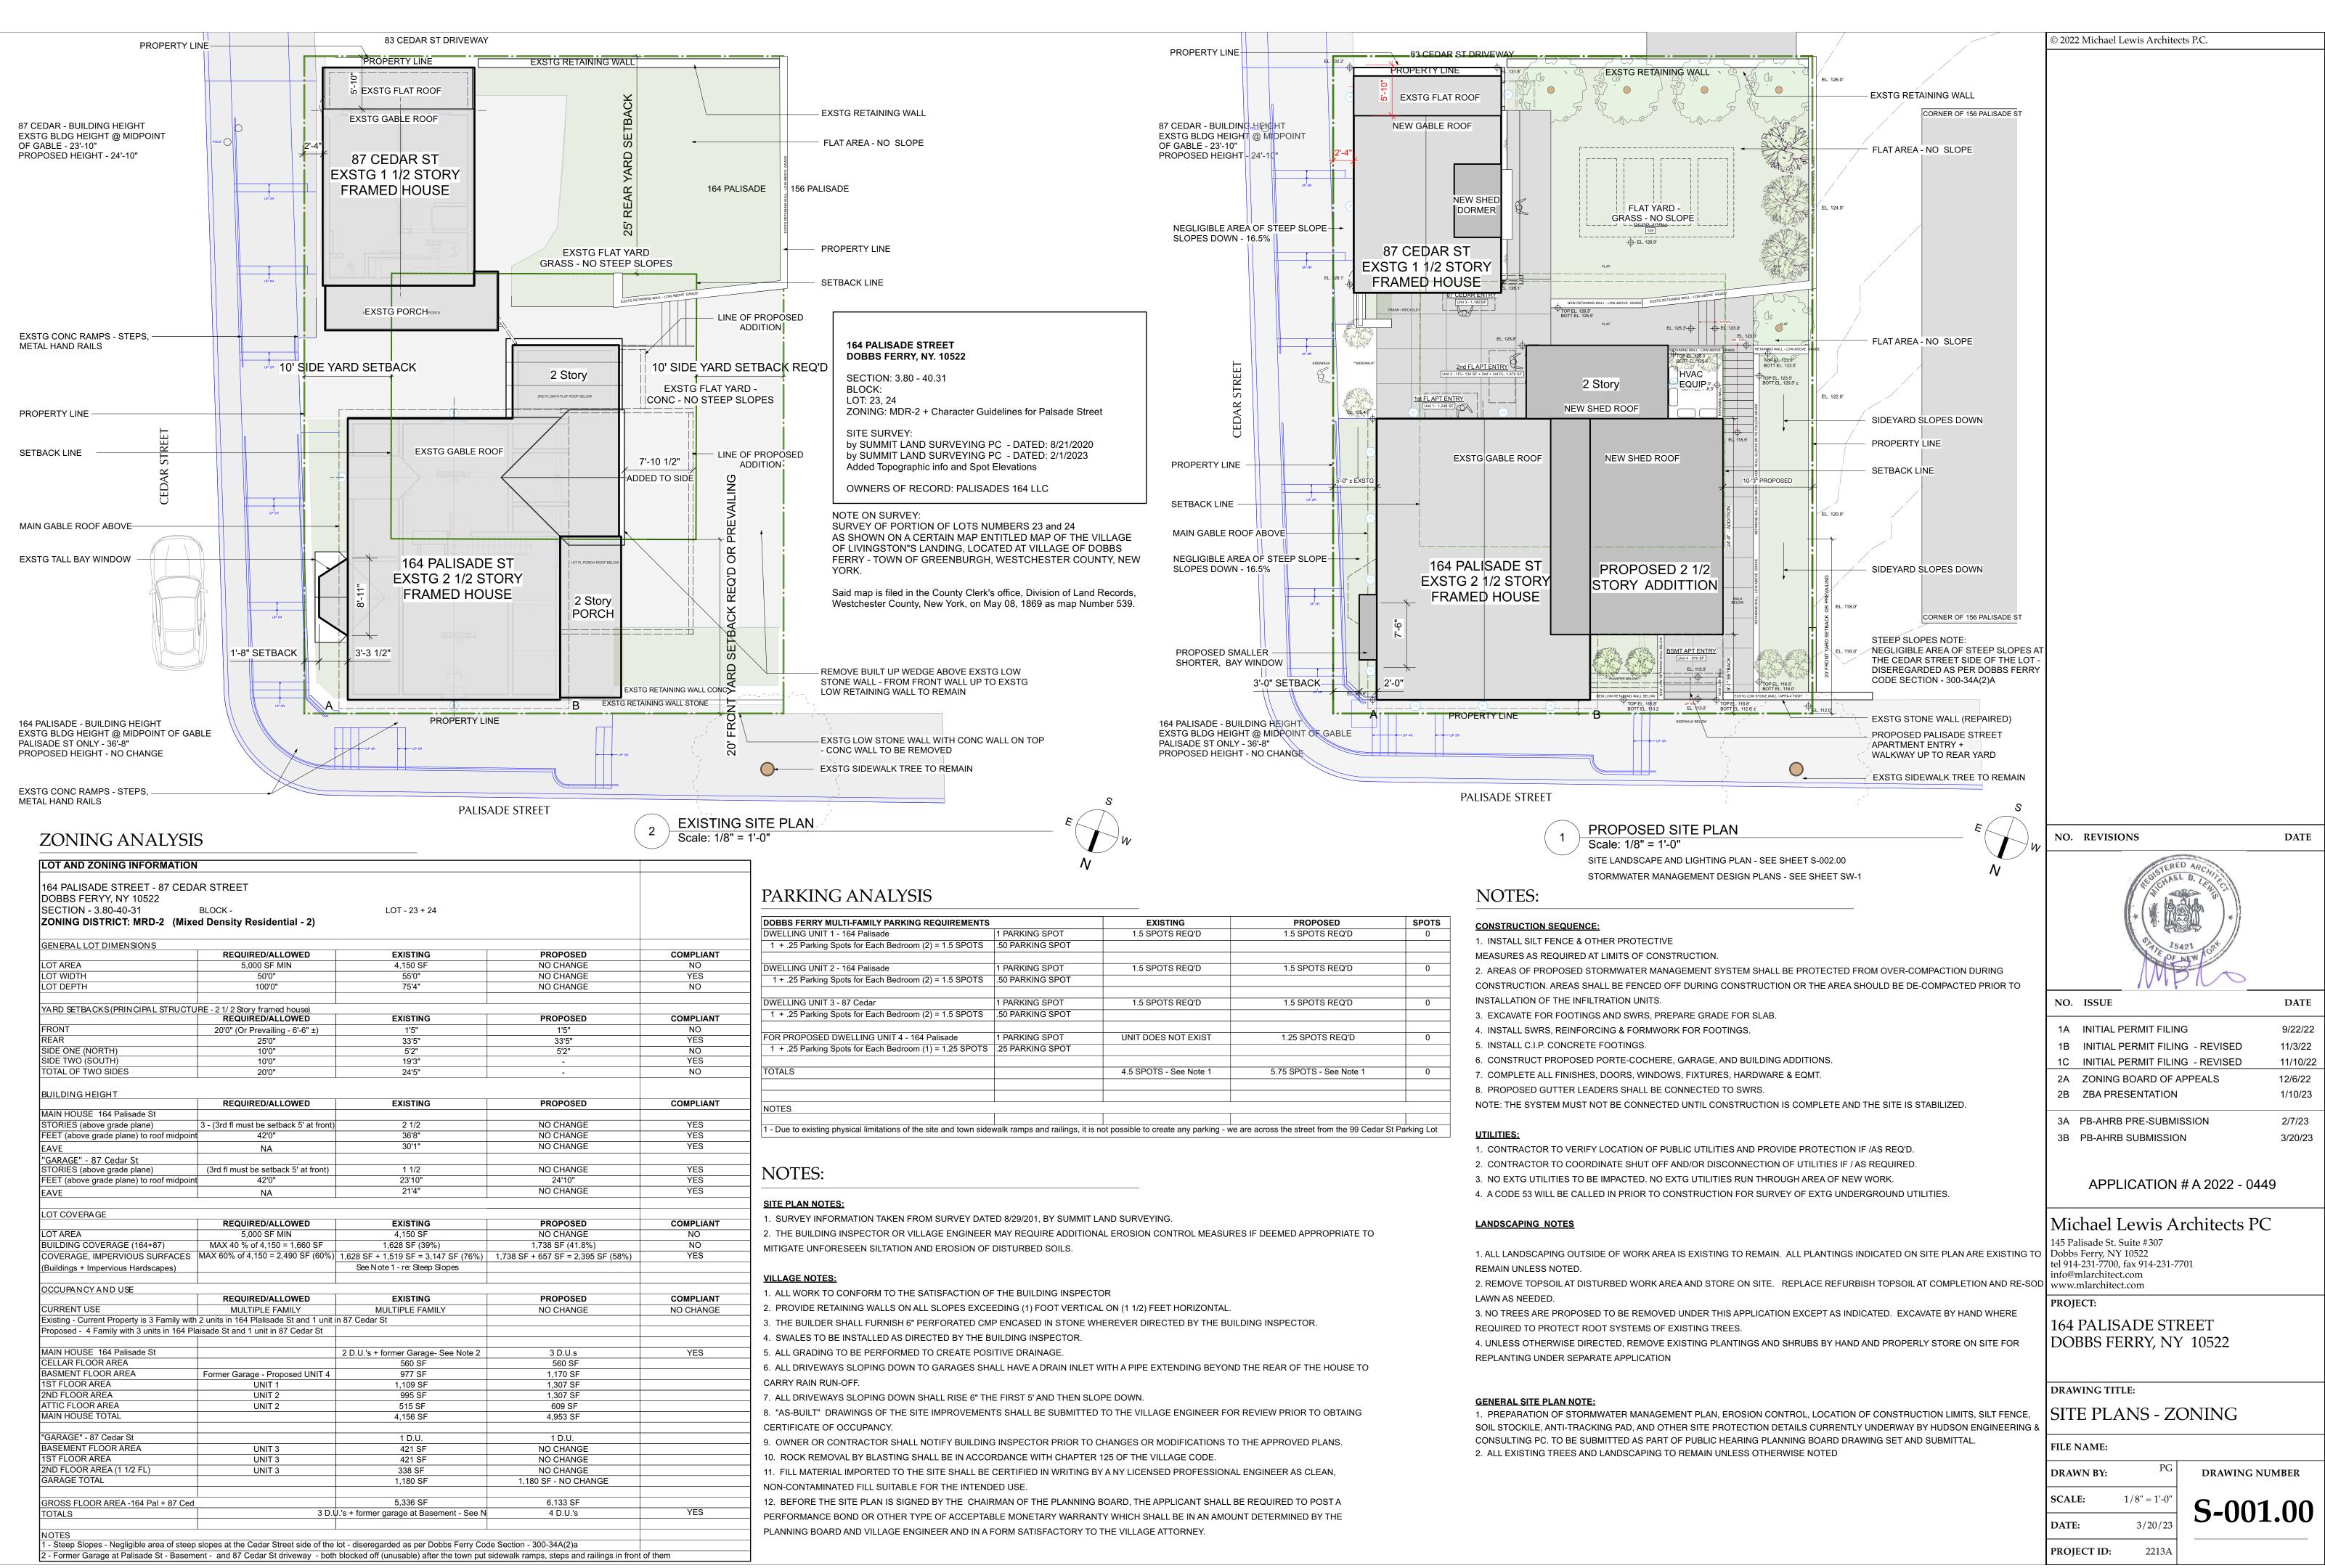

DOBBS FERRY MULTI-FAMILY PARKING REQUIREMENTS		EXISTING	PROPOSED	SPOTS
DWELLING UNIT 1 - 164 Palisade	1 PARKING SPOT	1.5 SPOTS REQ'D	1.5 SPOTS REQ'D	0
1 + .25 Parking Spots for Each Bedroom (2) = 1.5 SPOTS	.50 PARKING SPOT			
DWELLING UNIT 2 - 164 Palisade	1 PARKING SPOT	1.5 SPOTS REQ'D	1.5 SPOTS REQ'D	0
1 + .25 Parking Spots for Each Bedroom (2) = 1.5 SPOTS	.50 PARKING SPOT			
DWELLING UNIT 3 - 87 Cedar	1 PARKING SPOT	1.5 SPOTS REQ'D	1.5 SPOTS REQ'D	0
1 + .25 Parking Spots for Each Bedroom (2) = 1.5 SPOTS	.50 PARKING SPOT			
FOR PROPOSED DWELLING UNIT 4 - 164 Palisade	1 PARKING SPOT	UNIT DOES NOT EXIST	1.25 SPOTS REQ'D	0
1 + .25 Parking Spots for Each Bedroom (1) = 1.25 SPOTS	.25 PARKING SPOT			
TOTALS		4.5 SPOTS - See Note 1	5.75 SPOTS - See Note 1	0
NOTES				












PROPERTY LINE		UP 2F	EL. 32.
WALL MOUNTED SCONC		UP 2F	EL. 28.
SEE LIGHTING LEGEND			SIDEWALK
SETBACK LINE	E	UP	2R
NEGLIGIBLE AREA OF STE SLOPES DOWN - 16.5%	EEP SLOP	E	•
SEE LIGHTING LEGEND			JP 2R
PROPOSED SMALLER SHORTER, BAY WINDOV	v	3'-0" SETBA	JCK UP 3R

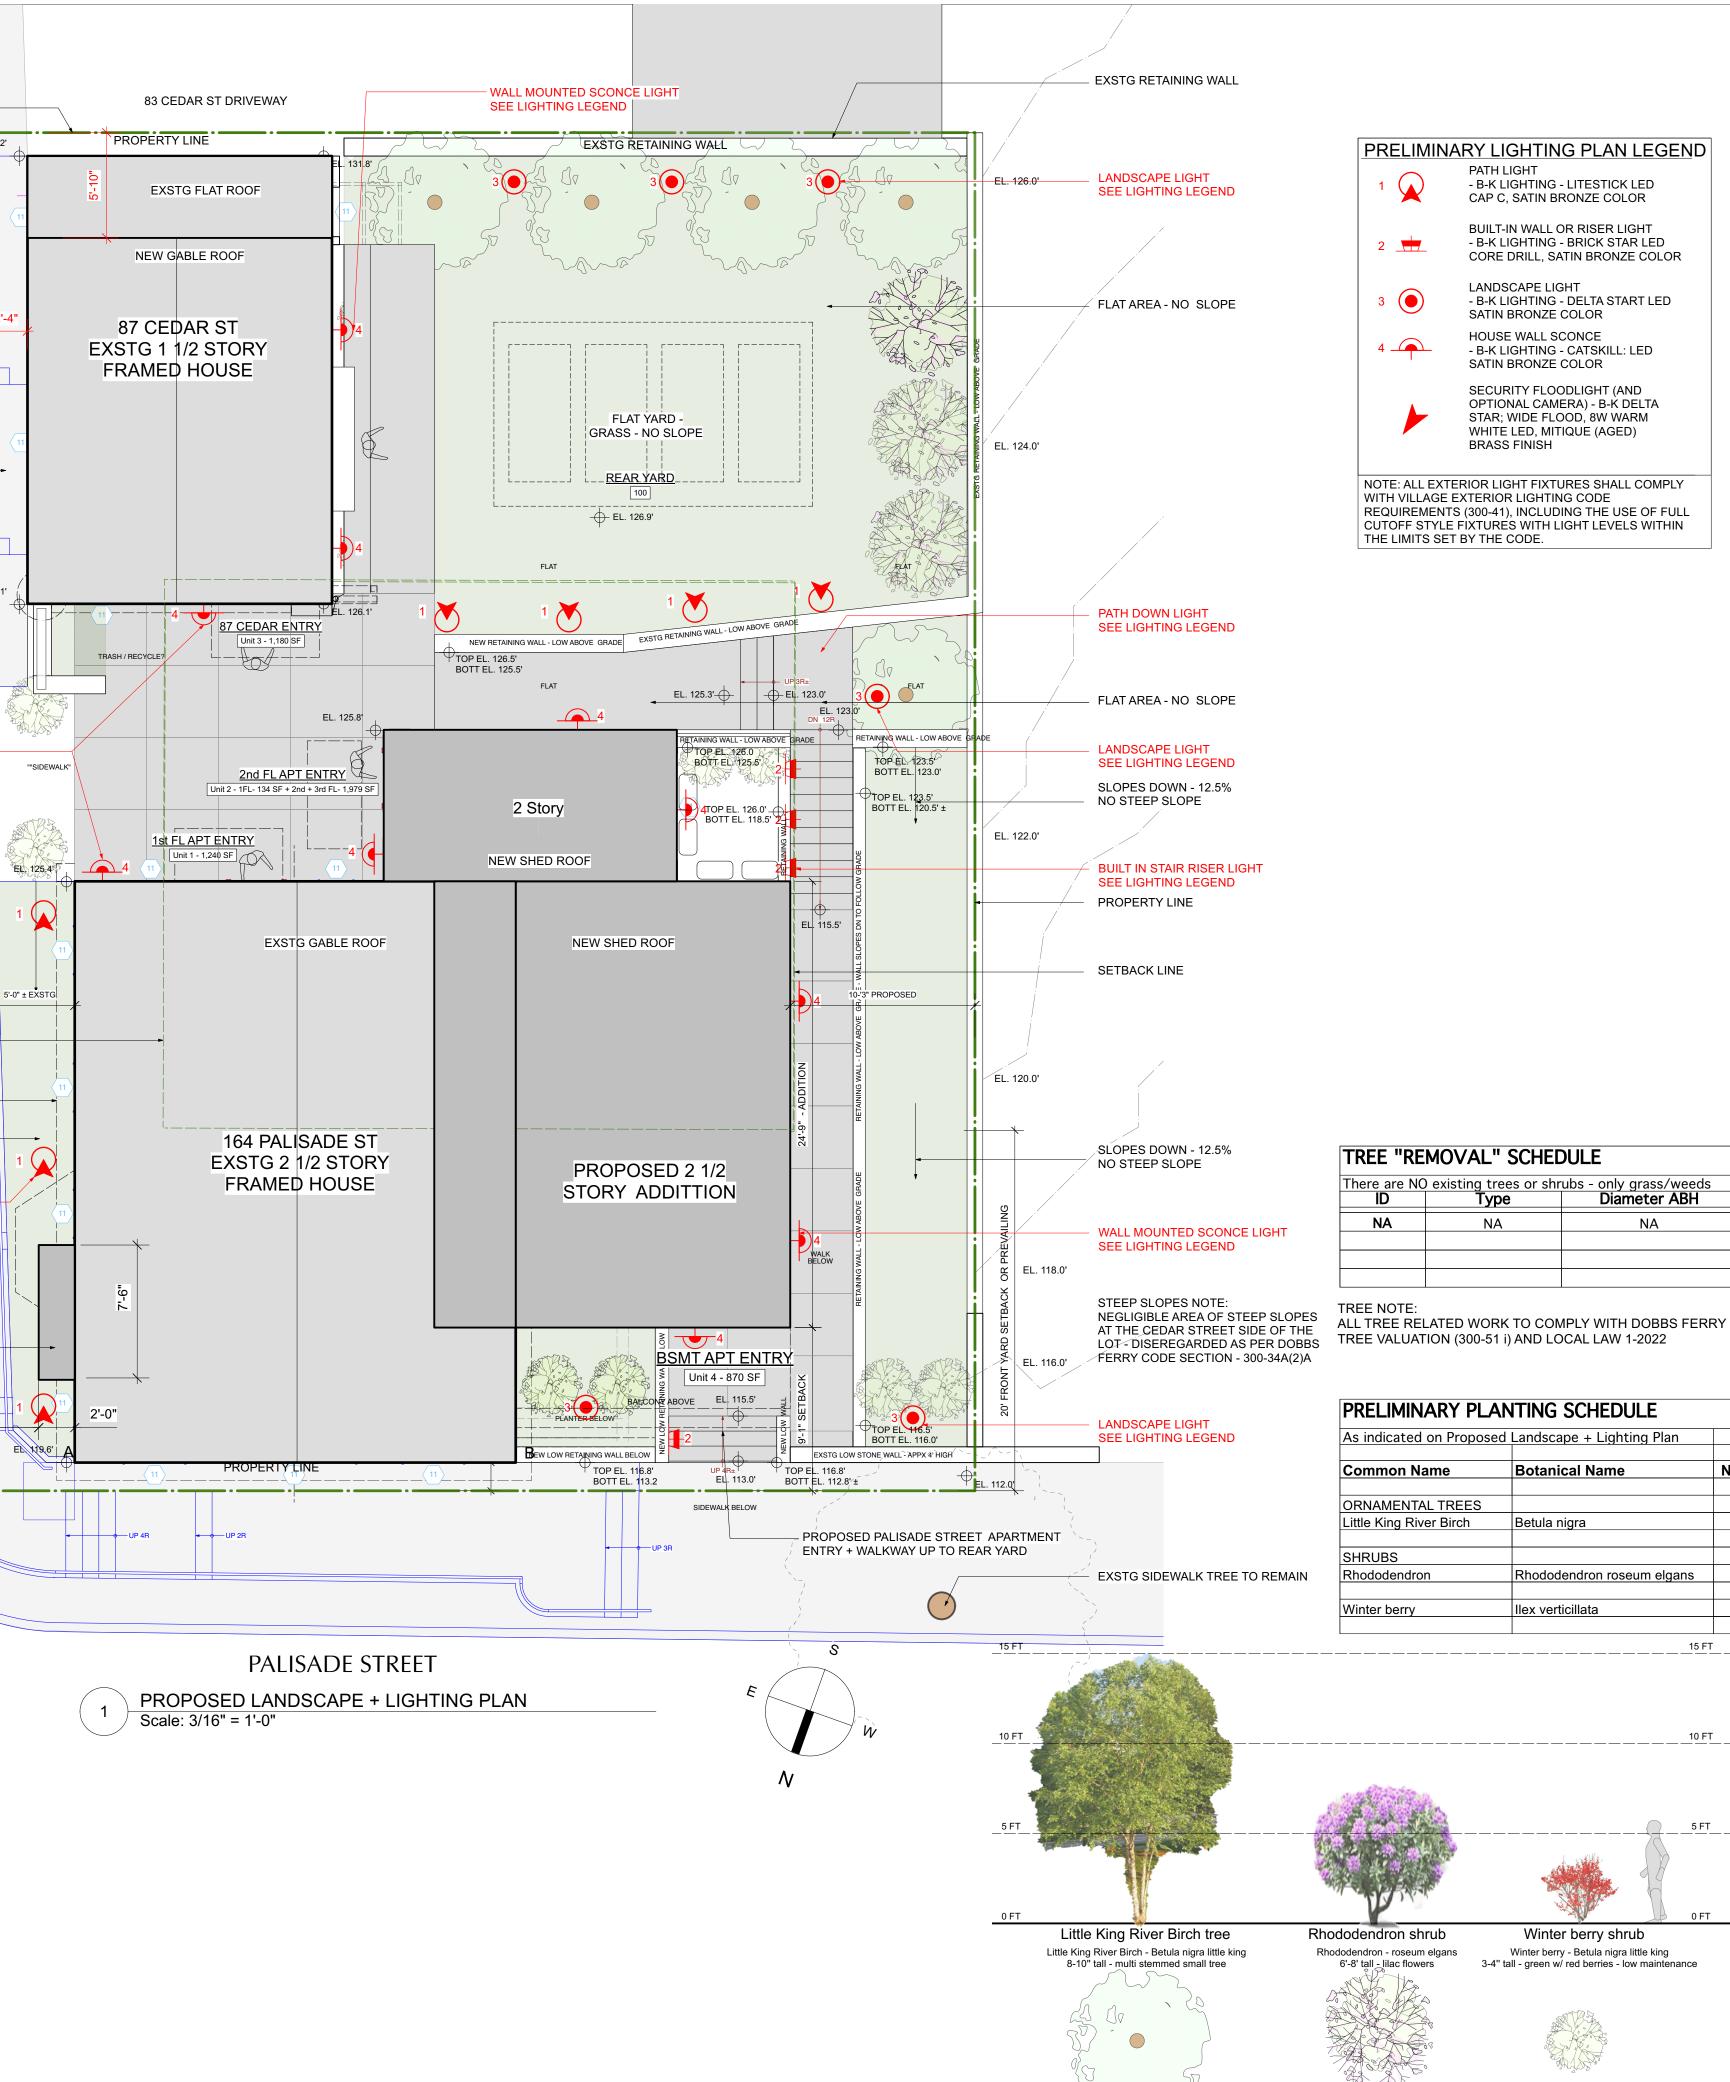

MOVAL" SCHEI	
	Diameter ABH
Туре	
NA	NA
	existing trees or shr Type

ALL TREE RELATED WORK TO COMPLY WITH DOBBS FERRY

PRELIMINAR	Y PLAN	ITING S	SCHEDU	LE
As indicated on	Proposed I	Landscap	e + Lightir	ng Plan

Common Name	Botanical Name	Nativ
ORNAMENTAL TREES		
Little King River Birch	Betula nigra	Yes
SHRUBS		
Rhododendron	Rhododendron roseum elgans	Yes
Winter berry	llex verticillata	Yes
		165
	15 F	т

NO. REVISIONS

DATE



NO. ISSUE

NO.	ISSUE	DATE
1A	INITIAL PERMIT FILING	9/22/22
1B	INITIAL PERMIT FILING - REVISED	11/3/22
1C	INITIAL PERMIT FILING - REVISED	11/10/22
2A	ZONING BOARD OF APPEALS	12/6/22

1/10/23 2B ZBA PRESENTATION 3A PB-AHRB PRE-SUBMISSION 2/7/23 3B PB-AHRB SUBMISSION 3/20/23

APPLICATION # A 2022 - 0449

Michael Lewis Architects PC 145 Palisade St. Suite #307 Dobbs Ferry, NY 10522 tel 914-231-7700, fax 914-231-7701 info@mlarchitect.com www.mlarchitect.com **PROJECT:**

164 PALISADE STREET DOBBS FERRY, NY 10522

DRAWING TITLE:

LANDSCAPE + LIGHTING PLAN

FILE NAME: PG **DRAWN BY:** 1/8'' = 1'-0'SCALE: 3/20/23 DATE: **PROJECT ID:** 2213A


DRAWING NUMBER

S-002.00







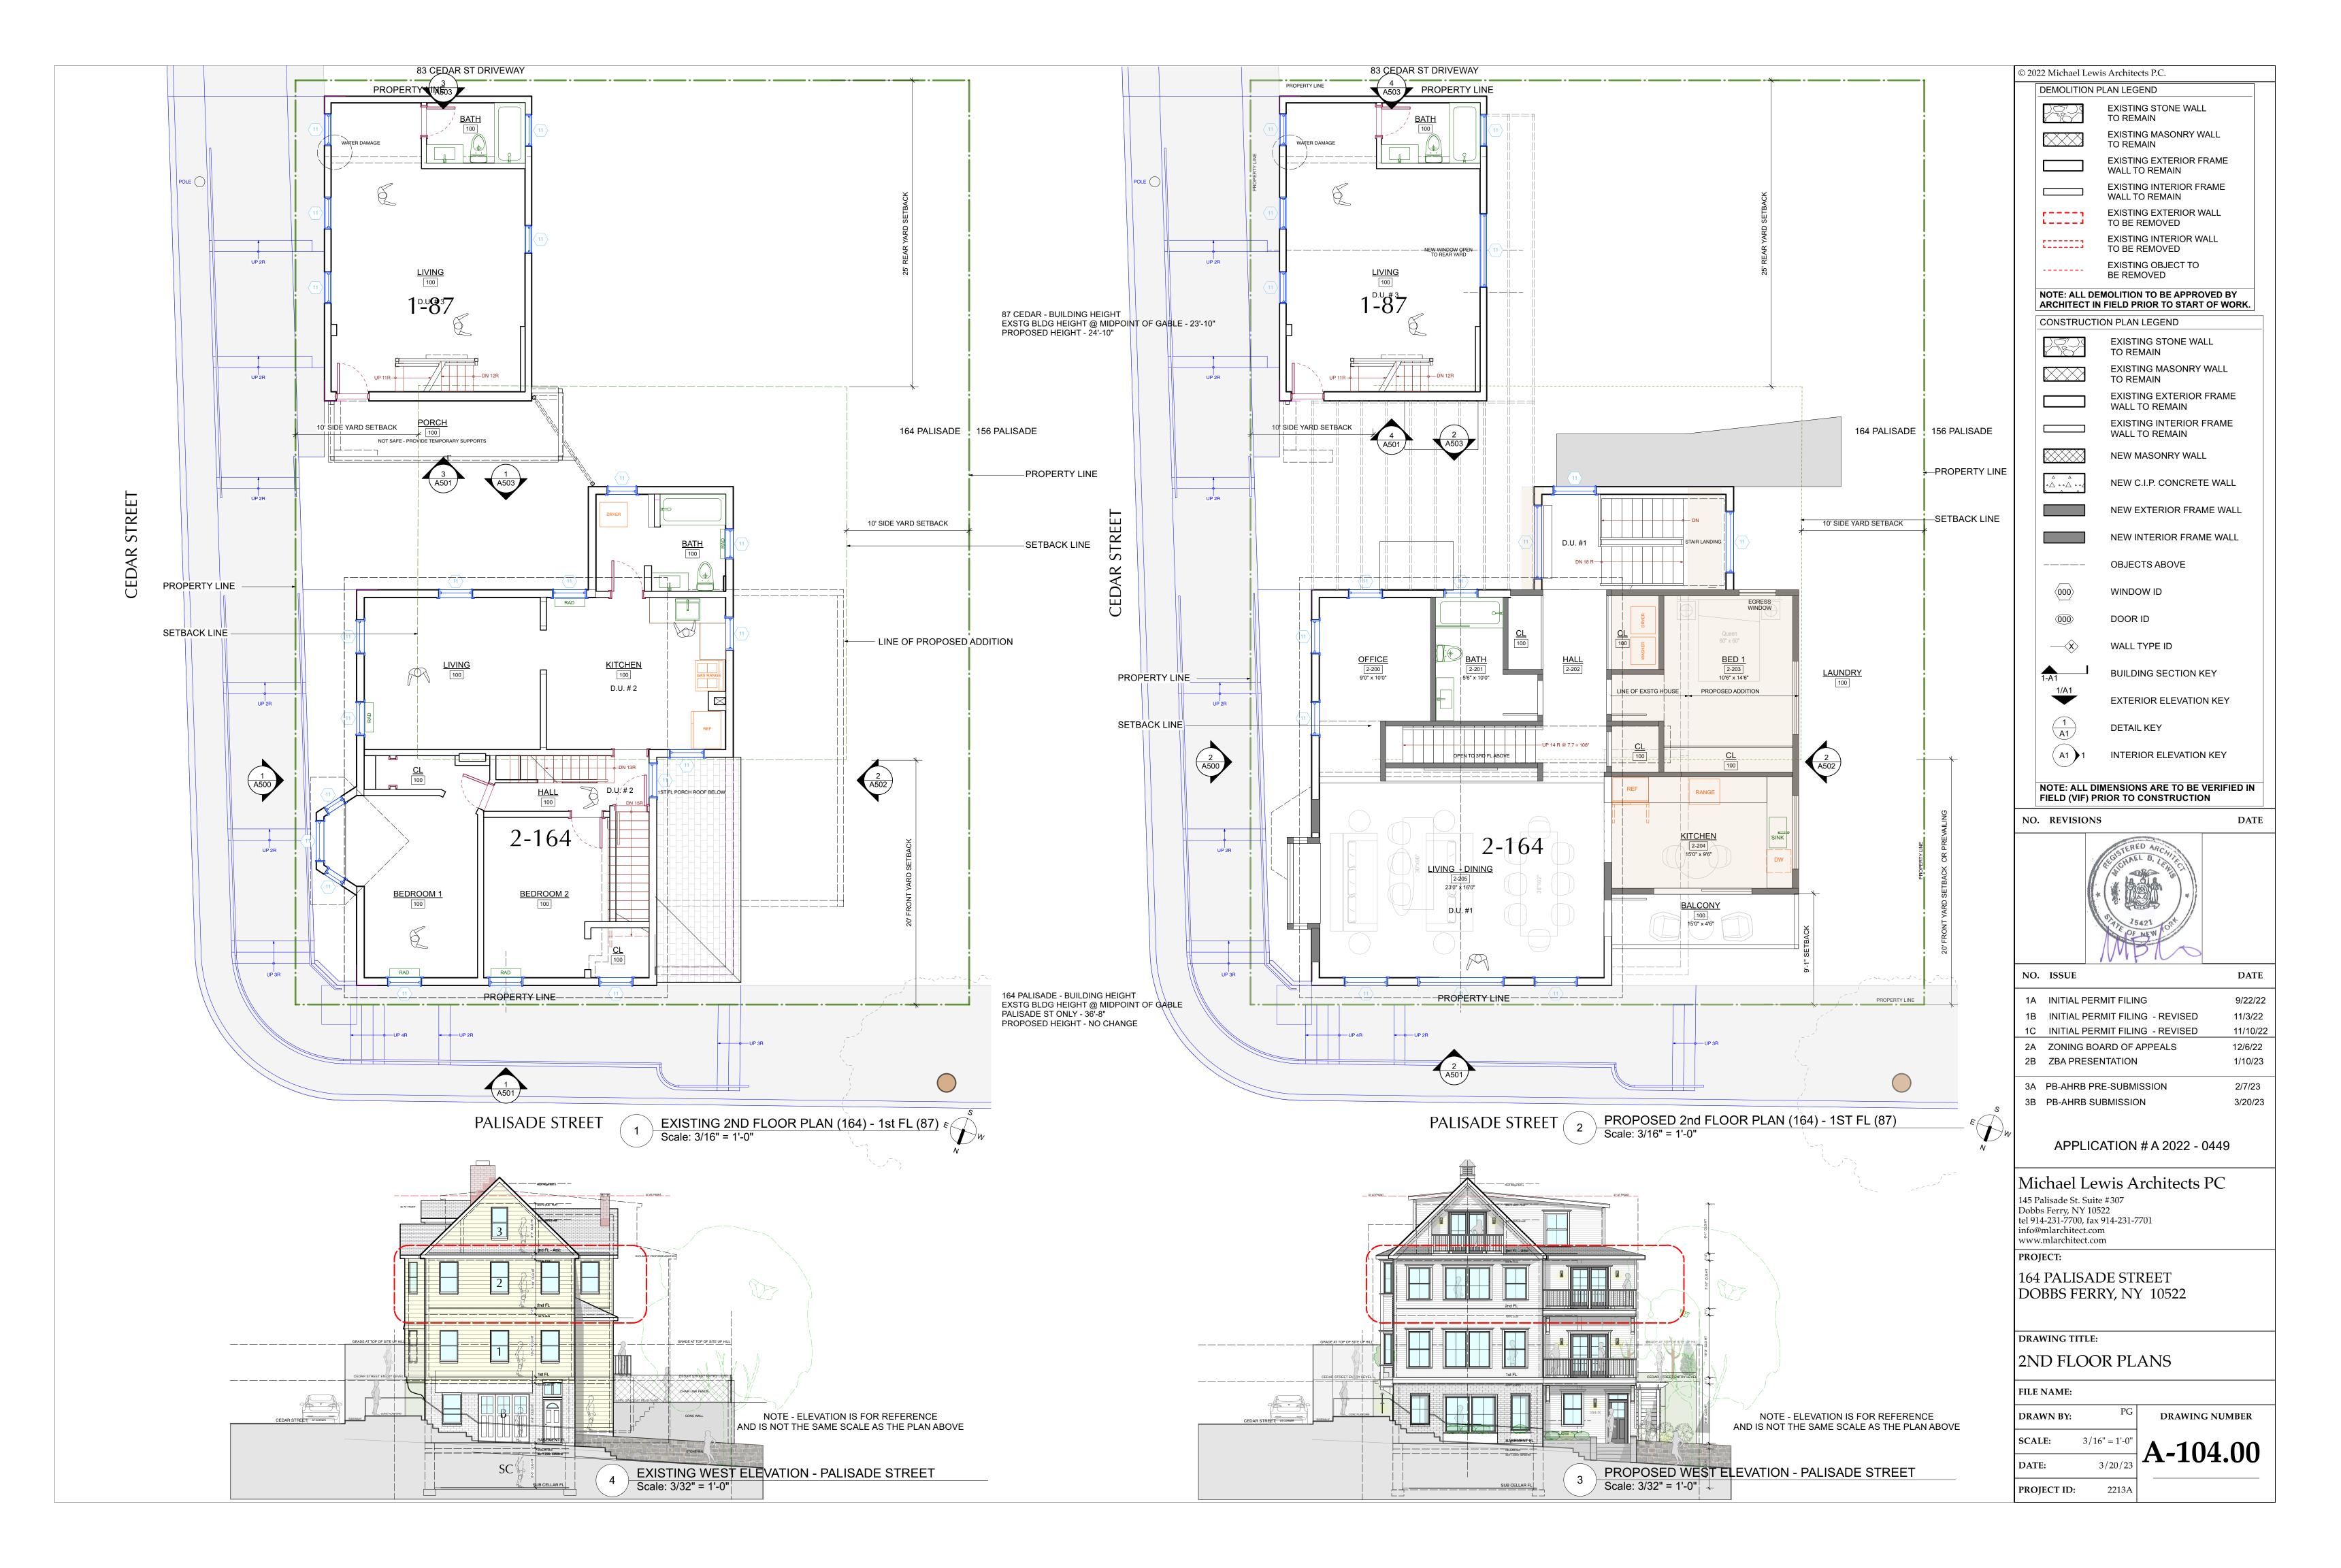











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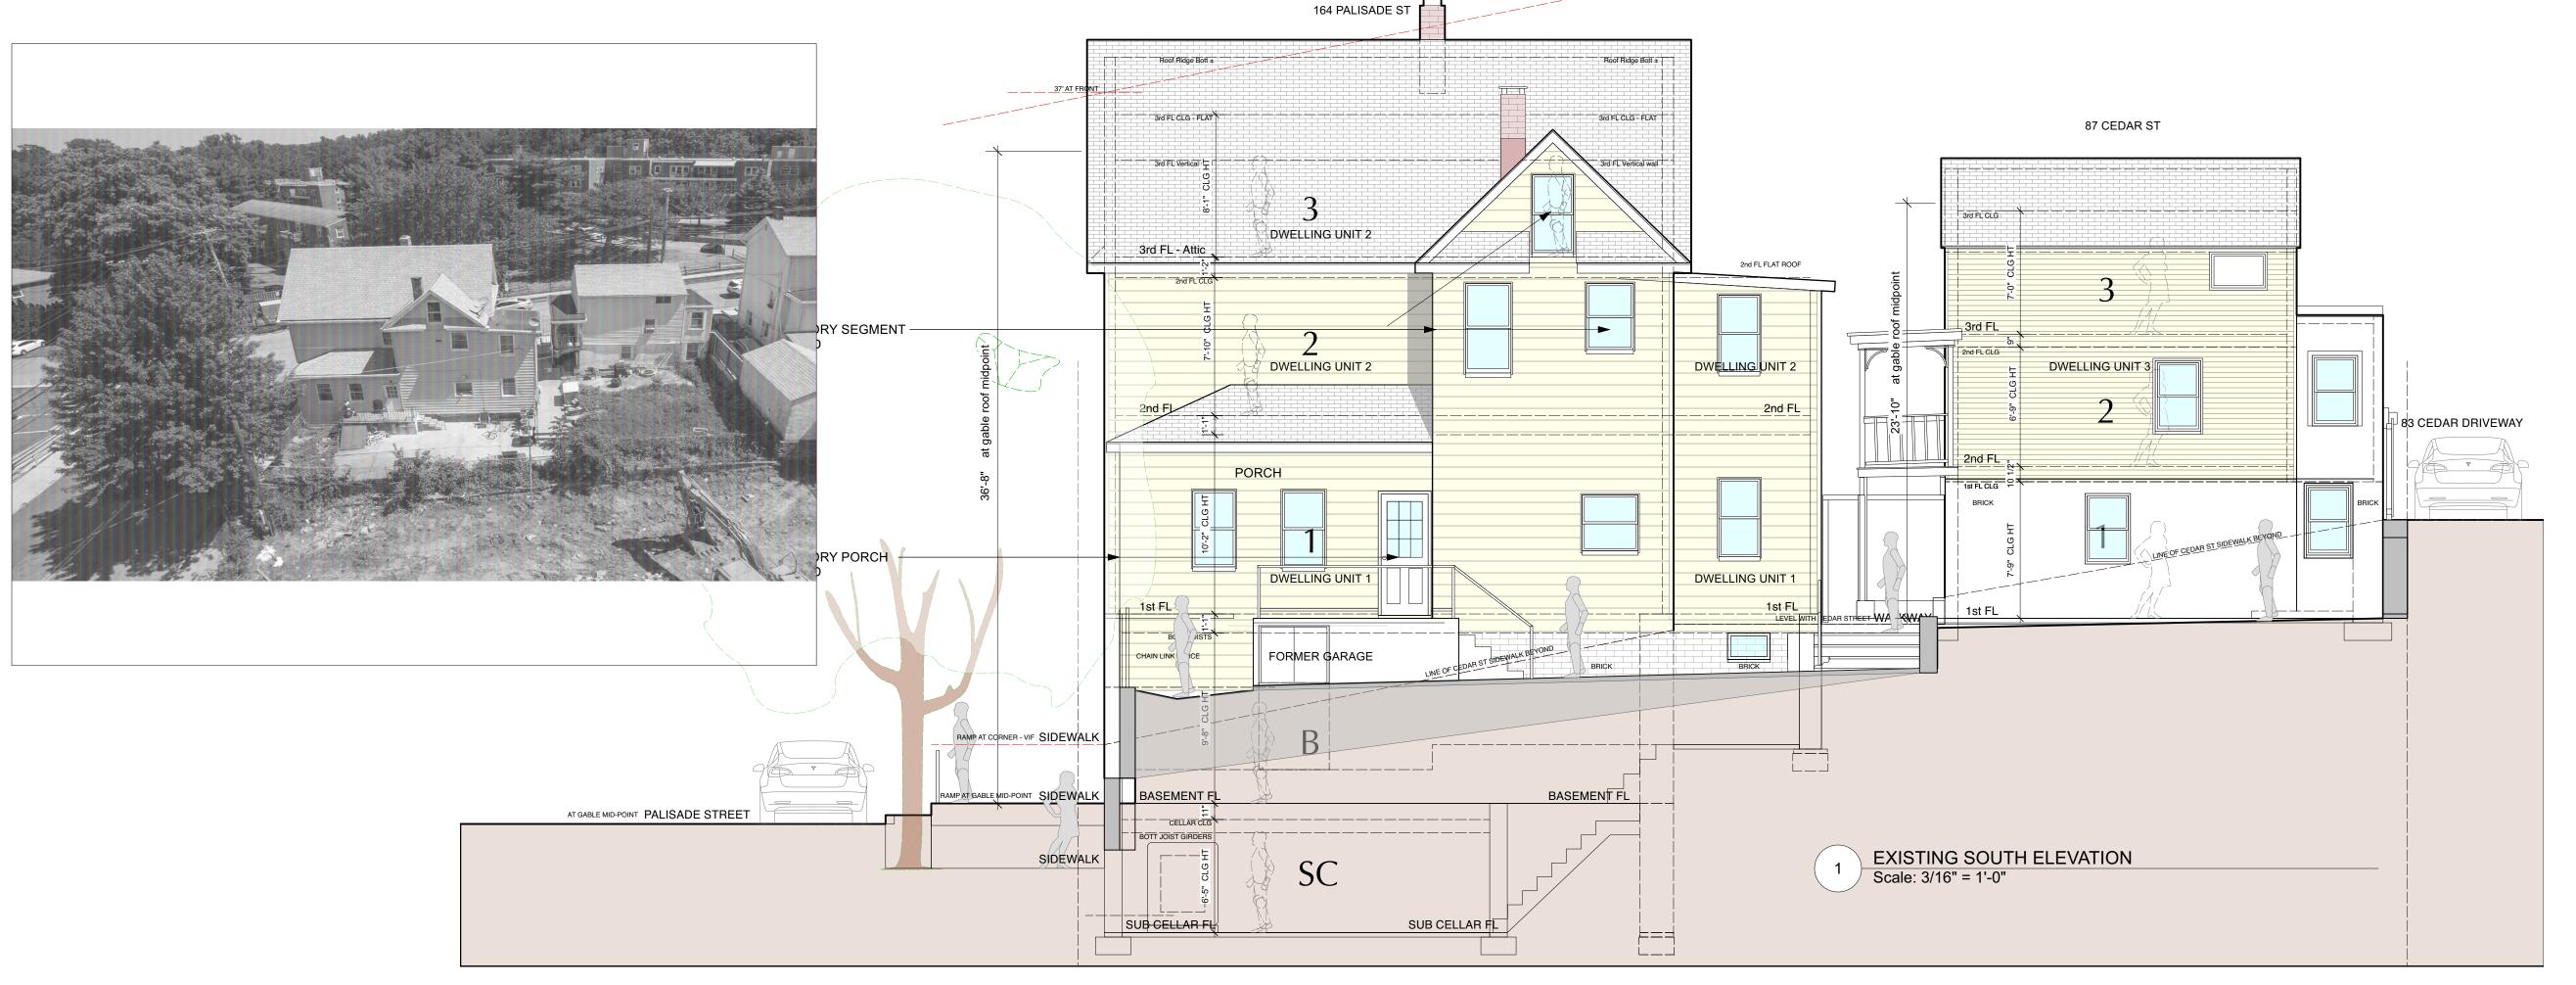
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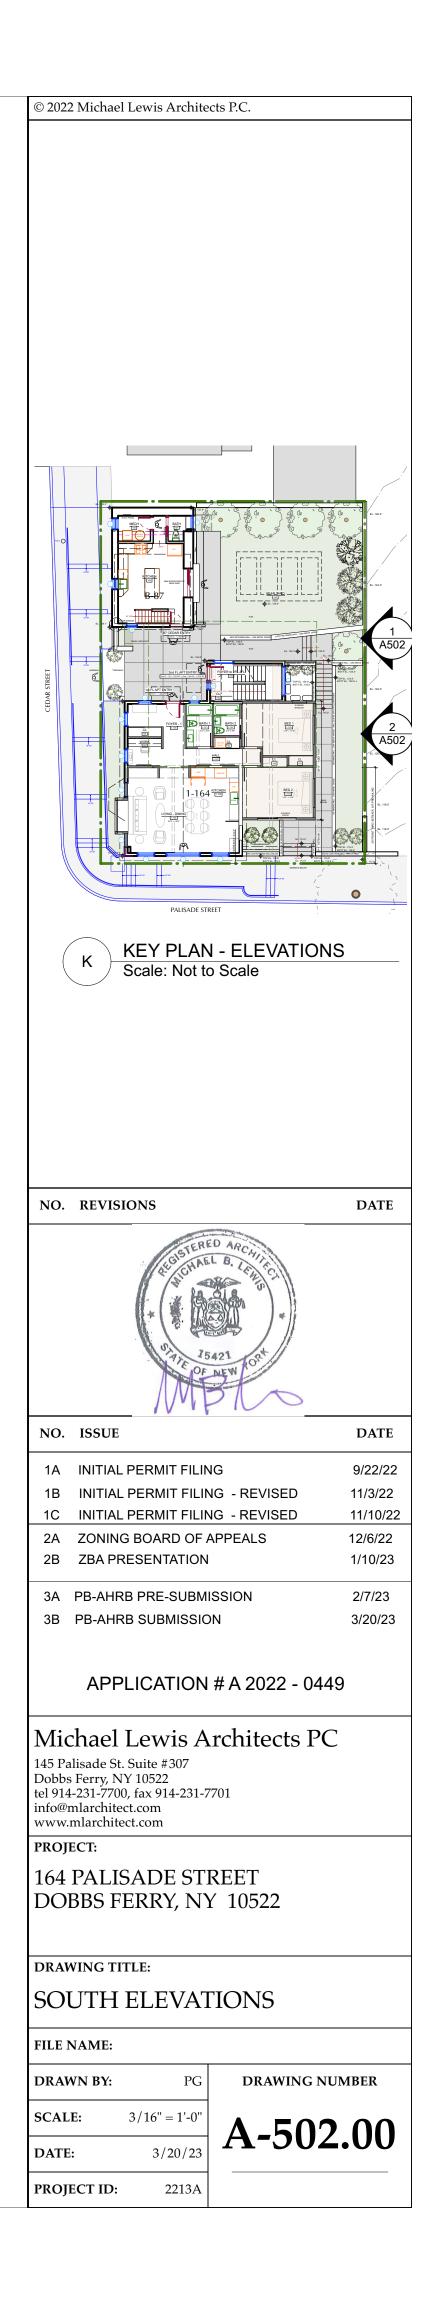


























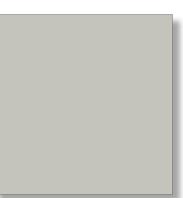

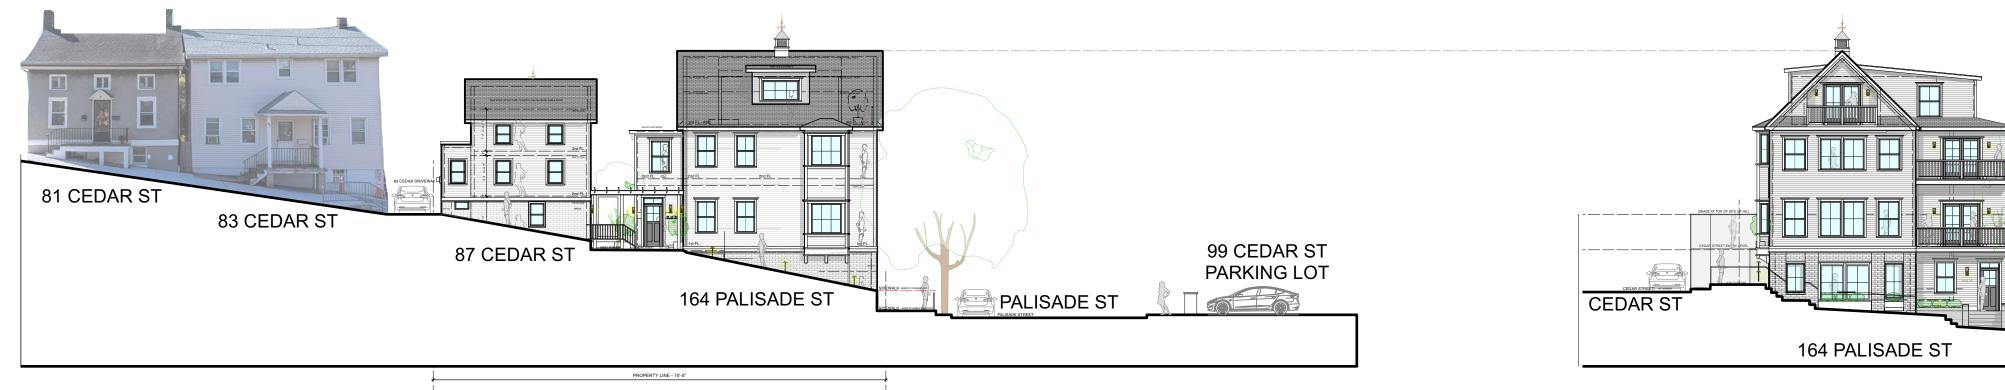



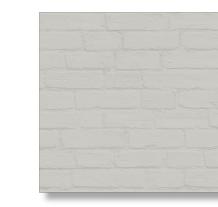


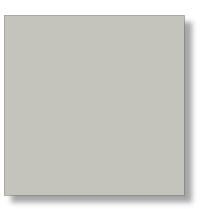







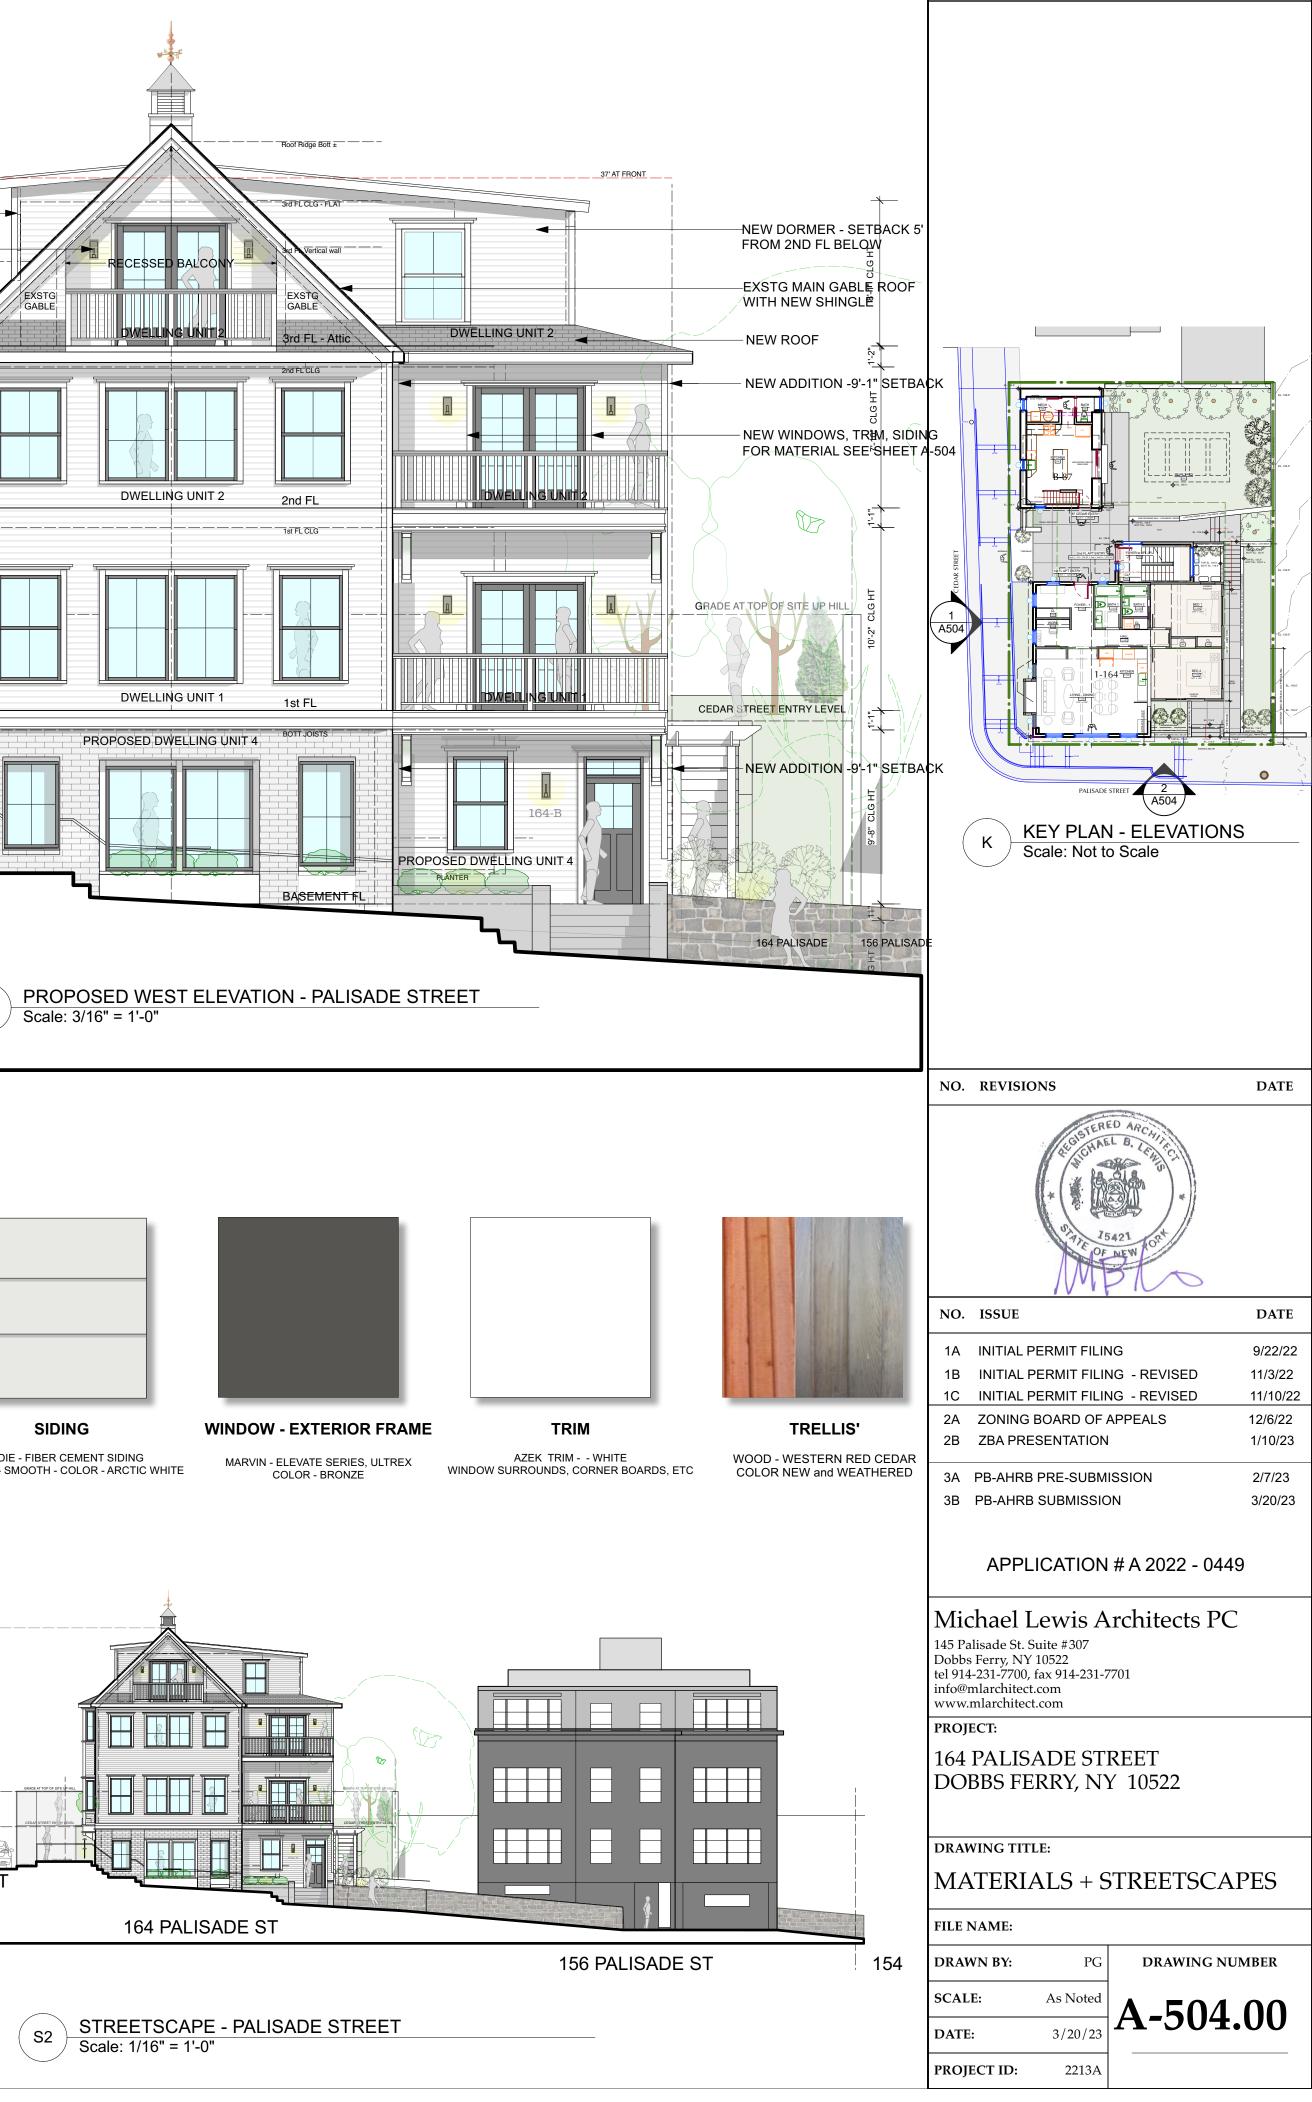

GENERAL NOTES

CONTRACTOR SHALL VISIT SITE AND SHALL BE RESPONSIBLE FOR VERIFICATION OF ALL DIMENSIONS, CONDITIONS, WHICH PERTAIN TO THE FABRICATION PROCESSES, OR TO TECHNIQUES FOR CONSTRUCTION AND COORDINATION OF THE WORK OF ALL TRADES, PRIOR TO START OF CONSTRUCTION.

ALL DISCREPANCIES SHALL BE BROUGHT TO THE ATTENTION OF ARCHITECT/ENGINEER BEFORE PROCEEDING. THE ELEVATIONS AND AVAILABILITY OF UTILITITIES, SEWER, WATER HAVING RECEIVED NYSDEC 4-HOUR EROSION AND SEDIMENT AND ELECTRIC LINES SHALL BE VERIFIED BY OR DETERMINED BY INTERESTED CONTRACTORS PRIOR TO SUBMISSION OF BID.

CONTRACTORS SHALL ADJUST PITCH OF NEW LINES TO INSURE PROPER AND LEGAL INTERSECTIONS. CONTRACTOR SHALL COORDINATE LOCATIONS FOR STRUCTURAL. MECHANICAL AND ELECTRICAL WORK FOR ALL PITS, SLAB DEPRESSIONS, SLEEVES IN FOUNDATION WALLS, SLABS, AND ROOF OPENINGS, ETC.

CONTRACTOR SHALL VERIFY CONDITIONS OF ADJOINING STRUCTURES WHICH MAY BE AFFECTED, PROVIDE ADEQUATE PROTECTION AND RESTORE TO ORIGINAL CONDITIONS, WHENCE DAMAGE SHOULD RESULT FROM SUCH WORK. THE CONTRACTOR SHALL PROVIDE AND USE. ALL NECESSARY SHORING AND BRACING FOR ALL BUILDING COMPONENTS IN ORDER TO ADEQUATELY PROTECT AGAINST ANY FAILURES.

CONTRACTOR/OWNER SHALL SECURE AND PAY FOR ANY AND ALL PERMITS, LICENCES, CERTIFICATES, FEES, ETC., REQUIRED BY THE DOBBS FERRY DEPARTMENT OF BUILDINGS OR ANY AND ALL JURISDICTION AUTHORITIES. CONTRACTOR SHALL OBTAIN A FINAL CERTIFICATE OF OCCUPANCY UPON COMPLETION.

ALL WORK MUST CONFORM TO THE DOBBS FERRY DEPARTMENT OF BUILDINGS, FIRE DEPARTMENT LAWS, RULES AND TO ALL REGULATIONS OF ALL AUTHORITIES HAVING JURISDICTION WHETHER SPECIFICALLY SHOWN OR NOT. [O.S.H.A. REGULATIONS MUST ALSO BE ADHERED TO]. ALL ELECTRIC WORK MUST CONFORM TO NATIONAL ELECTRIC CODE

ANY ITEM SHOWN ON ONE SHEET SHALL BE AS IF CALLED FOR BY ALL SHEETS. FINAL COORDIANTION IS THE RESPONSIBILITY OF THE CONTRACTOR. CONTACTOR SHALL NOT SCALE DRAWINGS AND SHALL USE FIGURED DIMENSIONS ONLY. THE GENERAL CONDITIONS OF THE CONTRACT FOR CONSTRUCTION OF BUILDINGS, [STANDARD FORM OF A.I.A. LATEST (OR APPROVED EQUAL.) EDITION A201], ARE PART OF THE CONTRACT DOCUMENTS.

THE ARCHITECT/ENGINEER HAS NOT BEEN RETAINED FOR SUPERVISION OR PERIODIC FIELD OBSERVATIONS AND ASSUMES NO RESPONSIBILITY FOR SAFETY METHODS ON SITE. THE OWNER AND CONTRACTOR SHALL HOLD HARMLESS THE ARCHITECT/ENGINEER FROM AND AGAINST ALL CLAIMS, DAMAGES, LOSSES AND EXPENSES INCLUDING ATTORNEY'S FEES ARISING OUT OF OR RESULTING FROM THE PERFORMANCE OF THE WORK BY THE CONTRACTOR.

THE FOLLOWING NOTES SHALL BE PROVIDED ON PLANS THAT INVOLVE SWPPP'S: - THE APPLICANT SHALL NOTIFY THE BUILDING DEPARTMENT VILLAGE'S CONSULTING ENGINEER IN WRITING AT

LEAST 48 HOURS BEFORE ANY OF THE FOLLOWING SO THAT ANY INSPECTION MAY BE PERFORMED.

- __ START OF CONSTRUCTION __ INSTALLATION OF SEDIMENT AND EROSION CONTROL MEASURES.
- COMPLETION OF SITE CLEARING. ____ COMPLETION OF ROUGH GRADING
- __ INSTALLATION OF SMP'S.
- __ COMPLETION OF FINAL GRADING AND STABITIZATION OF DISTURBED AREAS. CLOSURE OF CONSTRUCTION.
- ___ COMPLETION OF FINAL LANDSCAPING; AND ____ SUCCESSFUL ESTABLISHMENT OF LANDSCAPING IN PUBLIC AREAS.

THE OWNER OR OPERATOR SHALL HAVE A OUALIFIED INSPECTOR INSPECT AND DOCUMENT THE EFFECTIVENESS OF ALL EROSION AND SEDIMENTATION CONTROL PRACTICES AND PREPARE INSPECTION REPORTS AT LEAST ONCE A MONTH. THESE REPORTS MUST BE KEPT ON SITE AND AVAILABLE FOR REVIEW"

INSPECTION SCHEDULE:

- O SCHEDULE INSPECTIONS (AS-REQUIRED), THE APPLICANT SHALL CONTACT THE BUILDING DEPARTMENT
- AT LEAST 48 HOURS FOR REQUIRED INSPECTIONS YPICALLY FOR THE FOLLOWING
- START OF CONSTRUCTION INSTALLATION OF EROSION AND SEDIMENT CONTROL DEVICES
- 3. INSTALLATION OF STORM WATER MANAGMENT PRACTICES.
- 4. COMPLETION OF SITE CLEARING
- 5. COMPLETION OF ROUGH GRADING 6. COMPLETION OF FINAL GRADING
- 2. CLOSE OF THE CONSTRUCTION SEASON.
- 8. COMPLETION OF FINAL LANDSCAPING. 9. ESTABLISHMENT OF LANDSCAPING IN PUBLIC AREA.

SITE WORK

-ALL EXISTING SITE CONDITIONS DAMAGED BY ANY EQUIPMENT, MACHINERY OR CONSTRUCTION, ARE TO BE REPAIRED OR REPLACED TO THEIR EXISTING CONDITIONS OR PROPOSED.

-ALL FILL MATERIAL SHALL BE SOIL. OR SOIL-ROCK MIXTURE FREE FROM ORGANIC MATTER AND OTHER OBJECTABLE MATERIAL. IT SHALL CONTAIN NO ROCK OR LUMP OVER 6" IN GREATEST DIMENSION AND NOT MORE THAN 15% OF THEROCKS OR LUMPS SHALL BE LARGER THAN 2.5" IN GREATEST DIMENSION.

-CONTRACTOR/OWNER IS RESPONSIBLE FOR NOTIFYING ALL UTILITY COMPANIES AND VERIFYING LOCATION OF SAME UTILITY COMPANY LINES, SERVICES AND OTHER POSSIBLE EQUIPMENT OF UTILITY COMPANY.

-CONTRACTOR/OWNER SHALL VERIFY ALL INVERT ELEVATIONS AND SEWER CONDITIONS INDICATED PRIOR TO CONTRUCTION ARCHITECT/ENGINEER ASSUMES NO RESPONSIBILITY FOR INFORMATION CONTAINED IN SURVEYS OR SEWER DEPARTMENT RECORDS.

VERIFY DEPTH OF EXISTING ADJACENT STRUCTURES PRIOR TO CONSTRUCTION. IF UNDERPRINNING IS NECESSARY A SEPARATE APPLICATION MUST BE FILED

VILLAGE OF DOBBS FERRY SITE PLAN NOTES:

-SHOULD ROCK BLASTING BE REQUIRED, A PERMIT APPLICATION IN ACCORDANCE WITH CHAPTER 125 - BLASTING AND EXPLOSIVES OF THE VILLAGE OF DOBBS FERRY CODE MUST BE SUBMITTED TO THE VILLAGE BY THE APPLICANT FOR REVIEW/APPROVAL

-THE BUILDING INSPECTOR OR VILLAGE ENGINEER MAY REQUIRE ADDITIONAL EROSION CONTROL MEASURES IF DEEMED APPROPRIATE TO MITIGATE UNFORESEEN SILTATION AND EROSION OF DISTURBED SOILS. -AS BUILT SURVEY OF THE SITE IMPROVEMENTS AND DRAINAGE IMPROVEMENTS SHALL BE SUBMITTED TO THE VILLAGE

ENGINEER FOR REVIEW PRIOR TO ISSUANCE OF CERTIFICATE OF OCCUPANCY. -FILL MATERIAL IMPORTED TO THE SITE SHALL BE CERTIFIED IN WRITING BY A NEW YORK LICENSED PROFESSIONAL ENGINEER AS CLEAN, NON-CONTAMINATED FILL SUITABLE FOR THE INTENDED USE.

-THE RESTORATION WORK FOR THE ROADWAY WITH IN THE VILLAGE RIGHT-OF-WAY SHALL BE PERFORMED TO THE SATISFACTION OF THE VILLAGE ENGINEER AND DEPARTMENT OF PUBLIC WORKS.

-BEFORE THE SITE PLAN IS SIGNED BY THE CHAIRMAN OF THE PLANNING BOARD, THE APPLICANT SHALL BE REQUIRED TO POST A PERFORMANCE BOND OR OTHER TYPE OF ACCEPTABLE MONETARY GUARANTY WHICH SHALL BE IN AN AMOUNTDETERMINED BY THE PLANNING BOARD AND THE VILLAGE ENGINEER AND IN A FORM SATISFACTORY TO THE VILLAGE

ATTORNEY


NOTES:

1 .PLANS DO NOT SHOW ALL UNDERGROUND UTILITIES, OIL TANKS OR OTHER SUBSURFACE INFORMATION. IT IS THE CONTRACTORS RESPONSIBILTY TO ARRANGE FOR A UTILITY MARK OUT PRIOR TO CONSTRUCTION CALL 800-962-7962 WWW.DIGSAFELYNEWYORK.COM 2. THE ENGINEER SHALL NOT BE RESPONSIBLE FOR THE SUPERVICION OF THE CONSTRUCTION

3. ALL CONDITIONS, LOCATIONS, AND DIMENSIONS SHALL BE FIELD VERIFIED AND THE ENGINEER SHALL BE IMMEDIATELY NOTIFIED

- OF ANY DISCREPANCIES. NO CHANGES SHALL BE MADE TO THESE PLANS EXCEPT AS PER NYS LAW CH. 987. 4. ALL WORK AND MATERIALS SHALL COMPLY WITH ALL APPLICABLE CODES, INCLUDING BUT NOTLIMITED
- TO RESIDENTIAL CODE OF NYS, LOCAL BUILDING AND ZONING CODES.
- 5. CONTRACTOR IS RESPONSIBLE FOR A SAFE WORKPLACE IN ACCORDANCE WITH ALL APPLICABLE LAWS AND CODES.
- 5. THE CONTRACTOR SHALL SUPERVISE AND DIRECT THE WORK AND SHALL BE SOLEY RESPONSIBLE FOR ALL
- CONSTRUCTION MEANS, METHODS TECHNIQUES, SEQUENCES AND PROCEDURES. . WRITTEN DIMENSIONS ON THE DRAWINGS SHALL TAKE PROCEDENCE OVER SCALED DIMENSIONS.
- 3. CONTRACTOR SHALL PROTECT EXISTING TREES DURING CONSTRUCTION
- 9. FINAL GRADING AROUND THE BUILDING SHALL SLOPE AWAY FROM THE STRUCTURE.

SOIL RESTORATION AT THE COMPLETION OF

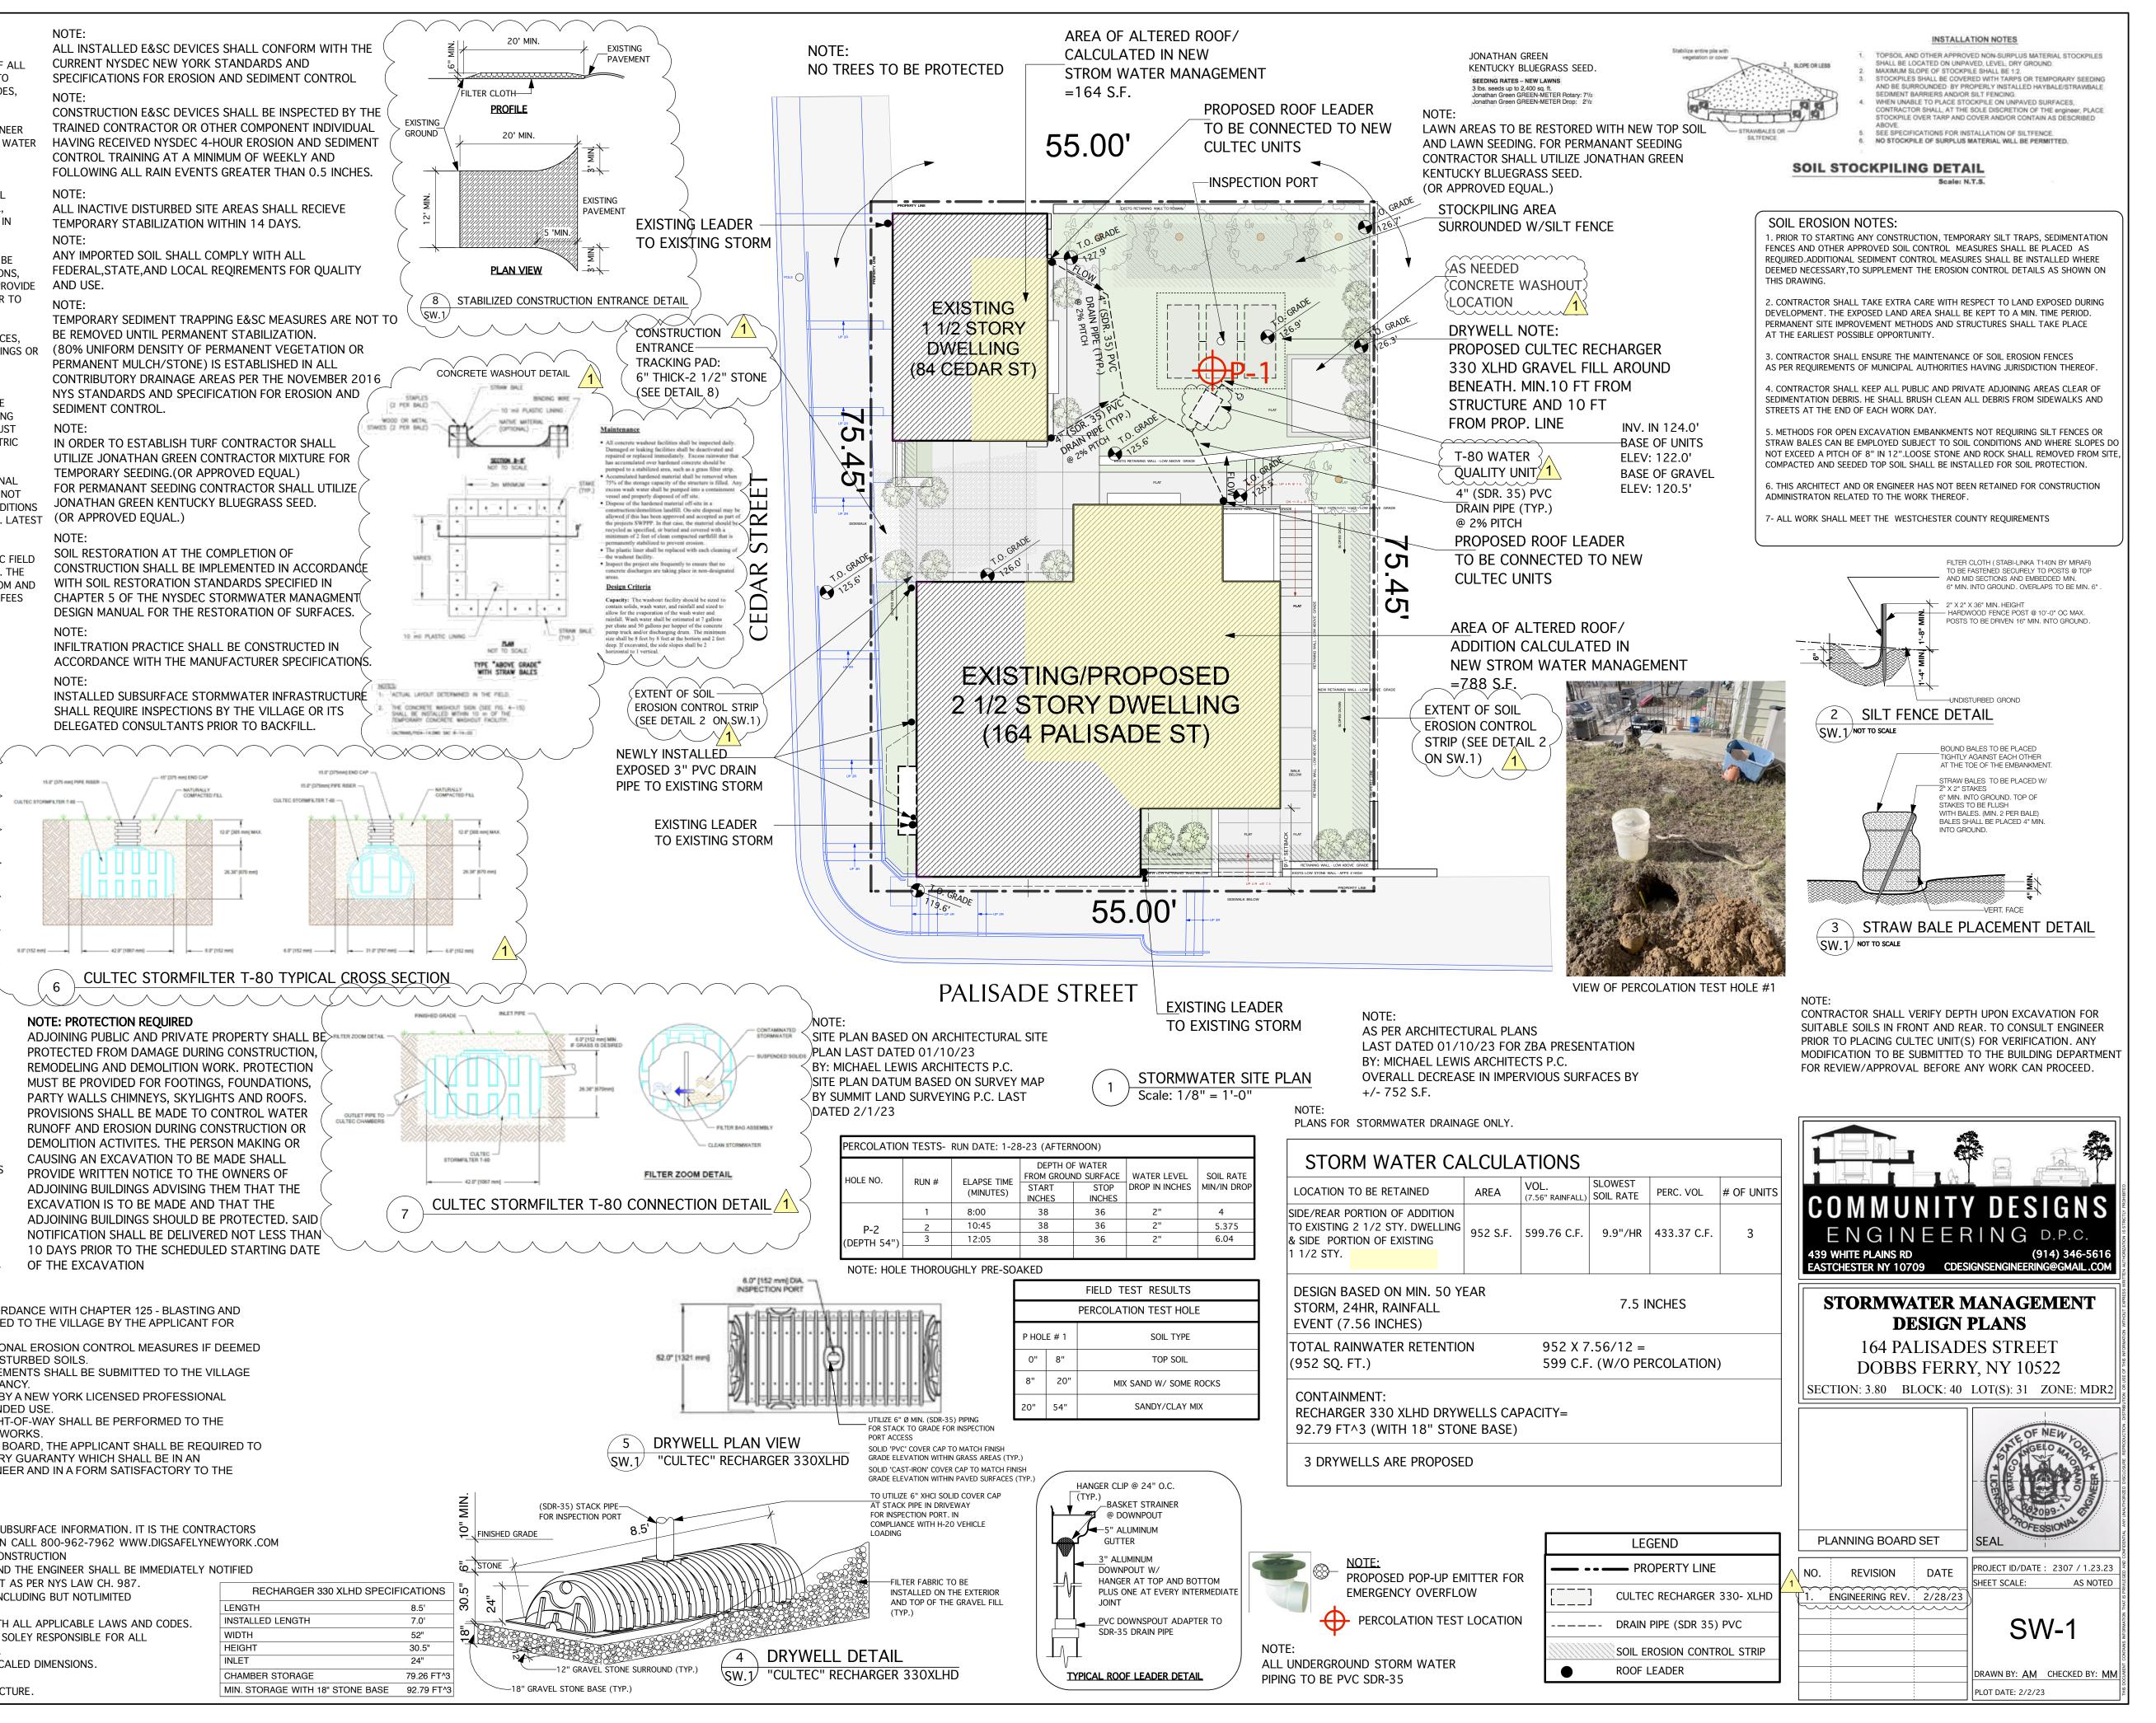

LENGTH INSTALLED LENGTH WIDTH HEIGHT INLET CHAMBER STORAGE	
WIDTH HEIGHT INLET CHAMBER STORAGE	LENGTH
HEIGHT INLET CHAMBER STORAGE	INSTALLED LENGTH
INLET CHAMBER STORAGE	WIDTH
CHAMBER STORAGE	HEIGHT
	INLET
MIN STORAGE WITH 10" STONE RASE	CHAMBER STORAGE
WIIN. STURAGE WITH TO STUNE DASE	MIN. STORAGE WITH 18" STONE BASE