

The Altshuler Residence

11 Fairlawn Avenue, Dobbs Ferry, New York 10522

NOTES

1. Approval subject to all requirements and resolutions of the Planning Board of the Village of Dobbs Ferry, New York. Any change, erasure, modification, or revision of this plan, absent re-approval from the Planning Board, shall void this approval.
2. All construction work shall be performed in compliance with the administrative Building Code of the village of Dobbs Ferry, NY, and all other applicable ordinances and regulation of all Governing Agencies having jurisdiction over the work.
3. All Construction, including Plumbing, Mechanical and Electrical work, to be performed by Licensed Contractors and all required permits and certification shall be obtained prior to commencement of work.
4. The services of Gregory Sharp Architect (GSA) are being performed solely for the client's benefit and no Contractor, Subcontractor, Supplier, Fabricator, Manufacturer, Tenant, Vendor, Consultant or other third party shall have any claim against GSA as a result of the architectural agreement with the client or the performance or non-performance of GSA's services. It is understood that this provision will be brought to the attention of the parties with whom the client contracts and have them do the same with those who they contract.
5. The Construction and vendor contracts shall include provision describing GSA's role as stated in this agreement with respect to construction and installation of the furnishing and require the Contractor(s) (and any Vendors(s) working on the job site) to indemnify the client and GSA as set forth in the indemnification clause below, which shall appearing in the Construction and Vendor Contracts. This obligation shall be insured by the contactor(s) and its subcontractors and any vendor working on the job site.
6. The contractor(s) shall defend, indemnify and hold harmless GSA and their respective directors, officers, partners, employees, and agents, from any and all claims directly or indirectly arising or alleged to arise out of the adjoining land or driveways, or streets or alleys used in connection with the performance of the work, and from any and all claims by Workmen, Suppliers or Subcontractors who are involved in the performance of the work.
7. The obligators set forth in this provision shall specifically include, but not be limited to, all claims directly or indirectly arising or alleged to arise under any scaffolding, structural work with respect to the protection of adjacent landowners.
8. The Contractor(s) shall be notified of any claims against GSA and given such reasonable information, authority and assistance as may be requested by him to enable him to perform the obligations set forth in this section. Failure to notify the Contractor(s) of a claim or to give such information, authority and assistance shall not discharge the obligations set forth in this section unless the Contractor(s) has been prejudiced in the defense of such a claim.
9. The Contractor(s) also expressly warrants and guarantees to GSA that all work performed by the Contractor(s), its Workmen, Suppliers and Subcontractors, shall conform to the requirements of the the contract documents and shall be performed in a safe and careful manner. The foregoing shall not deprive GSA of any other action, right or remedy otherwise available to them, at common law or otherwise. The term "Work" for purposes of this section means the obligations undertaken by the Contractor(s) pursuant to the contract documents. Work includes, unless specifically excepted, Furnishing all Material, Labor, Equipment, Supplies, Plant, Tools, Scaffolding, Transportation, Superintendence, Insurance, Taxes and all other Services, Facilities, and Expenses necessary for the full performance and Completion of the Requirements of the Contract Documents. Work also includes that which produced, constructed or built pursuant to the Contract Documents.
10. The Construction Contacts shall include a provision requiring the Contractor(s) or Vendor(s) to warrant to the Client and GSA that all Materials and Equipment Furnished will be new unless otherwise specified, and that all work will be of good quality, free from faults and defects and in conformance with the Construction Documents.

- General Construction Notes: Building Department
- 1.0 The Building is a Single Family Residence
 - 2.0 The New International Type Building Code went into effect in New York State on 2020.
 - 3.0 Special Inspection Items:
 - *Sediment and Erosion Control
 - *Footing
 - *Preparation for Concrete Slabs and Walls
 - *Framing
 - *Building Systems, including underground rough in.
 - *Fire resistant Construction and Penetrations
 - *Insulation
 - *Solid Fuel
 - *Foundation and Footing drain
 - *Energy Code Compliance
 - *Final Inspection for Cof O
 - *Additional State and Local Law Inspections as required.

- 4.1 Scope of work: New Home and Garage to built.
The project can be summarized as a Basement plus 1 floor with attached Garage.
- 4.2 All Proposed work will be set on undisturbed soil.
- 4.3 All doors marked F.P.S.C. shall be at least 1 hour fire rated.
- 4.4 All masonry partitions shall be braced.
All finishes over .036 of an inch in thickness shall comply with flame spread rating or be approved by the Board of Standards and Appeals.
Sprinkler and Mechanical System will be filed under separate application.

- General Safety Notes
- 1.2 Construction operations shall be confined to normal working hours:
7 am - 7 pm MONDAY-SATURDAY, except legal holidays.
 - 2.1 All work shall be done in accordance with the New York State Building Code and regulations of all other state, local or federal agencies having jurisdiction.
 - 2.2 The Contractor shall provide adequate bracing and shoring to ensure the structural stability of the premises.
 - 2.3 The Contractor must conduct their activities so as not to endanger any individual.
Contractors shall comply with all applicable OSHA codes.
 - 2.4 All Contractors shall be equipped with safety equipment including gloves, eye protection or other specialized equipment required for the work being performed.
 - 2.5 The Contractor shall maintain work areas and access ways thereto safe against intrusion of unauthorized persons. The Contractor shall be responsible for keeping unauthorized persons out of the work area and for protecting the safety and security of the Owners and general public.
 - 2.6 The Contractor shall be required to protect from falling debris all persons and property in areas beneath and adjoining the work area.
 - 2.7 Work which necessitates the use of chemicals or equipment that produces noxious fumes or excessive noise, will be allowed during normal business hours. Should such work be required, arrangements shall be made with the the Owner. The Owner reserves the right to stop any work, which causes excessive disturbances.

- 2.8 Separate access to the affected areas shall be provided by the Contractor and shall be made safe and non-accessible during non-working hours. Construction-related traffic shall be permitted as designated by the Owner.
- 3.0 Storage
- 3.1 No flammable, toxic or hazardous materials or supplies shall be allowed in the Building unless specifically approved by the Owner. Storage of such materials is to be in a manner and location designated by the Property Owner.
- 3.2 Material Safety Data Statements covering safety information, contents and antidotes will be filed with the Property Owner for all materials used in the Building.
- 3.3 Contractor materials are not to be stored in any public or occupied areas. Owner is not responsible for the theft or damage of construction equipment or materials stored in the building.
- 3.4 All building materials stored at the construction area and/or in any area of the building are to be secured in a locked area. Access to such areas to be controlled by Owner and/or Contractor.
- 4.0 Deliveries
- 5.0 Sprinklers and Fire Alarms
- 5.1 No work is to be done which affects any aspect of the Buildings sprinkler or fire alarm system without prior approval of the Property Owner. Alarm panels must be returned to full operation by the end of the day.
- 5.2 There must be one (1) fire extinguisher for every seventy-five feet (75'-0") on the job at all times. ABC type all-purpose extinguishers shall be used.
- 5.3 All required permits, a Fire Watch (by persons caring of Qualification and Fitness) and protective blankets are required for all burning and welding.
- 6.0 Trash Removal
- 6.1 Construction debris and all trash shall be removed from the work area daily and placed in a legal container arranged for by the Contractor. Contractor is responsible for general area of where debris is disposed of (ie where trash drops or is blown from the container).
- 7.0 Damage
- 7.2 The Contractor shall assume responsibility to protect all materials from loss or damage at no cost to the Owner, until they are finally incorporated into the work and accepted, whether or not the Owner has paid them for.
- 8.0 Disconnecting Equipment, Utilities

Required Notes from Town:

- All work must conform to the satisfaction of the building inspector.
- The Building Inspector or Village Engineer may require additional erosion control measures if deemed appropriate to mitigate unforeseen siltation and erosion of disturbed soils.
 - "As-Built" drawings of the site improvements shall be submitted to the Village Engineer for the review prior to obtaining Certificate of Occupancy.
 - Infiltration system access ports shall be shown on the "As-Built".
 - The infiltration system must not be connected until construction is complete and the site is stabilized. A note, stating as much, should be added to the plans.
 - Cut/Fill material shall not be imported to or exported from the site.
 - Fill material imported to the site shall be certified in writing by a New York Licensed Professional Engineer as clean, non contaminated fill suitable for the intended use.
 - Before the plan site is signed by the chairman of the planning board, the applicant shall be required to post a performance bond or other type of acceptable monetary guarantee wich shall be in the amount determined by the Planning Borad and the Village Engineer and in a form satisfactory to the Village Attorney.

ZONING AS PER TABLES B-5, B-5 (SLIDING SCALES)				
PROPERTY LOCATION: 11 FAIRLAWN AVENUE, DOBBS FERRY N.Y. BLOCK:134 LOT:12 TAX ID: 3.150-134-12				
OWNER: THE ALTSHULER RESIDENCE				
ZONING DISTRICT : OF-6 ONE-FAMILY RESIDENTIAL 6				
REQUIREMENT	UNITS	REQUIRED / ALLOWED	EXISTING	PROPOSED
MINIMUM NET LOT AREA	S.F.	5,000	26,164 SF.	37% SLOPE (.50% OFF LOT AREA) 13,082
MINIMUM LOT WIDTH	FT.	50	151	N/A
MINIMUM LOT DEPTH	FT.	100	169	N/A
MAXIMUM LOT COVERAGE BY BUILDING	S.F.	13,082 x.75= 9,811.5	0	3,255 S.F.
MAX. LOT COVERAGE BY IMPERVIOUS SURFACES	%	13,082 x.75= 9,811.5	438 S.F.	5,287 S.F.
MINIMUM YARDS				
FRONT YARD SETBACK	FT.	40	N/A	9'-2"
SIDE YARD SETBACK (EACH)	FT.	20	N/A	16' 7.5"-45'
SIDE YARD SETBACK (BOTH)	FT.	50	N/A	61
REAR YARD SETBACK	FT.	40	N/A	90
STORIES	#	2 1/2	N/A	1
MAXIMUM HEIGHT	FT.	35	N/A	28
FAR	S.F.		N/A	4,473
OFF STREET PARKING	#	2	2	2

TABLE OF CONTENTS	
T-001	Title page
C-1	Survey
C-1	Steep Slopes & Demo
C-2	Stormwater Magnament
C-3	Details
Z-001	Zoning
A-001	Proposed Site Plan
A-002	Proposed Basement
A-003	Proposed First Floor
A-004	Proposed Roof Plan
A-005	Proposed Elevations & Sections
A-005.2	Proposed Materials
A-005.3	Windows, Doors & Exterior Lights Specs.
A-006	Conceptual Section
A-007	Perspectives
A-008	Perspectives

CLIMATIC AND GEOGRAPHIC DESIGN CRITERIA (Effective 10/03/2016)											
Location: Village of Dobbs Ferry Zip Code: 10522											
Ground Snow Load	Wind Design		Seismic Design Category (RCHY Only)	Subject to Damage From		Ice Barrier Underlayment	Flood Hazards		Air Freezing Index	Mean Annual Temp.	
	Speed (mph)	Topo Effects	Special Wind Region	Wind - borne Debris Zone	Weathering	First Line Depth	Termitte	Climat e Zone			
30	"Special Wind Region	NO	NO	NO	C	Severe	42"	Moderat e to Heavy	4A	YES	
**FIRM COMMUNITY - PANEL MAP# 36119C0261F EFFECTIVE DATE, 9-28-2001											

NYS Stretch Energy Code 2020		
Building Envelope Fenestration Maximum U-Factor and SHGC Requirements Table C402.4		
Climate Zone : 4		
Vertical Fenestration		
U-Factor	Fixed Fenestration	0.36
	Operable Fenestration	0.43
	All Other Vertical Fenestration	
	All Fenestration	0.30
SHGC	Entrance doors	0.77
	PF < 0.2	0.36
	0.2 <= PF < 0.5	0.43
	PF >= 0.5	0.58
Skylights	U-Factor	0.48
	SHGC	0.38
SHGC	SHGC	SHGC
PF = Projection Factor.		
a. U-Factor and SHGC shall be rated in accordance with NFRC 100.		

NYS Stretch Energy Code 2020			
Opaque Thermal Envelope Assembly Maximum Requirements, U-Factor Method, Table C402.1.4			
Climate Zone : 4			
		All other	Group R
Roofs	Insulation Entirely above roof deck	U-0.030	U-0.030
	Metal Buildings	U-0.035	U-0.035
	Attic and other	U-0.020	U-0.020
	Mass	U-0.099	U-0.086
Walls, above grade	Metal Building	U-0.048	U-0.048
	Metal framed	U-0.061	U-0.061
Walls, below grade	Wood framed and other	U-0.061	U-0.061
	Below-grade wall	C-0.119	C-0.092
Floors	Mass	U-0.057	U-0.051
	Joist/triming	U-0.033	U-0.033
Slab-on-grade floors	Unheated slabs	U-0.052	U-0.052
	Heated slabs	U-0.063	U-0.063
Opaque Doors	Swinging	U-0.050	U-0.050
	Garage door < 14% glazing	U-0.031	U-0.031

*15 MPH to 120 MPH. The specialist wind region should serve as warning to design professionals is evaluating wind loading conditions. Wind speed higher than the derived values taken from Section 1609 of the IRC and Figure R301.2(4)(A) of the IRC are likely to occur and should be consider in the design.
*State if applicable. For Flood Hazards the Design Professional shall state if they are applicable. Y/N. Verify with FIRM Maps. Maps are available on the FIRMA web site <http://floodmap.floodsimple.com/>

2 Construction Sequences


- Phase 1 - 3 weeks.
General Site Work, Silt Fence, Tree Protection, Tree removal, Excavation, Utility Connections, Locate Concrete Footings and Foundation Preparation.
- Phase 1.2 - 4 weeks
Concrete Foundation, Underground plumbing.
- Phase1.3 - 3 weeks
Basement Concrete Slab, Backfilling foundation, Site Grading, Soil Retention, Site Drainage.
- Phase 2 - 16 Weeks
Rough Framing, Structural Steel work, Wood Framing, Sub-floors, Sub-Roof, Sheathing, Air Barrier.
- Phase 2.1 - 8 Weeks
Roofing, Installing Windows, Installing Siding and Exterior Finishes, Interior Framing and Stairs
- Phase 2.2 - 12 Weeks
All rough in Mechanical, Electrical, and Plumbing. Modifying Framing as required, prepare to accommodate finishes etc.
- Phase 3 - 12 Weeks
Install Sheetrock, Tape and Prime, Tile and Stone Finishes, Bathroom and Kitchen Waterproofing, Wood Flooring, Decking etc.
- Phase 4 - 12 Weeks
Install Millwork, Cabinets, Closets, Doors, Hardware, Appliances, Final Paint and Accessories
- Phase 4.1 - 6 Weeks
Final Landscaping, Hardscape, Plantings, Clean Up, Close Out, C of O. Punch List.
- *Case Development Projects that this project will take approximately 15 Months in total construction time and there will be some overlap between the phases. We are hoping to begin upon approval from the Village in the early spring 2017.

3 Maintenance Guidelines For Cultec Stormwater System

- The following guidelines shall be adhered to for the operation and maintenance of the CULTEC stormwater management system:
- a. The owner shall keep a maintenance log which shall include details of any events which would have an effect on the system's operational capacity.
 - b. The operation and maintenance procedure shall be reviewed periodically and changed to meet site conditions.
 - c. Maintenance of the stormwater management system shall be performed by qualified workers and shall follow applicable occupational health and safety requirements.
 - d. Debris removed from the stormwater management system shall be disposed of in accordance with applicable laws and regulations.


4. Suggested Maintenance Schedules

- a. Minor Maintenance
The following suggested schedule shall be followed for routine maintenance during the regular operation of the stormwater system:
Frequency Action Monthly in first year Check inlets and outlets for clogging and remove any debris as required.
Spring and Fall Check inlets and outlets for clogging and remove any debris as required.
One year after commissioning and every third year following
Check inlets and outlets for clogging and remove any debris as required.
- b. Major Maintenance
The following suggested maintenance schedule shall be followed to maintain the performance of the CULTEC stormwater management chambers. Additional work may be necessary due to insuffi cient performance and other issues that might be found during the inspection of the stormwater management chambers.

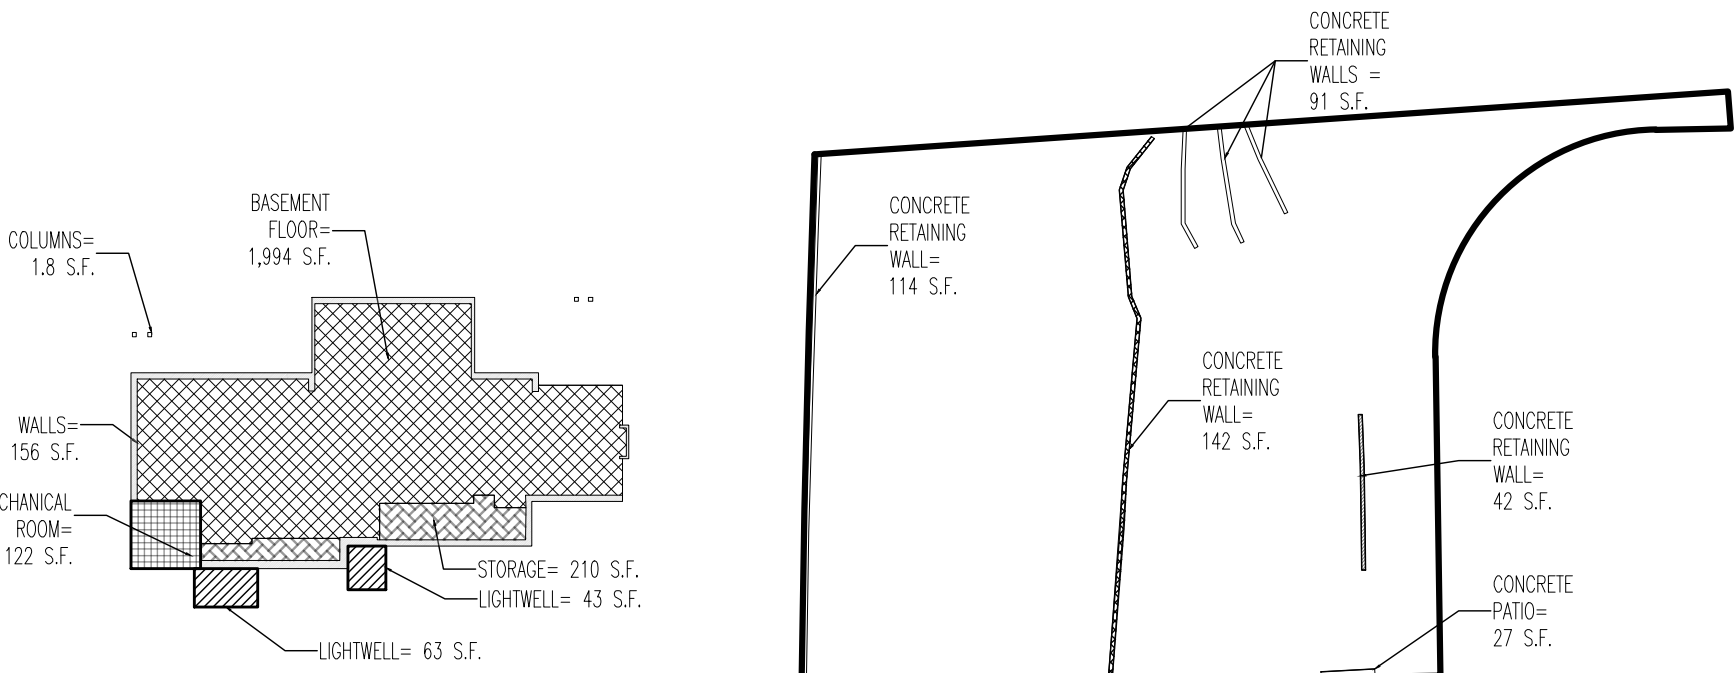


2 Zoning Diagram - Basement

SCALE: NS
Building (Basement): 1,994 S.F.
Mechanical: 122 S.F.
Storage: 210 S.F.
Walls: 156 S.F.
Columns: 1.8 S.F.
Lightwells: 1.8 S.F.
FAR: 1,994 S.F.

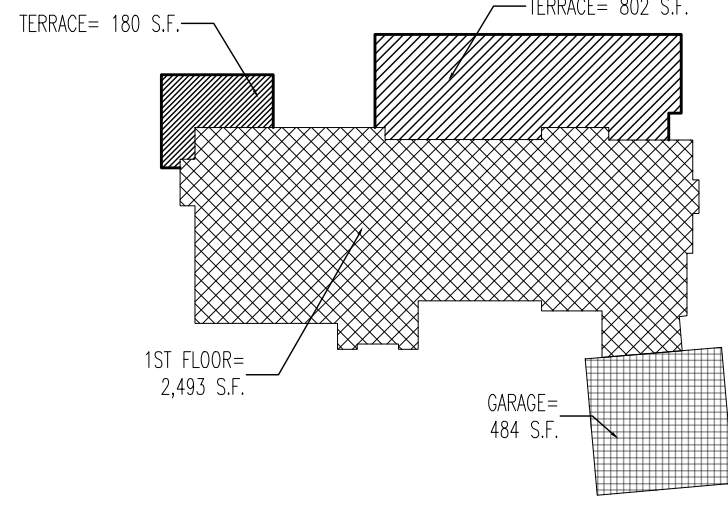


3 Zoning Diagram - First Floor

SCALE: NS
Building (1st. Floor): 2,479 S.F.
Garage: 484 S.F.
Terraces: 983 S.F.
FAR: 2,479 S.F.

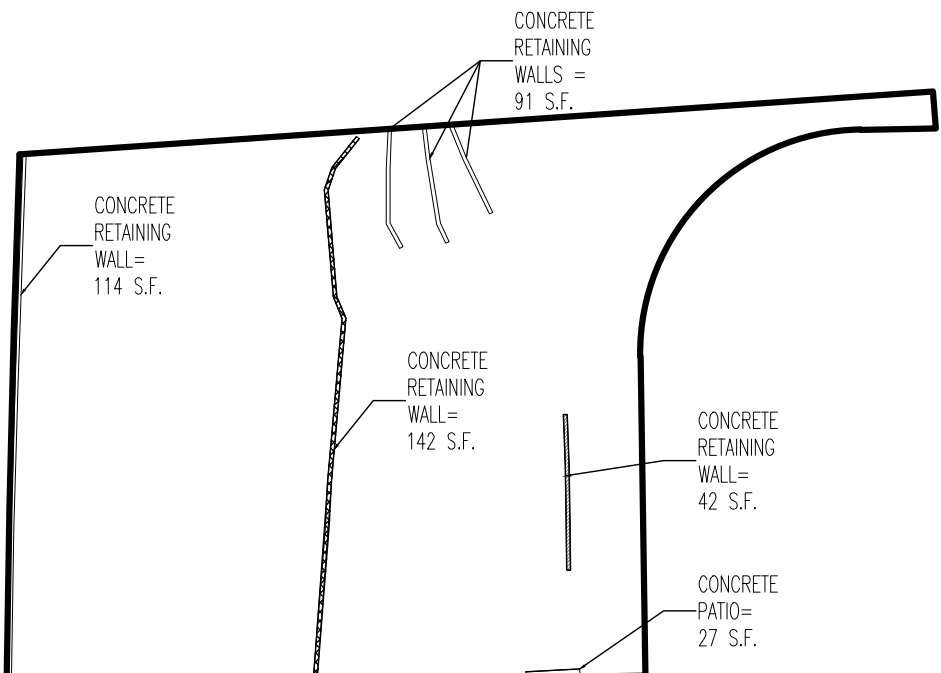


4 Existing Site Plan

SCALE: NS
Impervious coverage surface: 438 sq.ft. (3.34%)

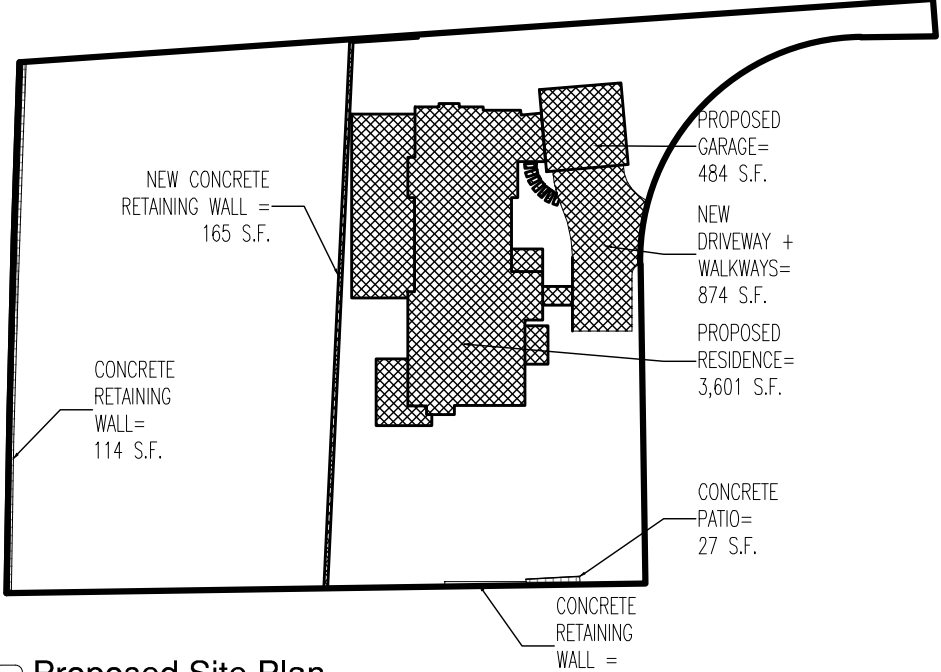

5 Proposed Site Plan

SCALE: NS
Impervious coverage surface: 5,528 sq.ft. (40.41%)

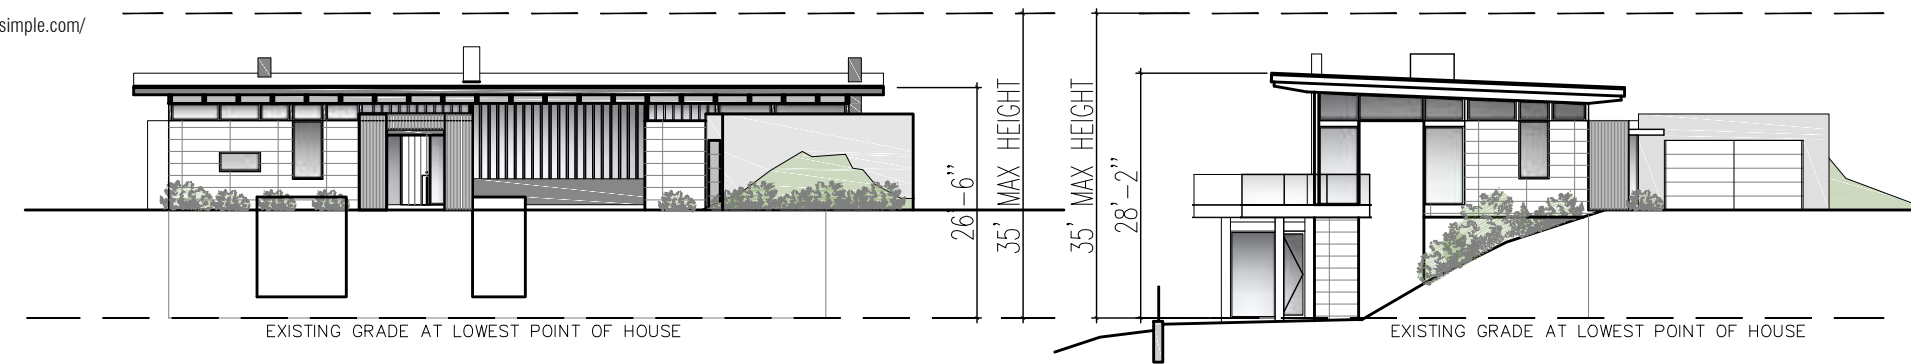


6 Proposed Front Elevation

SCALE: NS

7 Proposed Side Elevation

SCALE: NS

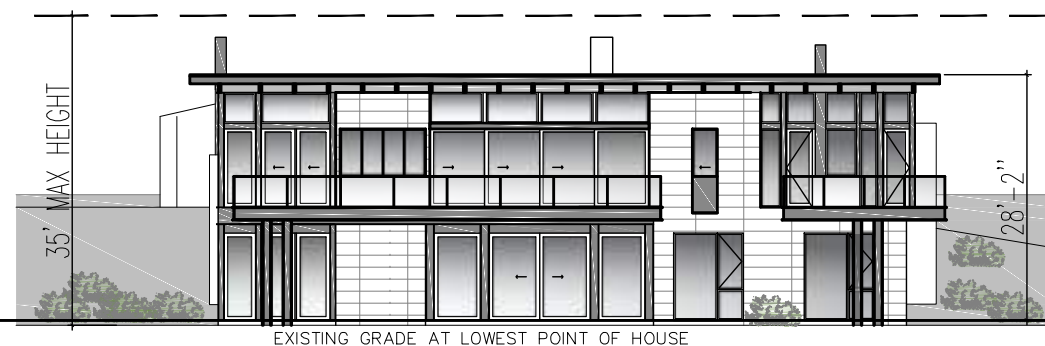


8 Proposed Rear Elevation

SCALE: NS

9 Proposed Side Elevation

SCALE: NS

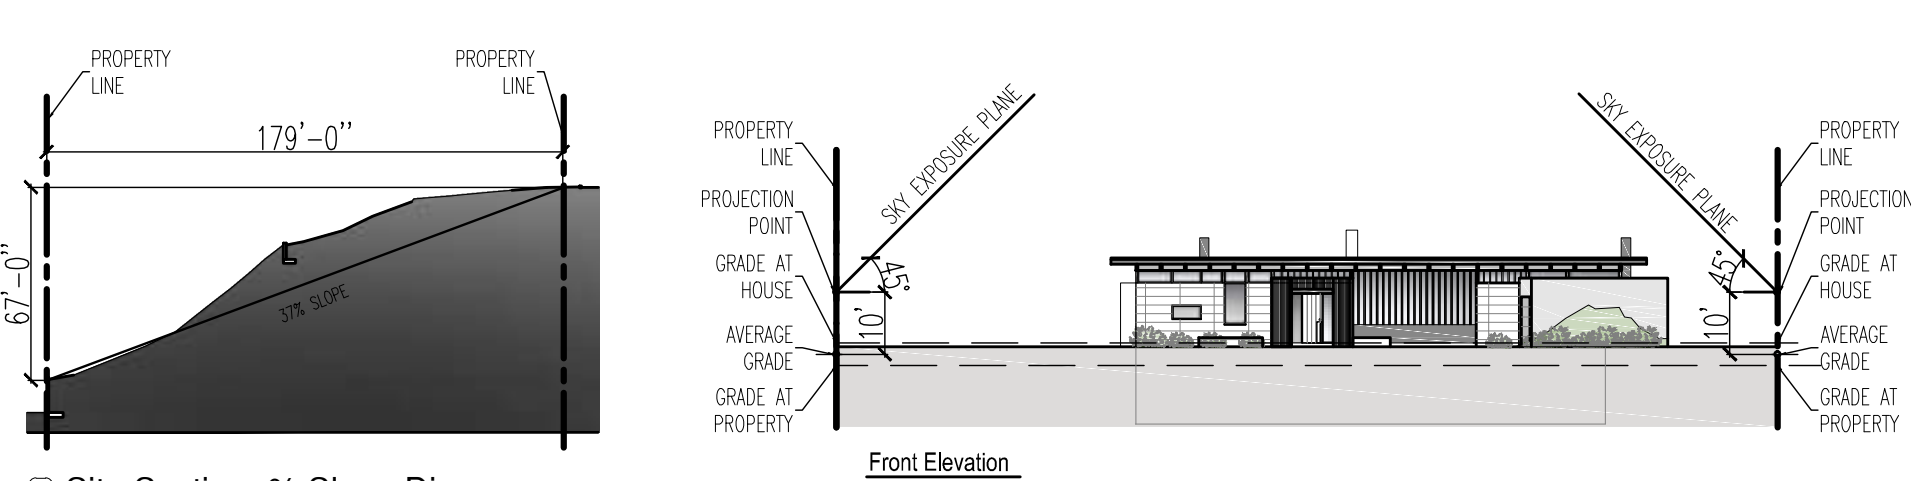


11 Site Section- % Slope Diagram

SCALE: NS



13 Land Parcel and Surrounds from above

Do Not Scale See - Dimensions

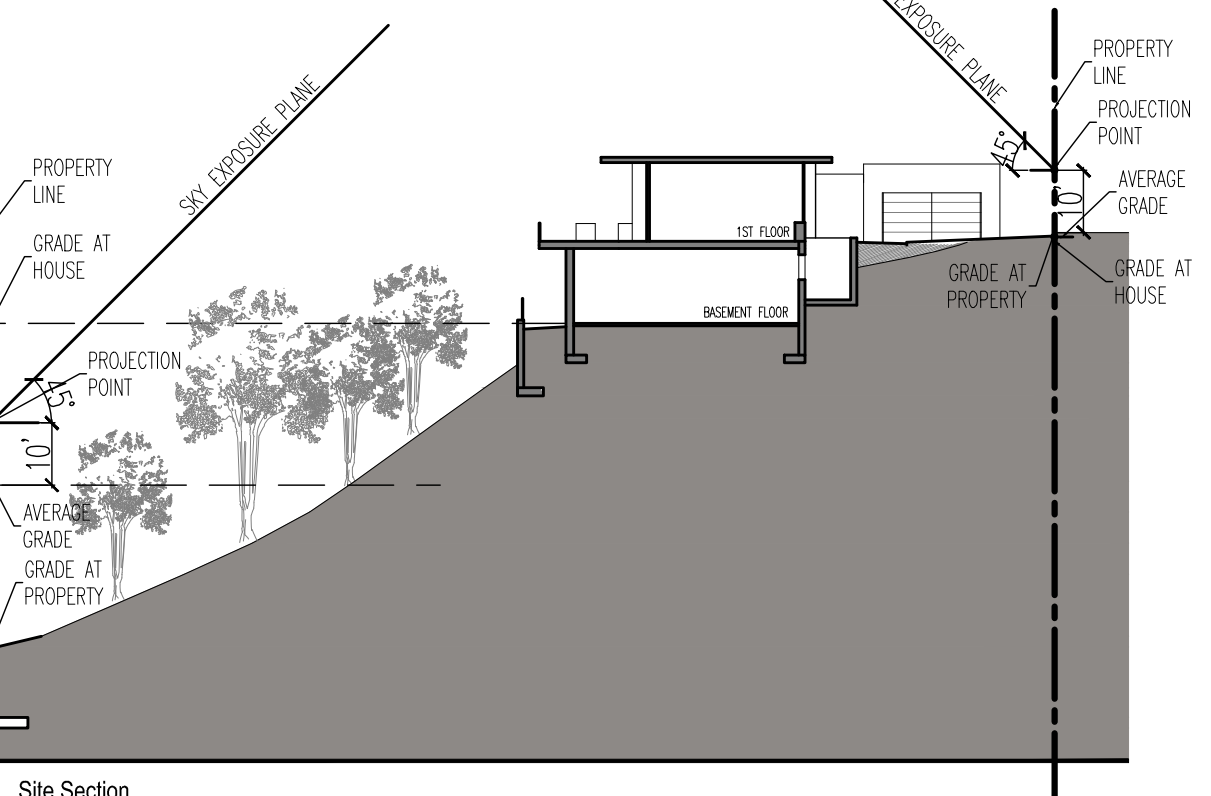

14 Sky Exposure Diagrams

SCALE: NS

Project Architect:

GSA
GREGORY SHARP ARCHITECT, PC
145 PALISADE STREET, SUITE 211
DOBBS FERRY
DIRECT 917 597 1982
INFO@CASEDEVELOPMENT.COM

OWNER'S REP / PROJECT MANAGER

CASE DEVELOPMENT

Case Development Inc

145 PALISADE STREET, SUITE 211
DOBBS FERRY, NY 10522
www.casedevelopment.com
DIRECT 917 597 1982

D.O.B CONSULTANT

LANDSCAPE ARCHITECT

ARBORIST

STRUCTURAL ENGINEER


PROJECT ENGINEER

NOTES

SYMBOL LEGEND

- | | |
|--|-----------------------|
| | Interior Elevation |
| | See Detail |
| | Elevation |
| | Section Cut |
| | Window Number |
| | Coordination Tag |
| | Door Number |
| | Wall Type |
| | 0.0' Elevation Target |
| | Revision |

North Arrow:

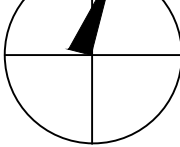

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DRAWING INFORMATION

ISSUED FOR PRE-FILE	12-8-2022
ISSUED FOR PRE-FILE	1-24-2023
ISSUED FOR PRE-FILE	2-14-2023
ISSUED FOR AHRB	3-15-2023

D.O.B. No. -

A New House located in
Dobbs Ferry, NY developed by:

The Altshuler Residence

PROJECT:

THE ALTSHULER RESIDENCE
11 FAIRLAWN AVENUE,
DOBBS FERRY, NY 10522

TITLE PAGE

SEAL AND SIGNATURE:



DATE:

3/15/2023

PROJECT No: ALTSHULER 2023

DRAWING BY: GS


CHK BY:

SWGS No:

T-001.00

CADD No:

BSCAN:

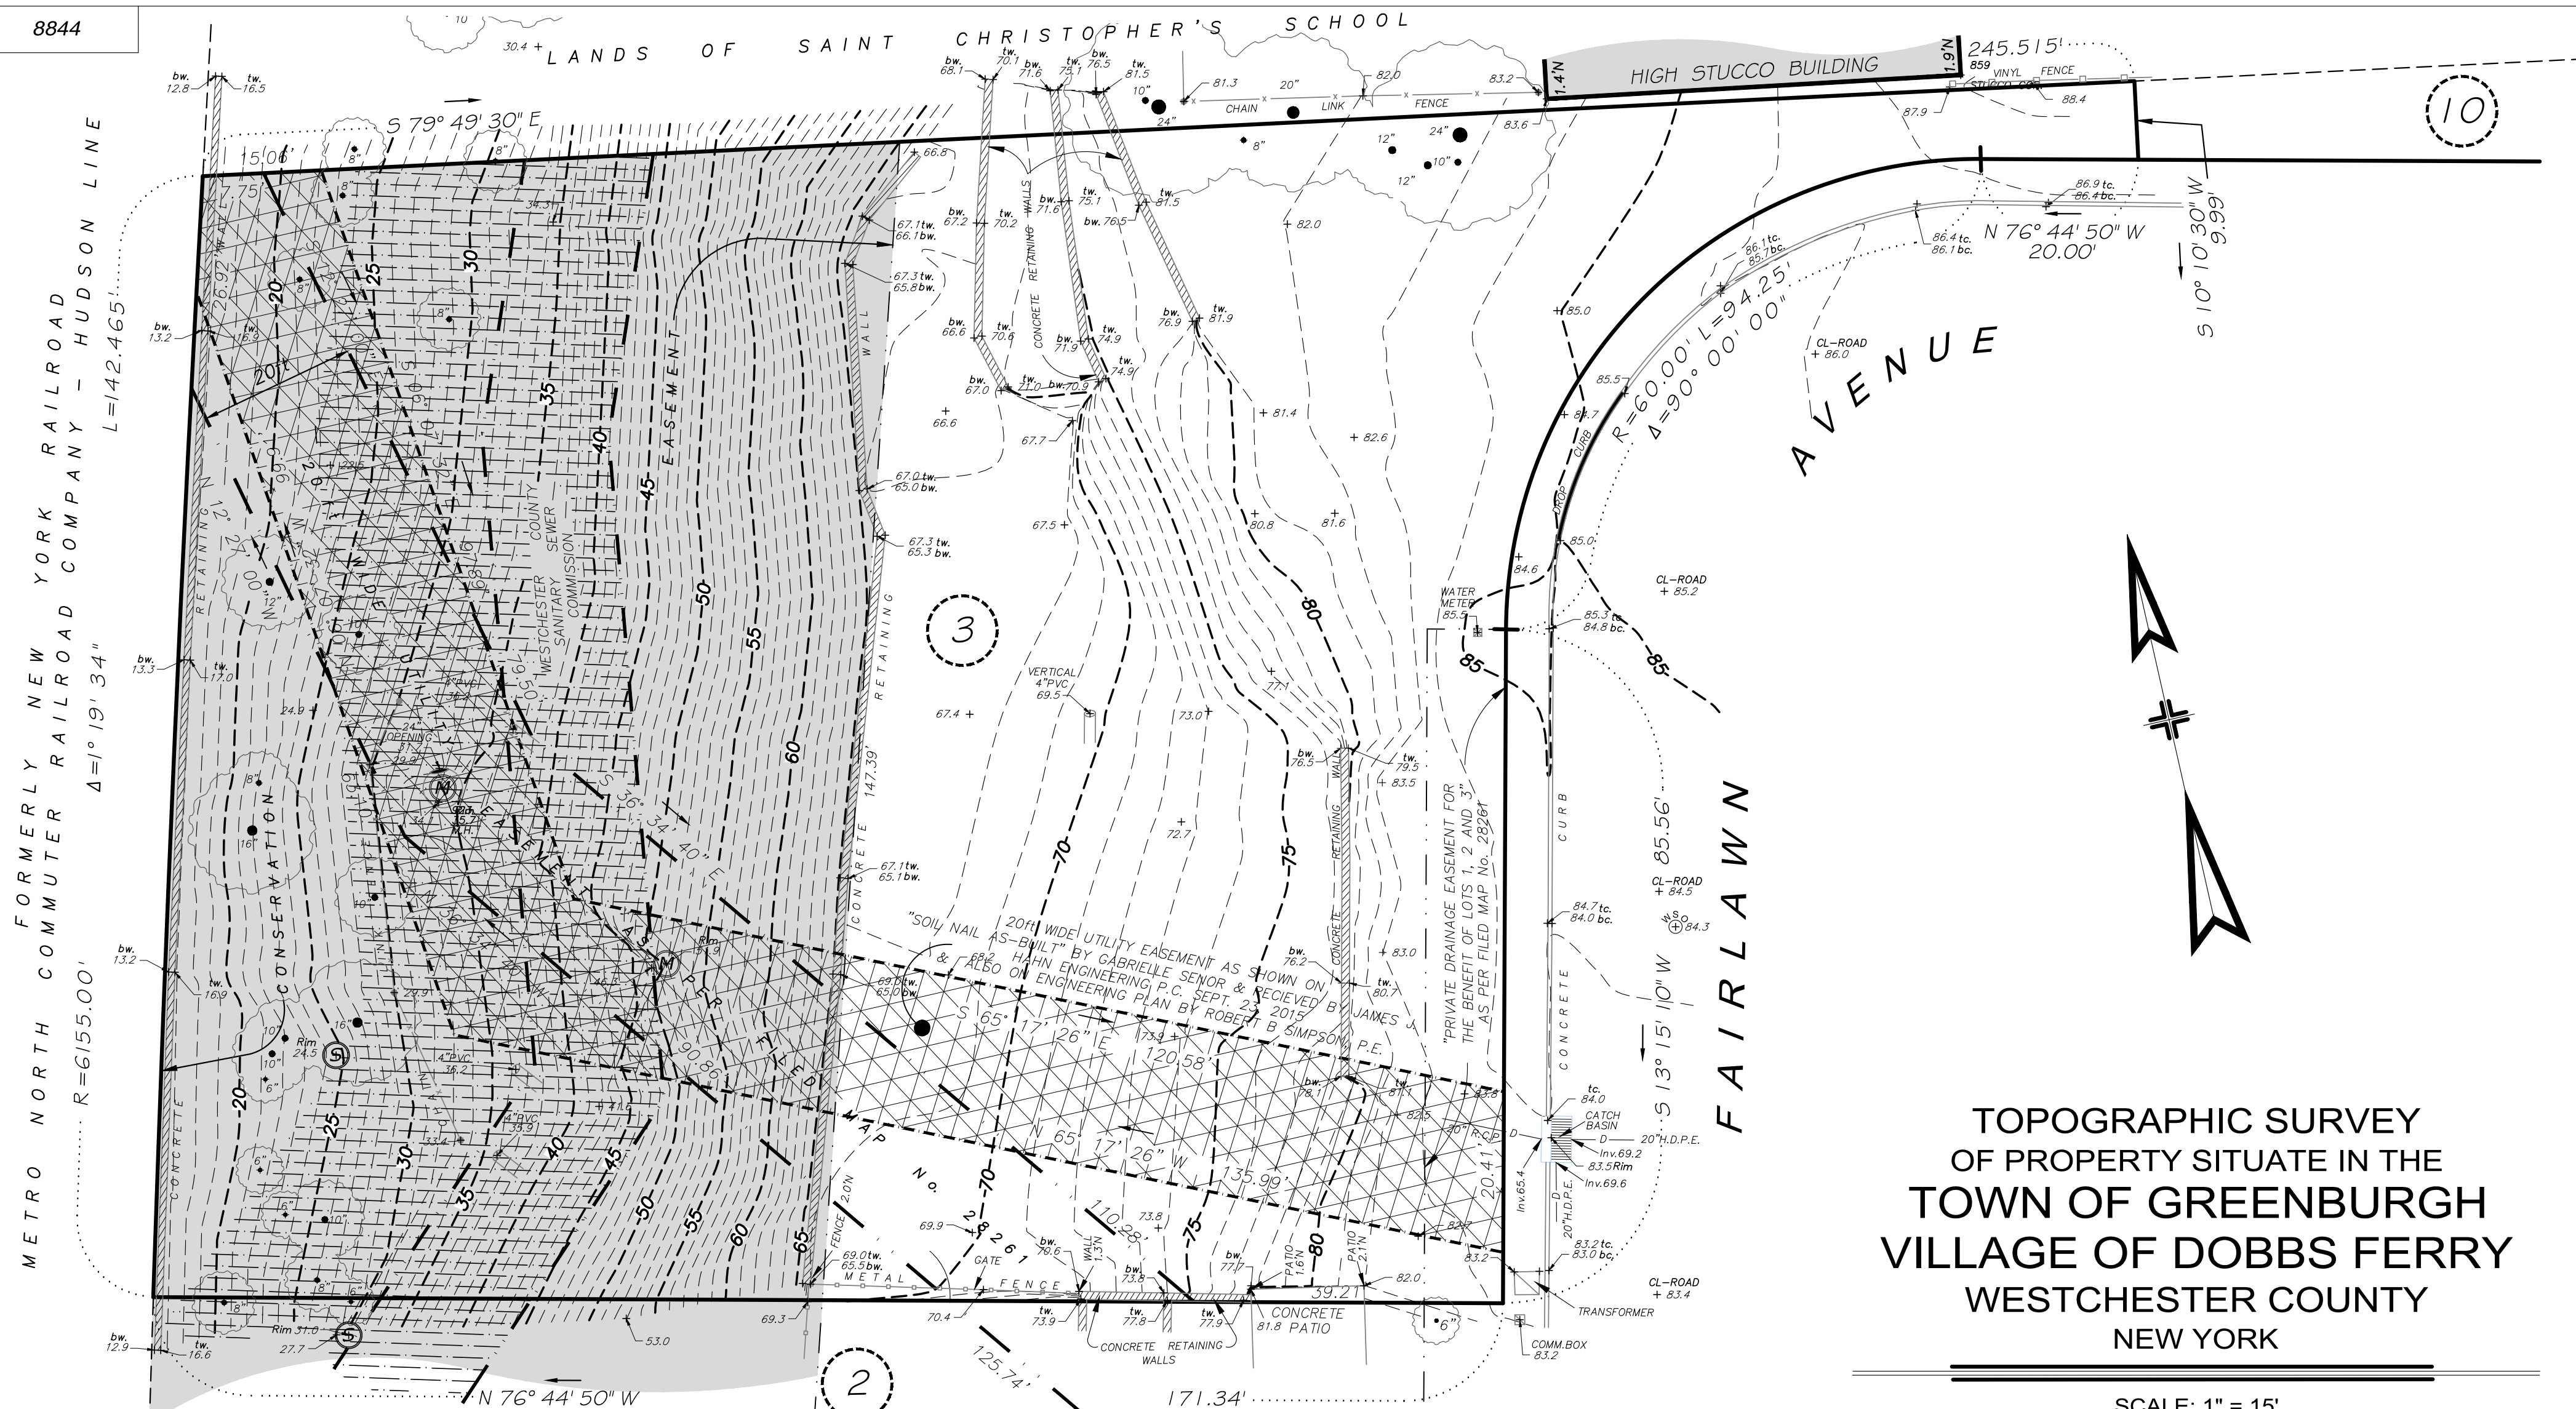

- THE PREMISES SHOWN HEREON BEING KNOWN AND DESIGNATED AS LOT No. 3 ON A CERTAIN MAP ENTITLED, "SUBDIVISION MAP OF WATERS EDGE AT DOBBS FERRY" DATED MAY 17, 2006 AND A FINAL REVISION DATE OF JULY 17, 2009 MADE BY PAUL PETRETTI, P.E. & L.S. FILED IN THE WESTCHESTER COUNTY CLERK'S OFFICE, DIVISION OF LAND RECORDS ON AUGUST 24, 2009 AS FILED MAP No. 28261
- PREMISES ARE DESIGNATED ON THE TAX MAPS FOR THE TOWN OF GREENBURGH / VILLAGE OF DOBBS FERRY SECTION: 3.150 BLOCK: 134 LOT: 12 PROPERTY ADDRESS: 11 FAIRLAWN AVENUE PROPERTY AREA: 26,164 Sq.Ft. - 0.6007 ACRE
- THIS MAP IS BASED UPON THE INFORMATION SUPPLIED BY THE CLIENT AND/OR HIS REPRESENTATIVE AND SUBJECT TO THE FINDINGS THAT A COMPLETE ABSTRACT OF TITLE MAY UNCOVER
- THE ELEVATIONS SHOWN HEREON ARE IN THE "NAVD 88", (NORTH AMERICAN VERTICAL DATUM 1988).
- THE OFFSETS SHOWN HEREON ARE NOT INTENDED TO ESTABLISH PROPERTY LINES FOR THE ERECTION OF FENCES, STRUCTURES OR ANY OTHER IMPROVEMENTS.

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- THIS MAP WAS PREPARED FROM AN ACTUAL FIELD SURVEY CONDUCTED ON THE DATE SHOWN AND THAT SAID SURVEY WAS PERFORMED IN ACCORDANCE WITH THE EXISTING "CODE OF PRACTICE FOR LAND SURVEYS" ADOPTED BY THE NEW YORK STATE ASSOCIATION OF PROFESSIONAL LAND SURVEYORS.


PREPARED FOR: ROSANNE ALTSCHULER

SCALE: 1" = 15'
SURVEYED: MARCH 1, 2021
SURVEY AMENDED TO SHOW TREES, WALL & 1ft CONTOURS: JULY 21, 2021
SURVEY AMENDED TO REFLECT CURRENT OWNER: APRIL 20, 2023

Link
Land Surveyors P.C.
21 Clark Place, Suite 1-B Phone 845-628-5857
Mahopac N.Y. 10541




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1. THE ENGINEER SHALL NOT BE RESPONSIBLE FOR THE SUPERVISION OF THE CONSTRUCTION.
2. ALL CHANGES SHALL BE MADE TO THESE PLANS EXCEPT AS PER NYS LAW CHAPTER 987.
3. ALL WORK AND MATERIALS SHALL COMPLY WITH ALL APPLICABLE CODES, INCLUDING BUT NOT LIMITED TO AEC, AISC, ZONING, AND THE NEW YORK STATE BUILDING CODE.
4. ALL CHANGES SHALL BE IMMEDIATELY NOTIFIED OF ANY DISCREPANCIES.
5. ALL CHANGES MADE TO THE PLANS SHALL BE APPROVED BY THE ENGINEER AND ALL SUCH CHANGES SHALL BE FILED AS AMENDMENTS TO THE ORIGINAL BUILDING PERMIT.
6. THE CONTRACTOR SHALL SUPERVISE AND DIRECT THE WORK USING HIS BEST SKILL AND ATTENTION. HE SHALL BE SOLELY RESPONSIBLE FOR ALL CONSTRUCTION MEANS, METHODS, TECHNIQUES, EQUIPMENT, PROGRAMS, AND SCHEDULES OR COORDINATING ALL PORTIONS OF THE WORK UNDER THE CONTRACT.
7. THE CONTRACTOR SHALL BE RESPONSIBLE TO THE OWNER FOR THE ACTS AND OMISSIONS OF HIS EMPLOYEES, SUBCONTRACTORS, AND ALL OTHERS, INCLUDING EMPLOYEES, AND OTHER PERSONS PERFORMING ANY OF THE WORK UNDER A CONTRACT WITH THE CONTRACTOR.
8. THE CONTRACTOR SHALL BE RESPONSIBLE FOR THE RESPONSIBILITY OF THE CONTRACTOR AND SHALL CONFORM TO ALL LOCAL, STATE AND FEDERAL AGENCIES IN EFFECT DURING THE PERIOD OF CONSTRUCTION.
9. THE CONTRACTOR AND HIS SUBCONTRACTORS SHALL MAKE APPLICATION TO RECEIVE ALL NECESSARY PERMITS TO DO THE WORK UNDER CONTRACT. THE CONTRACTOR AND HIS SUBCONTRACTORS SHALL BE LICENSED TO DO ALL WORK AS REQUIRED BY THE LOCAL, COUNTY, AND STATE AGENCIES WHICH MAY HAVE JURISDICTION OVER THE PROJECT. THE CONTRACTOR SHALL PRESENT THE OWNER WITH COPIES OF ALL LICENSES AND INSURANCE CERTIFICATES.
10. FINAL GRADING AROUND THE BUILDING AREA SHALL SLOPE AWAY FROM THE STRUCTURE.
11. ALL WRITTEN DIMENSIONS ON THE DRAWINGS SHALL TAKE PRECEDENCE OVER ANY SCALED DIMENSIONS.
12. ADJOINING PUBLIC AND PRIVATE PROPERTY SHALL BE PROTECTED FROM DAMAGE BY EROSION, REMODELING AND DEMOLITION WORK. PROTECTION MUST BE PROVIDED FOR FOOTINGS, FOUNDATIONS, PARTY WALLS, CHIMNEYS, SKYLIGHTS AND ROOFS. PROVISIONS SHALL BE MADE TO CONTROL WATER RUNOFF AND EROSION DURING CONSTRUCTION OR DEMOLITION ACTIVITIES. THE PERSON NOTICING OR BECOMING AWARE OF ANY EROSION OR DAMAGE TO ADJOINING PROPERTY SHALL IMMEDIATELY ADVISE THE OWNER. THE OWNERS OF ADJOINING BUILDINGS ADVISING THEM THAT THE EXCAVATION IS TO BE MADE AND THAT THE ADJOINING BUILDING SHOULD BE PROTECTED. SAID PROTECTION SHALL BE DELIVERED TO THE OWNER WITHIN 10 DAYS PRIOR TO THE SCHEDULED STARTING DATE OF THE EXCAVATION.
13. OWNER SHALL INSURE THAT THE INSURANCE PROVIDED BY THE CONTRACTOR HIRED TO PERFORM THE WORK SHALL BE IN ACCORD WITH THE NEW YORKS ENGINEERING & CONSULTING, P.C. AND ALL DIRECTOR, OFFICER, EMPLOYEES, SUBSIDIARIES, AND AFFILIATES, AS ADDITIONAL INSURED ON ALL POLICIES AND HOLD HARMLESS DOCUMENTS, AND SHALL STIPULATE THAT THIS INSURANCE IS PRIMARY, AND THAT THE INSURANCE OF SELF-EMPLOYED OR NON-EMPLOYED PERSONS ENGINEERING & CONSULTING, P.C., SHALL BE EXCESS ONLY AND SHALL NOT BE CALLED UPON TO CONTRIBUTE WITH THIS INSURANCE. (SO ADDITIONAL INSURED ENDORSEMENT FORM MUST BE OBTAINED FROM THE INSURANCE CARRIER BY THE NEW YORKS ENGINEERING & CONSULTING, P.C. PRIOR TO THE SIGNING OF THE CONTRACT).
14. INDUSTRIAL CODE RULE 753. PRIOR TO THE CONTRACTOR SHALL NOTIFY ALL UTILITY COMPANIES PRIOR TO THE START OF HIS OPERATIONS AND SHALL COMPLY WITH ALL THE LATEST INDUSTRIAL CODE RULE 753 REGULATIONS.

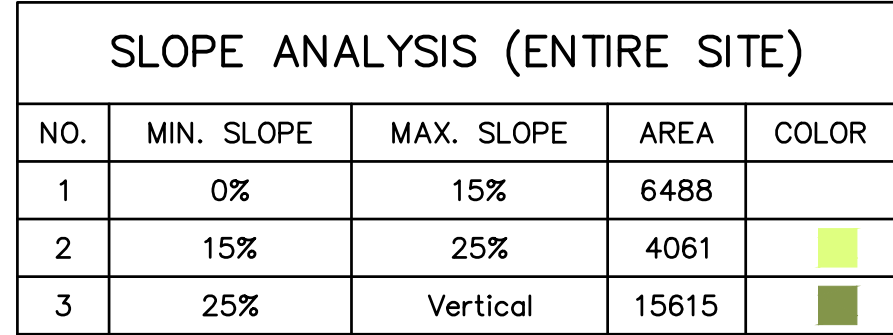				PROJECT:	
			4/19/23	Date	
				REUSED PER VILLAGE COMMENTS	
				Description	
				Revisions	
				No.	
THIS PLAN NOT VALID FOR CONSTRUCTION WITHOUT ENGINEERS SEAL & SIGNATURE					
<p align="center">PROJECT DWELLING 11 FAIRLAWN AVENUE VILLAGE OF DOBBS FERRY WESTCHESTER COUNTY – NEW YORK</p>					
SLOPE ANALYSIS/DEMOLITION PLAN					
<div style="text-align: center;"> HUDSON <hr/>ENGINEERING & CONSULTING, P.C. 45 Knollwood Avenue Suite 201 Elmsford, New York 10523 T: 914-908-0420 F: 914-560-2086 © 2023 </div>					
Date: 03/16/23 Sheet:					
Scale: 1" = 10' 1					
Designed By: U.A.					
Checked By: M.S.					3
Sheet No.					
					C-1



LEGEND

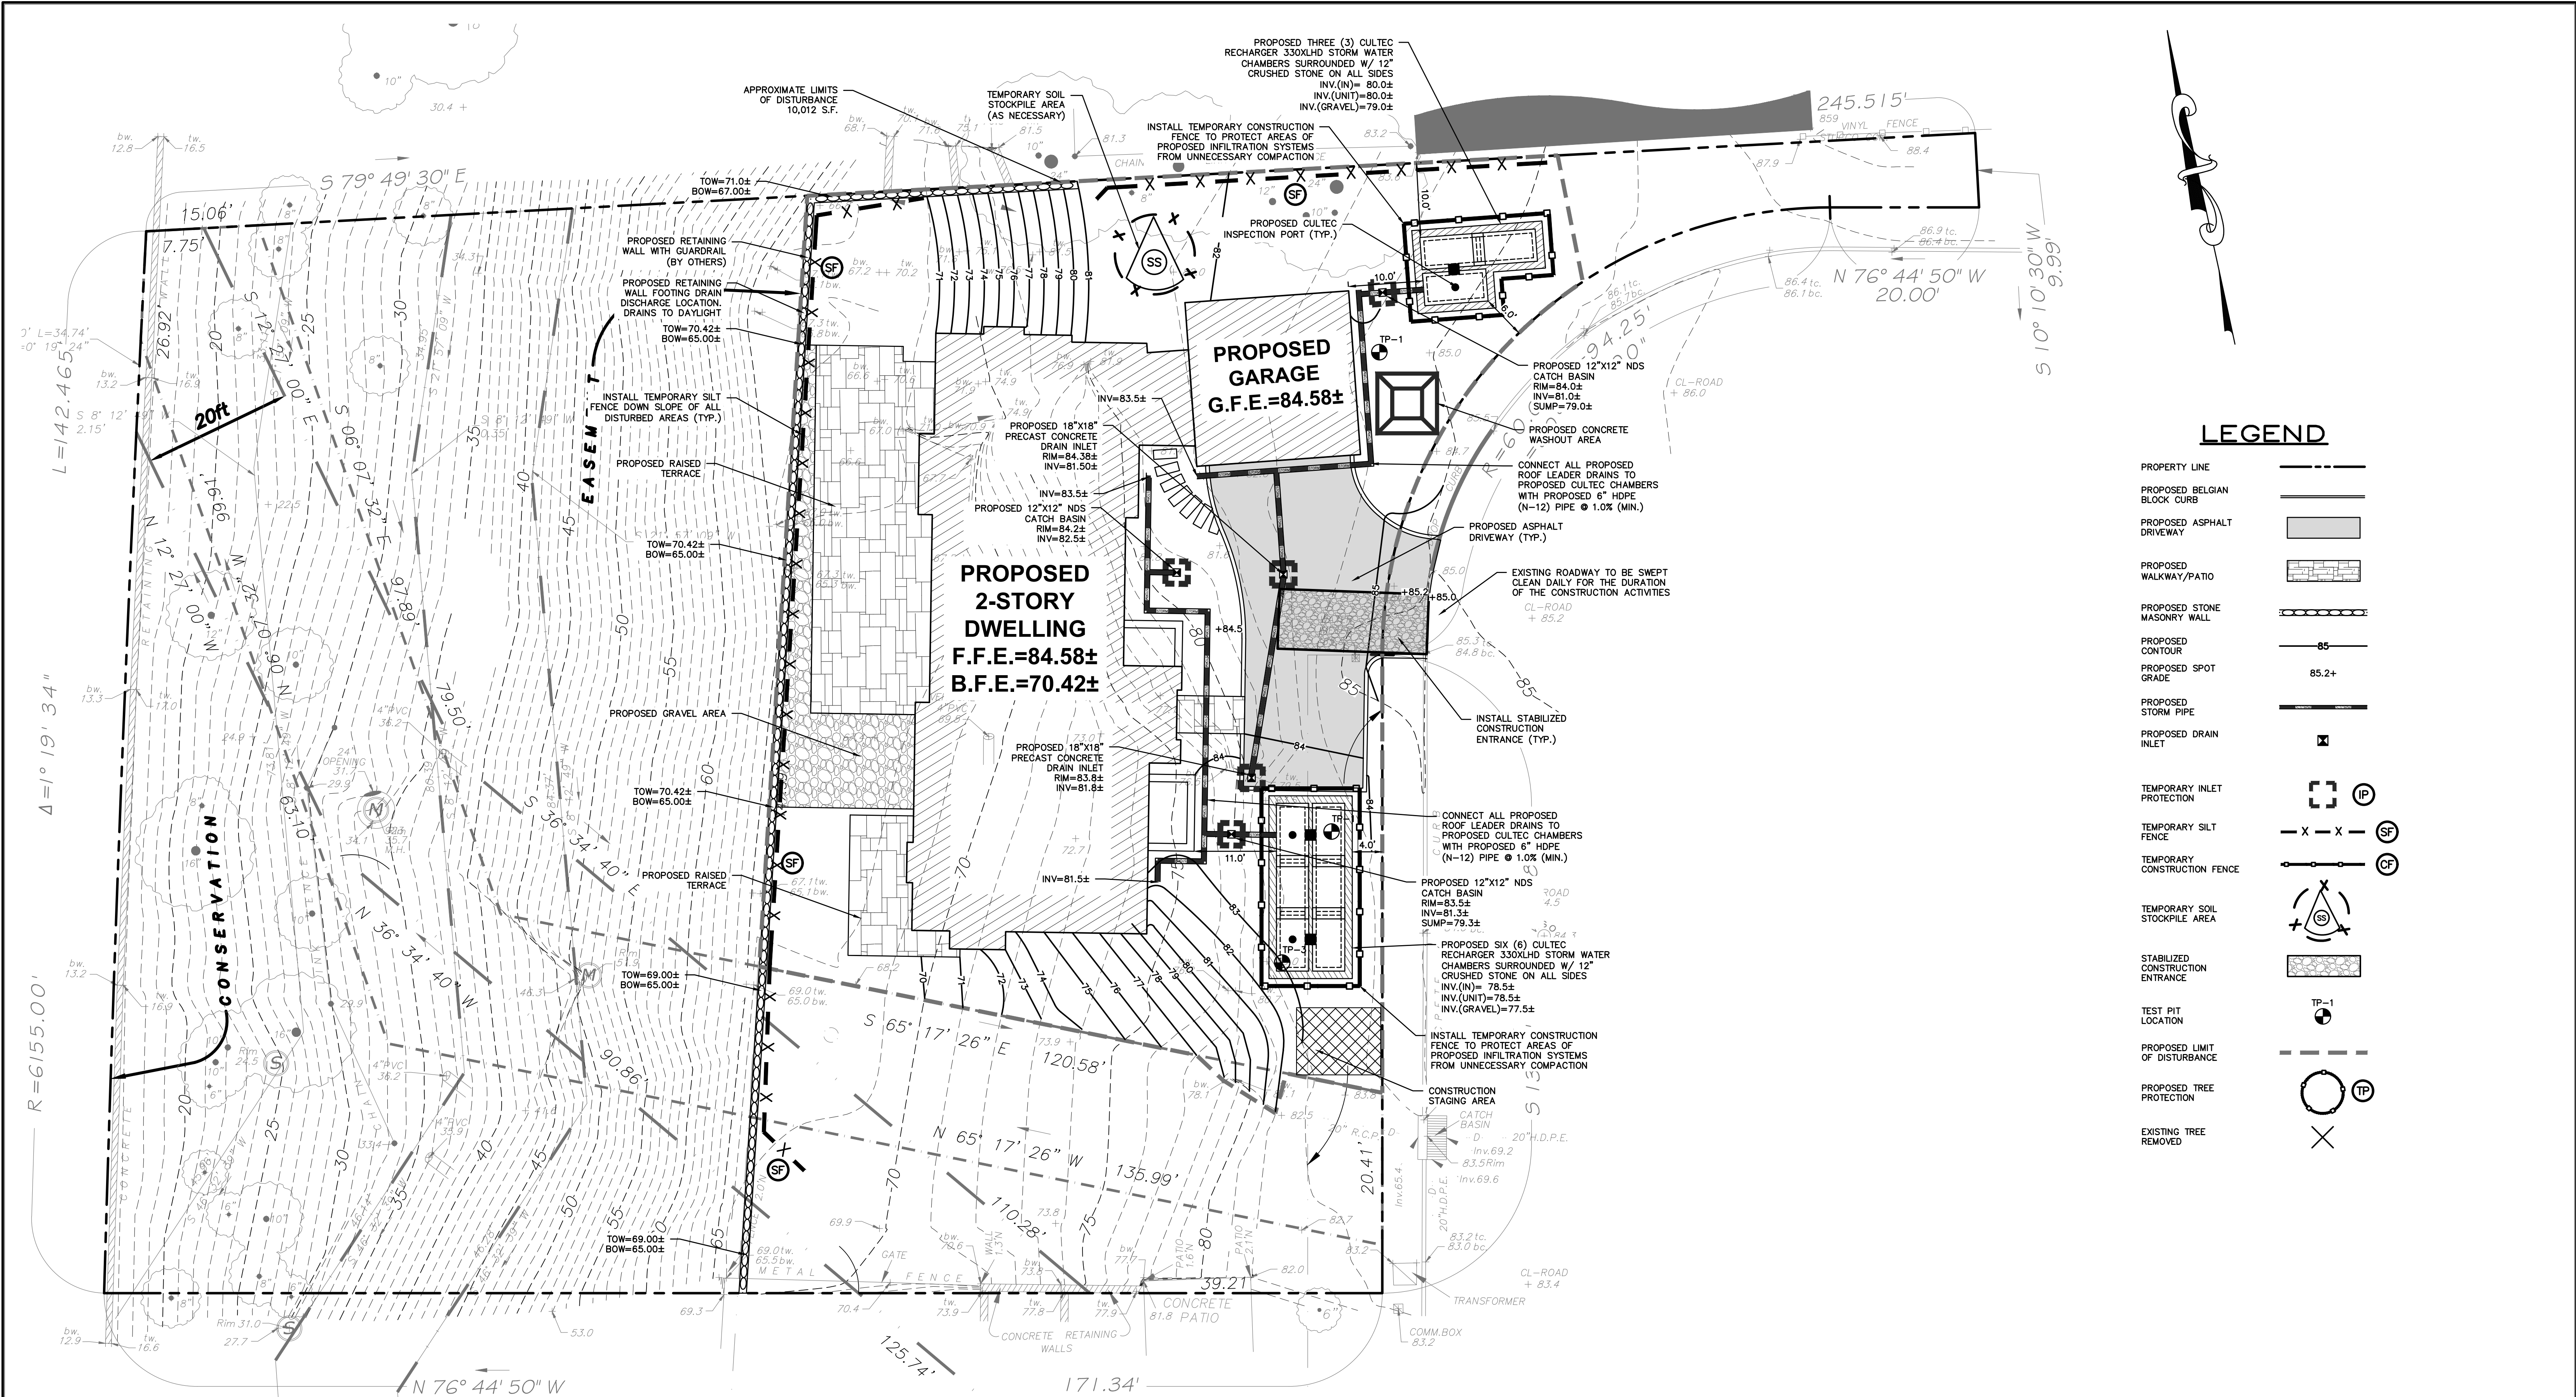- PROPERTY LINE
- PROPOSED BELGIAN BLOCK CURB
- PROPOSED ASPHALT DRIVEWAY
- PROPOSED WALKWAY/PATIO
- PROPOSED STONE MASONRY WALL
- PROPOSED CONTOUR
- PROPOSED SPOT GRADE
- PROPOSED STORM PIPE
- PROPOSED DRAIN INLET
- TEMPORARY INLET PROTECTION
- TEMPORARY SILT FENCE
- TEMPORARY CONSTRUCTION FENCE
- TEMPORARY SOIL STOCKPILE AREA
- STABILIZED CONSTRUCTION ENTRANCE
- TEST PIT LOCATION
- PROPOSED LIMIT OF DISTURBANCE
- PROPOSED TREE PROTECTION
- EXISTING TREE REMOVED

INSTALLATION & MAINTENANCE OF EROSION CONTROL:

CONSTRUCTION SCHEDULE
NOTIFY APPROPRIATE MUNICIPAL AGENCY HAVING JURISDICTION AT LEAST 5 DAYS PRIOR TO START.

EROSION CONTROL MEASURES
INSTALL ALL EROSION CONTROL MEASURES PRIOR TO START OF CONSTRUCTION. CALL FOR INSPECTION FROM THE APPROPRIATE MUNICIPAL AGENCY HAVING JURISDICTION AT LEAST 2 DAYS PRIOR TO FINISH.

INSPECTION BY MUNICIPALITY
MAINTENANCE (TO BE PERFORMED DURING ALL PHASES OF CONSTRUCTION)

AFTER ANY RAIN CAUSING RUNOFF, CONTRACTOR TO INSPECT HAYBALES, ETC. AND REMOVE ANY EXCESSIVE SEDIMENT AND INSPECT STOCKPILES AND CORRECT ANY PROBLEMS WITH SEED ESTABLISHMENT. INSPECTIONS SHALL BE DOCUMENTED IN WRITING AND SUBMITTED TO THE APPROPRIATE MUNICIPAL AGENCY HAVING JURISDICTION.

INSPECTION BY MUNICIPALITY - FINAL GRADING
REMOVE UNNEEDED SUBGRADE FROM SITE. CALL FOR INSPECTION FROM THE APPROPRIATE MUNICIPAL AGENCY HAVING JURISDICTION AT LEAST 2 DAYS PRIOR TO FINISH.

INSPECTION BY MUNICIPALITY - LANDSCAPING

SPREAD TOPSOIL EVENLY OVER AREAS TO BE SEED. HAND RAKE LEVEL. BROADCAST 1.25 LB. BAG OF JONATHAN GREEN "FASTGROW" MIX OR EQUAL OVER AREA TO BE SEED. APPLY STRAW MULCH AND WATER WITHIN 2 DAYS OF COMPLETION OF TOPSOILING. CALL FOR INSPECTION FROM THE APPROPRIATE MUNICIPAL AGENCY HAVING JURISDICTION AT LEAST 2 DAYS PRIOR TO FINISH.

INSPECTION BY MUNICIPALITY - FINAL LANDSCAPING

GRASS ESTABLISHED. CALL FOR INSPECTION FROM THE APPROPRIATE MUNICIPAL AGENCY HAVING JURISDICTION AT LEAST 2 DAYS PRIOR TO FINISH.

INSPECTION BY MUNICIPALITY - FINAL INSPECTION

ALL EROSION CONTROL MEASURES REMOVED AND GRASS ESTABLISHED. CALL FOR INSPECTION FROM THE APPROPRIATE MUNICIPAL AGENCY HAVING JURISDICTION AT LEAST 2 DAYS PRIOR TO FINISH.

EXISTING INFORMATION SHOWN HEREON
PROVIDED BY LINK LAND SURVEYORS
DATED JULY 21, 2021

GRAPHIC SCALE



(IN FEET)
1 inch = 10 ft.


CONTRACTOR SHALL CONTACT DESIGN ENGINEER TO SCHEDULE A SITE INSPECTION PRIOR TO BACKFILLING INFILTRATION/ATTENUATION SYSTEM(S). ALL CONNECTIONS SHALL BE INSTALLED IN ACCORDANCE WITH MANUFACTURER'S SPECIFICATIONS AND VISIBLE AT TIME OF INSPECTION. SHOULD THE CONTRACTOR BACKFILL PRIOR TO INSPECTION, THE CONTRACTOR SHALL EXPOSE THE SYSTEM AT THEIR OWN EXPENSE.

ANY ALTERATIONS OR REVISIONS OF THESE PLANS, UNLESS DONE BY OR UNDER THE DIRECTION OF THE NYS LICENSED AND REGISTERED ENGINEER THAT PREPARED THEM, IS A VIOLATION OF THE NYS EDUCATION LAW.

PROJECT:		PROJECT DWELLING 11 FAIRLAWN AVENUE VILLAGE OF DOBBS FERRY WESTCHESTER COUNTY - NEW YORK	
STORMWATER MANAGEMENT PLAN		HUDSON ENGINEERING CONSULTING, P.C. 45 Knollwood Road, Suite 201 Elmsford, New York 10523 T: 914-909-0420 F: 914-560-2086 © 2023	
THIS PLAN NOT VALID FOR CONSTRUCTION WITHOUT ENGINEER'S SEAL & SIGNATURE		Date: 03/16/23 Sheet: 2 Scale: 1" = 10' 2 Designed By: U.A. Checked By: M.S. Sheet No. C-2	



1 Neighborhood Pictures

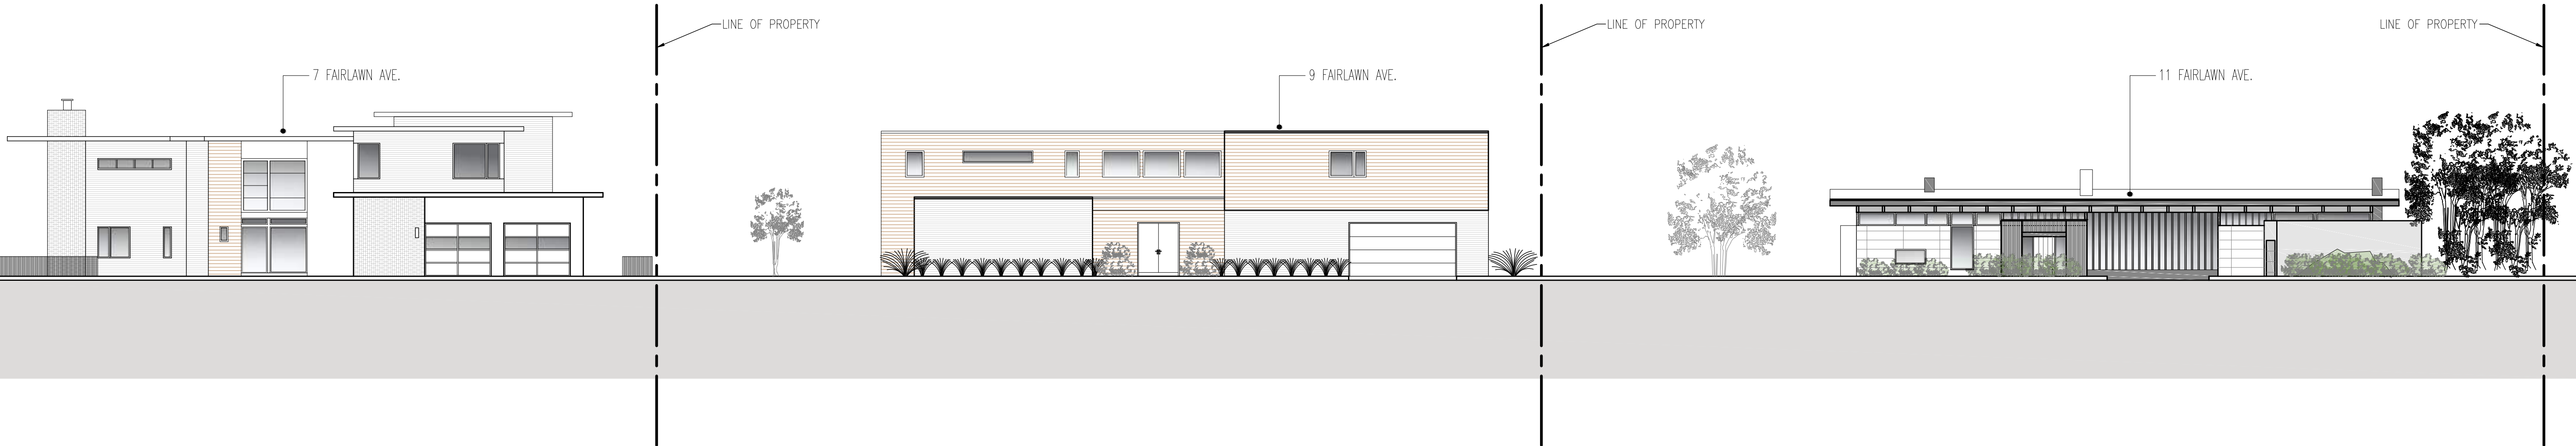

2 Proposed Front Elevation and Adjacent Buildings- View from Street
Scale: 1/8"=1'-0"

Project Architect:
GSA
GREGORY SHARP ARCHITECT, PC
145 PALISADE STREET, SUITE 211
DOBBS FERRY
DIRECT 917 597 1982
INFO@CASEDEVELOPMENT.COM
OWNER'S REP / PROJECT MANAGER

CASE DEVELOPMENT

Case Development Inc
145 PALISADE STREET, SUITE 211
DOBBS FERRY, NY 10522
www.casedevelopment.com
DIRECT 917 597 1982

D.O.B CONSULTANT

LANDSCAPE ARCHITECT

ARBORIST


STRUCTURAL ENGINEER

PROJECT ENGINEER

NOTES

SYMBOL LEGEND

	See Detail		Interior Elevation
	Elevation		Coordination Tag
	Section Cut		Door Number
	Window Number		Wall Type
			0.0' Elevation Target
			Revision

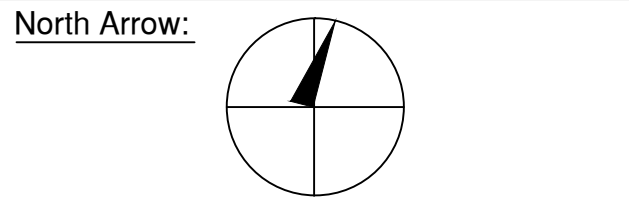

DRAWINGS AND SPECIFICATIONS REPRESENTED AND OR INDICATED HEREBY ARE THE PROPERTY OF CASE DEVELOPMENT, AND ARE NOT TO BE USED, EITHER IN WHOLE OR IN PART, FOR ANY OTHER PROJECTS OR PURPOSES, BY ANY PARTIES OTHER THAN THOSE AUTHORIZED BY CONTRACT, WITHOUT PRIOR WRITTEN AUTHORIZATION FROM CASE DEVELOPMENT.

DRAWING INFORMATION

ISSUED FOR PRE-FILE	12-8-2022
ISSUED FOR PRE-FILE	1-24-2023
ISSUED FOR PRE-FILE	2-14-2023
ISSUED FOR AHRB	3-15-2023

D.O.B. No. -

A New House located in
Dobbs Ferry, NY developed by:


The Altshuler Residence

PROJECT:
THE ALTSHULER RESIDENCE
11 FAIRLAWN AVENUE,
DOBBS FERRY, NY 10522

NEIGHBOORS PICTURES
ADJACENT BUILDINGS

SEAL AND SIGNATURE:	DATE:	3/15/2023
	PROJECT No:	ALTSHULER 2023
	DRAWING BY:	GS
	CHECK BY:	
	DWG No:	T-002.00
	CADD No:	

BSCAN:

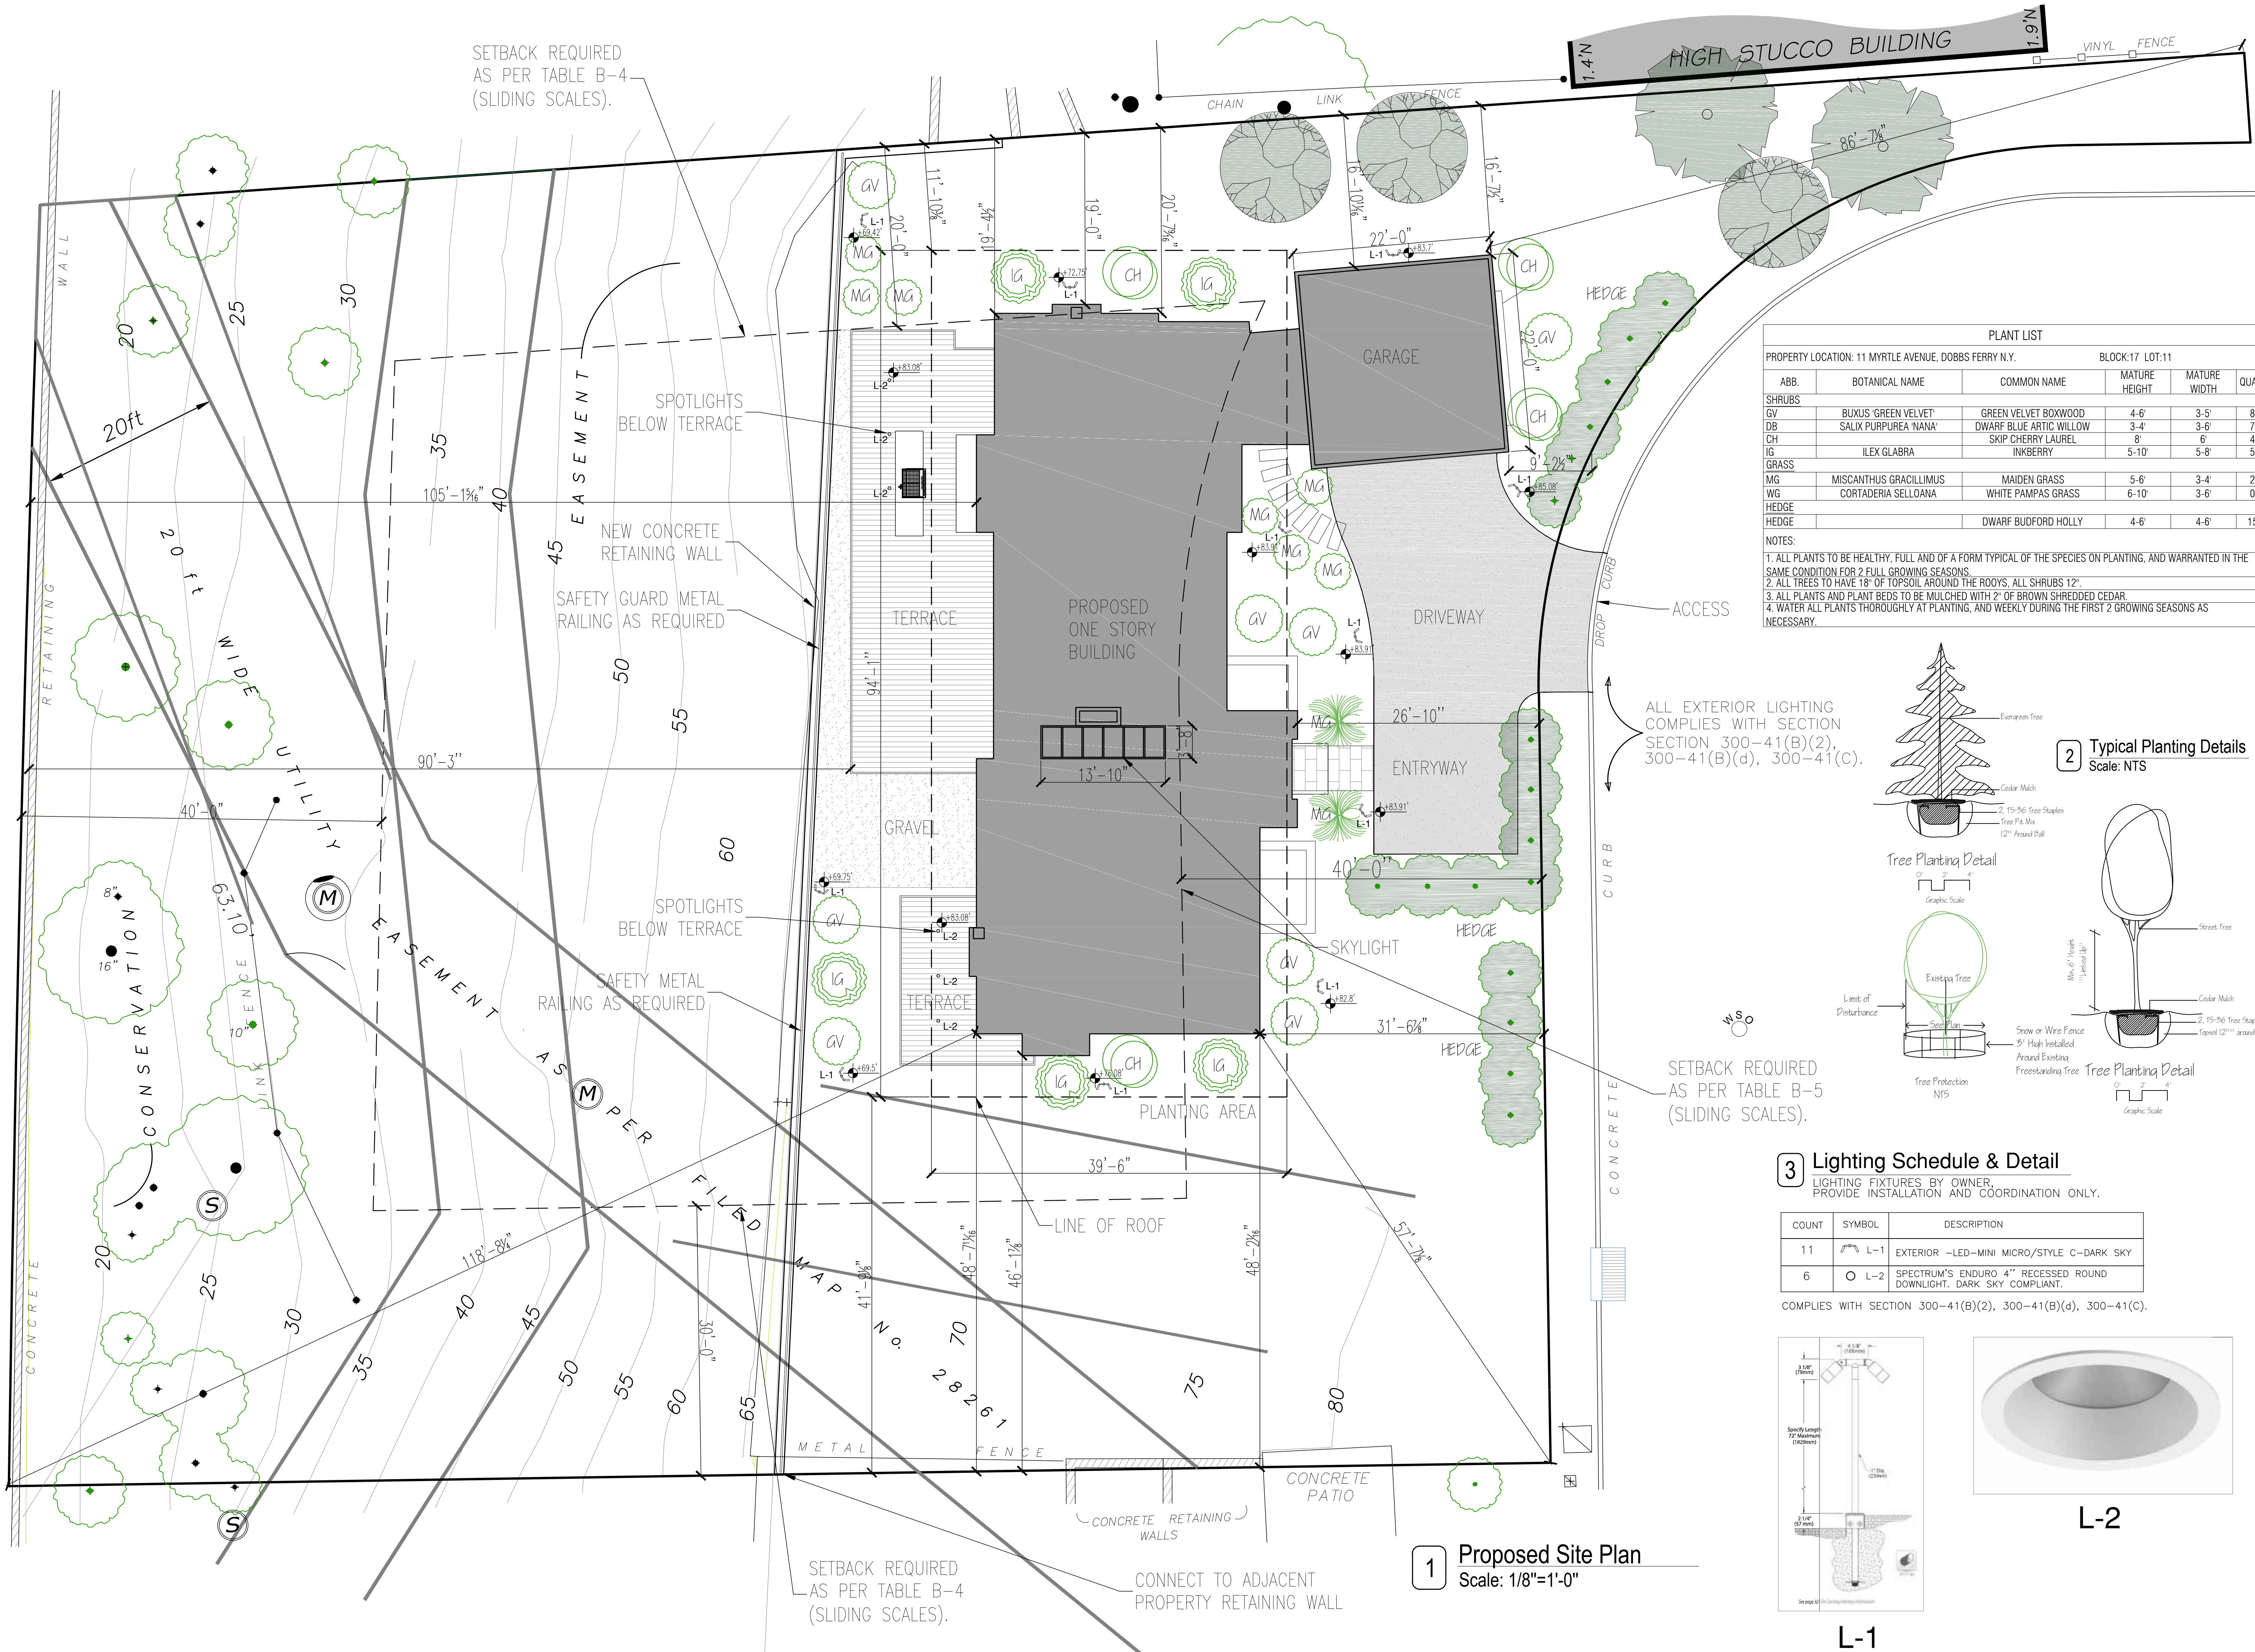

Project Architect:
GS
GREGORY SHARP ARCHITECT, PC
145 PALISADE STREET, SUITE 211
DOBBS FERRY
DIRECT 917 597 1982
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CASE DEVELOPMENT

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DOBBS FERRY, NY 10522
www.casedevelopment.com
DIRECT 917 597 1982

D.O.B CONSULTANT

LANDSCAPE ARCHITECT

ARBORIST

STRUCTURAL ENGINEER

PROJECT ENGINEER

NOTES

SYMBOL LEGEND

Interior Elevation

See Detail

Elevation

Section Cut

Window Number

Coordination Tag

Door Number

Wall Type

0.0' Elevation Target

Revision

North Arrow:

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ISSUED FOR PRE-FILE 2-14-2023
ISSUED FOR AHRB 3-15-2023

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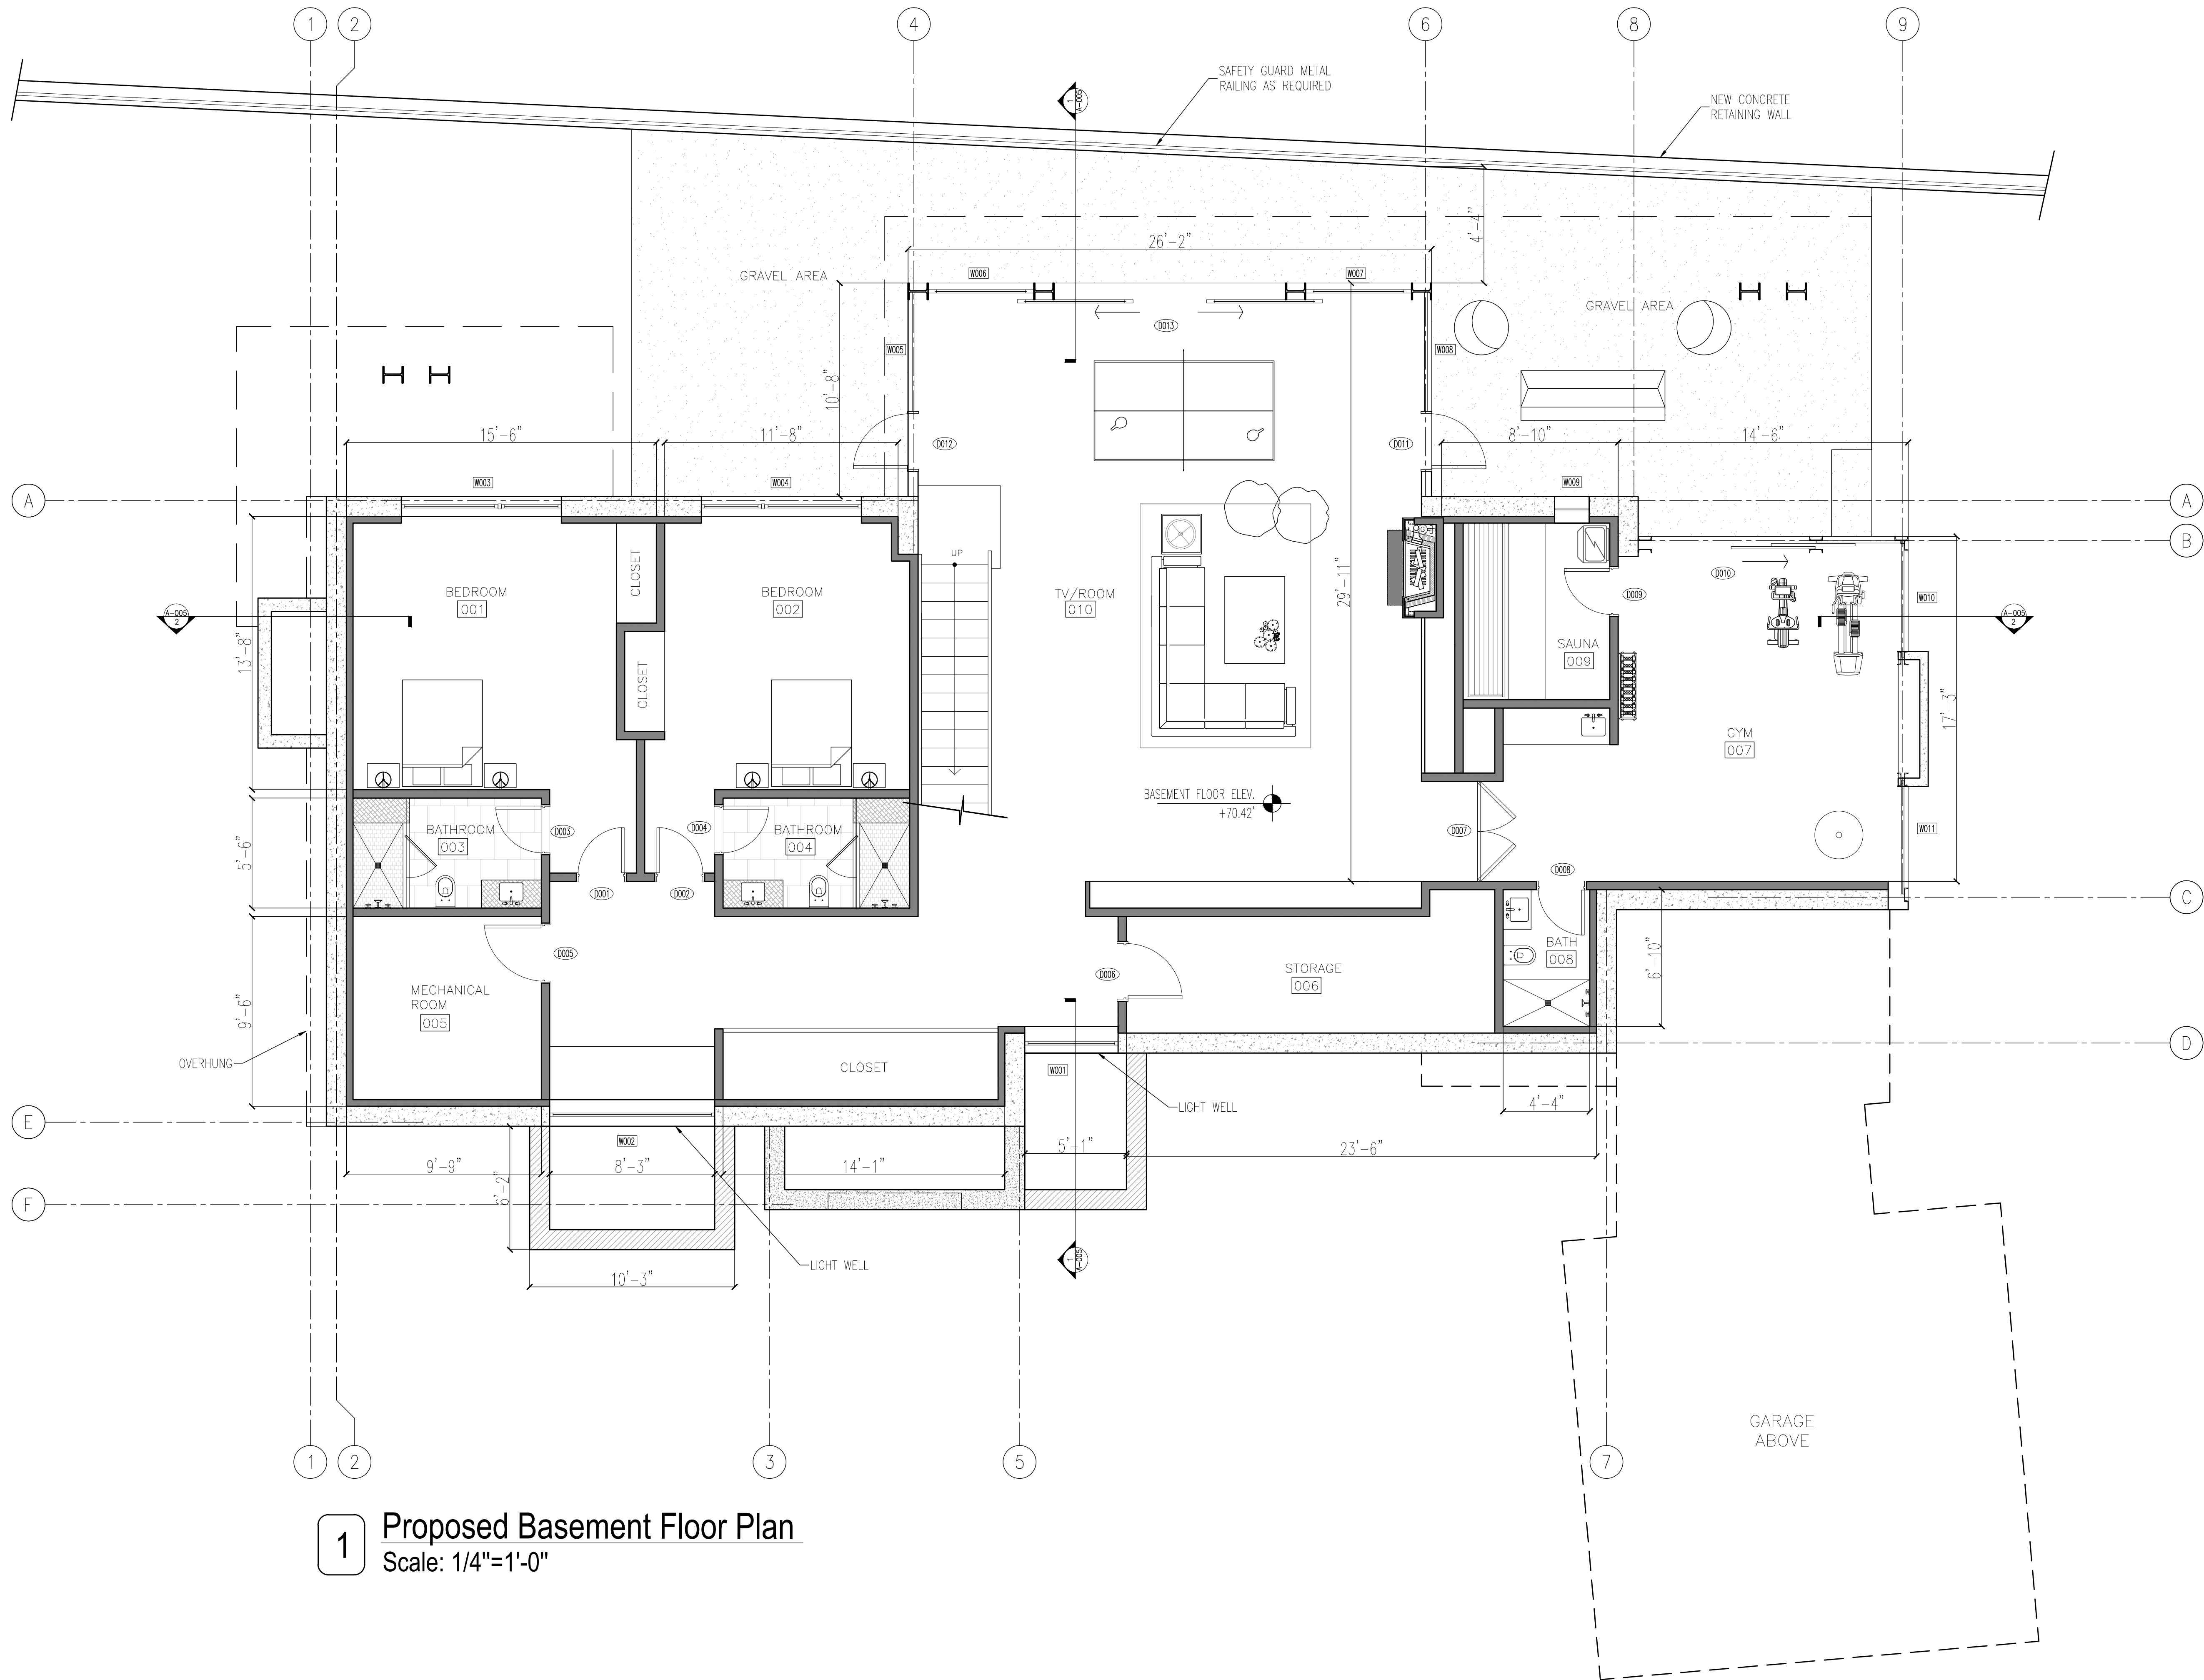
The Altshuler Residence

PROJECT:
THE ALTSHULER RESIDENCE
11 FAIRLAWN AVENUE,
DOBBS FERRY, NY 10522

PROPOSED SITE PLAN

SEAL AND SIGNATURE:
GREGORY SHARP ARCHITECT, PC
DATE: 3/15/2023
PROJECT No: ALTSHULER 2023
DRAWING BY: GS
DWG No: **A-001.00**
CADD No:

BSCAN:



1 Proposed Basement Floor Plan
Scale: 1/4"=1'-0"

Project Architect:
GS
GREGORY SHARP ARCHITECT, PC
145 PALISADE STREET, SUITE 211
DOBBS FERRY
DIRECT 917 597 1982
INFO@CASEDEVELOPMENT.COM
OWNER'S REP / PROJECT MANAGER

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DOBBS FERRY, NY 10522
www.casedevelopment.com
DIRECT 917 597 1982

D.O.B CONSULTANT

LANDSCAPE ARCHITECT

ARBORIST


STRUCTURAL ENGINEER

PROJECT ENGINEER

NOTES

SYMBOL LEGEND

	Interior Elevation
	Coordination Tag
	Door Number
	Wall Type
	0.0' Elevation Target
	Revision

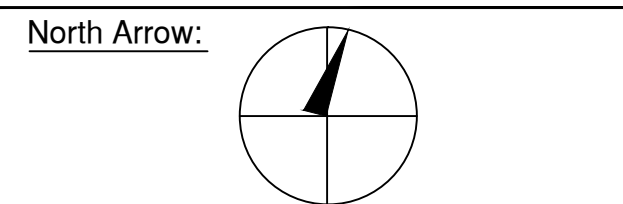

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ISSUED FOR PRE-FILE	2-14-2023
ISSUED FOR AHRB	3-15-2023

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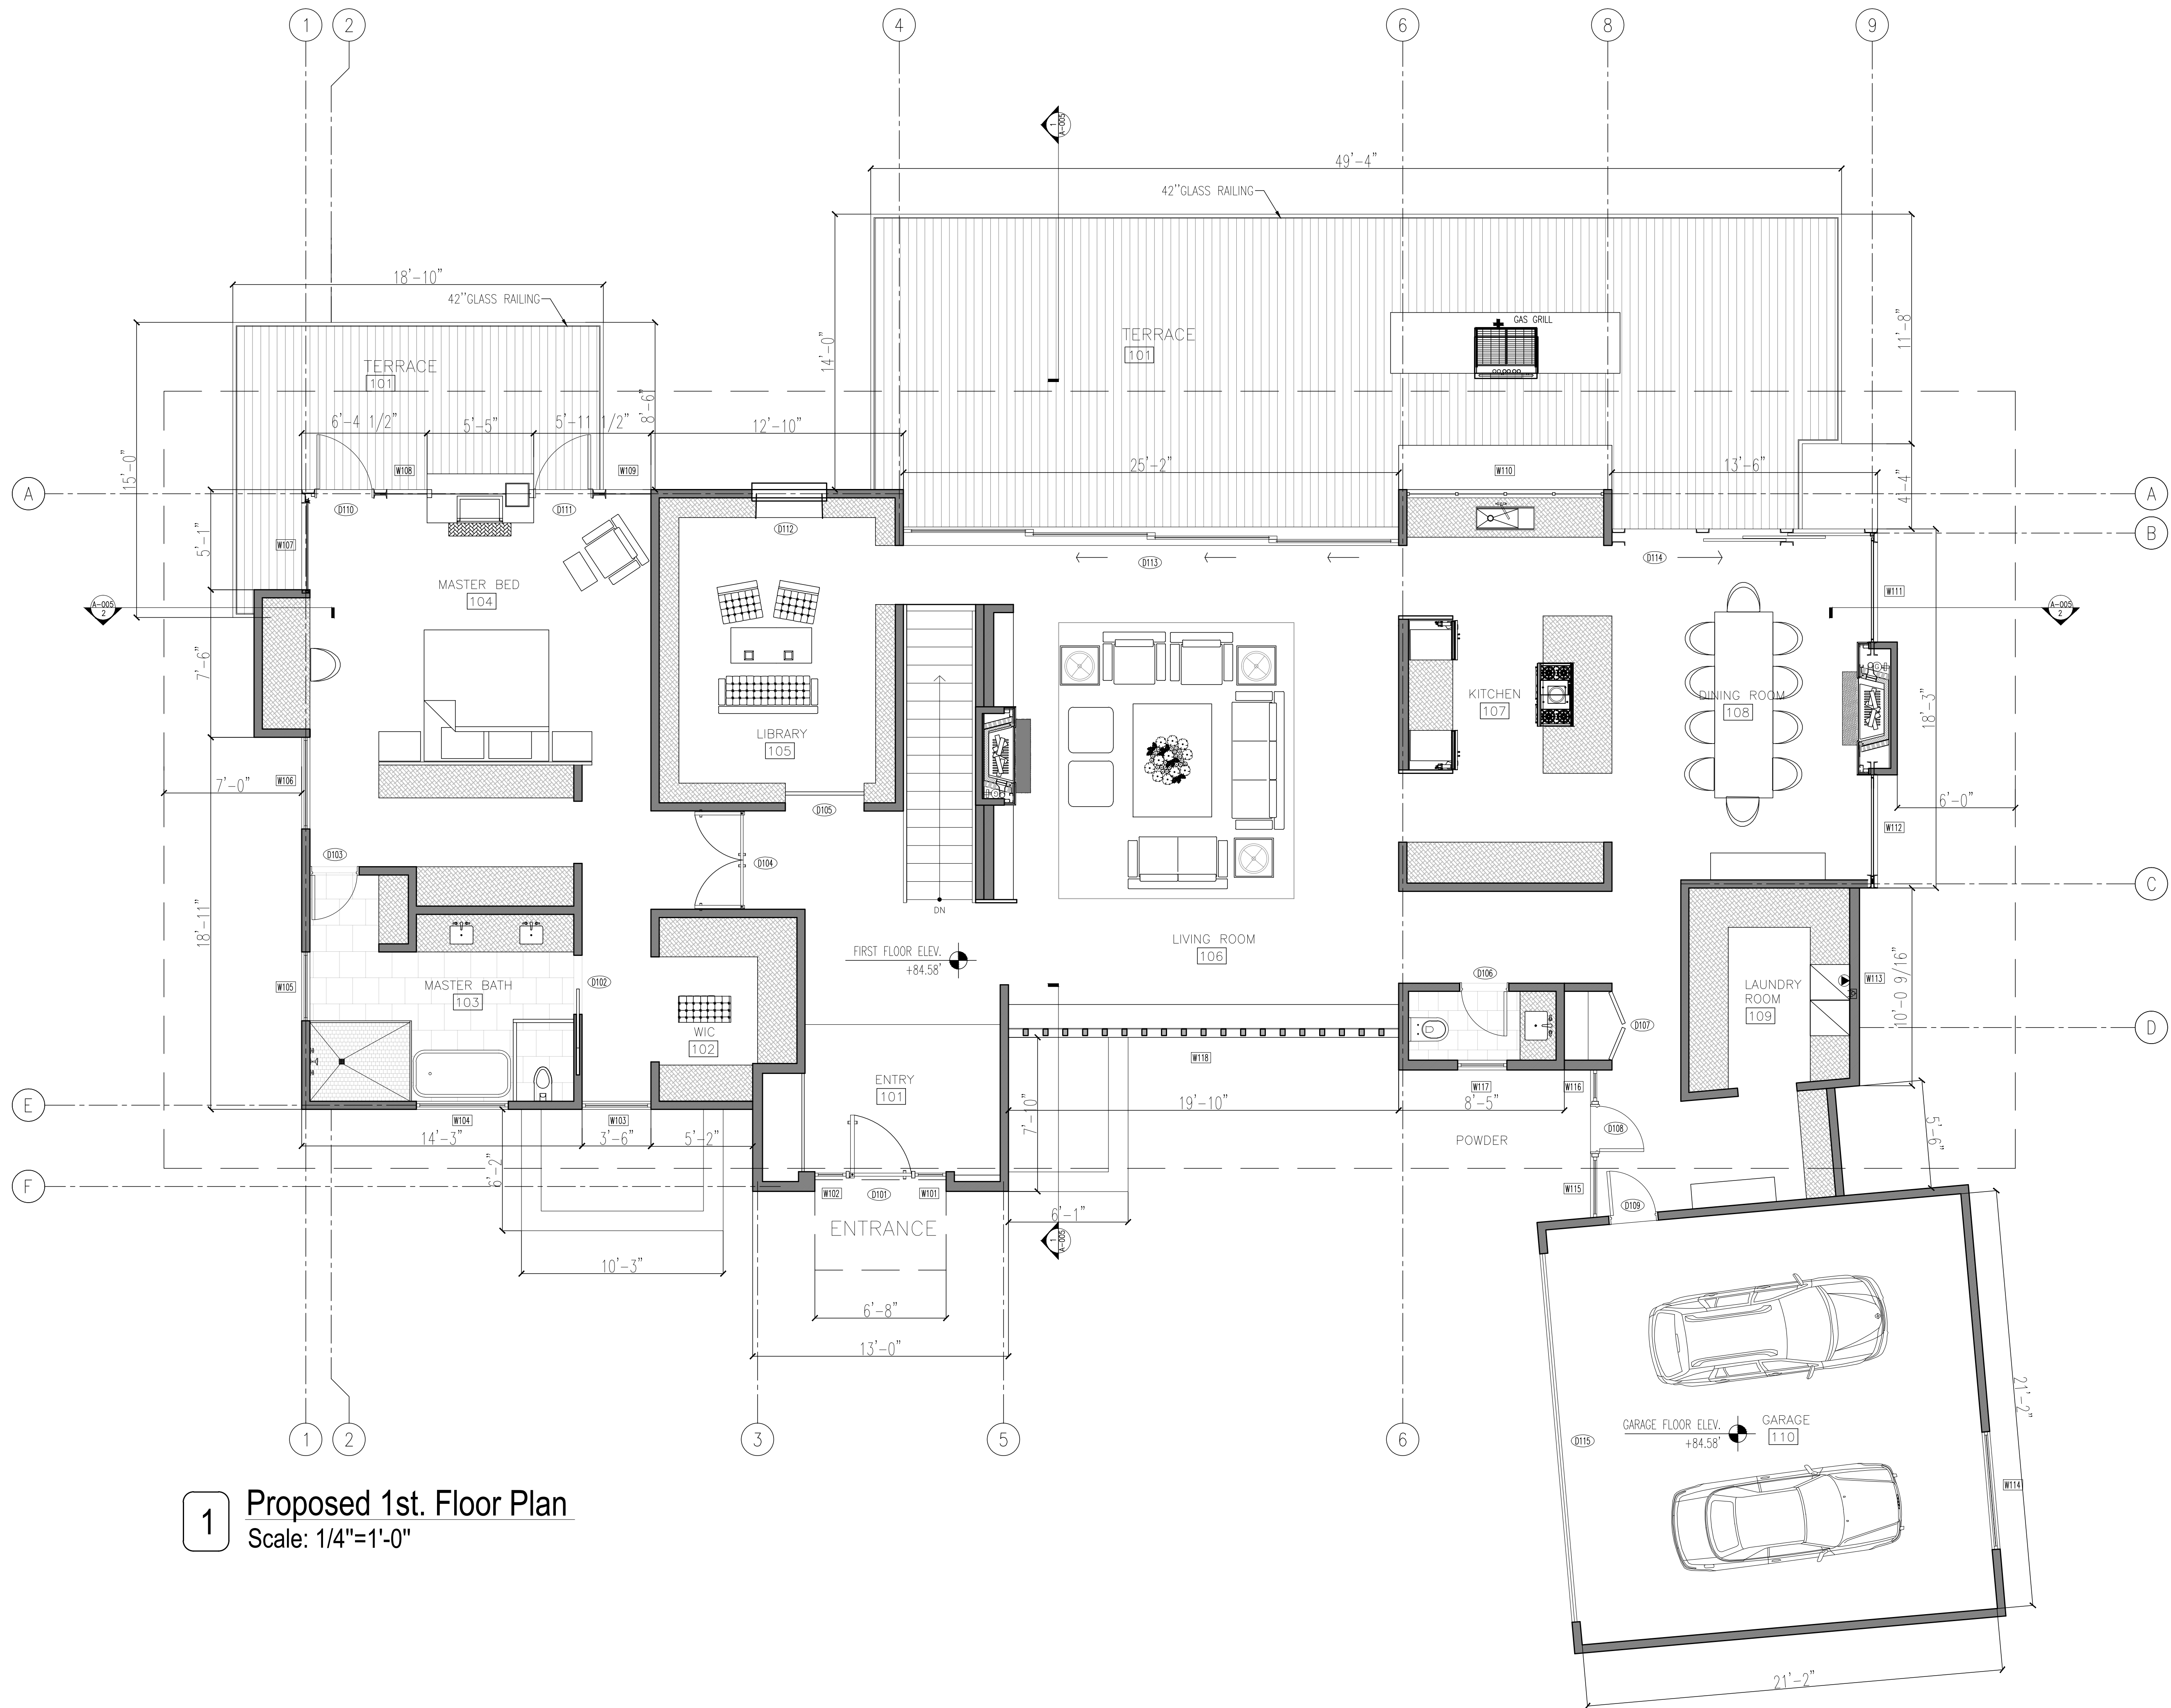
The Altshuler Residence

PROJECT:
THE ALTSHULER RESIDENCE
11 FAIRLAWN AVENUE,
DOBBS FERRY, NY 10522


PROPOSED BASEMENT

SEAL AND SIGNATURE:	DATE: 3/15/2023
	PROJECT No: ALTSHULER 2023
	DRAWING BY: GS
	CHECK BY:
	DWG No: A-002.00
CADD No:	

BSCAN:



1 Proposed 1st. Floor Plan
Scale: 1/4"=1'-0"

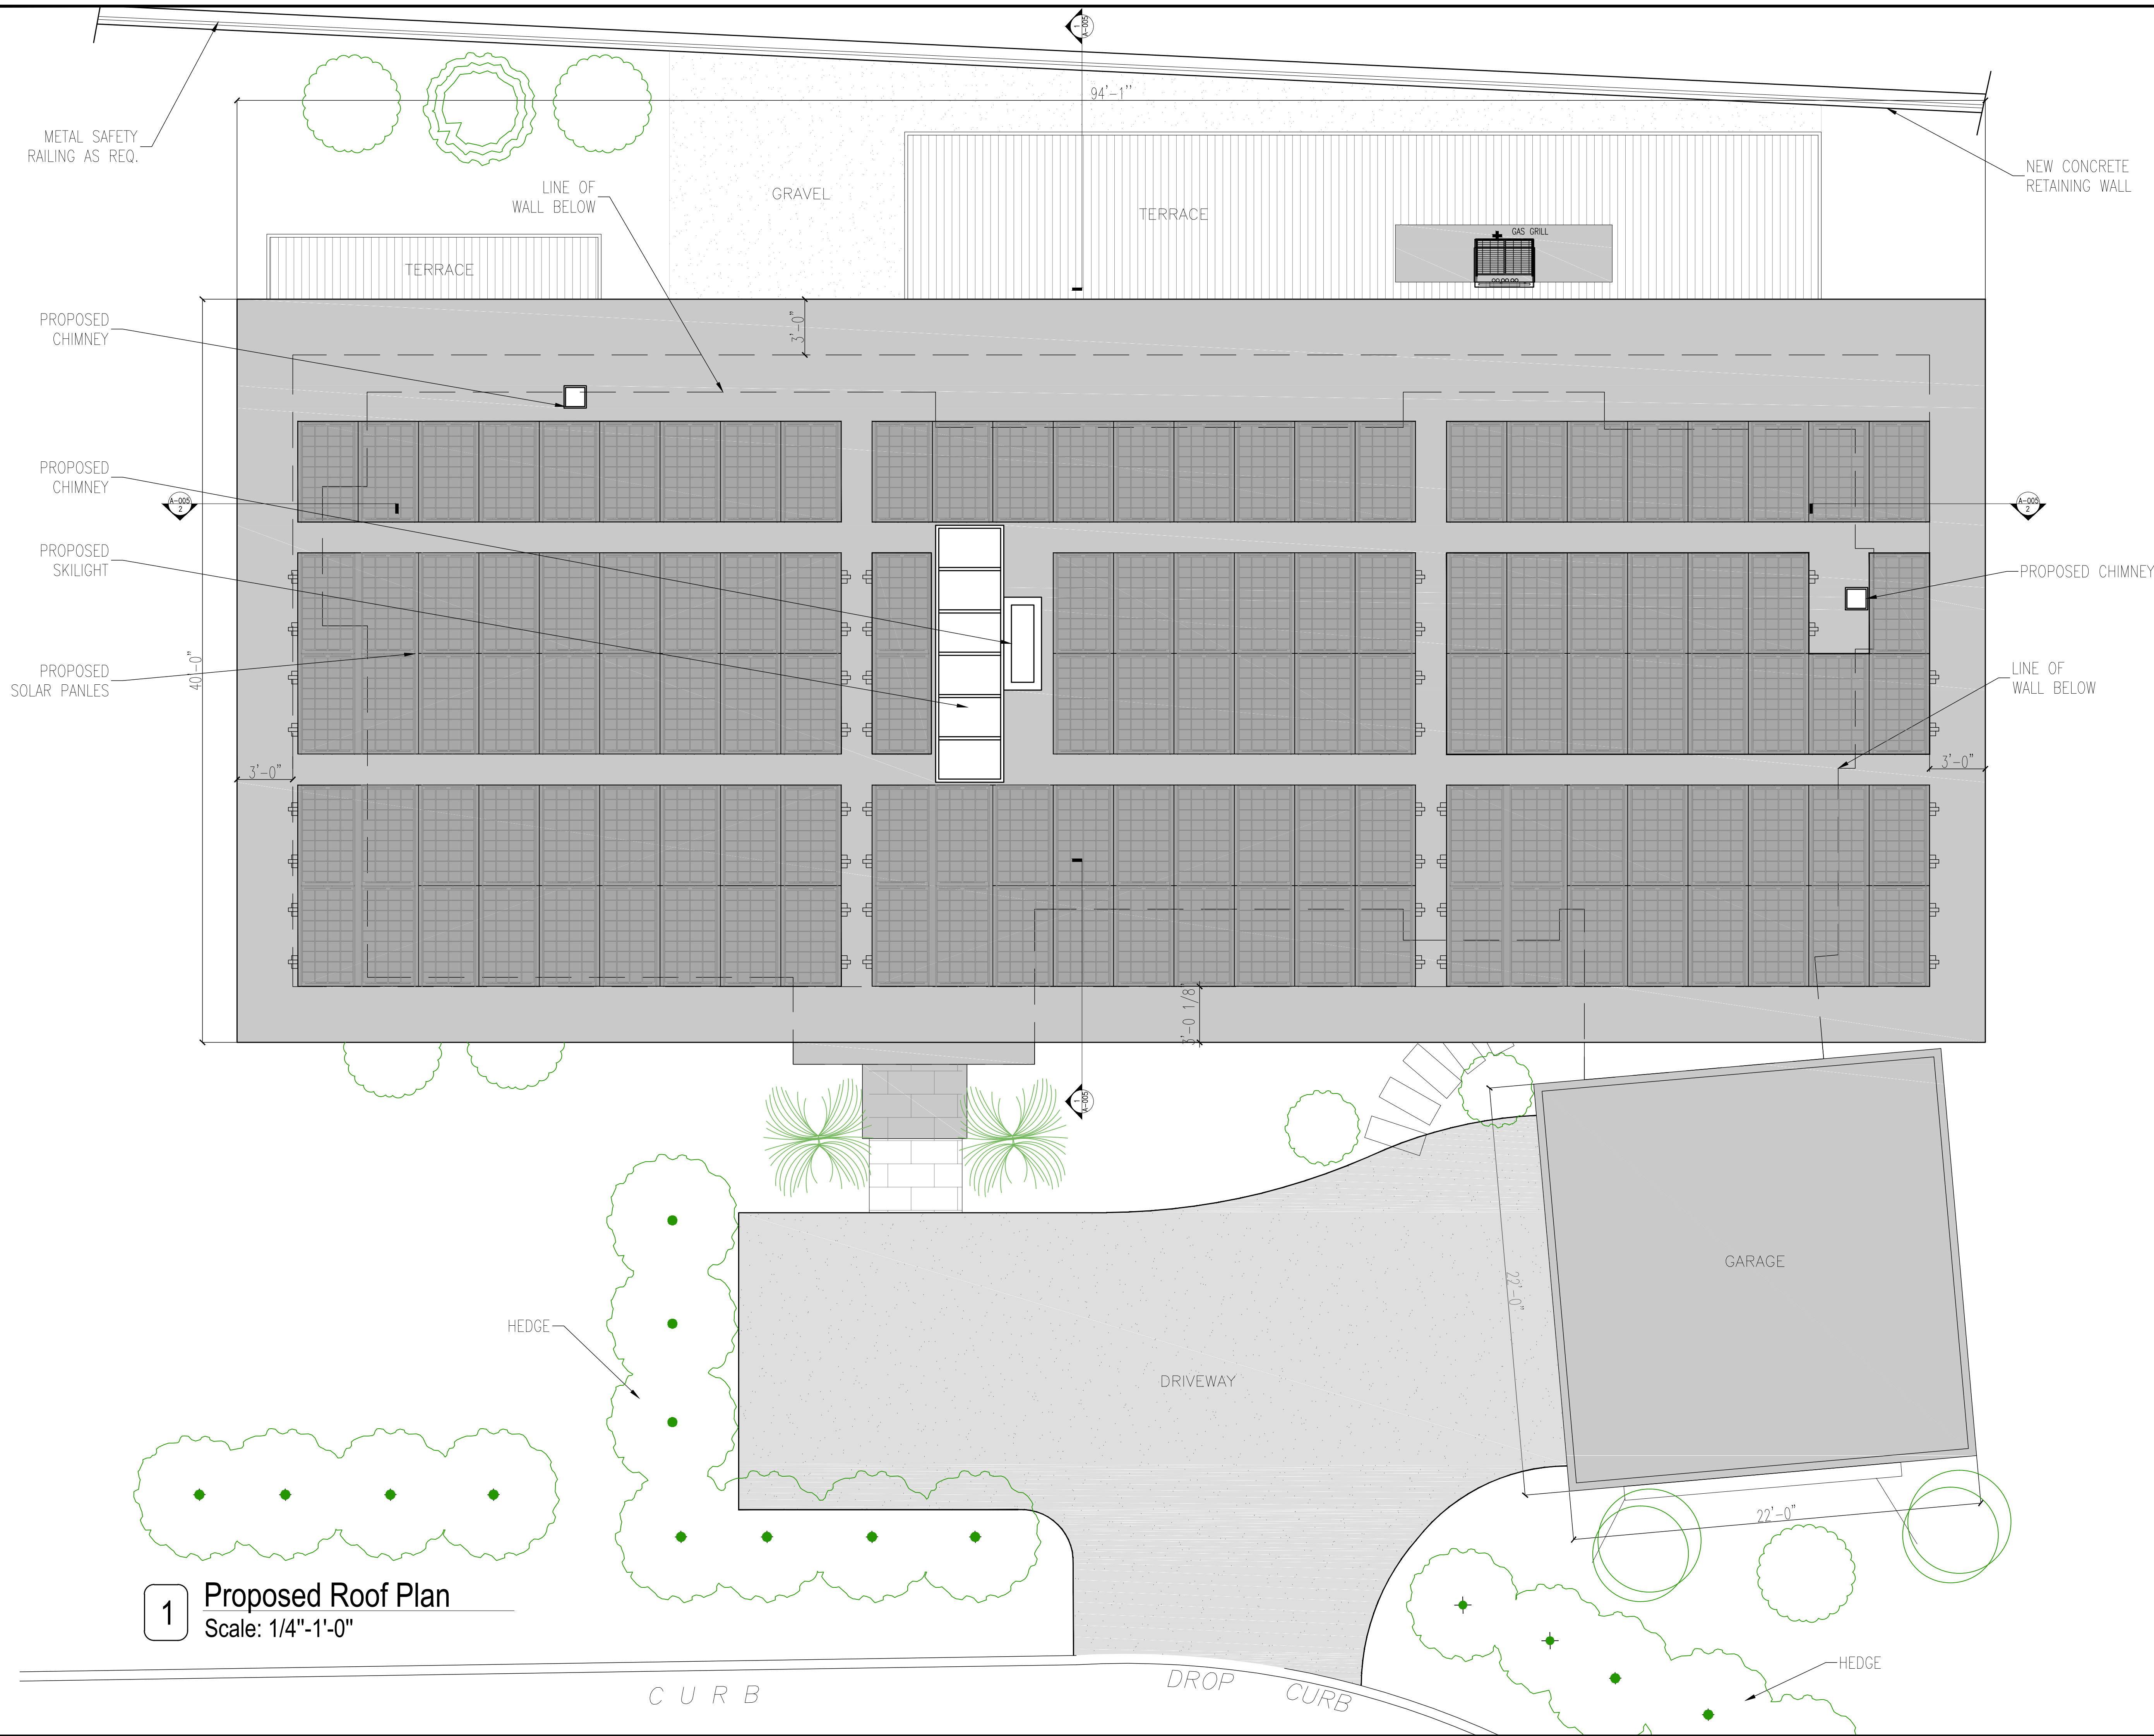

Project Architect:
GS A
GREGORY SHARP ARCHITECT, PC
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DOBBS FERRY
DIRECT 917 597 1982
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OWNER'S REP / PROJECT MANAGER

CASE DEVELOPMENT

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DOBBS FERRY, NY 10522
WWW.CASEDEVELOPMENT.COM
DIRECT 917 597 1982

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LANDSCAPE ARCHITECT


ARBORIST

STRUCTURAL ENGINEER

PROJECT ENGINEER

NOTES

SYMBOL LEGEND	
	Interior Elevation
	See Detail
	Elevation
	Section Cut
	Window Number
	Coordination Tag
	Door Number
	Wall Type
	0.0' Elevation Target
	Revision

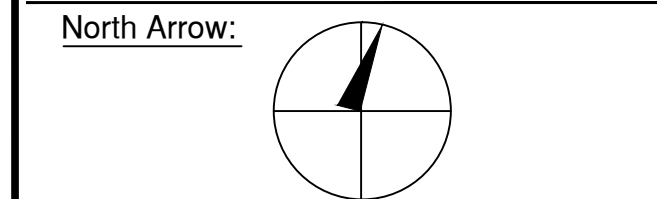

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ISSUED FOR PRE-FILE	2-14-2023
ISSUED FOR AHRB	3-15-2023

D.O.B. No. -


A New House located in
Dobbs Ferry, NY developed by:
The Altshuler Residence

PROJECT:
THE ALTSHULER RESIDENCE
11 FAIRLAWN AVENUE,
DOBBS FERRY, NY 10522

PROPOSED ROOF PLAN

SEAL AND SIGNATURE:	DATE:	3/15/2023
	PROJECT No:	ALTSHULER 2023
	DRAWING BY:	GS
	CHK BY:	
	DWG No:	A-004.00
	CADD No:	


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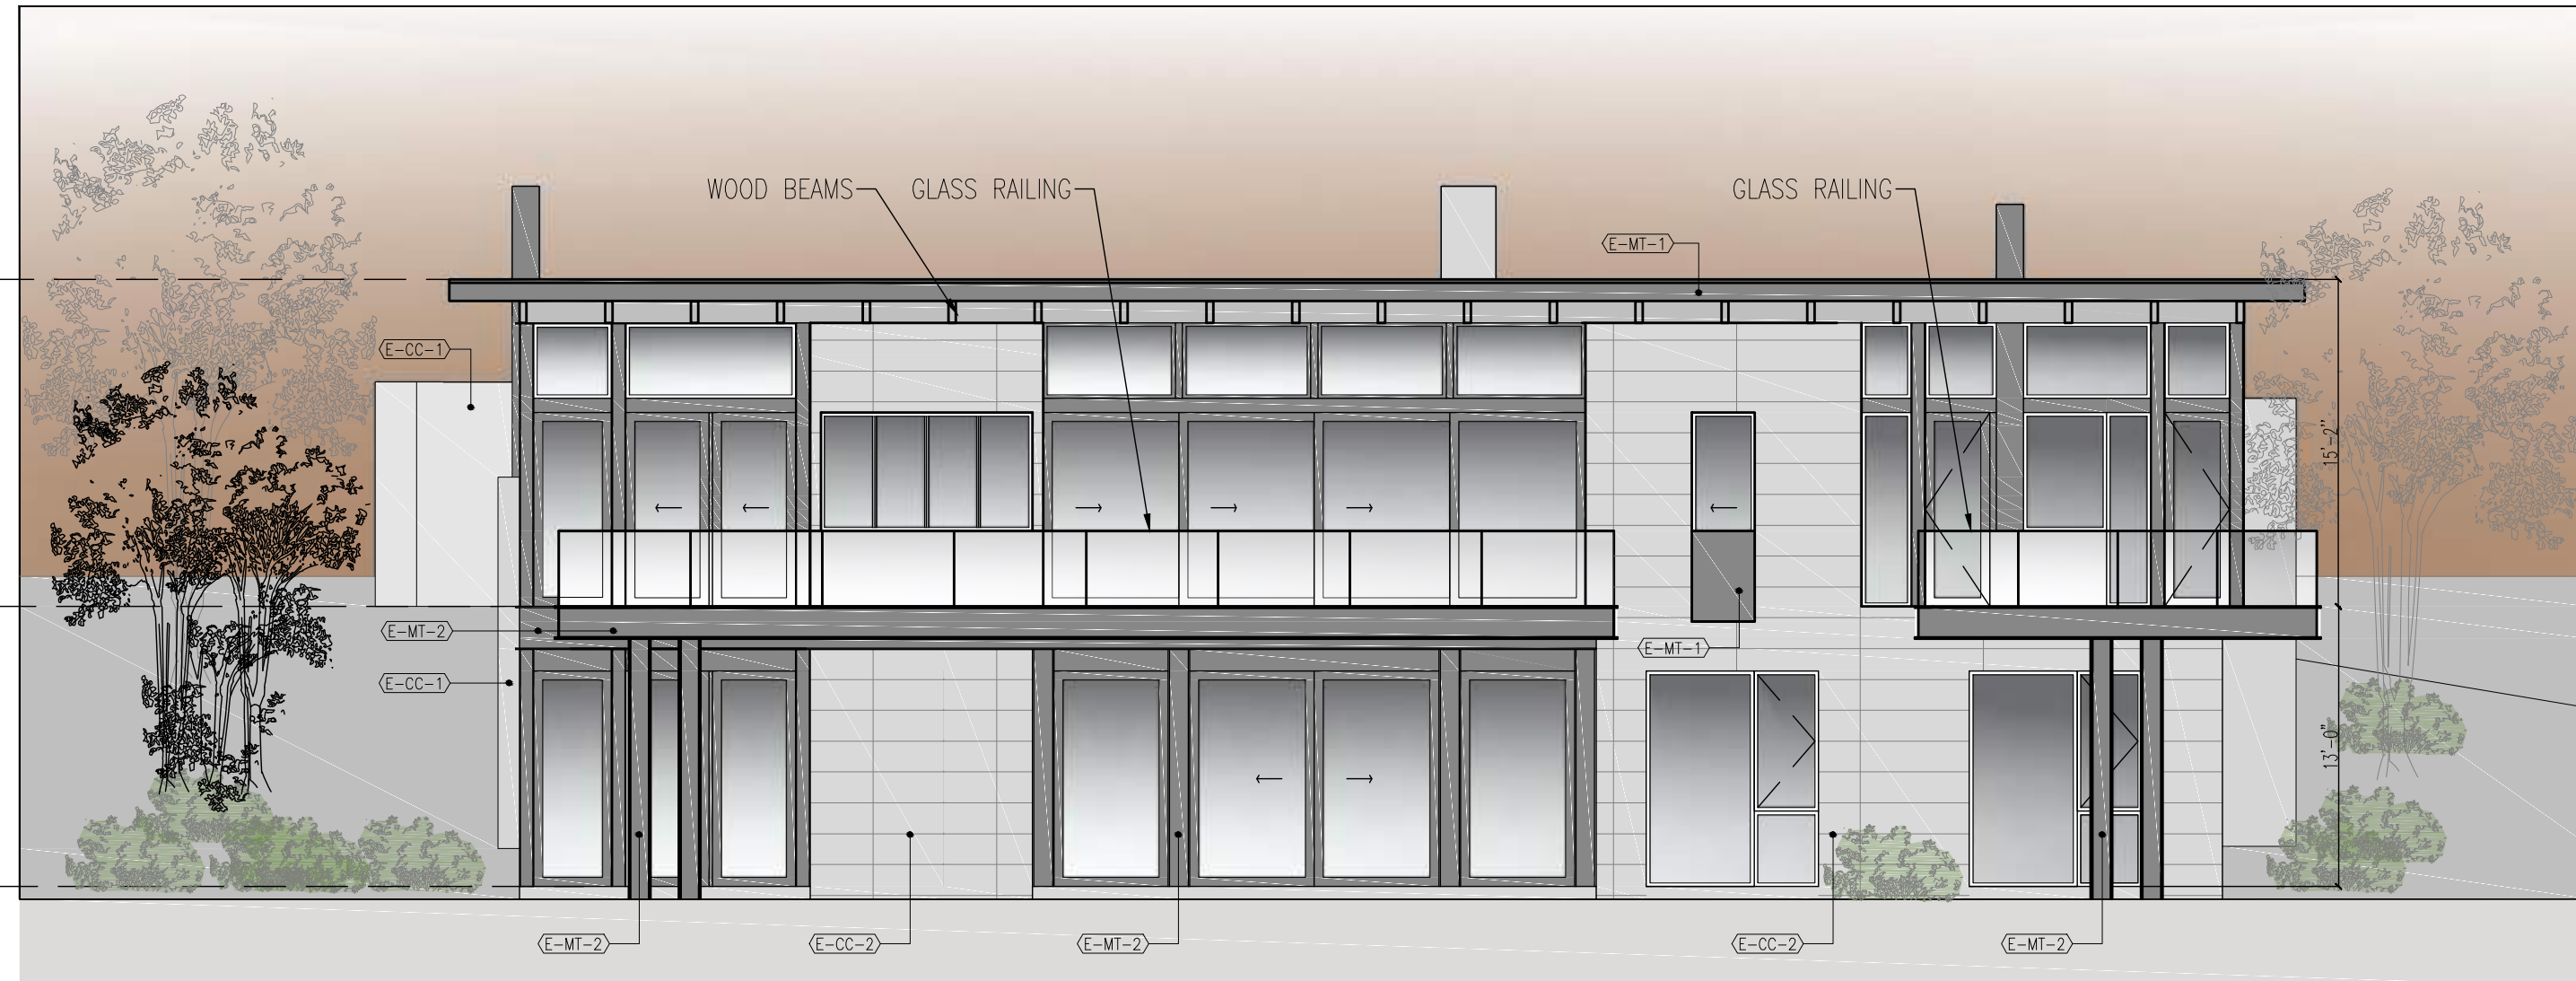
1 Front Elevation
Scale: 1/8"=1'-0"

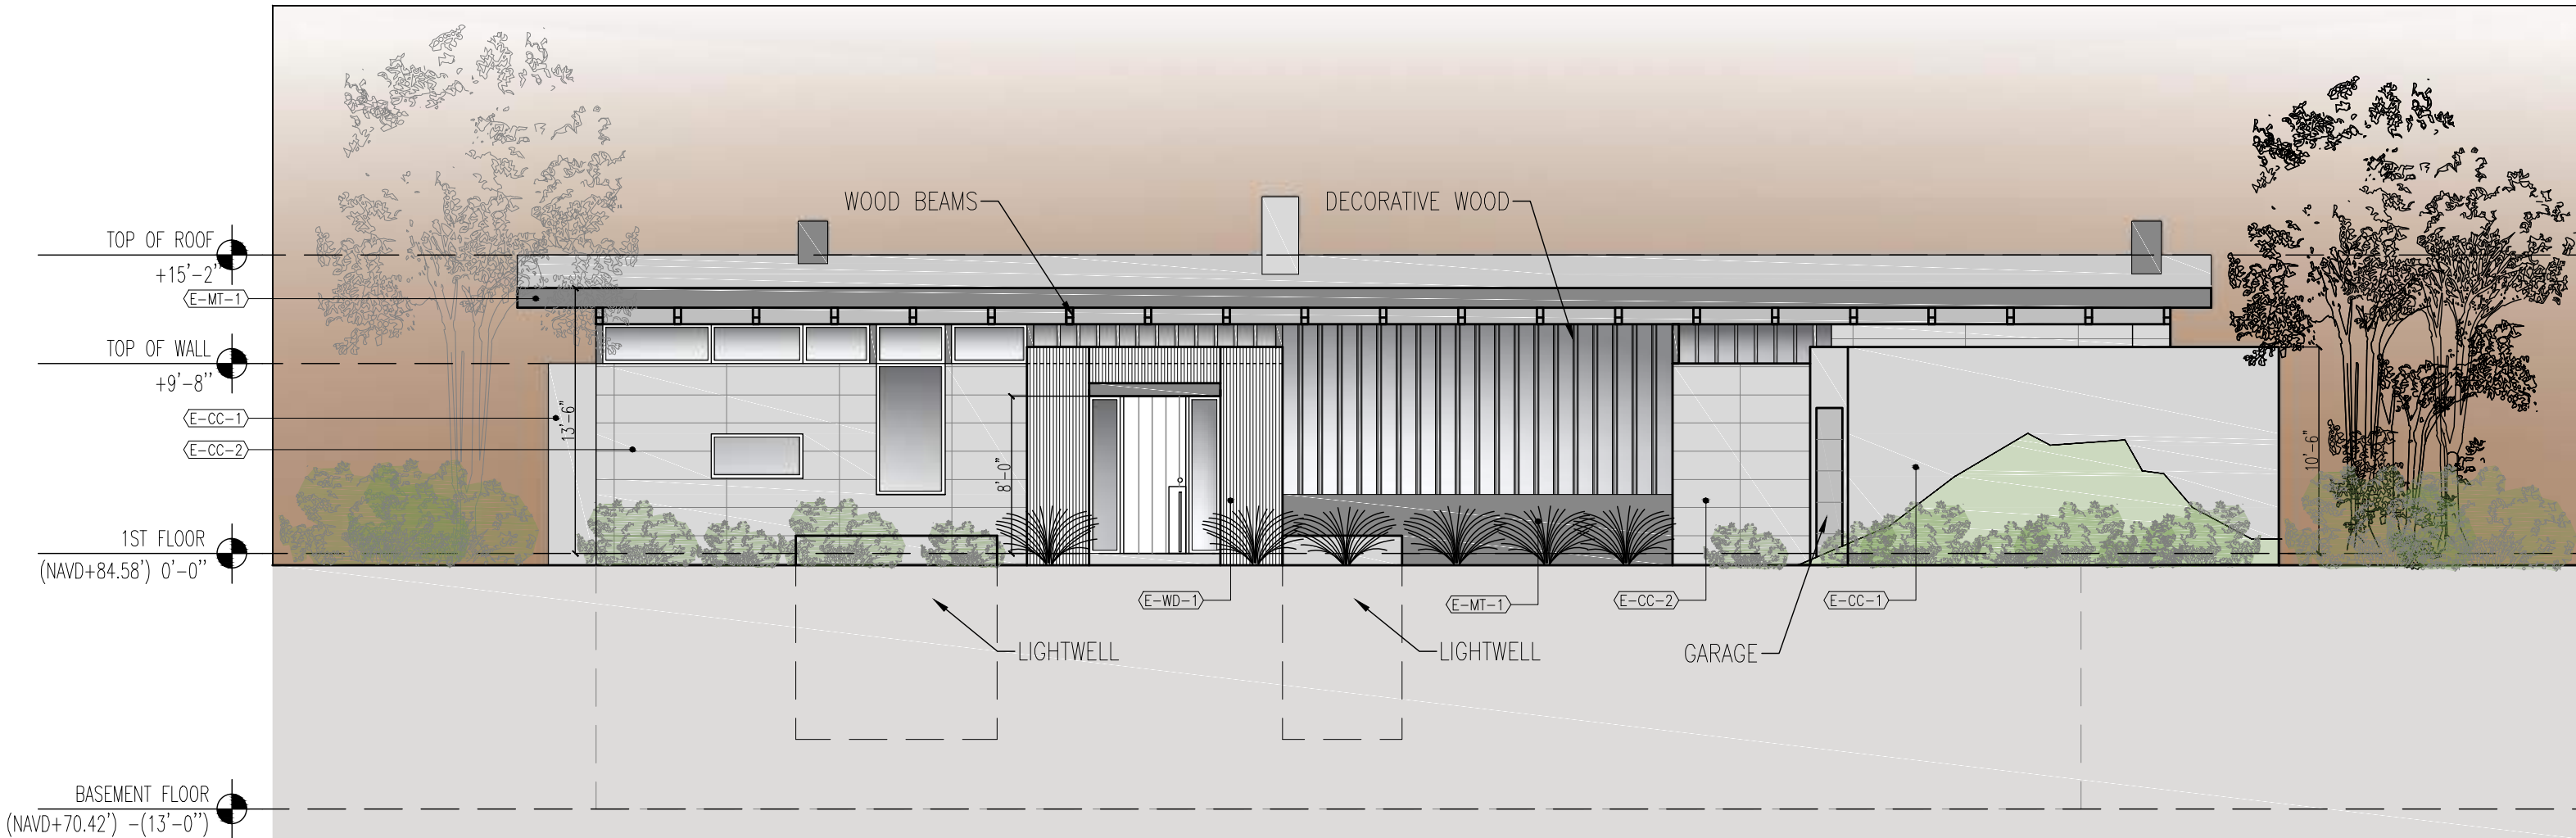


3 Side Elevation
Scale: 1/8"=1'-0"



5 Section 1
Scale: 1/8"=1'-0"

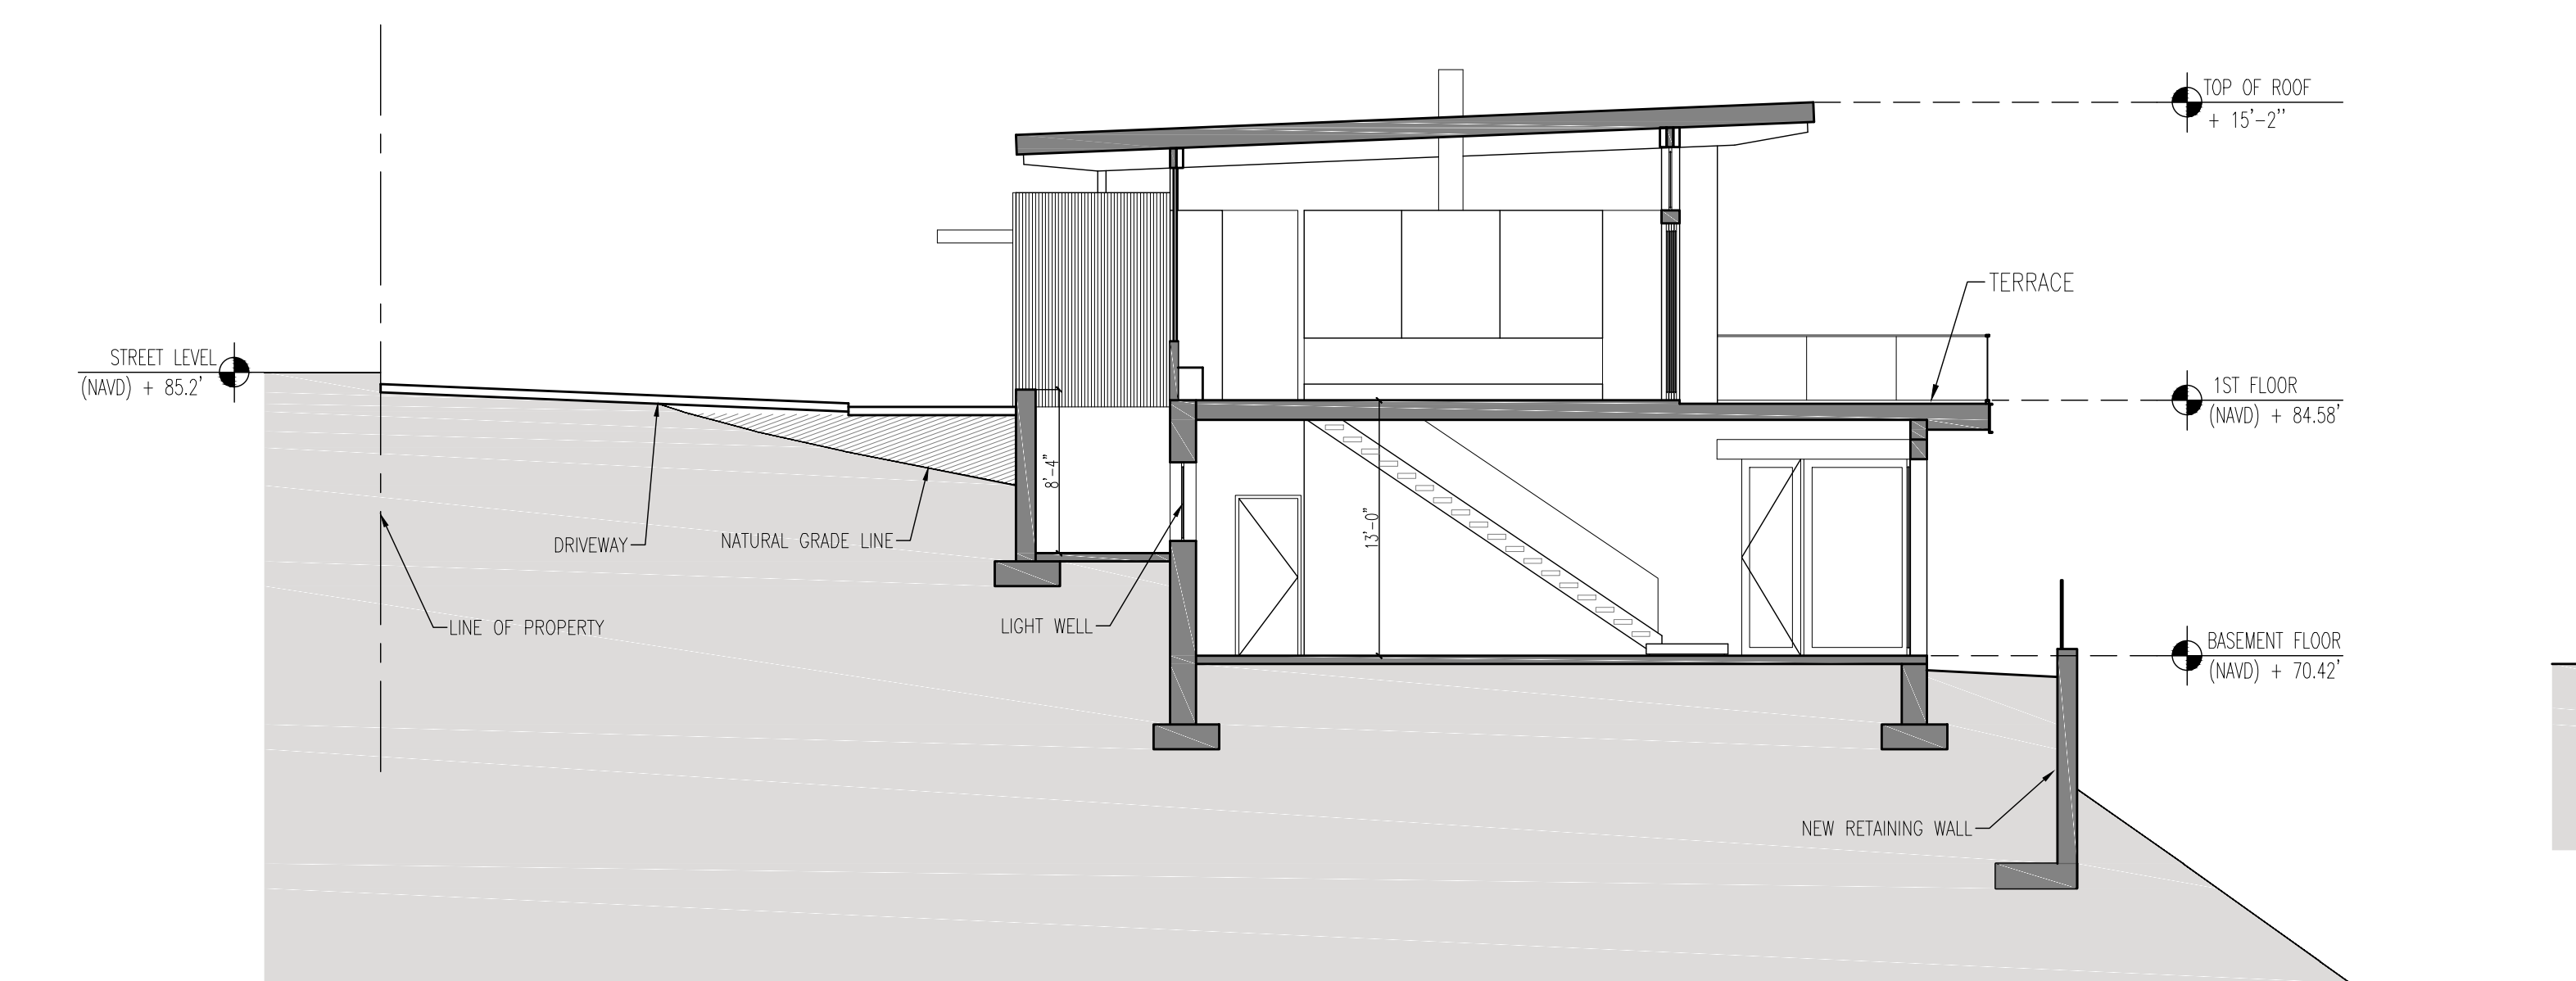

2 Rear Elevation
Scale: 1/8"=1'-0"

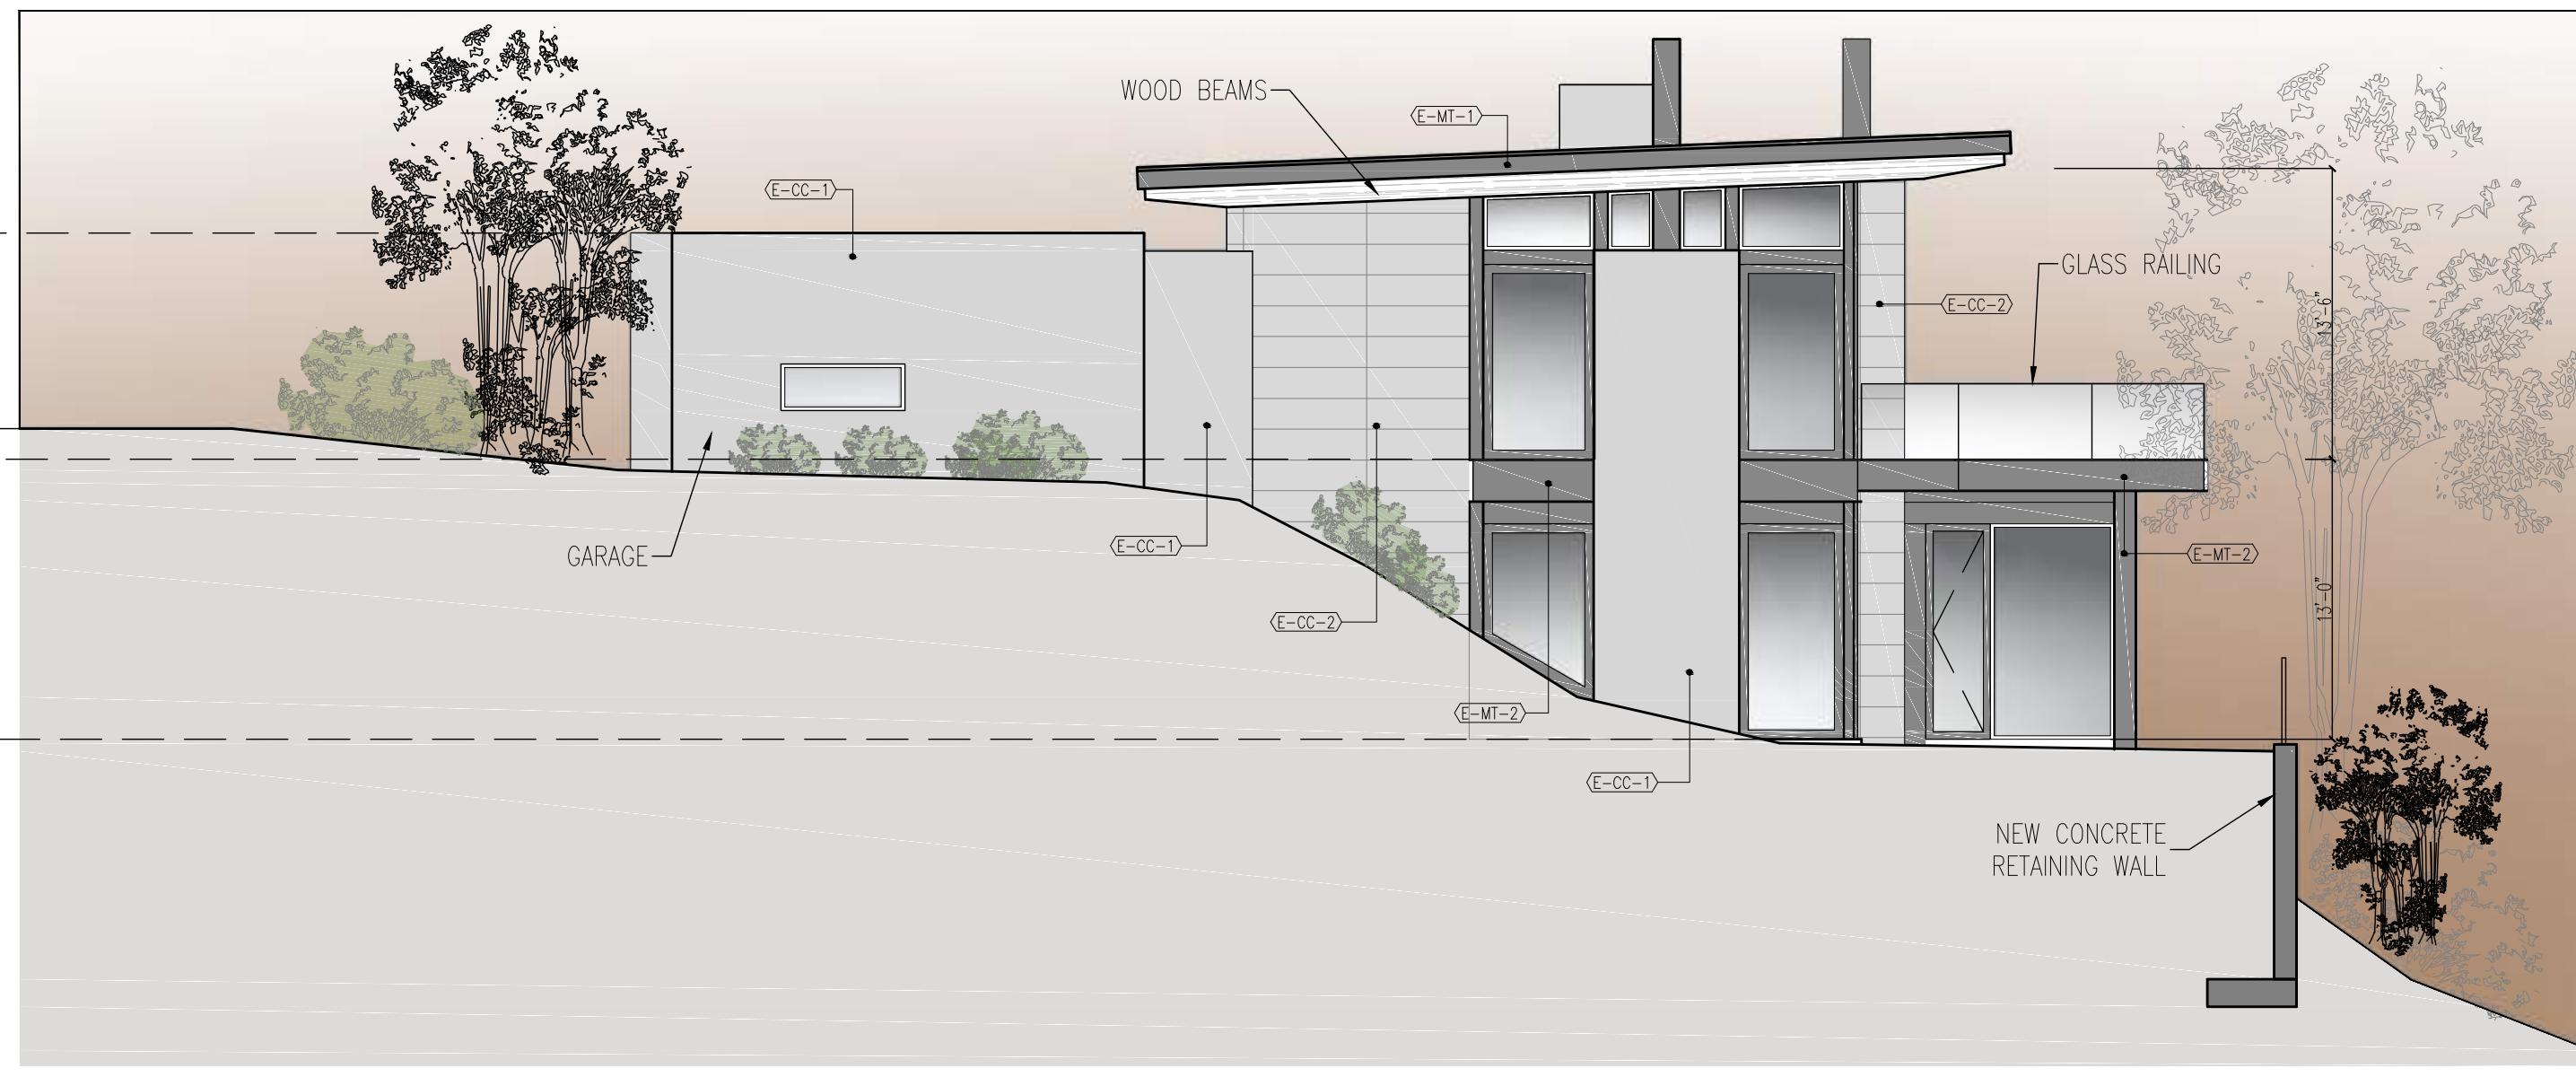

4 Side Elevation
Scale: 1/8"=1'-0"



6 Section 2
Scale: 1/8"=1'-0"

Project Architect:
GS
GREGORY SHARP ARCHITECT, PC
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DOBBS FERRY
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OWNER'S REP / PROJECT MANAGER

CASE DEVELOPMENT

Case Development Inc
145 PALISADE STREET, SUITE 211
DOBBS FERRY, NY 10522
www.casedevelopment.com
DIRECT 917 597 1982

D.O.B CONSULTANT

LANDSCAPE ARCHITECT


ARBORIST

STRUCTURAL ENGINEER

PROJECT ENGINEER

NOTES

SYMBOL LEGEND	
	Interior Elevation
	See Detail
	Elevation
	Section Cut
	Window Number
	Coordination Tag
	Door Number
	Wall Type
	0.0' Elevation Target
	Revision

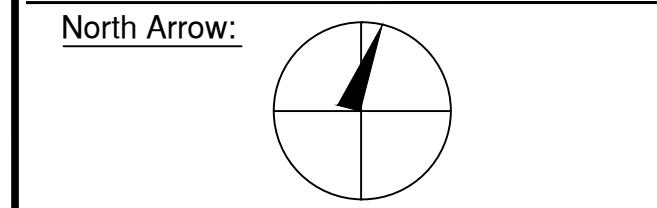

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ISSUED FOR AHRB	3-15-2023

D.O.B. No. -

A New House located in
Dobbs Ferry, NY developed by:
The Altshuler Residence

PROJECT:
THE ALTSHULER RESIDENCE
11 FAIRLAWN AVENUE,
DOBBS FERRY, NY 10522

PROPOSED ELEVATIONS

SEAL AND SIGNATURE: 	DATE: 3/15/2023 PROJECT No: ALTSHULER 2023 DRAWING BY: GS CHK BY: DWG No: A-005.00 CADD No:
-------------------------	-------------------------------------------------------------------------------------------------------------------

BSCAN:



CONCRETE PANEL
RIEDER– OFF WHITE/FERRO LIGHT



DECORATIVE WOOD



E-WD-2



WOOD GARAGE DOOR

E-MT-1



BLACK ALUMINUM FACIA

E-MT-2



STEEL– BLACK FINISH

E-CC-1



GREY STUCCO FINISH

E-CC-2



CONCRETE PANEL –RIEDER–OFF WHITE/FERRO LIGHT

Project Architect:
GSA
GREGORY SHARP ARCHITECT, PC
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www.casedevelopment.com
DIRECT 917 597 1982

D.O.B CONSULTANT

LANDSCAPE ARCHITECT


ARBORIST

STRUCTURAL ENGINEER

PROJECT ENGINEER

NOTES

SYMBOL LEGEND	
	Interior Elevation
	See Detail
	Elevation
	Section Cut
	Window Number
	Coordination Tag
	Door Number
	Wall Type
	0.0' Elevation Target
	Revision

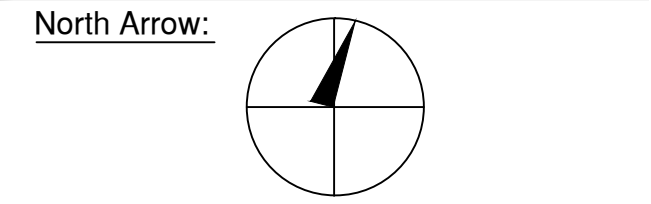

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D.O.B. No. -

A New House located in
Dobbs Ferry, NY developed by:

The Altshuler Residence

PROJECT:
THE ALTSHULER RESIDENCE
11 FAIRLAWN AVENUE,
DOBBS FERRY, NY 10522

PROPOSED ELEVATIONS

SEAL AND SIGNATURE: 	DATE: 3/15/2023 PROJECT No: ALTSHULER 2023 DRAWING BY: GS CHK BY: DWG No: A-005.02 CADD No:
-------------------------	------------------------------------------------------------------------------------------------------------

BSCAN:

BOLD and BRILLIANT. Say YES to YAWAL USA



HIGH PERFORMANCE WINDOWS AND DOORS FEATURING BEST-IN-CLASS QUALITY, TECHNOLOGY, ENERGY EFFICIENCY AND CONTEMPORARY DESIGN

Say YES to the YAWAL USA Steel View WINDOWS

The Steel View system window brings together, steel look, performance and narrow sirteline that allows you to enjoy more of the view and natural light that comes with it. Steel View is a modern window system that's perfect for many applications including both new constructions and retrofit.

The Steel View window uses innovative technology to meet and exceed standards and guidelines, thanks to the ultra-thin profiles used to build the system, you have virtually unlimited contact with nature. Multiple glass options are available to meet the designer/end user's aesthetic appeal, and our full range of custom frame finishes make Steel View a great choice for architects, builders, dealers and consumers. Operable window Steel View is available in sizes up to 5 feet wide, up to 10 feet high, while the fixed version is unlimited by size restrictions.



yawalusa.com

ALUMINUM + ARCHITECTURE

STEEL VIEW WINDOW SIGNIFICANT BENEFITS


+ More natural light, jumbo capability	+ Meets and Exceeds the most rigorous energy codes and guidelines
+ Will reduce building Energy costs	+ A sustainable choice: environmentally focused
+ Superior U-Value range of 0.13	+ Fully tested and Warranted
+ Narrow sirteline allowing more of light and view	+ Easy to order, procure and install
+ Endless Design Options included Steel look, custom frame finishes, glass choices, shapes and sizes	

STEEL VIEW WINDOW WITH THERMAL INSULATION

ONE SYSTEM THREE DIFFERENT STYLES



CONFIGURATIONS POSSIBILITIES:

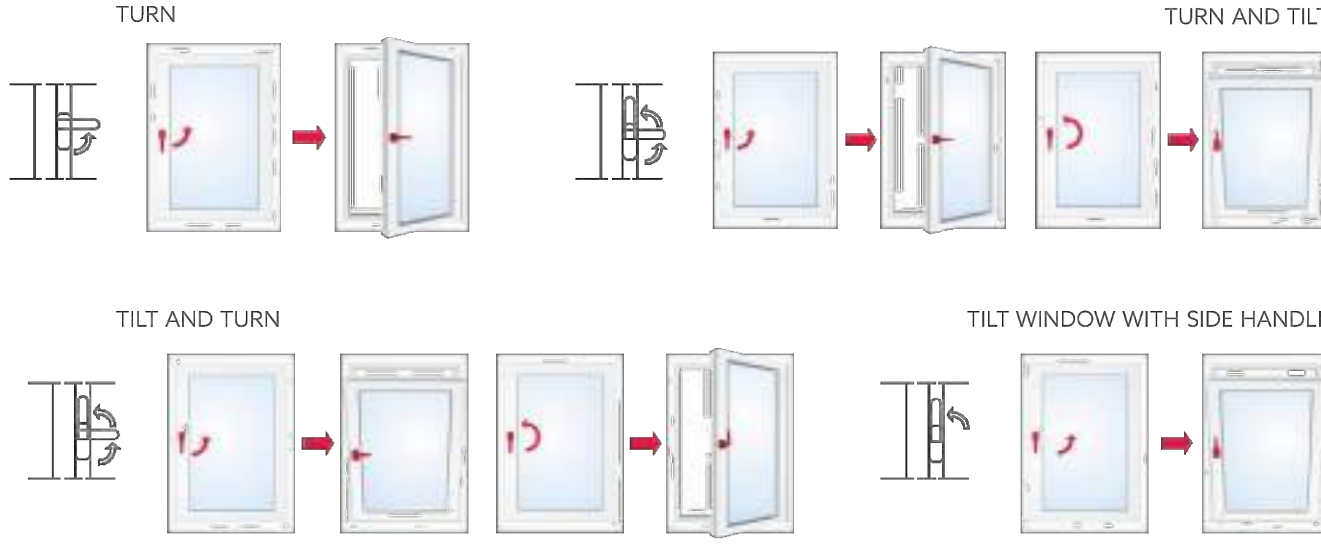

TECHNICAL SPECIFICATIONS - STEEL VIEW WINDOW

U-Value	0.13
Acoustic insulation	STC 39-44 dB
Water tightness	16 psf
Design pressure	AW PG 65
SHGC	0.20-0.48

YAWAL USA - 11 West Hudson Ave. Englewood, NJ 07631, USA
T: +1 (551) 250 3614, office@yawalusa.com, www.yawalusa.com

On.:
7

Constructions:

Pos. 7
#007 TV Room
Fixed unit
System: TM 77 / Pano
Size: B = 5ft 4in, H = 10ft 0in
Weight = 507,9 lbs
Thermal Calculation:
U = 0.14 BTU/ht*2 F
SHGC = 0.28

Quantity:


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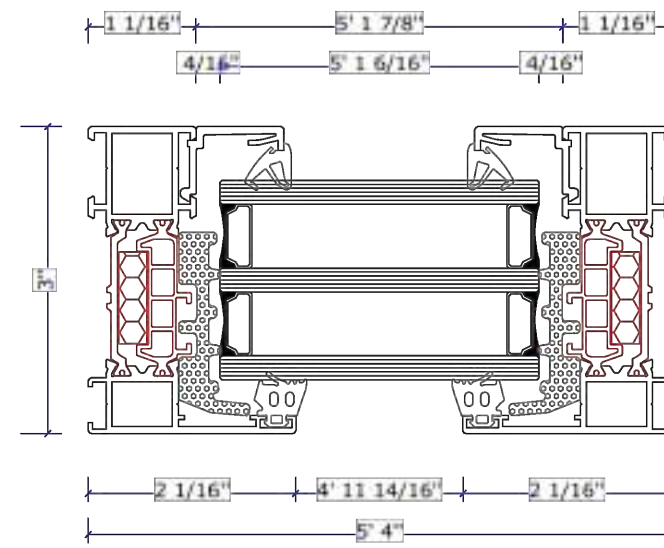
Profiles colour:RAL5803A 9005 0A00
Hardware colour:Attached Spec
Fillings:6T/16/6T/16/6T SHGC 0.31 LT 68%

View:

View from the outside



FACTORY ASSEMBLED
UNGLAZED

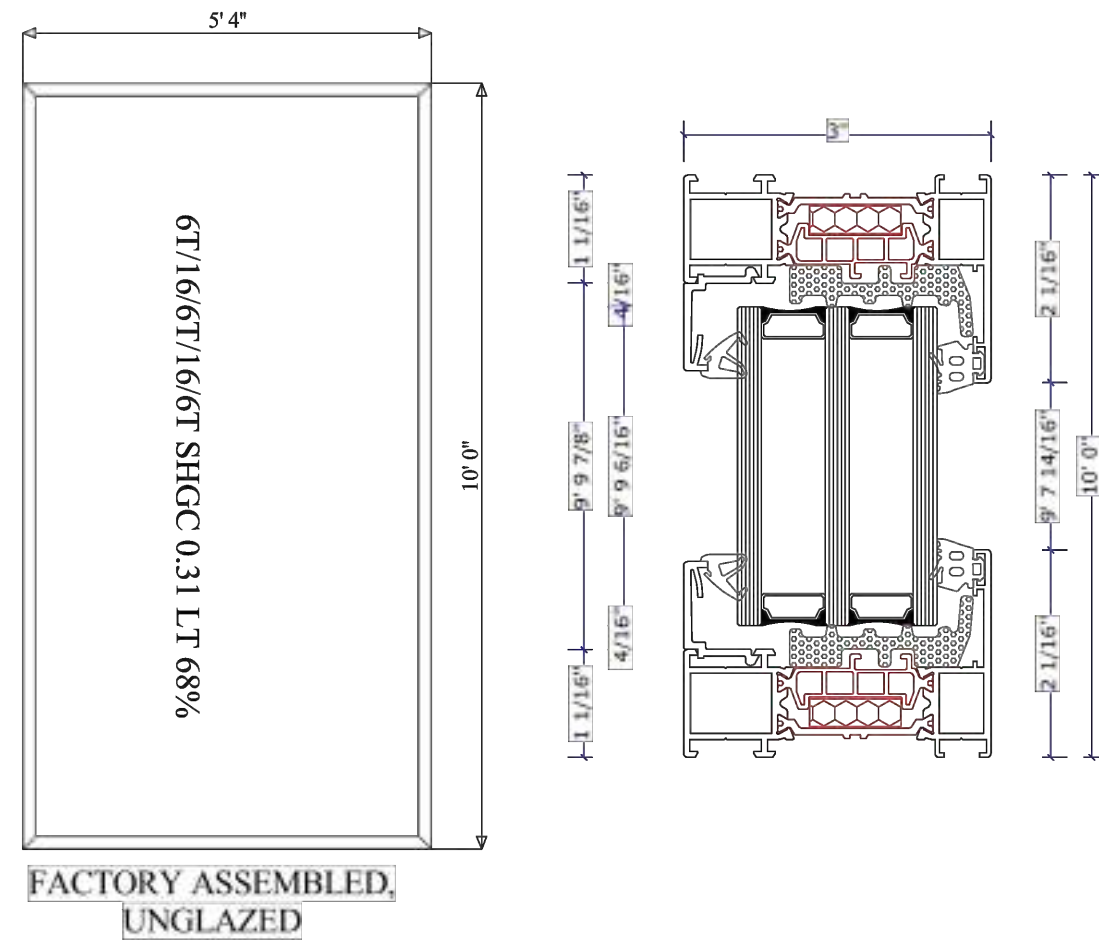

7 (45)

2023-02-16

1 Windows- Details Scale: ns

On.:
6

Constructions:

Pos. 6
#006 TV Room
Outswing door + fixed unit
System: TM 77 / Pano
Size: B = 9ft 0in, H = 10ft 0in
Weight = 854,4 lbs
Thermal Calculation:
U = 0.15 BTU/ht*2 F
SHGC = 0.26

Quantity:



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Description:

Profiles colour:RAL5803A 9005 0A00
Hardware colour:Attached Spec
Fillings:6T/16/6T/16/6T SHGC 0.31 LT 68%

View:

View from the outside

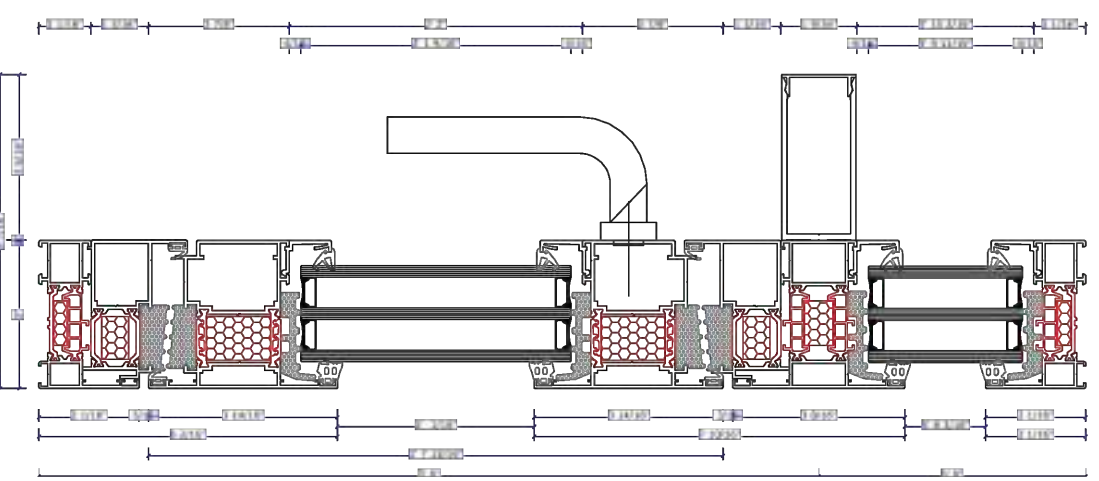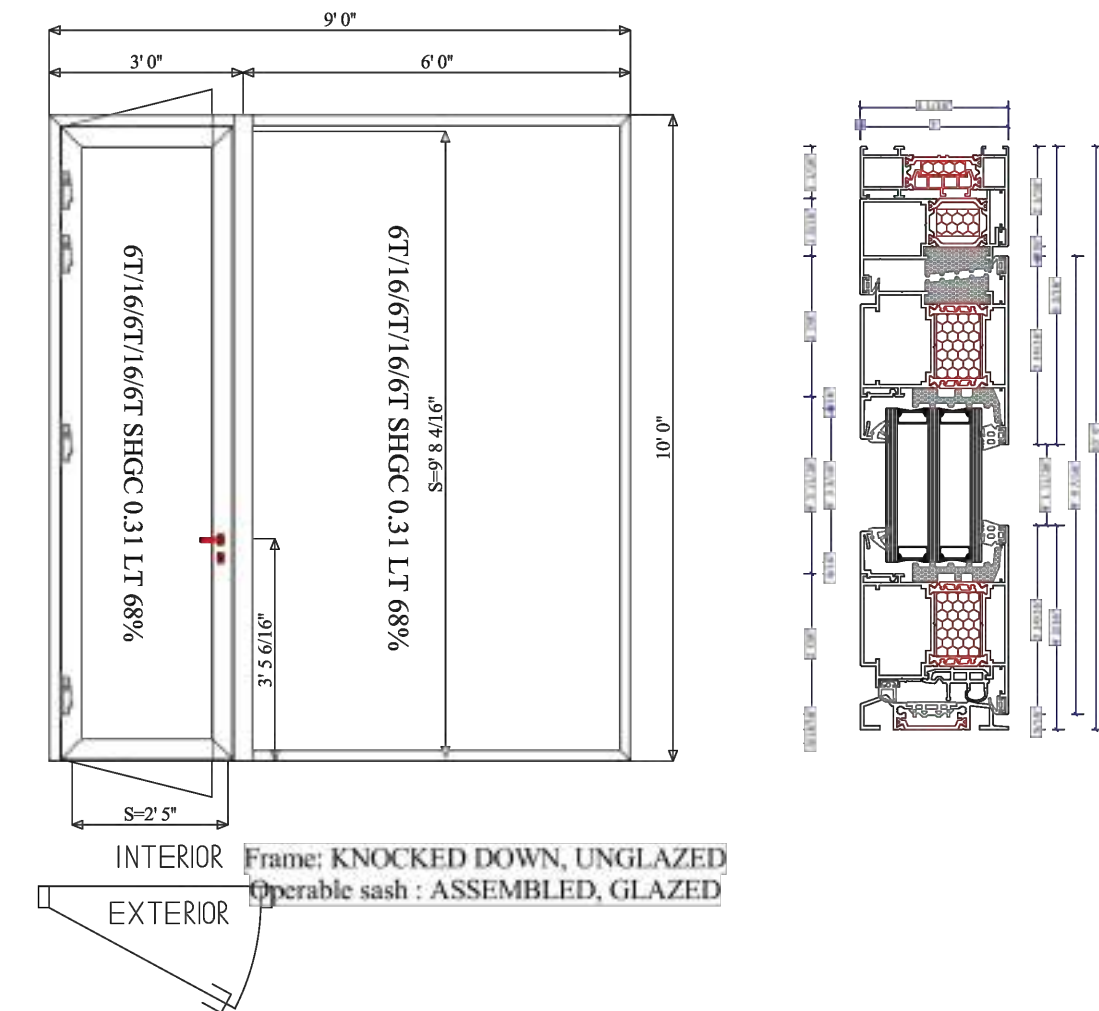

6 (45)

2023-02-16

2 Doors- Details Scale: ns

MICRO NITE™/STYLE C TWIN STAFF STAR™

"Micro Nite™ Twin Staff Star™ Style C's rotational control is second to none because it can be aimed along two axes perched atop a T stem. This unassuming fixture has the potential to illuminate ground level, landscaping features as well serve as an upward facing flood when equipped with its appropriate B style caps."

Karen Duffy, LC, B-K Lighting, Regional Sales Manager/BKU Instructor



B-K LIGHTING PATH / AREA



4" ROUND DEEP DOWNLIGHT WILDLIFE FRIENDLY

UNIVERSAL HOUSINGS WITH INTERCHANGEABLE TRIMS

Spectrum's Enduro 4" recessed round downlight series features a firm and variety of options for accent and general illumination.

PART NUMBER	LUMENS	BEAMS LUMENS	DELIVERED LUMENS	SYSTEM WATTS	LPW
RD04F	1000	800	800	16	25
RD04F	1000	800	800	16	25

AVAILABLE HOUSING TYPES



FIXTURE HOUSING SPECIFICATION

SERIES	LUMENS	DRIVER / DIMMING / VOLTAGE	OPTIONS	MOUNTING
RD04F	1000	16.0 120V	11 120V	11 120V
RD04R	1000	16.0 120V	11 120V	11 120V

AVAILABLE TRIM / MODULE TYPES



TRIM / MODULE SPECIFICATION

TRIM	CCT	FINISH	FLANGE FINISH	LENS*	OPTIONS
RD04F	Downlight	AWH	White	11 120V	11 120V
RD04R	Downlight	AWH	White	11 120V	11 120V

EXAMPLE: SRM0TASLDS2W1/H12/RDD4FAMCHWFO

EXAMPLE: SRM0TASLDS2W1/H12/RDD4FAMCHWFO

* 1 Natural Source Lumens * 2 Normal Delivered Lumens * 3 Specify with 1A Only * 4 Specify with 1D Only * 5 Dual Circuit Option Requires Dedicated on the Controls by Others, Controls by Others Are Not Allowed * 6 Lens is Required for All Applications * 7 Consult Factory for More Information * 8 Consult Factory for More Information * 9 Lens is Required * 10 Standard Lens

Dimensions and values shown are nominal. Spectrum Lighting continually works to improve products and reserves the right to make changes which may affect the performance or appearance of products.



WWW.SPECLIGHT.COM • 994 JEFFERSON STREET, FALL RIVER, MA 02721 • 508.678.2303 FAX 508.678.2260

83-70912-3A

3 Exterior Lights- Specs Scale: ns

Project Architect:

GS
GREGORY SHARP ARCHITECT, PC
145 PALISADE STREET, SUITE 211
DOBBS FERRY
DIRECT 917 597 1982
INFO@CASEDEVELOPMENT.COM

OWNER'S REP / PROJECT MANAGER

CASE DEVELOPMENT

Case Development Inc
145 PALISADE STREET, SUITE 211
DOBBS FERRY, NY 10522
www.casedevelopment.com
DIRECT 917 597 1982

D.O.B CONSULTANT

LANDSCAPE ARCHITECT

ARBORIST

STRUCTURAL ENGINEER


PROJECT ENGINEER

NOTES

SYMBOL LEGEND

1/2	See Detail	1/2	Interior Elevation
1/2	Elevation	1/2	Coordination Tag
1/2	Section Cut	1/2	Door Number
1/2	Window Number	1/2	Wall Type
1/2		1/2	Elevation Target
1/2		1/2	Revision

North Arrow:

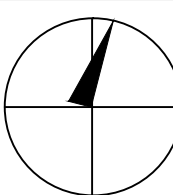

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DRAWING INFORMATION

ISSUED FOR PRE-FILE	12-8-2022
ISSUED FOR PRE-FILE	1-24-2023
ISSUED FOR PRE-FILE	2-14-2023
ISSUED FOR AHRB	3-15-2023

D.O.B. No. -

A New House located in
Dobbs Ferry, NY developed by:

The Altshuler Residence

PROJECT:

THE ALTSHULER RESIDENCE
11 FAIRLAWN AVENUE,
DOBBS FERRY, NY 10522

SPECIFICATIONS

SEAL AND SIGNATURE:



DATE: 3/15/2023

PROJECT No: ALTSHULER 2023

DRAWING BY: GS


CHECK BY:

DWG No:

A-005.03

CADD No:

BSCAN:

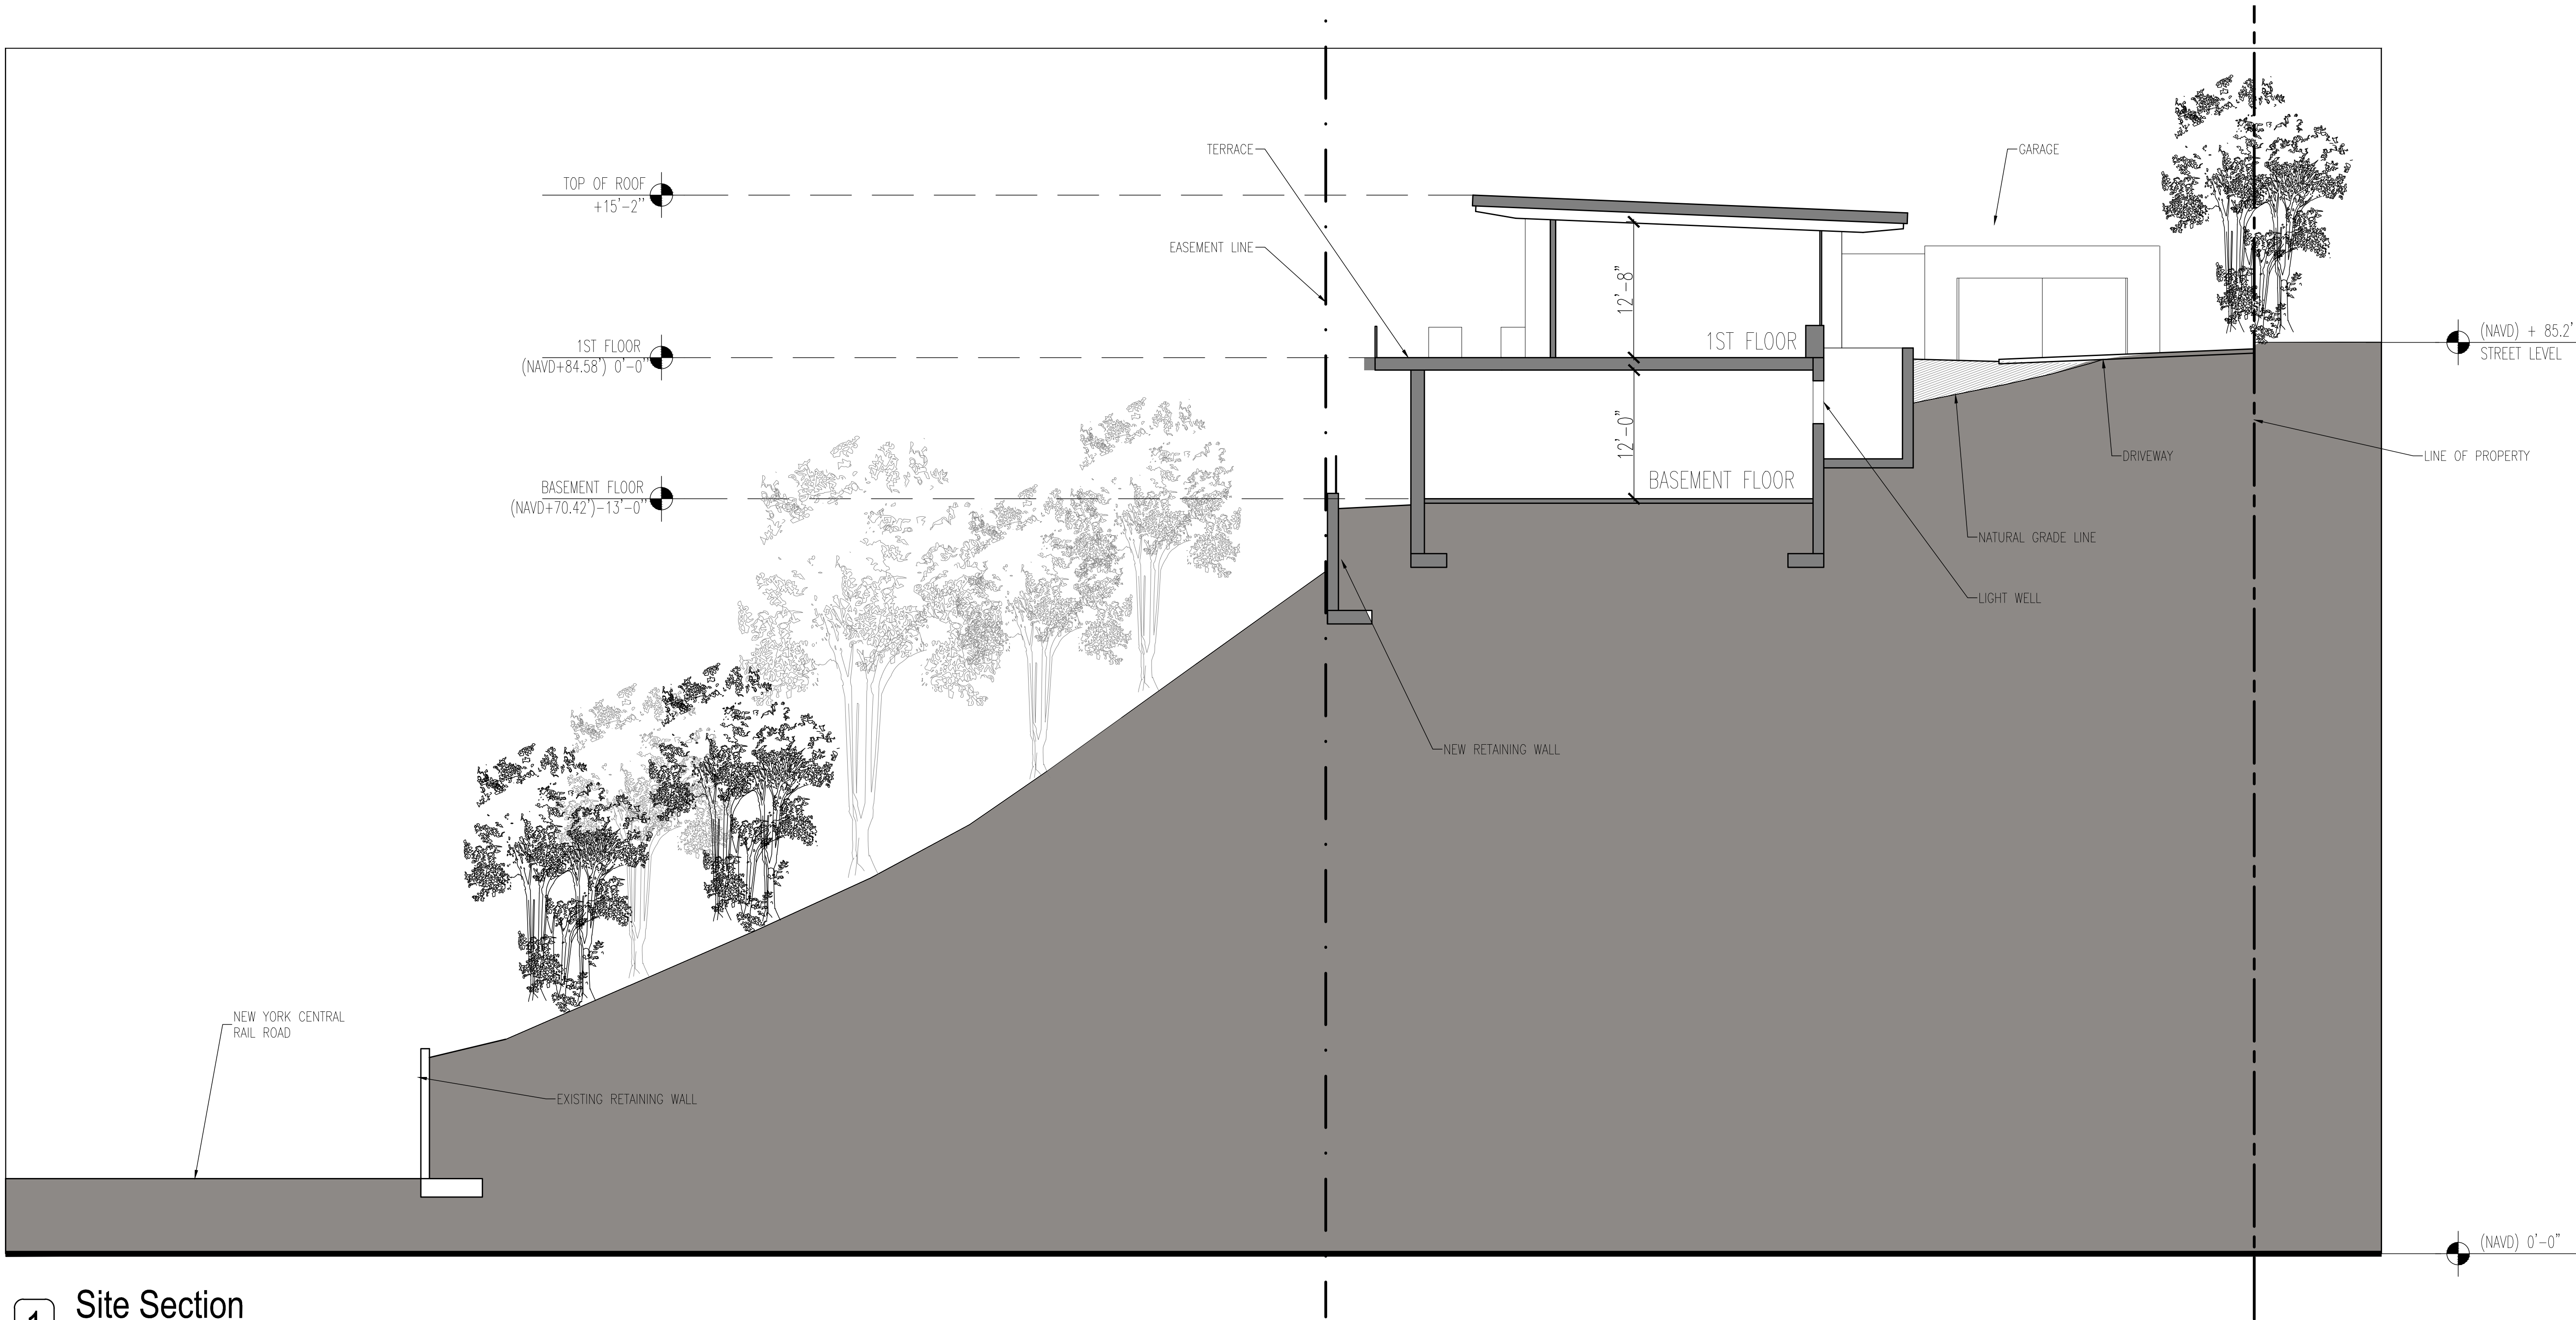

1 Site Section
Scale: 1/8"=1'-0"

Project Architect:

GSA
GREGORY SHARP ARCHITECT, PC
145 PALISADE STREET, SUITE 211
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LANDSCAPE ARCHITECT

ARBORIST

STRUCTURAL ENGINEER


PROJECT ENGINEER

NOTES

SYMBOL LEGEND

	Interior Elevation
	See Detail
	Elevation
	Section Cut
	Window Number
	Coordination Tag
	Door Number
	Wall Type
	0.0' Elevation Target
	Revision

North Arrow:

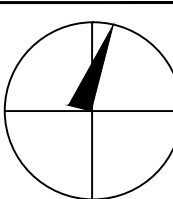

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DOBBS FERRY, NY 10522

**SITE SECTION
FRONT ELEVATIONS**

SEAL AND SIGNATURE:



DATE: 3/15/2023

PROJECT No: ALTSHULER 2023

DRAWING BY: GS

CHK BY:

DWG No:

A-006.00

CADD No:

BSCAN:



1 Front View



2 Side View



3 Side View



4 Rear View

Project Architect:

GSA
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LANDSCAPE ARCHITECT







ARBORIST

STRUCTURAL ENGINEER


PROJECT ENGINEER

NOTES

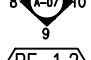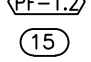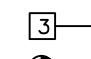SYMBOL LEGEND

 Interior Elevation
 Coordination Tag
 Door Number
 Wall Type
 Elevation Target
 Revision

North Arrow:

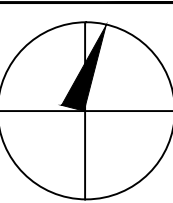

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
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DOBBS FERRY, NY 10522

PERSPECTIVES

SEAL AND SIGNATURE:	DATE: 3/15/2023
	PROJECT No: ALTSHULER 2023
	DRAWING BY: GS
	CHK BY:
	DWG No: A-007.00
CADD No:	

BSCAN:



Project Architect:



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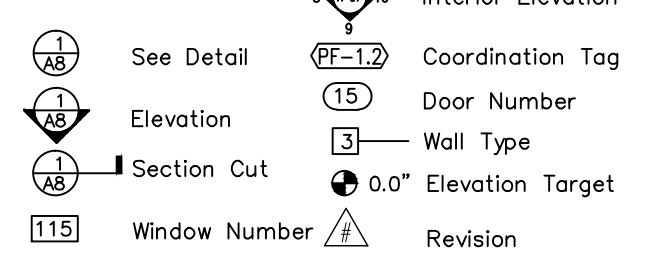
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STRUCTURAL ENGINEER


PROJECT ENGINEER

NOTES

SYMBOL LEGEND



North Arrow:

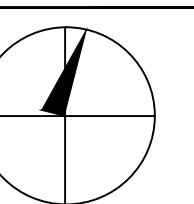

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DOBBS FERRY, NY 10522

PERSPECTIVES

SEAL AND SIGNATURE: _____



DATE: 3/15/2023

PROJECT No: ALTSHULER 2023

DRAWING BY: GS

CHK BY: _____
MGC No: _____

WG No:

A-008 00

A-000.00

BSCAN: