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April 14, 2022

Honorable Mayor Vincent Rossillo and Members of the Board of Trustees Village of Dobbs Ferry 112 Main Street Dobbs Ferry, New York 10522

Re: Mercy College

Amended Site Plan Application

555 Broadway, Dobbs Ferry, New York

Dear Hon. Mayor Rossillo and Members of the Board of Trustees:

This firm represents Mercy College ("Mercy") in connection with its amended site plan application for the construction of a permanent open-aired pavilion in The Grove area of the campus (where a large temporary tent has been installed during the COVID-19 pandemic) and upgrades to the R-Lot, consisting of full depth reconstruction of the existing parking lot with no increase in footprint or impervious site area, together with installation of new energy-efficient LED lighting and drainage improvements in the upper lot (collectively the "Proposed Project"). We are pleased to present the Proposed Project, which is described in greater detail in the enclosed documentation, for your review and consideration.

The Mercy property is located in the Educational/Institutional (EI) Zoning District on the Village of Dobbs Ferry Zoning Map, in which educational uses (including institutions of higher learning such as Mercy) are principal permitted uses. As you may recall, as a condition of the approvals for Hudson Hall, Mercy was required to work with the NYDOT on improvements to the main entrance to the College on Route 9, including a new right-only turning lane out of the campus. We are pleased to report that this project has finally received all necessary NYDOT approvals and Mercy is bidding the project for construction this summer. In conjunction with the Route 9 improvements, Mercy will also be undertaking a major landscaping and signage upgrade project at the entrance to the College, the vast majority of which is located in the Village of Irvington.¹

¹ Mercy will be simultaneously submitting an application to the Irvington Planning Board for amended site plan approval for the entrance project. We have confirmed with Dobbs Ferry Building Inspector Dan Roemer that no approvals are required from Dobbs Ferry in connection with the entry work.

With respect to the purposes and standards of the Dobbs Ferry Zoning Code, it is respectfully submitted that the Proposed Project complies with the applicable standards set forth in Sec. 300-52(D) of the Zoning Code, as follows:

- 1. As shown on the site plan, the Proposed Project, to the maximum extent practicable, avoids environmentally sensitive areas and features, including rock outcrops, steep slopes and highly erodible soils. To the extent such environmentally sensitive features are present and will be altered or otherwise affected by the Proposed Project, an erosion and sediment control plan has been provided in the site plan set and is subject to approval by the Board of Trustees. The erosion and sediment control plan has been prepared by a NYS licensed professional engineer, and is consistent with the provisions of the New York State Department of Environmental Conservation Manual for Erosion and Sediment Control, as amended from time to time.
- 2. As set forth in detail in the enclosed site plans and as will be addressed in a Stormwater Pollution Prevention Plan ("SWPPP"), the siting of the Proposed Project includes adequate storm water and surface water drainage facilities on site to ensure no net increase in stormwater runoff from the site as a result of the Proposed Project. Roof leaders, catch basins, etc. will be directed to appropriate drainage control structures on site and specifically will not be directed uncontrolled to Village streets or adjacent properties.
- 3. As set forth on the enclosed site plans, the siting of the Proposed Project provides for adequate screening and minimizes noise and lighting impacts upon surrounding property owners.
- 4. The siting of building renovations, walkways, driveways, roads, and other improvements provides for safe, adequate, and convenient pedestrian and vehicular traffic circulation, both on the site and in the surrounding streets. Excessive grades in the design of roads and/or driveways have been avoided.
- 5. As set forth on the enclosed site plans, the siting of the Proposed Project minimizes disturbance to open space and natural features located on publicly owned lands adjacent to the site, including, but not limited to, parkland, wildlife habitat and scenic views.
- 6. The Proposed Project conforms to the height, bulk and other requirements of this chapter, and does not require any variances from the Zoning Board of Appeals, nor modifications or waivers by the Board of Trustees.
- 7. As noted above, a SWPPP consistent with the requirements of Chapter 262 of the Village of Dobbs Ferry Village Code will be submitted as required for site plan approval. The SWPPP will meet the performance and design criteria and standards in § 262-8 of the Village of Dobbs Ferry Code.

8. Finally, as set forth on the enclosed Coastal Assessment Form, it is respectfully submitted that the Proposed Project is consistent with the Village's LWRP policy standards.

Enclosed please find for your review the following documents:

- 1) Completed and signed Site Plan Application form, including a completed Coastal Assessment Form;
- 2) Completed and signed Short Environmental Assessment Form; and
- 3) Complete set of site plan drawings, prepared by Foit-Albert Associates, Architecture, Engineering and Surveying, PC and Alloy Design Studio PLLC, for your consideration. These drawings include the details regarding the Proposed Project, including landscaping, lighting, grading, erosion control, and storm water management features.

Kindly place this matter on the April 26, 2022 Board of Trustees meeting agenda, for the Board to consider referring the application to the Planning Board and AHRB for review and recommendation at their respective May meetings, and declaring its intent to serve as the Lead Agency under SEQRA. Thank you for your consideration of this project.

Very truly yours,

Seth M. Mandelbaum

SMM:srw

Enc.

cc: Mercy College Development Team

Lori Lee Dickson, Esq.

Valerie Monastra

Village of Dobbs Ferry Site Plan Application

ricase crieck approp	TIBLE DUX.	•
X_Preliminary	Date April 14, 20	022Final Date_April , 2022
Name of proposed d	evelopment_Mercy	/ College - Grove Pavilion and R-Lot Parking Improvements
Applicant:		Plan Prepared By: Name: Foit-Albert Associates (Civil Engineer)
Name_Mercy Colle	ge ·	Address: 89-31 161st St, Suite 901
Address 555 Broad	way	Jamaica, NY 11432 Telephone: 716.856.3933
Dobbs Fer	ry, NY10522	Name: Allay Danign Studio DLLC (Landacana
Telephone 914.674	7473	Name: Alloy Design Studio PLLC (Landscape Architect) Address: 29 Perryridge Road
Owner (if different):	N/A	Greenwich, CT 06830
		Telephone: 203.661.2723
If more than one ow	ner, provide inform	ation for each:
Name		
Address		
Telephone		
Oursetis intentions		N/Λ
Ownership intentions	, i.e., purchase opt	JOHS_N/A
		· · · · · · · · · · · · · · · · · · ·
Location of site Me	rcv College - 555	Broadway
Tax map description:	SBLs: 3.40-4-2	1 & 3.40-4-19
Sheet	Block	Lot/Parcel
Current Zening Classi	Section Education	n/Institutional (EI)

Site Plan Application Page 2 of 6

State and federal permits needed (list type and appropriate department):	
NYSDEC General Permit for Construction Activities (SPDES)	
	92
Proposed uses(s) of site Existing Education/College (no change of use)	40
Project includes construction of pavilion in The Grove area and upgrades to	
R-Lot with no increase in pavement footprint.	
Total site area (square feet or areas) 35.02 acres	
Anticipated construction time	
Will development be staged? No	•
Current land use of site (agriculture, commercial, undeveloped, etc.)	
Education/College	
·	
Current condition of site (buildings, rush, etc.) College Campus	
Character of surrounding lands (suburban, agriculture, wetlands, etc.)	
Residential to North, East and South. Hudson River and MetroNorth RR to the W	/est
Estimated cost of proposed improvement \$	
Anticipated increase in number of residents, shoppers, employees, etc. (as applicable) No anticipated increase to number of students.	

Site Plan Application Page 3 of 6

Describe the proposed use, including primary and secondary uses; ground floor area; height; and number of stories for each building:

The Grove Section of Campus: Mercy College is proposing landscape renovations and a new timber pavilion on the Grove section of their Dobbs Ferry Campus. The Pavilion will be openair structure of timber posts, beams, and trusses for a rough size of 44'-90' with a natural stone floor finish and covered by a gable pitched roof. Additional site renovations include stabilized gravel pathways, boulder seat-walls, pruning and maintaining existing legacy vegetation, and expansion of an existing open-air storm-water basin.

R-Lot Parking Renovations: The R-Lot parking area, located at the western most portion of campus is in dire need of repaving, safe and uniform lighting, and resetting of curbs for slope stabilization, all of which is being proposed in as part of this work. Additional site-work remediation includes storm-water improvements, planting, and correction of minor alignment changes to improve safety and accessibility. No additional parking will be added as part of this work.

STATE OF NEW YORK) COUNTY OF WESTCHESTER) ss: VILLAGE OF DOBBS FERRY)	*
Thomas R. Simmonds	being duly sworn, deposes
and says, that (s)he resides at Mercy Co	llege, 555 Broadway, Dobbs Ferry, NY 10522
0	entative of the owner and that the foregoing
answers are true to the best of (his) know	vledge and belief, that the plat if approved by
	ce of the County Clerk within ninety (90) days
following the date approval and that all	regulations of the Planning Board have been
complied.	Mercy College by: Unil College Thomas P. Signando
SWORN TO BEFORE ME THIS 13 DAY	Thomas R. Simmonds
Thomas J. mosour	05EPH MC0
THOMAS JOSEPH MCDONALD NOTARY PUBLIC-STATE OF NEW YORK No. 02MC6282650 Qualified in Westchester County My Commission Expires 05-28-2025	COLL EVPIRES COLL STREET

Site Plan Application Page 4 of 6

Proposed Development:	Applicant:
Name Mercy College - Grove Pavilion and R-Lot Parking Improvements	Name_Mercy College
and K-Lot Parking improvements	Address 555 Broadway, Dobbs Ferry, NY 10522
	Telephone 914.674.7473
Procedural Sequence	<u>Date</u>
Initial contact with enforcement Officer Presubmission conference Preliminary application Fee paid: Amount \$ Public hearing notice Public hearing Tentative action:	
Approval	
Approval with modification	· · · · · · · · · · · · · · · · · · ·
Disapproval Resubmitted	 :
Lapse date for final approval Final application Referral Comments returned Final Action:	
Approval Approval with modifications Conditions satisfied Disapproval Resubmitted	**************************************
Building permit granted Performance bond required	
Amount Period	
Improvements covered	
Performance bond satisfied	

Site Development Plan Review


Checklist (cont'd)

Technical Considerations	Item Satisfied
North arrow, scale date Property boundary, dimensions and angles Easements and deed restrictions Names, locations and widths of	X X
adjacent streets	N/A for Lot R
Land use, zoning, ownership and physical improvement of adjacent properties	N/A for Lot R
Conformity with comprehensive plan	N/A for Lot R
Impact on environs:	No impact for Lot R
Transportation	No impact for Lot R
Community facilities and services	No impact for Lot R
Aesthetics	No impact for Lot R
Environmental, i.e. air, water,	
noise, etc.	No impact for Lot R
Energy conservation	No impact for Lot R
Historic preservation	No impact for Lot R
Environmental impact statement	X (SEQR Part 1 completed) Drainage, pavement and lighting
Existing, on-site physical improvements	improvements
Existing natural features:	W-24
Geological features	<u>X</u>
Soil characteristics	X
Topography	X
Vegetation	X ,
Hydrologic features	<u>X</u>
Proposed development:	~
Grading and drainage plan	NI/A for Lot D
Buildings and other structures	N/A for Lot R
Improvements such as parking, storage and recreation areas	×
Vehicular and pedestrian ways	
including ingress and egress	X
	~
Utility lines and appurtenances	X

Site Plan Application Page 6 of 6

Outdoor lighting and public address systems

Outdoor signs
Landscaping plans
Architectural plans
Materials specifications
Construction schedule

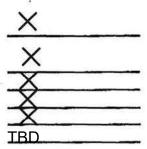

VILLAGE OF DOBBS FERRY

SITE PLAN CHECK LIST

The items listed below should be reviewed by the applicant's design professional to aid in providing a complete submission.

<u>AG</u>	SENCY APPROVALS	<u>YES</u>	<u>NO</u>
We	stchester County Department of Health		
Sep	otic and Water.		X
Ne	w York State Department Environmental	·	
Co	nservation Stormwater SPDES.	_×_	
Nev	w York City Department Environmental		-
Pro	tection Joint Septic.		<u>_X</u>
Nev	w York City Department of Environmental		
Pro	tection SWPPP.		_X_
<u>VII</u>	LLAGE PERMITS/APPROVALS		
Zor	ing Board of Appeals.		X
Bla	sting and Explosives Permit.		X X X
Fill	Permit.		X
	shwater Wetlands Permit.		<u>X</u>
	Plan to comply with Subdivision		
	at approval requirements		X
	rmwater Pollution Prevention Plan (SWPPP)	X	
	hitectural Review	_X_	
	lding Permit	_X_	
	avation/Grading Pernit	_X_	
	nolition Permit	_X_	
Elec	etrical Permit	<u>X</u>	
<u>SIT</u>	E PLAN INFORMATION	·	
1.	24" x 36" maximum drawing size.	_X_	
2.	Minimum scale: (1" = 30').	X	
3.	Project Name.	X	
4.	Name and address of engineer and surveyor.	X	
5.	Name and address of owner of record and applicant.	X X X X	
6.	Drawings signed and sealed by P.E. or R.A.		
7.	Original drawing date & revision dates.	<u>×</u>	
8.	Tax map section and lot numbers.	<u>×</u>	

9. 10.	Location plan with existing and adjacent zoning district. Scale, north arrow, date of survey, property acreage, drawings numbered (i.e., 1 of 3, 2 of 3, etc.) & identify adjoining property owners.	X X	
11.	Minimum yard setbacks.	<u>×</u>	
12.	Provide bulk zoning table with all existing, proposed		
	and required conditions.	_X_	
<u>AGI</u>	ENCY APPROVALS		
12.	Estimated quantity of cut or fill to be imported or removed from site or provide note stating that ANo material is to be imported or removed from this site.@		
13.	Topography at two feet maximum intervals.	_X_	
14.	Topography along streets adjacent to property.	<u>X</u> _X	
15.	Existing buildings, retaining walls, fences,		
	rock outcrops, wooded areas, watercourses, water		
16.	bodies, wetlands and wetland controlled areas, etc. Total amount of site area disturbed	_ <u>X</u>	
10.	Total amount of site area distarbed		Address of the State of the Sta
DRA	INAGE		
1.	Collect and convey driveway runoff.		
	Mitigate increases in site runoff due to		_
	site development.	_X_	·
2.	Roof drains to discharge to existing or proposed		
	drainage system. Mitigate increases from roof runoff.	NI/A	
3.	Surface inlets provided where low points cannot be	<u>N/A</u>	
٥.	graded to drain.	×	
4.	Swale provided between buildings and embankment		
	which slopes toward building.		. N/A.
5.	Culverts provided where roads or driveways cross		
_	watercourses.		<u>N/A</u>
6.	Catch basin spacing adequate.	<u>X</u>	
7. 8.	All rim and invert elevations provided. Two feet minimum cover of storm drains in roads,	_X_	NI/A
0.	driveways and parking areas. 18" minimum		<u>N/A</u>
	elsewhere.		
9.	Drywells provided with emergency overflow		
	outlet pipes to grade. Multiple drywell systems		
	should be connected by equalization pipes with		
	rim and invert elevations posted.		×
10.	Minimum storm drain pipe size 15" diameter.		X

12" dia. in some areas; pipes were sized to carry the 10-year flow

11.	Headwalls or end sections provided at pipe inlets and outlets.		N/A
12.	Rip-rap provided at headwalls and end sections.		N/A
13.	Provide cross section for pond or detention facility.		
13.	Trovide cross section for pond of detention facility.		_N/A
SITI	E INGRESS/EGRESS		
1.	Adequate sight distance at driveway intersection		
	with road.		N/A
2.	Site accessible to fire trucks, emergency	X	
	vehicles, tractor trailers for fill deliveries,		
	moving vans, oil trucks, etc.		
3.	Backup space for parking area.	X	
4.	Driveways intersecting existing road at 90E.		N/A
••	21170 ways missing omising road at 702.		.1.11/25_
SITE	E GRADING		
1.	All proposed grading on property for house, driveway		
••	and septic. Show limit line of disturbance.	X	
2.	Driveway platform sloped at 4% maximum within		
۷.	25 feet of centerline of street or within 35 feet from		
	the Right-of-Way, whichever is the greater distance.		N/A
3.	Driveway slope 14% maximum.		<u>N/A</u>
<i>3</i> . 4.	Parking area 5% maximum.		<u> 1747</u> .
5.	Paved areas 1% minimum grade at curb line.	X X X X X	
<i>5</i> . 6.	Lawn area 2% minimum.	$\frac{\Delta}{\lambda}$	
		$\frac{1}{\sqrt{2}}$	
7.	Top and bottom of retaining wall elevations provided.	\ \ \ \ \ \ \ \ \ \ \ \ \ \ \ \ \ \ \ 	
8.	Outside grade pitched away from residence.	<u>X</u>	
9.	Guide rail provided at steep drop offs.	<u>×</u>	
10.	Spot elevations at corners of residence and parking area	X	
	where necessary to ensure positive drainage.		. 1/0
11.	Finished floor elevations provided including basement.		<u>N/A</u>
12.	Plans and calculations for walls ≥ 4 feet Signed & Sealed		
	by P.E., R.A.	<u>X</u>	
13.	Provide profiles of proposed roads with vertical		
	geometry.		<u>N/A</u>
14.	Provide horizontal geometry.		N/A
<u>GEN</u>	RAL		
1	Change and a managed of that a formation and a	~	
l.	Show existing and proposed utilities (water, sewer, etc.)	\ \ \ \ \ \ \ \ \ \ \ \ \ \ \ \ \ \ \ 	
2.	Show snow piling areas.	X	

3.	Show refuse areas with enclosures.	<u>N/A</u>	
4.	Show zoning map with districts(school, fire, etc).	_X_	
5.	Show signage.	<u>_X_</u>	
6.	Show landscaping.	X X X X	
7.	Provide sections and details of wall.	<u> </u>	
8.	Provide phasing plan for areas over 5ac.		N/A
9.	Provide lighting plan.	$\underline{\times}$	
10.	Maintain low noise level at property line.		<u>N/A</u>
11.	ADA compliance	_X_	
12.	-Village Construction Standard Compliance	$\frac{\times}{\times}$	
SITE	E PLAN NOTES		
1.	General construction notes.		
2. 3.	Construction Sequence shown on plans.	<u>X</u> _X_	
3.	The following notes shall be provided on the plans:		
	AShould rock blasting be required, a permit		
	application in accordance with Chapter 125 -		
	Blasting and Explosives of the Village of Dobbs		
	Ferry Code must be submitted to the Village by		
	the applicant for review/approval. This should		
	be noted on the plans as follows:	_X_	
	AThe Village Engineer may require additional		
	erosion control measures if deemed appropriate		
	to mitigate unforeseen siltation and erosion of		
	disturbed soils.@	_X_	
	AAs-Built plans of the proposed driveway and		
	drainage improvements shall be submitted to		
	the Village Engineer for review prior to issuance		
	of Certificate of Occupancy.@	_X_	
	AFill material imported to the site shall be		
	certified in writing by a New York Licensed		
	Professional Engineer as clean, non-contaminated		
	fill suitable for the intended use.@	_X_	
	"Before the site plan is signed by the Chairman of		
	the Planning Board, the applicant shall be required		

to post a performance bond or other type of

		acceptable monetary guaranty which shall be in an amount determined by the Planning Board and the Village Engineer and in a form satisfactory to the Village Attorney".	_X_		•—•
4.	The follo	wing notes shall be provided on plans that involve SWPPP	's:		
	Villag	pplicant shall notify the Building Department or ge's Consulting Engineer in writing at least 48 hours before f the following so that any inspection may be performed.	_		
	1)	Start of construction	<u>×</u>		
	2)	Installation of sediment and erosion control measures.	_X_		
	3)	Completion of site clearing.	<u>_X_</u>		
	4)	Completion of rough grading.	_X_		
	5)	Installation of SMP's.	_X_		
	6)	Completion of final grading and stabilization of distured areas.	_×_		
	7)	Closure of construction.	<u>×</u>		
	8)	Completion of final landscaping; and	<u>×</u>		
	9)	Successful establishment of landscaping in public areas.			<u>N/A</u>
	inspec sedin at lea	owner or operator shall have a qualified inspector and document the effectiveness of all erosion and nentation control practices and prepare inspection reports st once a month. These reports must be kept on site and ble for review".	<u>×</u>		
SIT	E CONS	TRUCTION DETAILS			
Dri	veway Pro	ofile		NI/A	

Driv	veway and shoulder section		<u>N/A</u>
Roa	ndway replacement		<u>N/A</u>
	ement section	<u>×</u>	
Side	ewalk Details	×	
-	-rap slopes, embankments and aprons		<u>N/A</u>
Pave	ed, rip-rapped, grass gutters		N/A
NYS	SDOT material item numbers	_X_	
Dete	ention basin		
Cato	ch basin	<u>X</u> <u>X</u>	
Surf	face inlet —	X	
Drai	in manhole	<u>X</u>	
Head	dwall		N/A
Curt	b	X	
Dryv	well		N/A
Und	erdrain	$\overline{\mathbf{x}}$	
Reta	aining wall	$\overline{\mathbf{x}}$	
	fence	×	
Hayl	bales		N/A
-	protection	X X X X	
Anti	-tracking strip		N/A
Guid	derail	<u></u>	
Ener	rgy dissipater		N/A
Sedi	ment traps or basins		<u>N/A</u> <u>N/A</u>
ERC	DSION CONTROL PLAN		
	ion control measures implemented as plelines for Urban Erosion and Sediment		
Cuic			
<u>MIS</u>	CELLANEOUS ITEMS		
1.	Proposed easements		
	a) Temporary construction		<u>N/A</u>
	b) Drainage		N/A
	c) Sight		N/A
	d) Slope		N/A
	e) Driveway access		<u>N/A</u>
2	Existing conitory diamonal system in	the vicinity	NI/A
2.	Existing sanitary disposal system in of construction activity protected with	• —	_N/A
	fencing.		

VILLAGE OF DOBBS FERRY - LWRP CONSISTENCY REVIEW

COASTAL ASSESSMENT FORM (CAF)

Mailing address: 555 Broadway, Dobbs Ferry, NY 10522 Telephone number: 914.674.7473 Tax Lot # 3.40-4-19 and 3.40-4-21 Application number, if any: A. INSTRUCTIONS (Please print or type all answers) 1. All applicants, including the Village of Dobbs Ferry and other agencies, shall complete this CAF for proposed actions subject to Local Law # 10-05 - LWRP Consistency Law. This assessment is intended to supplement other information used by the Dobbs Ferry Planning Board in making a determination of consistency with the Coastal Management Policies set forth in the Dobbs Ferry Local Waterfront Revitalization Program (LWRP). 2. All applicants shall complete Sections B and C of this Coastal Assessment Form. If the proposed action meets any of the criteria listed in Section C, Section D must be completed. 3. In Section D, a proposed action should be evaluated as to its potential beneficial and/or adverse effects upon the coastal area and how it may affect the achievement of the specific policy standards contained in the LWRP and the LWRP Consistency Law. 4. Once evaluated, a proposed action may need to be analyzed in more detail and, if necessary, modified prior to making a determination that it is consistent with the LWRP policy standards. If an action cannot be certified as consistent with the LWRP policy standards, it shall not be undertaken. B. DESCRIPTION OF SITE AND PROPOSED ACTION
Application number, if any: A. INSTRUCTIONS (Please print or type all answers) 1. All applicants, including the Village of Dobbs Ferry and other agencies, shall complete this CAF for proposed actions subject to Local Law # 10-05 - LWRP Consistency Law. This assessment is intended to supplement other information used by the Dobbs Ferry Planning Board in making a determination of consistency with the Coastal Management Policies set forth in the Dobbs Ferry Local Waterfront Revitalization Program (LWRP). 2. All applicants shall complete Sections B and C of this Coastal Assessment Form. If the proposed action meets any of the criteria listed in Section C, Section D must be completed. 3. In Section D, a proposed action should be evaluated as to its potential beneficial and/or adverse effects upon the coastal area and how it may affect the achievement of the specific policy standards contained in the LWRP and the LWRP Consistency Law. 4. Once evaluated, a proposed action may need to be analyzed in more detail and, if necessary, modified prior to making a determination that it is consistent with the LWRP policy standards. If an action cannot be certified as consistent with the LWRP policy standards, it shall not be undertaken.
Application number, if any: A. INSTRUCTIONS (Please print or type all answers) 1. All applicants, including the Village of Dobbs Ferry and other agencies, shall complete this CAF for proposed actions subject to Local Law # 10-05 - LWRP Consistency Law. This assessment is intended to supplement other information used by the Dobbs Ferry Planning Board in making a determination of consistency with the Coastal Management Policies set forth in the Dobbs Ferry Local Waterfront Revitalization Program (LWRP). 2. All applicants shall complete Sections B and C of this Coastal Assessment Form. If the proposed action meets any of the criteria listed in Section C, Section D must be completed. 3. In Section D, a proposed action should be evaluated as to its potential beneficial and/or adverse effects upon the coastal area and how it may affect the achievement of the specific policy standards contained in the LWRP and the LWRP Consistency Law. 4. Once evaluated, a proposed action may need to be analyzed in more detail and, if necessary, modified prior to making a determination that it is consistent with the LWRP policy standards. If an action cannot be certified as consistent with the LWRP policy standards, it shall not be undertaken.
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B. DESCRIPTION OF SITE AND PROPOSED ACTION
 Type of action (check appropriate response): (a) Directly undertaken (e.g. capital construction, planning activity, agency regulation, land transaction)

The Grove Section of Campus: Mercy College is proposing landscape renovations and a new timber pavilion on the Grove Section of their Dobbs Ferry Campus. The Pavilion will be open-air structure of timber posts, beams, and 2. Describe nature and extent of action: trusses for a rough size of 44-90 with a natural stone floor finish and covered by a gable pitched roof.

Additional site renovations include stabilized gravel pathways, boulder seat-walls, pruning and maintaining existing legacy vegetation, and expansion of an existing open-air storm-

Re-Lot Parking Renovations: The R-Lot parking area, located at the western most portion of campus is in dire need of repaving, safe and uniform lighting, and resetting of curbs for slope stabilization, all of which is being proposed in as part of this work. Additional site-work remediation includes storm-water improvements, planting, and correction of minor alignment changes to improve safety and accessibility. No additional parking will be added as part of this work.

3. Location of action (Street or Site Description) : The Proposed Project would be located entirely within the Village of Dobbs Ferry portion of the campus, and comprises tax block and lots 3 40-4-19 and 3 40-4-21

portion of the campus, and comprises tax block and lots 0.40-4-10 and 0.40-4-21
C. COASTAL ASSESSMENT CRITERIA
Please check any of the following criteria that describe the proposed action.
1. The proposed action has direct contact with coastal waters, i.e. the Hudson River and/or its trībutaries - Wickers Creek and the Saw Mill River.
2. The proposed action utilizes coastal waters, either directly or indirectly.
3. The proposed action involves natural features such as tree cover, hillsides, steep slopes, ridgelines and wetlands that either effect or are affected by coastal waters.
4. The proposed action demonstrates a relationship to coastal waters. The relationship may be recreational, cultural, historic, or business.
5. The proposed action has a direct visual relationship with coastal waters and their waterfronts.
If the proposed action meets any of the above criteria, Section D must be completed.
D. COASTAL ASSESSMENT
The following thirteen questions are based directly on the Coastal Management Policies set forth
in Section III of the Dobbs Ferry LWRP. The preparer of this form should review these policies

which are available online at www.dobbsferry.com/content/waterfront and also on file in the Village of Dobbs Ferry Clerk's office. Please answer every question and provide a brief explanation. If necessary, you may attach further explanation or refer to other available documentation relating to the proposed action.

Planning Bd.	Applicant 1. Does the proposed action foster a pattern of development in the coastal area
1. 🗆	that enhances community character, open space preservation, use of existing
	infrastructure, use of a coastal location?
	× YES NO Not Applicable
	Existing stormwater detention and treatment structures will be retained as part of R-Lot work. Drainage
	improvements will result in less direct discharge of the adjacent slope, improving longterm slope stability
	adjacent to the Hudson.
	
2. 🗆	Does the proposed action preserve historic and archaeological resources? X YES NO Not Applicable The Grove Pavilion improvements would be located adjacent to the Old Croton Aqueduct, which is listed on the
	State and National Register of Historic Places. While the Proposed Project would be visible from the Old Croton
	Aqueduct, no direct disturbance or new crossings are proposed.
	There is not any impact for R-Lot Work.
3. ∐	3. Does the proposed action protect existing scenic resources or enhance visual quality in the community? XYESNONot Applicable The Project Site contains views of the Hudson River and Palisades.
	No impact for R-Lot work.
<u>.</u>	
4. ⊔	4. Does the proposed action minimize loss of life, structures, and natural
	resources from flooding and erosion?YESNO _x Not Applicable
	The Proposed Project is not within the floodplain or floodway.
	Drainage improvements will result in less direct discharge to the adjacent slope, reducing erosion and
	improving longterm slope stability adjacent to the Hudson.
5. 🗌	
э. 🗆	5. Does the proposed action protect or improve water resources? YESNO _x Not Applicable
	The Proposed Project does not involve any direct impacts to water resources. All stormwater will be managed
	in accordance with all applicable NYSDEC regulations.
	No impact for R-Lot work.

6. 🗌	6. Does the proposed action protect or restore ecological resources, including significant fish and wildlife habitats, wetlands, and rare ecological communities?
	YESNO _X Not Applicable
	The Proposed Project will avoid any impacts to ecological resources. There are no significant fish or wildlife
	habitats, wetlands, or rare ecological communities on the project site.
7. 🗆	7. Does the proposed action protect and/or improve air quality? YESNO _×Not Applicable The Proposed Project will not have any significant effect on air quality.
	The Proposed Project will not have any significant effect on all quality.
8. 🗆	8. Does the proposed action minimize environmental degradation from solid waste and hazardous substances and wastes? YES NO X Not Applicable No impact for R-Lot work.
9. 🗌	9. Does the proposed action improve public access to and recreational use of public lands and waters? YES NO X Not Applicable Mercy College is a privately owned college.
	No current or proposed public land or water access from R-Lot.
	10. Does the proposed action protect water-dependent uses, promote siting of new
10. 🗆	water-dependent uses in suitable locations, and/or support efficient harbor operation?
	YES X NO Not Applicable

11. 🗆	11. Does the proposed action promote the sustainable use of fish and wildlife resources? YES NO × Not Applicable There are no significant fish or wildlife communities on the Project Site.
12. 🗆	12. Does the proposed action protect agricultural lands? YESNO ×Not Applicable There are no agricultural lands on the Project Site.
13. 🗆	13. Does the proposed action promote appropriate use and development of energy and mineral resources? YESNOXNot Applicable Energy efficient lighting will be used for lighting R-Lot.
8 8	
Consistency Determination	E. FURTHER REMARKS OR ADDITIONAL INFORMATION:
☐ Yes ☐ No	
	If assistance or further information is needed to complete this form, please contact Village of Dobbs Ferry Clerk at 914-693-2203 ext. 204 Preparer's All Mandelbaum Telephone: 914.949.6400 McCullough, Goldberger & McC

Short Environmental Assessment Form Part 1 - Project Information

Instructions for Completing


Part 1 – Project Information. The applicant or project sponsor is responsible for the completion of Part 1. Responses become part of the application for approval or funding, are subject to public review, and may be subject to further verification. Complete Part 1 based on information currently available. If additional research or investigation would be needed to fully respond to any item, please answer as thoroughly as possible based on current information.

Complete all items in Part 1. You may also provide any additional information which you believe will be needed by or useful to the lead agency; attach additional pages as necessary to supplement any item.

Part 1 – Project and Sponsor Information			
Name of Action or Project:			
The Grove Pavilion & R-Lot Parking Improvements			
Project Location (describe, and attach a location map):			
Mercy College			
Brief Description of Proposed Action:			
Construction of a permanent open-aired pavilion in The Grove area of the campus (where large temporary tent has been installed during COVID-19 pandemic), and upgrades to R-Lot, including full depth reconstruction of existing parking lot with no increase in impervious area or pavement footprint; installation of new LED lighting; and drainage improvements in the upper lot.			
Name of Applicant or Sponsor:	Telephone: 914-674-747	3	
Mercy College E-Mail: tsimmonds1@mercy.edu		ercy.edu	
Address:			
555 Broadway			
City/PO: State: Zip Code:			
Dobbs Ferry NY 10522			
 Does the proposed action only involve the legislative adoption of a plan, local administrative rule, or regulation? 	ai iaw, ordinance,	NO Y	/ES
If Yes, attach a narrative description of the intent of the proposed action and the environmental resources that may be affected in the municipality and proceed to Part 2. If no, continue to question 2.			
2. Does the proposed action require a permit, approval or funding from any other government Agency? NO YES			ES
If Yes, list agency(s) name and permit or approval: Building Permit from Dobbs Ferry Building Department			√
3. a. Total acreage of the site of the proposed action? acres b. Total acreage to be physically disturbed? acres c. Total acreage (project site and any contiguous properties) owned or controlled by the applicant or project sponsor? acres			
4. Check all land uses that occur on, are adjoining or near the proposed action:			
5. Urban Rural (non-agriculture) Industrial Commerci	al 🔽 Residential (subu	rban)	
Forest Agriculture Aquatic Other(Spe	cify): Educational		
✓ Parkland			

5.	Is the proposed action,	NO	YES	N/A
	a. A permitted use under the zoning regulations?		√	
	b. Consistent with the adopted comprehensive plan?		√	
6.	Is the proposed action consistent with the predominant character of the existing built or natural landscape?		NO	YES
0.	is the proposed action consistent with the predominant character of the existing built of natural randscape.			✓
	Is the site of the proposed action located in, or does it adjoin, a state listed Critical Environmental Area? Name:Hudson River, Name:County & State Park Lands, Reason:Exceptional or unique character,		NO	YES
11 16	es, identify: Agency:Westchester County, Date:1-31-90			\checkmark
8.	a. Will the proposed action result in a substantial increase in traffic above present levels?		NO	YES
	b. Are public transportation services available at or near the site of the proposed action?			
	c. Are any pedestrian accommodations or bicycle routes available on or near the site of the proposed action?			√
9.	Does the proposed action meet or exceed the state energy code requirements?		NO	YES
If the	ne proposed action will exceed requirements, describe design features and technologies:			✓
10.	Will the proposed action connect to an existing public/private water supply?		NO	YES
	If No, describe method for providing potable water:			✓
11.	Will the proposed action connect to existing wastewater utilities?		NO	YES
	If No, describe method for providing wastewater treatment:			✓
12.	a. Does the project site contain, or is it substantially contiguous to, a building, archaeological site, or district		NO	YES
Com	ch is listed on the National or State Register of Historic Places, or that has been determined by the nmissioner of the NYS Office of Parks, Recreation and Historic Preservation to be eligible for listing on the e Register of Historic Places?	;		√
State	Old Croton Aqueduct			
arch	b. Is the project site, or any portion of it, located in or adjacent to an area designated as sensitive for naeological sites on the NY State Historic Preservation Office (SHPO) archaeological site inventory?			✓
	a. Does any portion of the site of the proposed action, or lands adjoining the proposed action, contain wetlands or other waterbodies regulated by a federal, state or local agency?		NO	YES
	b. Would the proposed action physically alter, or encroach into, any existing wetland or waterbody?		✓	
If Ye	es, identify the wetland or waterbody and extent of alterations in square feet or acres:			

14. Identify the typical habitat types that occur on, or are likely to be found on the project site. Check all that apply:		
✓Shoreline ☐ Forest ☐ Agricultural/grasslands ☐ Early mid-successional		
☐ Wetland ☐ Urban ☑ Suburban		
15. Does the site of the proposed action contain any species of animal, or associated habitats, listed by the State or	NO	YES
Federal government as threatened or endangered? Bald Eagle, Atlantic Sturge		√
16. Is the project site located in the 100-year flood plan?	NO	YES
	\checkmark	
17. Will the proposed action create storm water discharge, either from point or non-point sources?	NO	YES
If Yes,		√
a. Will storm water discharges flow to adjacent properties?	\checkmark	
b. Will storm water discharges be directed to established conveyance systems (runoff and storm drains)? If Yes, briefly describe:		✓
Grove Pavilion runoff will be directed to existing open air basin (to be expanded). R-Lot flow will be directed to existing/new storm drainage inlets. Some flow will be detained by an existing stormwater system under R-Lot.		
18. Does the proposed action include construction or other activities that would result in the impoundment of water or other liquids (e.g., retention pond, waste lagoon, dam)?	NO	YES
If Yes, explain the purpose and size of the impoundment:		
	\checkmark	Ш
19. Has the site of the proposed action or an adjoining property been the location of an active or closed solid waste management facility?	NO	YES
If Yes, describe:		
s	✓	
20. Has the site of the proposed action or an adjoining property been the subject of remediation (ongoing or completed) for hazardous waste?	NO	YES
If Yes, describe:		
		\checkmark
I CERTIFY THAT THE INFORMATION PROVIDED ABOVE IS TRUE AND ACCURATE TO THE BE MY KNOWLEDGE	EST OF	
Applicant/sponsor/name: Mercy College Date: April 14, 2022		
Signature: Attorney for Applicant		

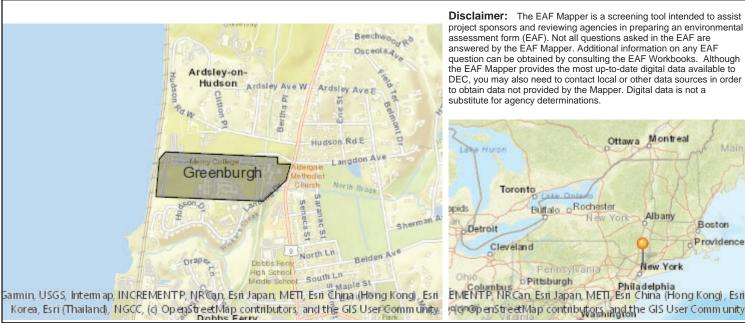

Disclaimer: The EAF Mapper is a screening tool intended to assist project sponsors and reviewing agencies in preparing an environmental assessment form (EAF). Not all questions asked in the EAF are answered by the EAF Mapper. Additional information on any EAF question can be obtained by consulting the EAF Workbooks. Although the EAF Mapper provides the most up-to-date digital data available to DEC, you may also need to contact local or other data sources in order to obtain data not provided by the Mapper. Digital data is not a substitute for agency determinations.




Part 1 / Question 7 [Critical Environmental Area]	Yes
Part 1 / Question 7 [Critical Environmental Area - Identify]	Name:Hudson River, Name:County & State Park Lands, Reason:Exceptional or unique character, Agency:Westchester County, Date:1-31-90
Part 1 / Question 12a [National or State Register of Historic Places or State Eligible Sites]	Yes
Part 1 / Question 12b [Archeological Sites]	Yes
Part 1 / Question 13a [Wetlands or Other Regulated Waterbodies]	Yes - Digital mapping information on local and federal wetlands and waterbodies is known to be incomplete. Refer to EAF Workbook.
Part 1 / Question 15 [Threatened or Endangered Animal]	Yes
Part 1 / Question 15 [Threatened or Endangered Animal - Name]	Bald Eagle, Atlantic Sturgeon, Shortnose Sturgeon
Part 1 / Question 16 [100 Year Flood Plain]	No
Part 1 / Question 20 [Remediation Site]	Yes

MERCY COLLEGE SITE, DOBBS FERRY, PARKING LOT "R" IMPROVEMENTS

555 BROADWAY DOBBS FERRY, NY 10522

60% DESIGN DOCUMENTS APRIL 8, 2022

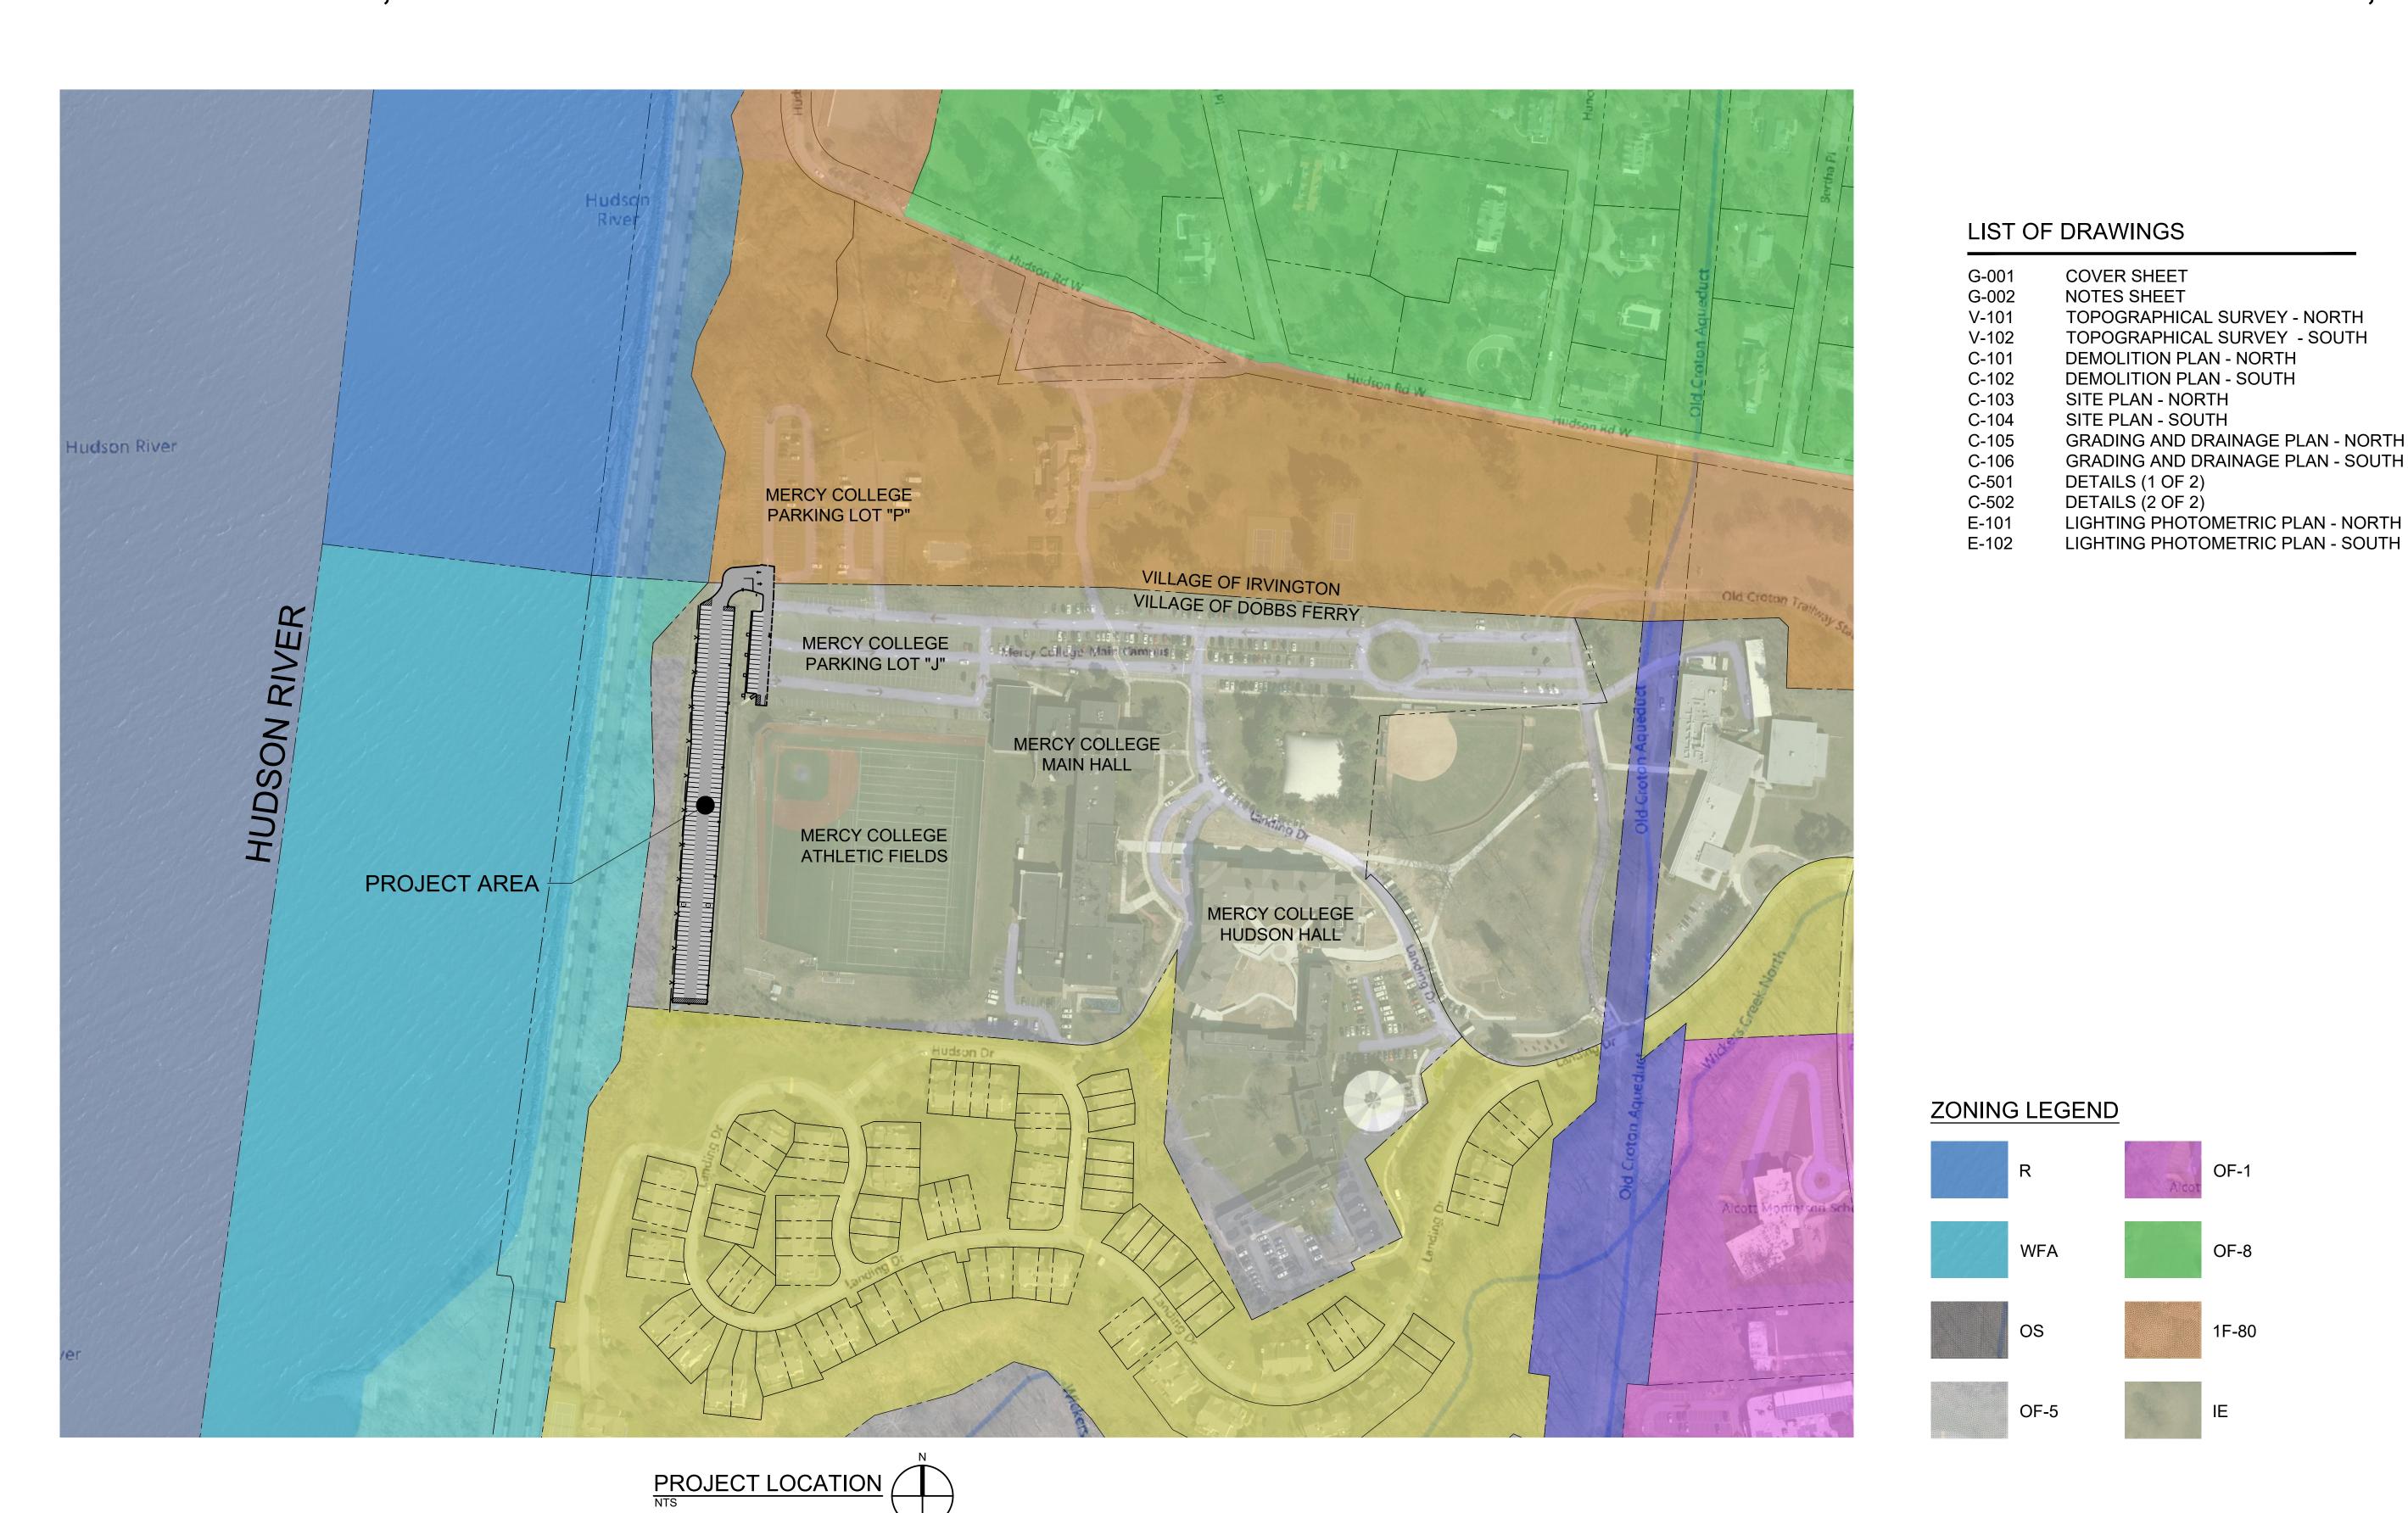



S S O C | A T E S L '
recture. Engineering. Surveying. Environ Street, Suite 200 P. (716) 856-3933 www.fo

SE DOBBS FERRY SIT I'R' IMPROVEMENTS

n Revision Date

a:
AS NOTED
: Project Manager:

Project Manager:
DLP

Vn By:
WB

Checked By:
HC

eact:
21013.00

G-00

GENERAL NOTES

- I. SHOULD ROCK BLASTING BE REQUIRED, A PERMIT APPLICATION IN ACCORDANCE WITH CHAPTER 125 -BLASTING AND EXPLOSIVES OF THE VILLAGE OF DOBBS FERRY CODE MUST BE SUBMITTED TO THE VILLAGE BY THE APPLICANT FOR REVIEW/APPROVAL.
- 2. THE VILLAGE ENGINEER MAY REQUIRE ADDITIONAL EROSION CONTROL MEASURES IF DEEMED APPROPRIATE TO MITIGATE UNFORESEEN SILTATION AND EROSION OF DISTURBED SOILS.
- 3. AS-BUILT PLANS OF DRAINAGE IMPROVEMENTS SHALL BE SUBMITTED TO VILLAGE ENGINEER FOR REVIEW.
- 4. FILL MATERIAL IMPORTED TO THE SITE SHALL BE CERTIFIED IN WRITING BY A NEW YORK LICENSED PROFESSIONAL ENGINEER AS CLEAN, NON-CONTAMINATED FILL SUITABLE FOR THE INTENDED USE.
- BEFORE THE SITE PLAN IS SIGNED BY THE CHAIRMAN OF THE PLANNING BOARD, THE APPLICANT SHALL BE REQUIRED TO POST A PERFORMANCE BOND OR OTHER TYPE OF ACCEPTABLE MONETARY GUARANTY WHICH SHALL BE IN AN AMOUNT DETERMINED BY THE PLANNING BOARD AND THE VILLAGE ENGINEER AND IN A FORM SATISFACTORY TO THE VILLAGE ATTORNEY.
- 6. IF SIGNS OF CONTAMINATION ARE ENCOUNTERED DURING EXCAVATION, IMMEDIATELY STOP WORK AND NOTIFY THE OWNER. SIGNS OF CONTAMINATION INCLUDE, BUT ARE NOT LIMITED TO: ODOR, OILY SHEEN, SLUDGE, SOIL STAINING, AND UNUSUAL FILL MATERIAL. THE NYSDEC MUST BE CONTACTED BY THE OWNER'S REPRESENTATIVE IF PETROLEUM CONTAMINATED SOIL IS ENCOUNTERED ONSITE DURING CONSTRUCTION.

DEMOLITION NOTES

- I. CLEAR AND GRUB EXISTING VEGETATION NECESSARY TO INSTALL THE WORK OF THIS CONTRACT. REMOVE ALL PORTIONS OF THE PLANTS TO A MINUMUM DEPTH OF 12" BELOW FINISH GRADE IN THE LAWN AREAS. COMPLETELY REMOVE ALL ABOVE AND BELOW GROUND PORTIONS OF PLANTS IN AREAS TO BE COVERED WITH BUILDINGS AND OTHER STRUCTURES, PAVEMENTS, AND PLANTING BEDS. REMOVE TREES INDICATED FOR REMOVAL IN THE ENTIRETY.
- PROTECT EXISTING TREES WHICH ARE TO BE PRESERVED FROM ROOT. TRUNK, AND LIMB DAMAGE, RESTRICT VEHICULAR TRAFFIC TO AREAS OUTSIDE THE DRIP LINE OF TREES. PREVENT COMPACTION OF SOIL WITHIN DRIP LINE OF TREES AND SURROUNDING SHRUBS.
- SAWCUTTING IS REQUIRED FOR TRENCHES AND PAVEMENT REMOVALS OR OTHER EXCAVATION WORK WITHIN PAVED AREAS OR AT CURBS, UNLESS OTHERWISE NOTED OR APPROVED BY THE OWNER'S REPRESENTATIVE.
- EXISTING CURB DESIGNATED FOR REMOVAL MUST BE REMOVED AND DISPOSED OFF SITE. ANY EXISTING CURB TO REMAIN THAT IS DAMAGED DURING CONSTRUCTION MUST BE REMOVED AND DISPOSED OF OFF SITE AND REPLACED AT THE EXPENSE OF THE CONTRACTOR.
- WHEN ADJACENT ASPHALT, CONCRETE, OR PAVING STONE AREAS ARE DISTURBED AS PART OF THE CONSTRUCTION, REPLACE THE DAMAGED OR EXCAVATED AREA. SAWCUT THE PERIMETER OF THE DISTURBED AREA FULL DEPTH SO THAT LINES ARE STRAIGHT AND TRUE.

STAGING AND WORK ZONE CONTROL NOTES

- 1. ENSURE THAT CONDITIONS SURROUNDING THE WORK AREA ARE ADEQUATE FOR PUBLIC SAFETY AT ALL TIMES. IMMEDIATELY REPORT THE PRESENCE OF ANY UNSAFE CONDITIONS TO THE OWNER.
- 2. NOTIFY LOCAL LAW ENFORCEMENT AND EMERGENCY SERVICES OF CHANGES TO THE TRAFFIC (VEHICULAR AND/OR PEDESTRIAN) PATTERNS AND ANY OTHER COORDINATION THEY REQUIRE.
- 3. MAINTAIN A SAFE TRAVEL WAY FOR PEDESTRIANS AROUND ALL WORK AREAS. KEEP ALL WORK AREAS, EITHER ACTIVE OR INACTIVE, INACCESSIBLE TO THE PUBLIC AT ALL TIMES BY MEANS ACCEPTABLE TO THE
- 4. COORDINATE TRAFFIC CONTROL MEASURES AND WORK SCHEDULE WITH THE OWNER.
- MAINTENANCE AND PROTECTION OF TRAFFIC MUST COMPLY WITH THE FEDERAL AND NEW YORK STATE DEPARTMENT OF TRANSPORTATION'S MANUAL OF UNIFORM TRAFFIC CONTROL DEVICES, SECTION 619 OF THE CURRENT NYSDOT STANDARD SPECIFICATIONS, THESE PLANS, AND AS ORDERED BY THE OWNER'S REPRESENTATIVE.
- VEHICLES AND/OR EQUIPMENT BELONGING TO THE CONTRACTOR OR THEIR WORKERS MAY NOT BE PARKED ON THE PAVEMENT OR SHOULDER ALONG A ROADWAY BEING USED BY THE GENERAL PUBLIC. NO MATERIAL MAY BE PLACED ON THE SHOULDER OR WITHIN THE CLEAR ROADSIDE AREA. CONSTRUCTION EQUIPMENT, MATERIALS, AND/OR VEHICLES STORED DURING NON-WORKING HOURS OR OVERNIGHT MUST BE LOCATED IN A FENCED PROJECT AREA AS PER OWNER'S DIRECTION.
- CONTRACTOR SHALL SUBMIT TO THE OWNER AND ENGINEER A WORK ZONE TRAFFIC CONTROL (WZTC) PLAN FOR APPROVAL PRIOR TO THE COMMENCEMENT OF ANY WORK. WZTC PLAN SHALL INCLUDE METHODS FOR ROAD CLOSURES, PARTIAL LANE CLOSURES, AND PARKING LOT CLOSURES WITH APPROXIMATE DATES OF

UTILITY NOTES

- 1. THE CONTRACTOR IS SPECIFICALLY CAUTIONED THAT THE LOCATIONS AND/OR ELEVATIONS OF EXISTING UTILITIES AS SHOWN ON THESE PLANS IS BASED ON RECORDS OF THE VARIOUS UTILITY COMPANIES AND. WHERE POSSIBLE, MEASUREMENTS TAKEN IN THE FIELD. THE INFORMATION IS NOT TO BE RELIED ON AS BEING EXACT OR COMPLETE.
- 2. CALL THE UNDERGROUND FACILITIES PROTECTION ORGANIZATION (UFPO) AT LEAST (7) FULL WORKING DAYS BEFORE ANY EXCAVATION (800) 962-7962. THE CONTRACTOR IS RESPONSIBLE FOR NOTIFYING UTILITY COMPANIES THAT ARE NOT A MEMBER OF THE "DIG SAFELY NEW YORK" PROGRAM.
- 3. VERIFY UTILITY LOCATIONS, DIMENSIONS, AND ELEVATIONS PRIOR TO COMMENCING WORK AND NOTIFY THE OWNER'S REPRESENTATIVE OF ANY DISCREPANCIES.
- 4. TAKE PRECAUTIONS NECESSARY TO PRESERVE THE INTEGRITY OF EXISTING UTILITIES TO REMAIN AND PROVIDE UNINTERRUPTED SERVICE TO ALL USERS OF THE EXISTING UTILITIES. PROTECT EXISTING UTILITIES TO REMAIN FROM DAMAGE BY EQUIPMENT PASSING OVER THEM. SUPPORT AND PROTECT EXISTING UTILITIES TO REMAIN IN EXCAVATIONS. USE SUITABLE VIBRATORY EQUIPMENT AND CONSTRUCTION PROCEDURES TO AVOID DISTURBANCE OR BREAKAGE OF THE EXISTING UTILITIES. CONTRACTOR TO REPAIR UTILITIES DAMAGED BY CONTRACTOR AT CONTRACTOR'S OWN COST.
- 5. NOTIFY THE OWNER 72 HOURS PRIOR TO PROPOSED UTILITY SHUTDOWN TO ALLOW TIME TO COORDINATE.
- 6. ADJUST OR REPLACE EXISTING WATER VALVES, GAS VALVES, STEAM, ELECTRIC, TELECOMMUNICATIONS, SANITARY SEWER, AND STORM MANHOLES AND/OR COVERS LOCATED WITHIN THE LIMIT OF CONTRACT AS REQUIRED TO MEET THE PROPOSED FINISH GRADE.

EARTHWORK & SITE RESTORATION NOTES

- REFER TO SPECIFICATION SECTION 310000 FOR ADDITIONAL EARTHWORK INFORMATION.
- 2. SOIL SUBBASES SHOULD NOT BE ALLOWED TO POOL STANDING WATER OR BECOME SATURATED, FROZEN, OR
- 3. PERFORM WORK IN COMPLIANCE WITH TITLE 29, CODE OF FEDERAL REGULATIONS, PART 1926, SAFETY AND HEALTH REGULATIONS FOR CONSTRUCTION (O.S.H.A.). IN TRENCH EXCAVATIONS, LAY THE SIDES SLOPES BACK TO A PERMITTED SLOPE (IF ADEQUATE SPACE IS AVAILABLE), USE A TRENCH SHIELD, OR PROVIDE SHEETING, SHORING, AND BRACING. INCLUDE COSTS FOR TRENCH AND STRUCTURE EXCAVATION
- 4. RESTORE DISTURBED AREAS WITH TOPSOIL (4" MINIMUM), HYDROSEEDING, MULCHING, AND WATERING UNLESS OTHERWISE STATED ON THE DRAWINGS.
- 5. THE CONTRACTOR IS RESPONSIBLE FOR MAINTENANCE OF LAWN SURFACES WITHIN THE CONTRACT LIMITS FOR THE DURATION OF THE CONSTRUCTION, MAINTAIN GRASS AT HEIGHTS BETWEEN 3 AND 3-1/2 INCHES ON A WEEKLY BASIS UNTIL THE FINAL ACCEPTANCE OF THE WORK.
- 6. DESIGNATE AN AREA AS APPROVED BY THE OWNER FOR TEMPORARY TOPSOIL STOCKPILING. KEEP SEPARATE FROM OTHER MATERIAL STOCKPILES. REMOVE FROM THE SITE AND DISPOSE OF STOCKPILED TOPSOIL THAT WILL NOT BE REUSED. REMOVE AND DISPOSE OF ANY UNSUITABLE SOIL MATERIAL
- 7. RESTORE EXCAVATIONS AND DISTURBED AREAS TO THE PROPOSED CONDITIONS SHOWN ON THE DRAWINGS AND PROJECT SPECIFICATIONS. THIS INCLUDES CONSTRUCTION ACCESS ROUTES, STAGING AREAS, AND DESIGNATED CONTRACT WORK AREAS.
- 8. PROVIDE ROUNDING AT TOP OF CUTS AND TOE OF FILLS WHEREVER POSSIBLE TO BLEND NEW CONTOURS TO
- ALL AREA WITHIN PROJECT AREA IS TO BE TOPSOILED AND SEEDED PER SPECIFICATIONS.

STORMWATER POLLUTION PREVENTION NOTES

- 1. THE PROJECT IS SUBJECT TO THE REQUIREMENTS OF NYSDEC SPDES GENERAL PERMIT FOR STORMWATER DISCHARGES FROM CONSTRUCTION ACTIVITY, GP-0-20-001. A STORMWATER POLLUTION PREVENTION PLAN (SWPPP) HAS BEEN PREPARED FOR THE PROJECT, AND EROSION AND SEDIMENT CONTROL WORK MUST BE COMPLETED UNDER THE PROVISIONS OF THE SWPPP.
- 2. FOLLOW MAINTENANCE, INSPECTION PROCEDURES, AND REQUIREMENTS OUTLINED IN THE NYSDEC SPDES GENERAL PERMIT FOR STORMWATER DISCHARGES FROM CONSTRUCTION ACTIVITY, GP-0-20-001.
- 3. PRIOR TO THE COMMENCEMENT OF CONSTRUCTION ACTIVITY, IDENTIFY AT LEAST ONE PERSON FROM RESPECTIVE COMPANIES INVOLVED IN EARTH DISTURBING ACTIVITIES THAT WILL BE RESPONSIBLE FOR IMPLEMENTATION OF THE SWPPP AND HAS RECEIVED 4 HOURS OF ENDORSED E&SC TRAINING. DESIGNATED TRAINED CONTRACTORS MUST READ, UNDERSTAND, AND SIGN A CONTRACTOR'S CERTIFICATION STATEMENT CONTAINED IN THE SWPPP PRIOR TO CONSTRUCTION. AT LEAST ONE TRAINED CONTRACTOR MUST BE ON THE SITE DURING THE PERFORMANCE OF SOIL-DISTURBING ACTIVITIES.
- 4. THE DIRECTOR'S REPRESENTATIVE IS RESPONSIBLE FOR DESIGNATING A QUALIFIED INSPECTOR AS DEFINED IN THE PERMIT TO PERFORM INSPECTIONS. THE QUALIFIED INSPECTOR IS RESPONSIBLE FOR INSPECTING THE SITE FOR COMPLIANCE WITH THE SWPPP AND THE PERMIT, IDENTIFYING COMPONENTS REQUIRING MAINTENANCE OR REMEDIAL ACTION, AND TRANSMITTING THIS INFORMATION TO THE TRAINED CONTRACTOR. MAINTENANCE OR REMEDIAL ACTION IDENTIFIED MUST OCCUR PRIOR TO THE NEXT INSPECTION. THE INSPECTION PERIOD IS AT LEAST ONCE EVERY SEVEN CALENDAR DAYS, UNLESS CONDITIONS REQUIRE MORE FREQUENT INSPECTIONS, OR AS SPECIFIED IN THE PERMIT.
- 5. MAINTAIN ON THE SITE A CURRENT RECORD OF SWPPP INSPECTIONS ALONG WITH A COPY OF THE PROJECT SWPPP, INCLUDING REVISIONS, ADDITIONS, OR MODIFICATIONS TO THE SWPPP.
- AT A MINIMUM, THE TRAINED CONTRACTOR(S), AS DEFINED IN GP-0-20-001, MUST:
- A. INSPECT EROSION CONTROL MEASURES BEING IMPLEMENTED IN THE ACTIVE WORK AREA DAILY TO ENSURE THEY ARE BEING MAINTAINED IN EFFECTIVE OPERATING CONDITION. REPAIR DEFICIENCIES IMMEDIATELY.
- B. SEED AND PLANT AREAS TO BE STABILIZED, INCLUDING REPAIRING BARE SPOTS, WASHOUTS, AND MAINTAINING A HEALTHY GROWTH OF STABILIZING COVER(S).
- C. MONITOR ADJACENT ROADWAYS TO ENSURE TRACKED MUD, DUST, DIRT, OR ROCKS ARE SWEPT AS NECESSARY.
- D. SEE THAT GENERAL WORKSITE HOUSEKEEPING IS MAINTAINED.
- 7. PRIOR TO FILING THE NOTICE OF TERMINATION, THE QUALIFIED INSPECTOR WILL PERFORM A FINAL SITE INSPECTION AND CERTIFY THAT THE SITE HAS UNDERGONE FINAL STABILIZATION AND THAT TEMPORARY EROSION AND SEDIMENT CONTROL MEASURES ARE REMOVED.

EROSION AND SEDIMENT CONTROL NOTES

- 1. INSTALL AND MAINTAIN EROSION CONTROL MEASURES IN ACCORDANCE WITH THE MOST CURRENT ISSUANCE OF "NEW YORK STATE STANDARDS AND SPECIFICATIONS FOR EROSION AND SEDIMENT CONTROL." COMMONLY KNOW AS "THE BLUE BOOK".
- 2. INSTALL EROSION CONTROL MEASURES FOR THE WORK AREA PRIOR TO SOIL DISTURBANCE AND EARTHWORK CONSTRUCTION ACTIVITIES. APPROPRIATE PRACTICES ARE TO REMAIN IN PLACE UNTIL NEW SLOPES AND EXPOSED EARTHEN SURFACES ARE STABILIZED AND HAVE ACHIEVED A MINIMUM OF 80% OF VEGETATIVE COVER IN ACCORDANCE WITH NYS SPDES GP-0-20-001 OR AS ORDERED BY DIRECTOR'S REPRESENTATIVE.
- 3. OTHER EROSION PROTECTION MEASURES OR STRUCTURES MAY BE REQUIRED AS CONDITIONS WARRANT, INCLUDING SILT FENCE, SEEDING, TEMPORARY MULCHING, STABILIZATION BLANKETS, ETC. PROVIDE PROTECTION FOR WATER BODIES ADJACENT TO OR DOWN GRADIENT FROM THE PROJECT AND PROTECT ADJACENT PROPERTIES FROM DAMAGE UNTIL DISTURBED AREAS HAVE BEEN PERMANENTLY STABILIZED. REPLACE OR REPAIR EROSION CONTROL STRUCTURES THAT FAIL AS QUICKLY AS POSSIBLE.
- 4. TAKE APPROPRIATE MEASURES TO PREVENT CONTAMINATION OF WATER BODIES OR DRAINAGE SYSTEM BY SILT, SEDIMENT, FUELS, SOLVENTS, LUBRICANTS, EPOXY COATINGS OR PAINT, CONCRETE LEACHATE, DUST OR POLLUTION ASSOCIATED WITH CONSTRUCTION OPERATIONS.
- 5. RING STOCKPILES OF ERODIBLE MATERIAL WITH SILT FENCE OR FILTER SOCK. STABILIZE STOCKPILES EXPOSED FOR LONGER THAN 14 DAYS WITH TEMPORARY SEED AND MULCH, COVERED, OR OTHER MEANS OF TEMPORARY STABILIZATION PROVIDED.
- 6. PROPERLY ANCHOR STABILIZATION MATTING (ALSO KNOWN AS EROSION CONTROL BLANKETS) AFTER TOPSOILING AND SEEDING ON DISTURBED SURFACES WITH SLOPES EQUAL TO OR GREATER THAN 3:1.
- 7. CONSTRUCT STABILIZED CONSTRUCTION ENTRANCE(S) AND EQUIPMENT AND MATERIAL STORAGE AREA. LOCATIONS TO BE COORDINATED WITH DIRECTOR'S REPRESENTATIVE. STABILIZE BARE AREAS IN ENTRANCES, CONSTRUCTION ROUTES, OR EQUIPMENT AREAS IMMEDIATELY.
- 8. MAINTAIN EROSION AND SEDIMENT CONTROL FEATURES UNTIL VEGETATION OR SEEDING HAS BEEN ESTABLISHED. AFTER ACCEPTANCE OF RESTORATION BY THE DIRECTOR'S REPRESENTATIVE, REMOVE TEMPORARY EROSION AND SEDIMENT CONTROL FEATURES.
- 9. THE CONTRACTOR SHALL NOTIFY THE BUILDING DEPARTMENT OR VILLAGE'S CONSULTING ENGINEER IN WRITING AT LEAST 48 HOURS BEFORE ANY OF THE FOLLOWING SO THAT INSPECTION MAY BE PERFORMED:
- 9.1. START OF CONSTRUCTION
- 9.2. INSTALLATION OF SEDIMENT AND EROSION CONTROL MEASURES
- 9.3. COMPLETION OF SITE CLEARING
- 9.4. COMPLETION OF ROUGH GRADING
- 9.5. INSTALLATION OF SMPs 9.6. COMPLETION OF FINAL GRADING AND STABILIZATION OF DISTURBED AREAS
- 9.7. CLOSURE OF CONSTRUCTION 9.8. COMPLETION OF FINAL LANDSCAPING
- 10. THE OWNER OR OPERATOR SHALL HAVE A QUALIFIED INSPECTOR INSPECT AND DOCUMENT EFFECTIVENESS OF ALL EROSION AND SEDIMENTATION CONTROL PRACTICES AND PREPARE INSPECTION REPORTS AT LEAST ONCE A MONTH. THESE REPORTS MUST BE KEPT ON SITE AND AVAILABLE FOR REVIEW.

NORTHING

EASTING

RADIUS

EXISTING

POINT OF CURVATURE

POINT OF TANGENCY

NOT FIELD VERIFIED

POINT OF INTERSECTION

BB	REVIATIONS	LEGEND
·C	TOP OF CURB	——— -600-—
C	BOTTOM OF CURB	
Ρ	EDGE OF PAVEMENT	560.5
IM	RIM OF STRUCTURE	
1\	INVERT	ST
/E	MATCH EXISTING	
В	CATCH BASIN	
Ol	DRAINAGE INLET	— Е —
МН	STORM MANHOLE	——— ОНW —
N МН	SANITARY MANHOLE	—— w ———
1H	MANHOLE	—— G ———
0	CLEANOUT	— x — x — x –
G	TOP OF GRATE) (
/C	POLYVINYL CHLORIDE	(A)
PE	HIGH DENSITY POLYETHYLENE	S
CP	REINFORCED CONCRETE PIPE	
IP	DUCTILE IRON PIPE	co
IP	CAST IRON PIPE	₽ w
MP	CORRUGATED METAL PIPE	∇
/ V	WATER VALVE	- o -
EV	ELEVATION	
	NODTUNO	

_____ -----

SAWCUT PAVEMENT BOLLARD BASELINE ------ COMM (QLB) ------ COMMUNICATION LINE - LEVEL B ———UE (QLB)——— ELECTRIC LINE - LEVEL B SLOPE - TOP/BOTTOM ______ ———UNK (QLB)——— UNKNOWN LINE - LEVEL B

EXISTING CONTOUR

PROPOSED CONTOUR PROPOSED SPOT ELEVATION PROPERTY LINE STORM LINE PERFORATED UNDERDRAIN SANITARY SEWER LINE

ELECTRIC LINE OVERHEAD WIRE WATER LINE GAS LINE CHAINLINK FENCE

— x — LIGHT POLE SANITARY MANHOLE STORM MANHOLE CATCH BASIN

CLEANOUT WATER VALVE FIRE HYDRANT

SIGNAGE TREE PROTECTION FENCING SILT FENCE/FILTER SOCK

TEMPORARY INLET PROTECTION **DEMO ASPHALT PAVEMENT** ASPHALT PAVEMENT

HEAVY DUTY ASPHALT PAVEMENT

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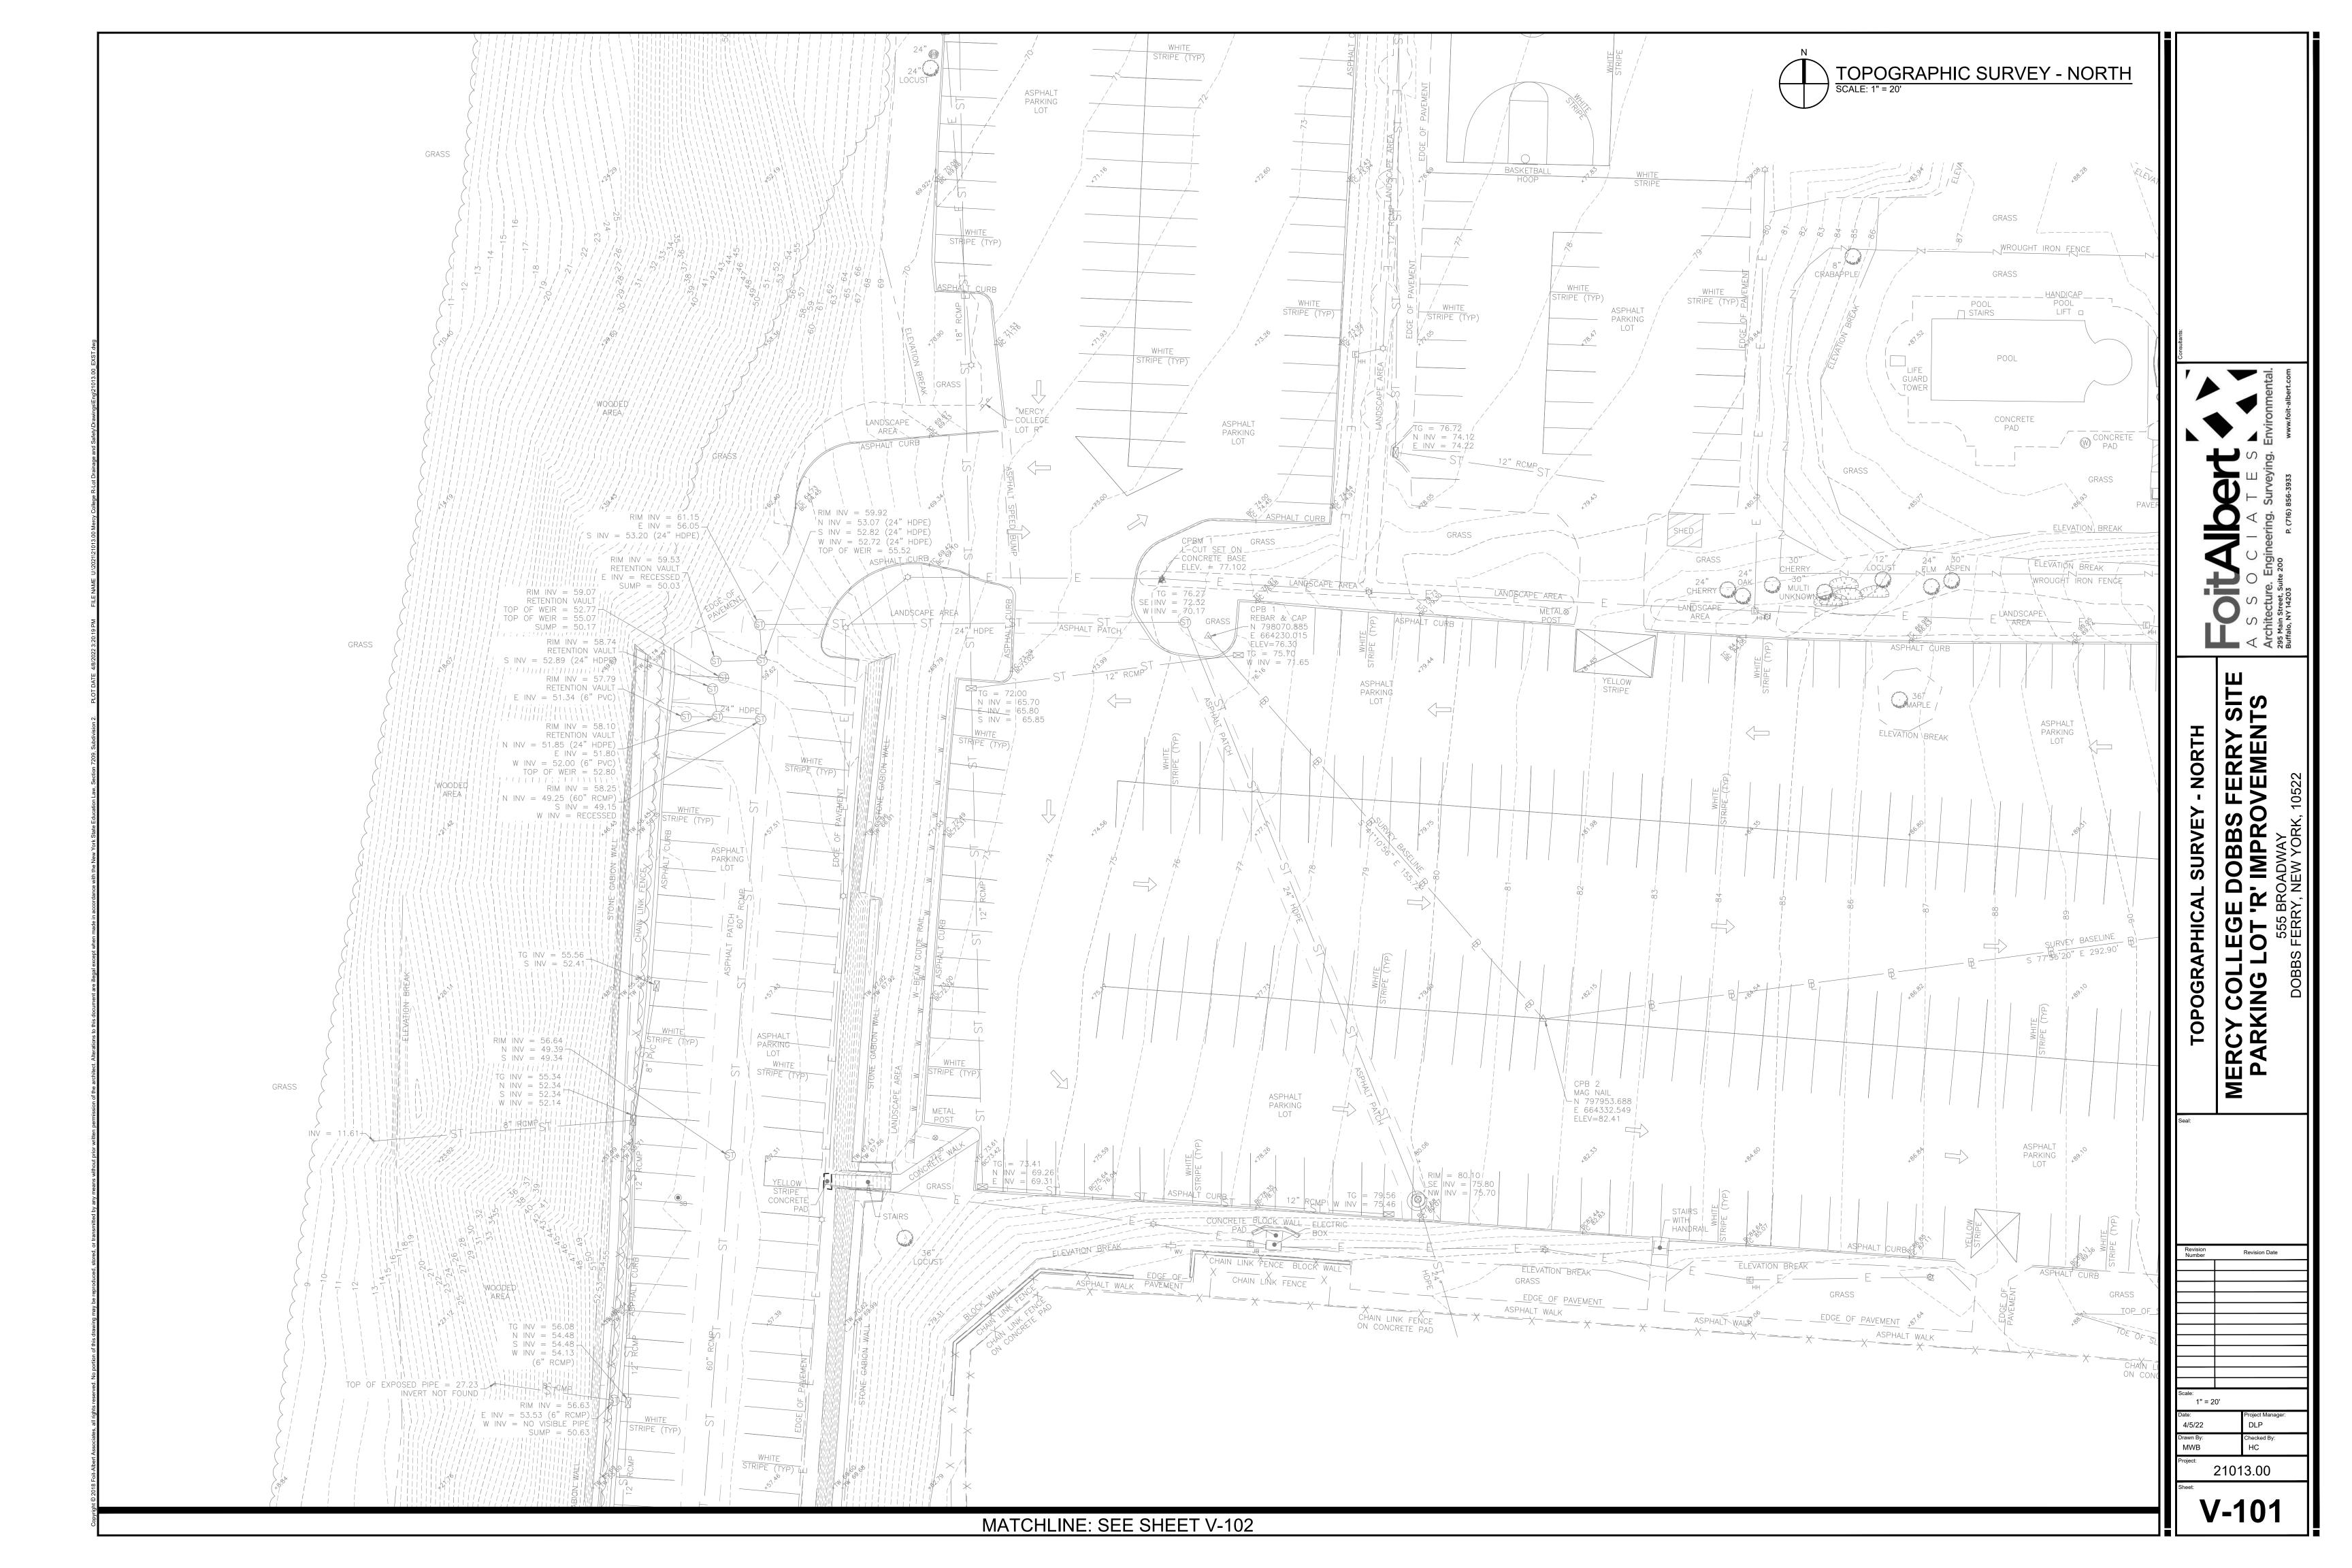
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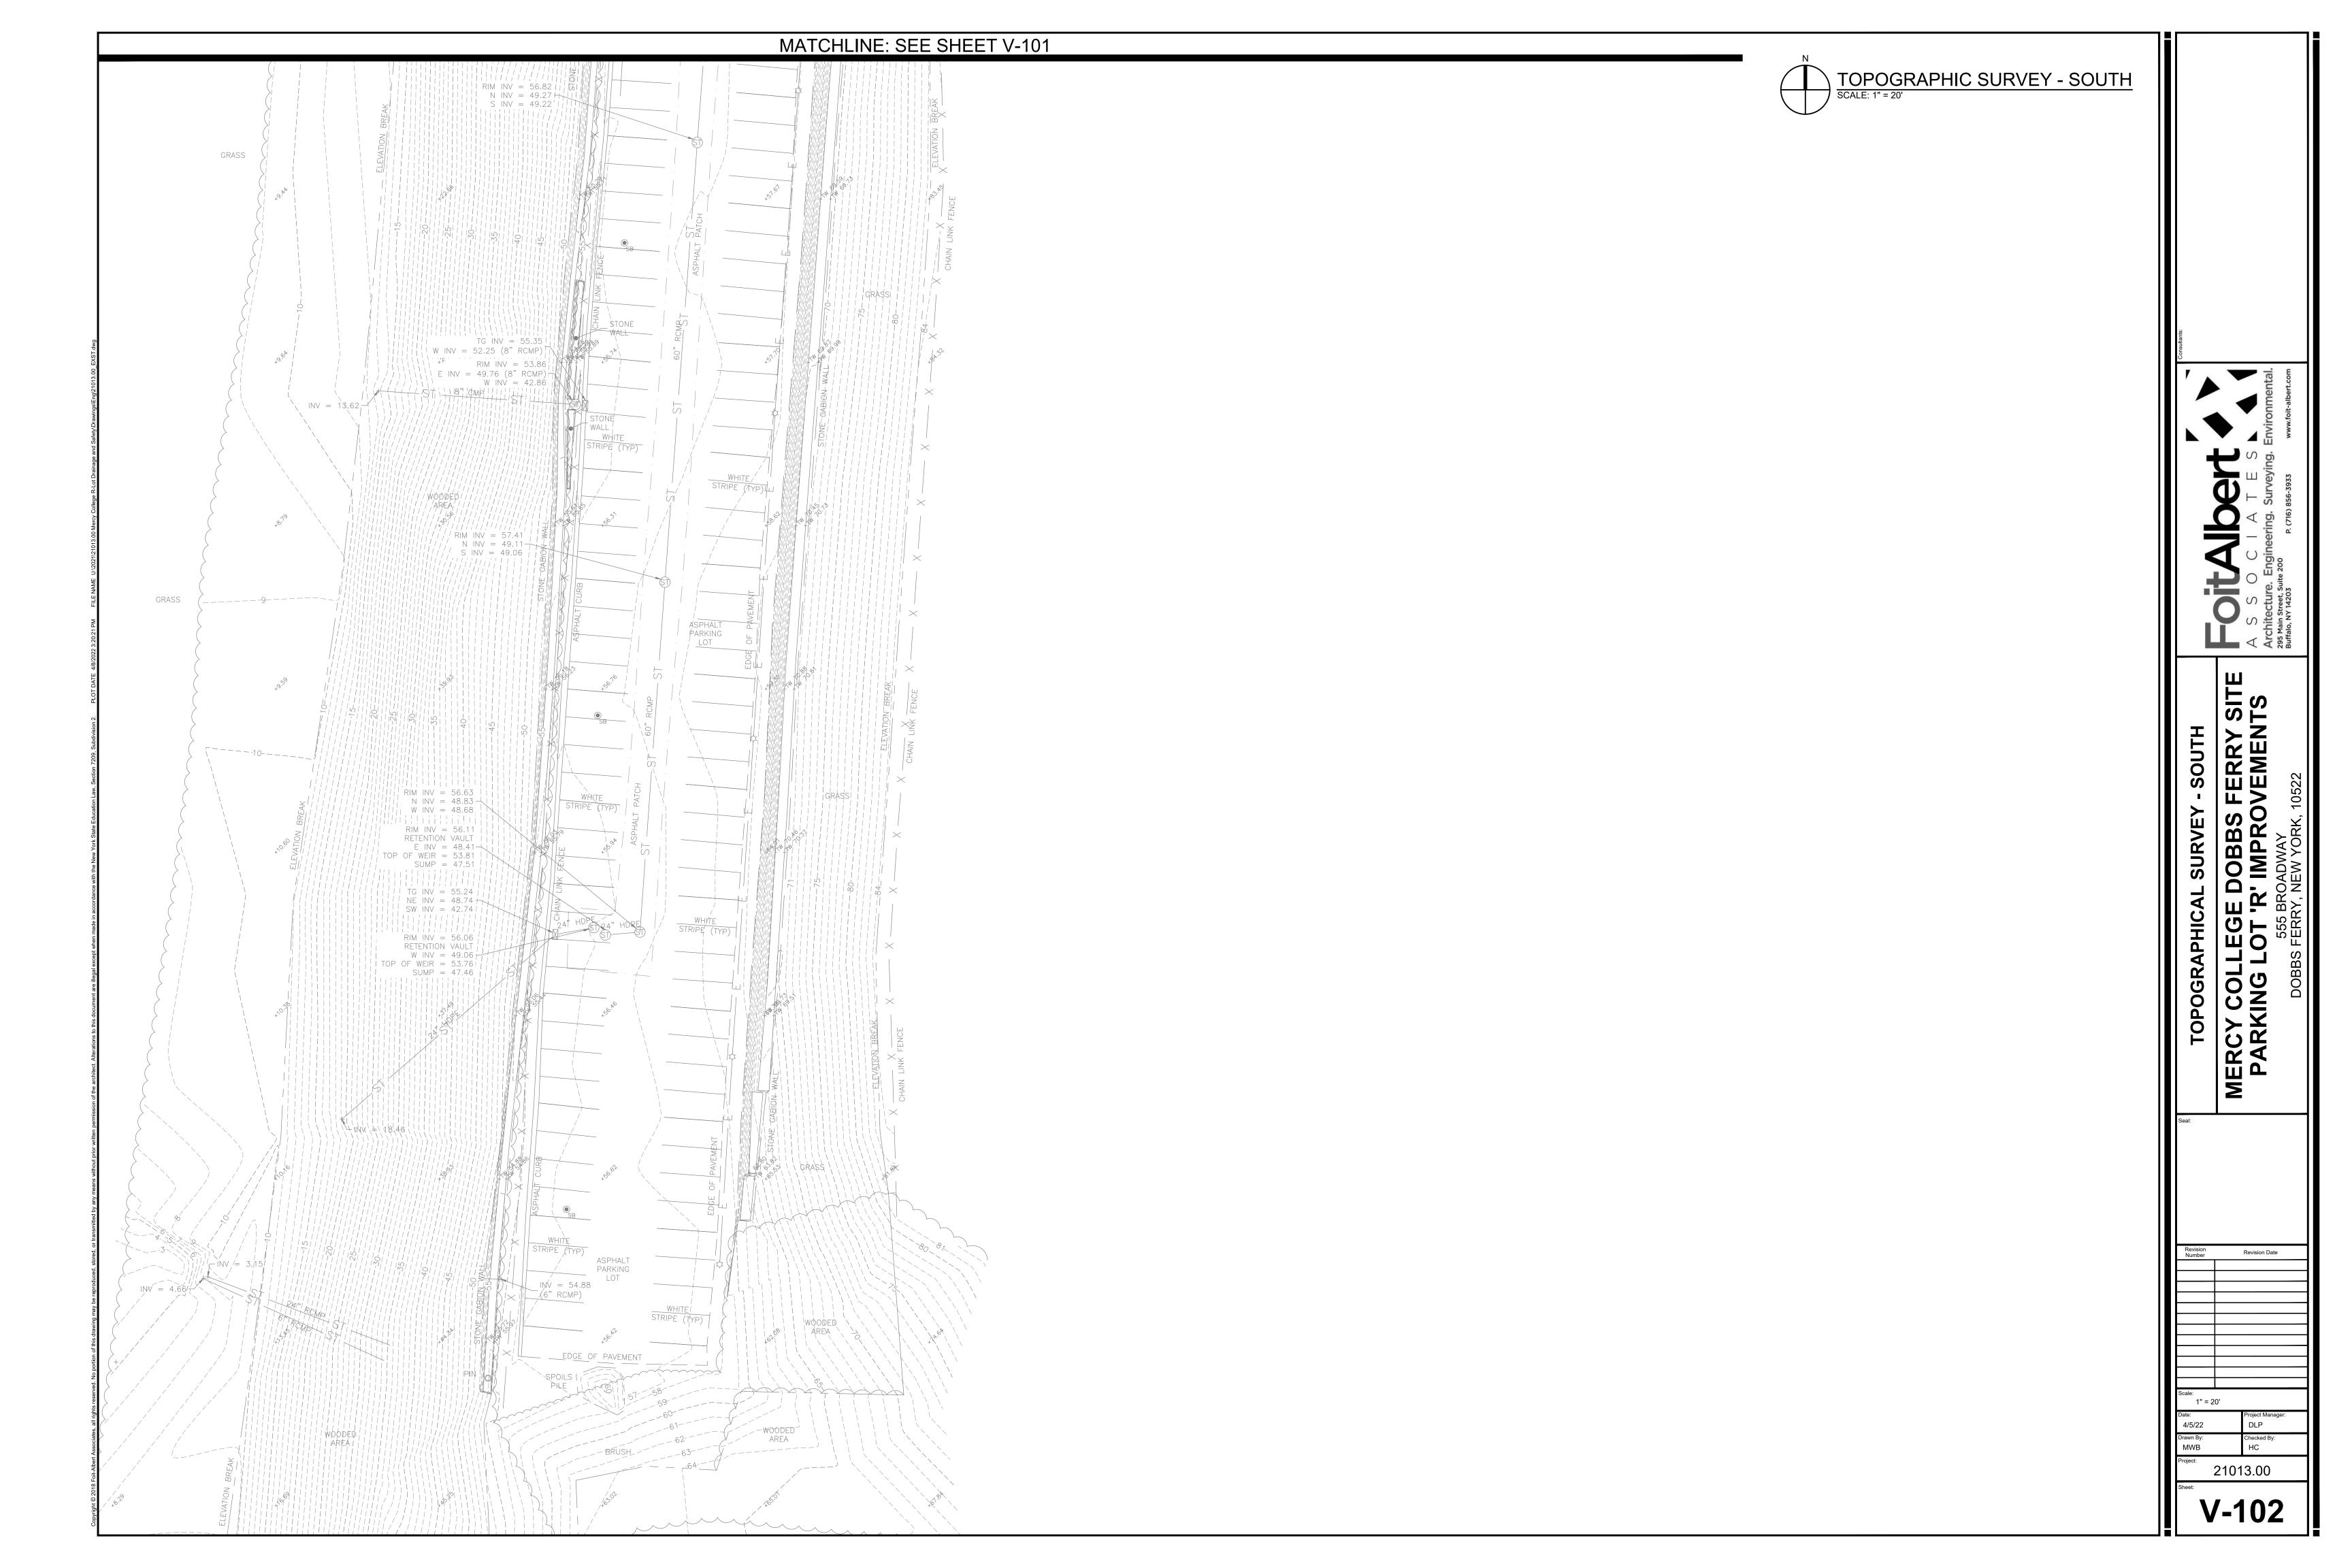
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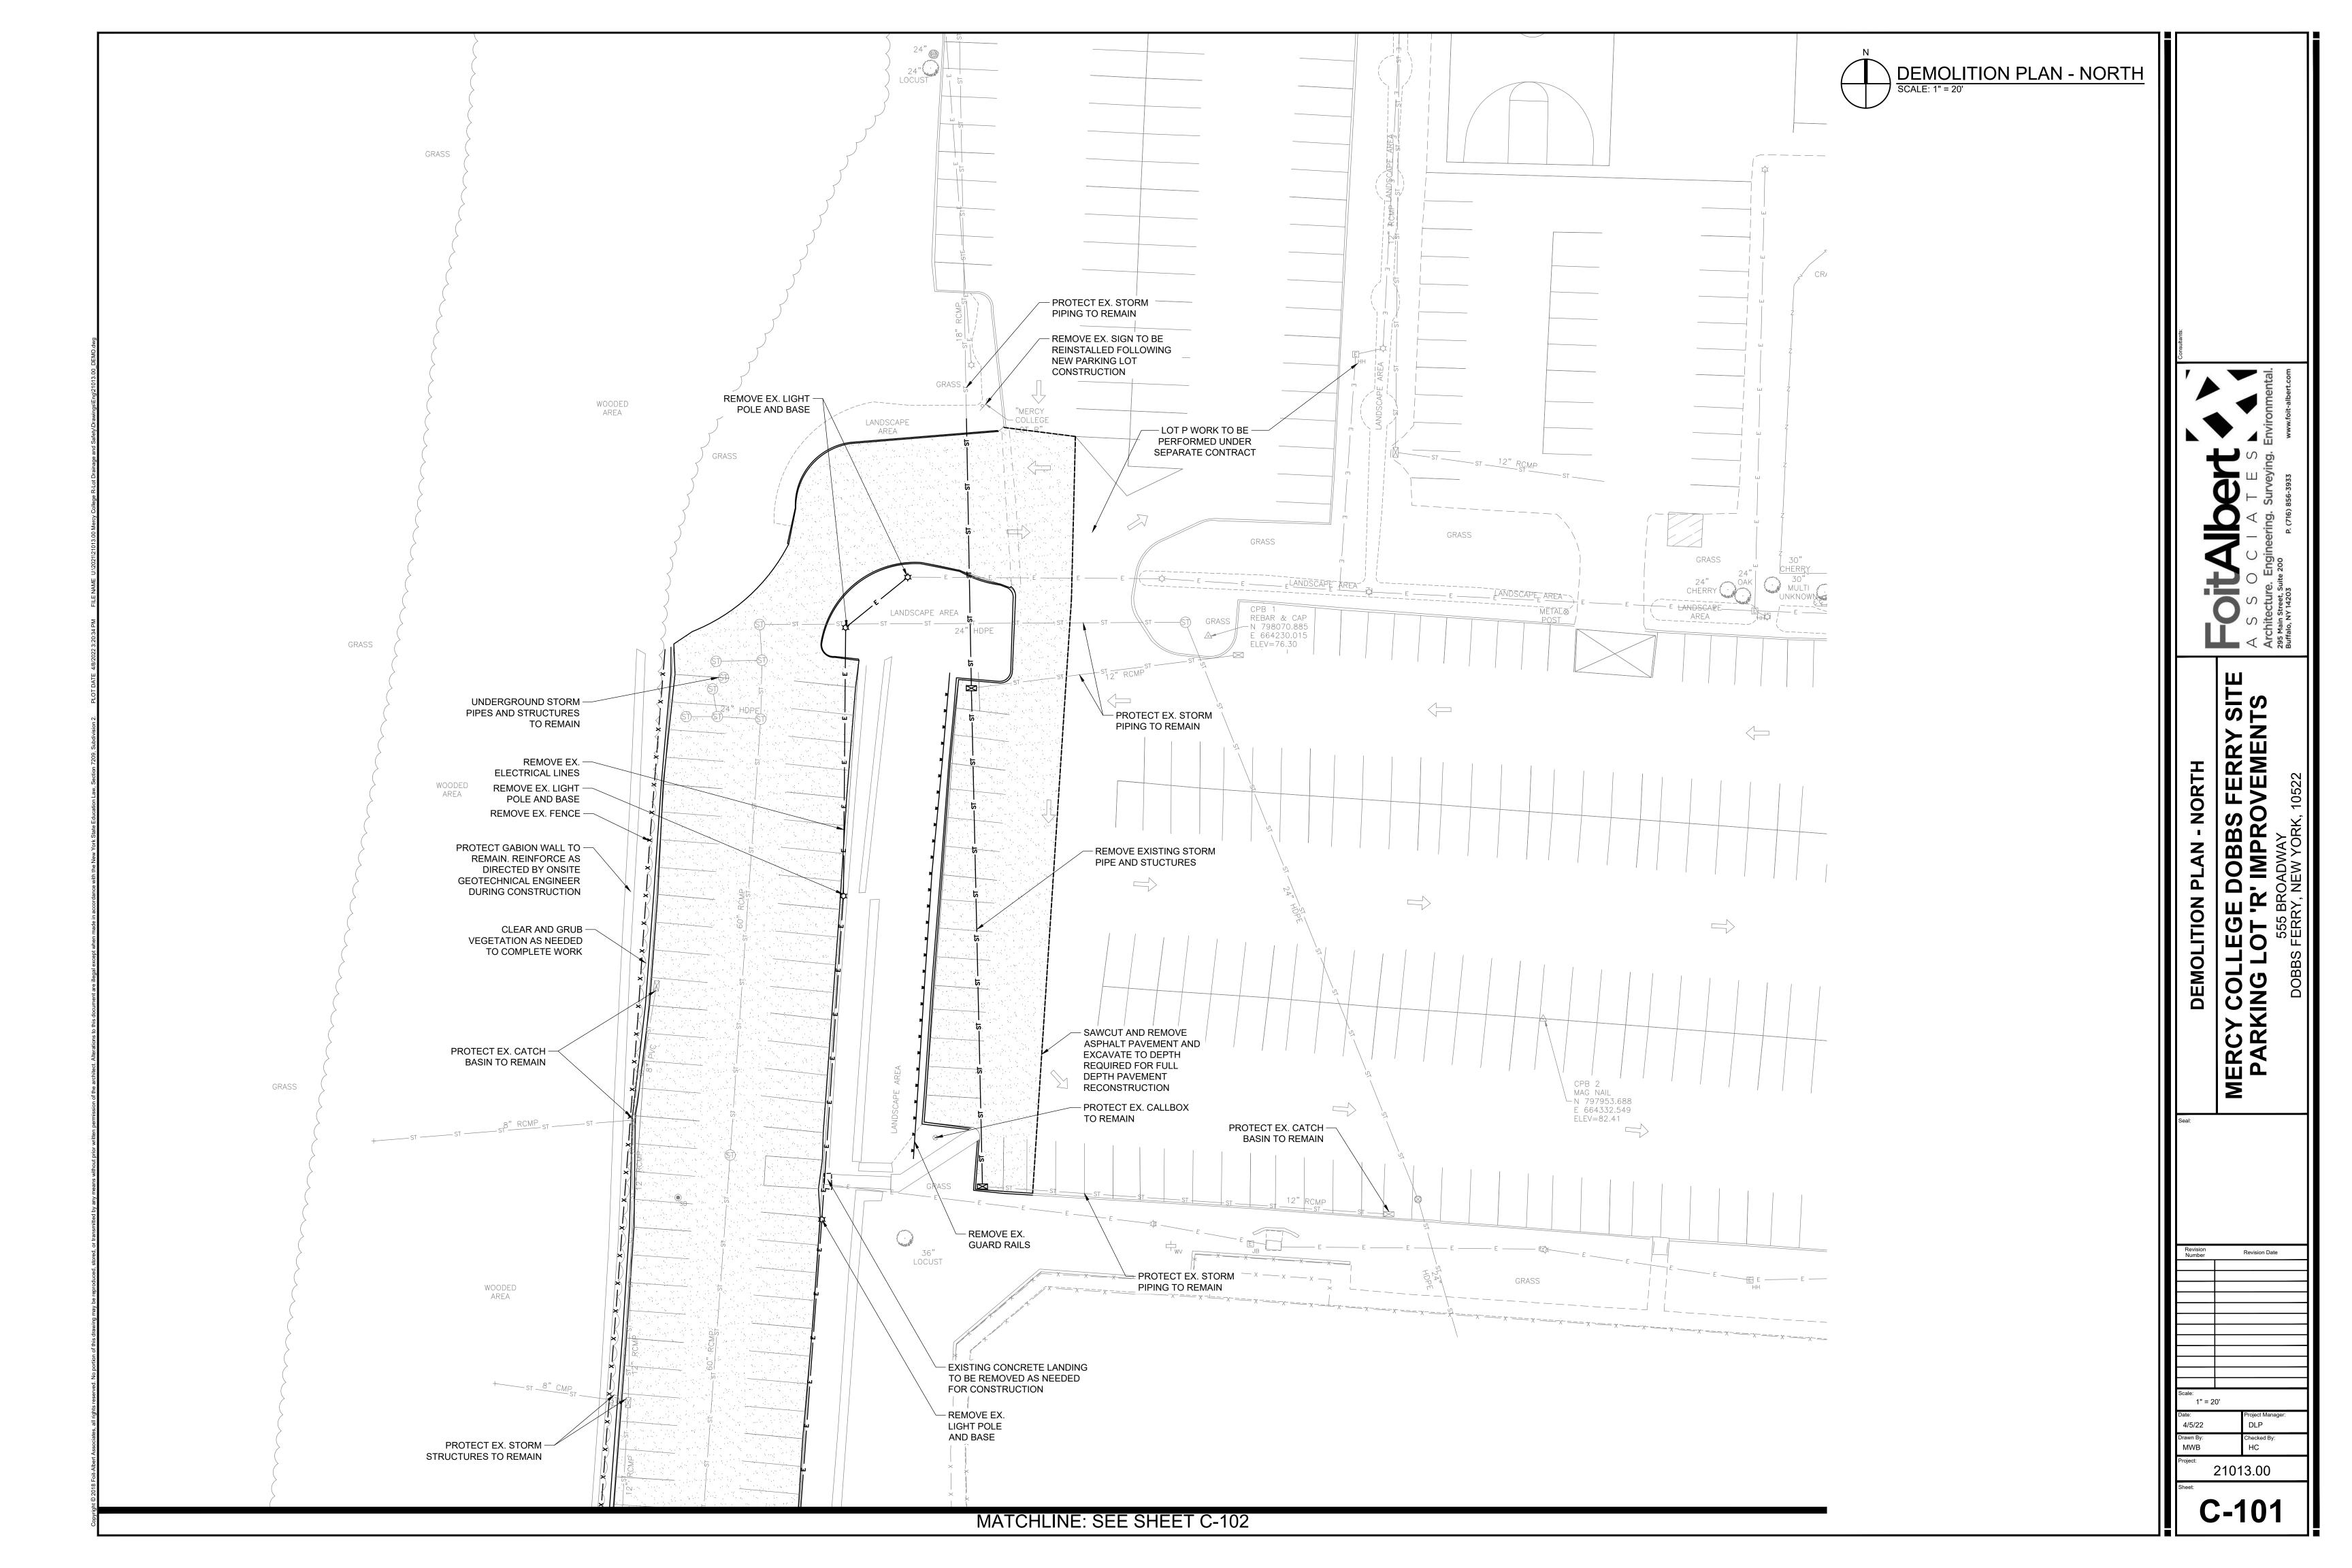
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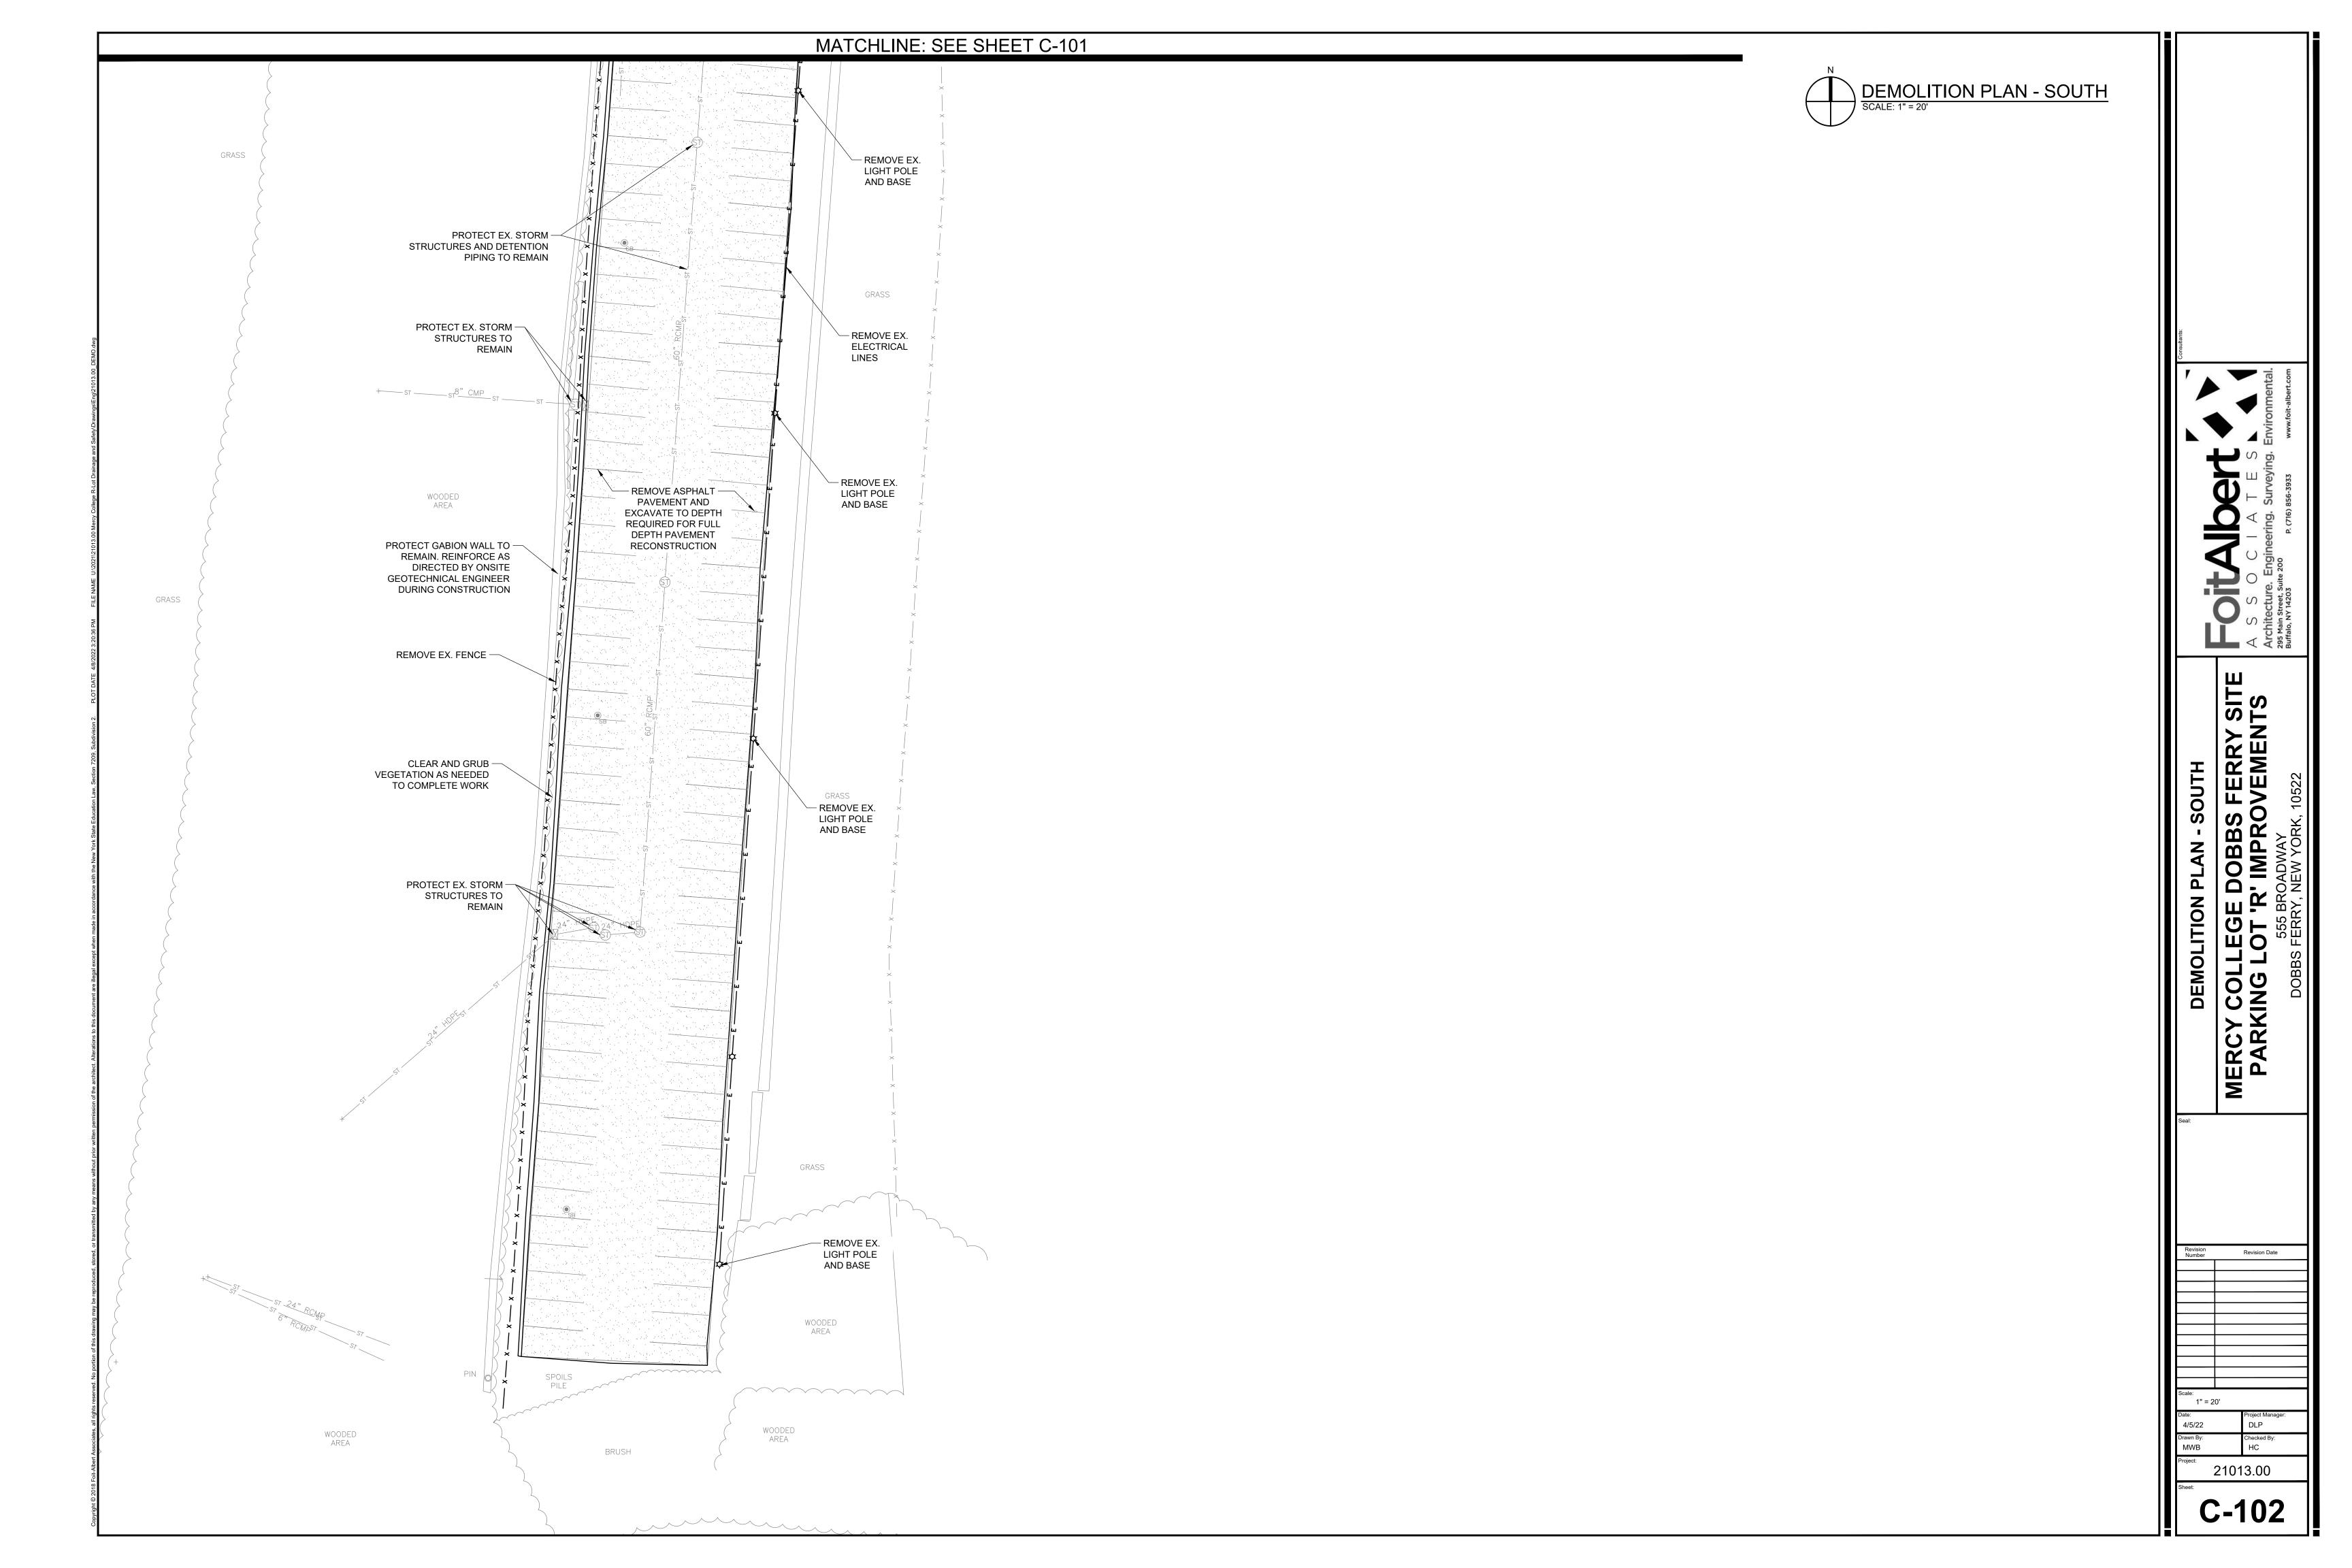
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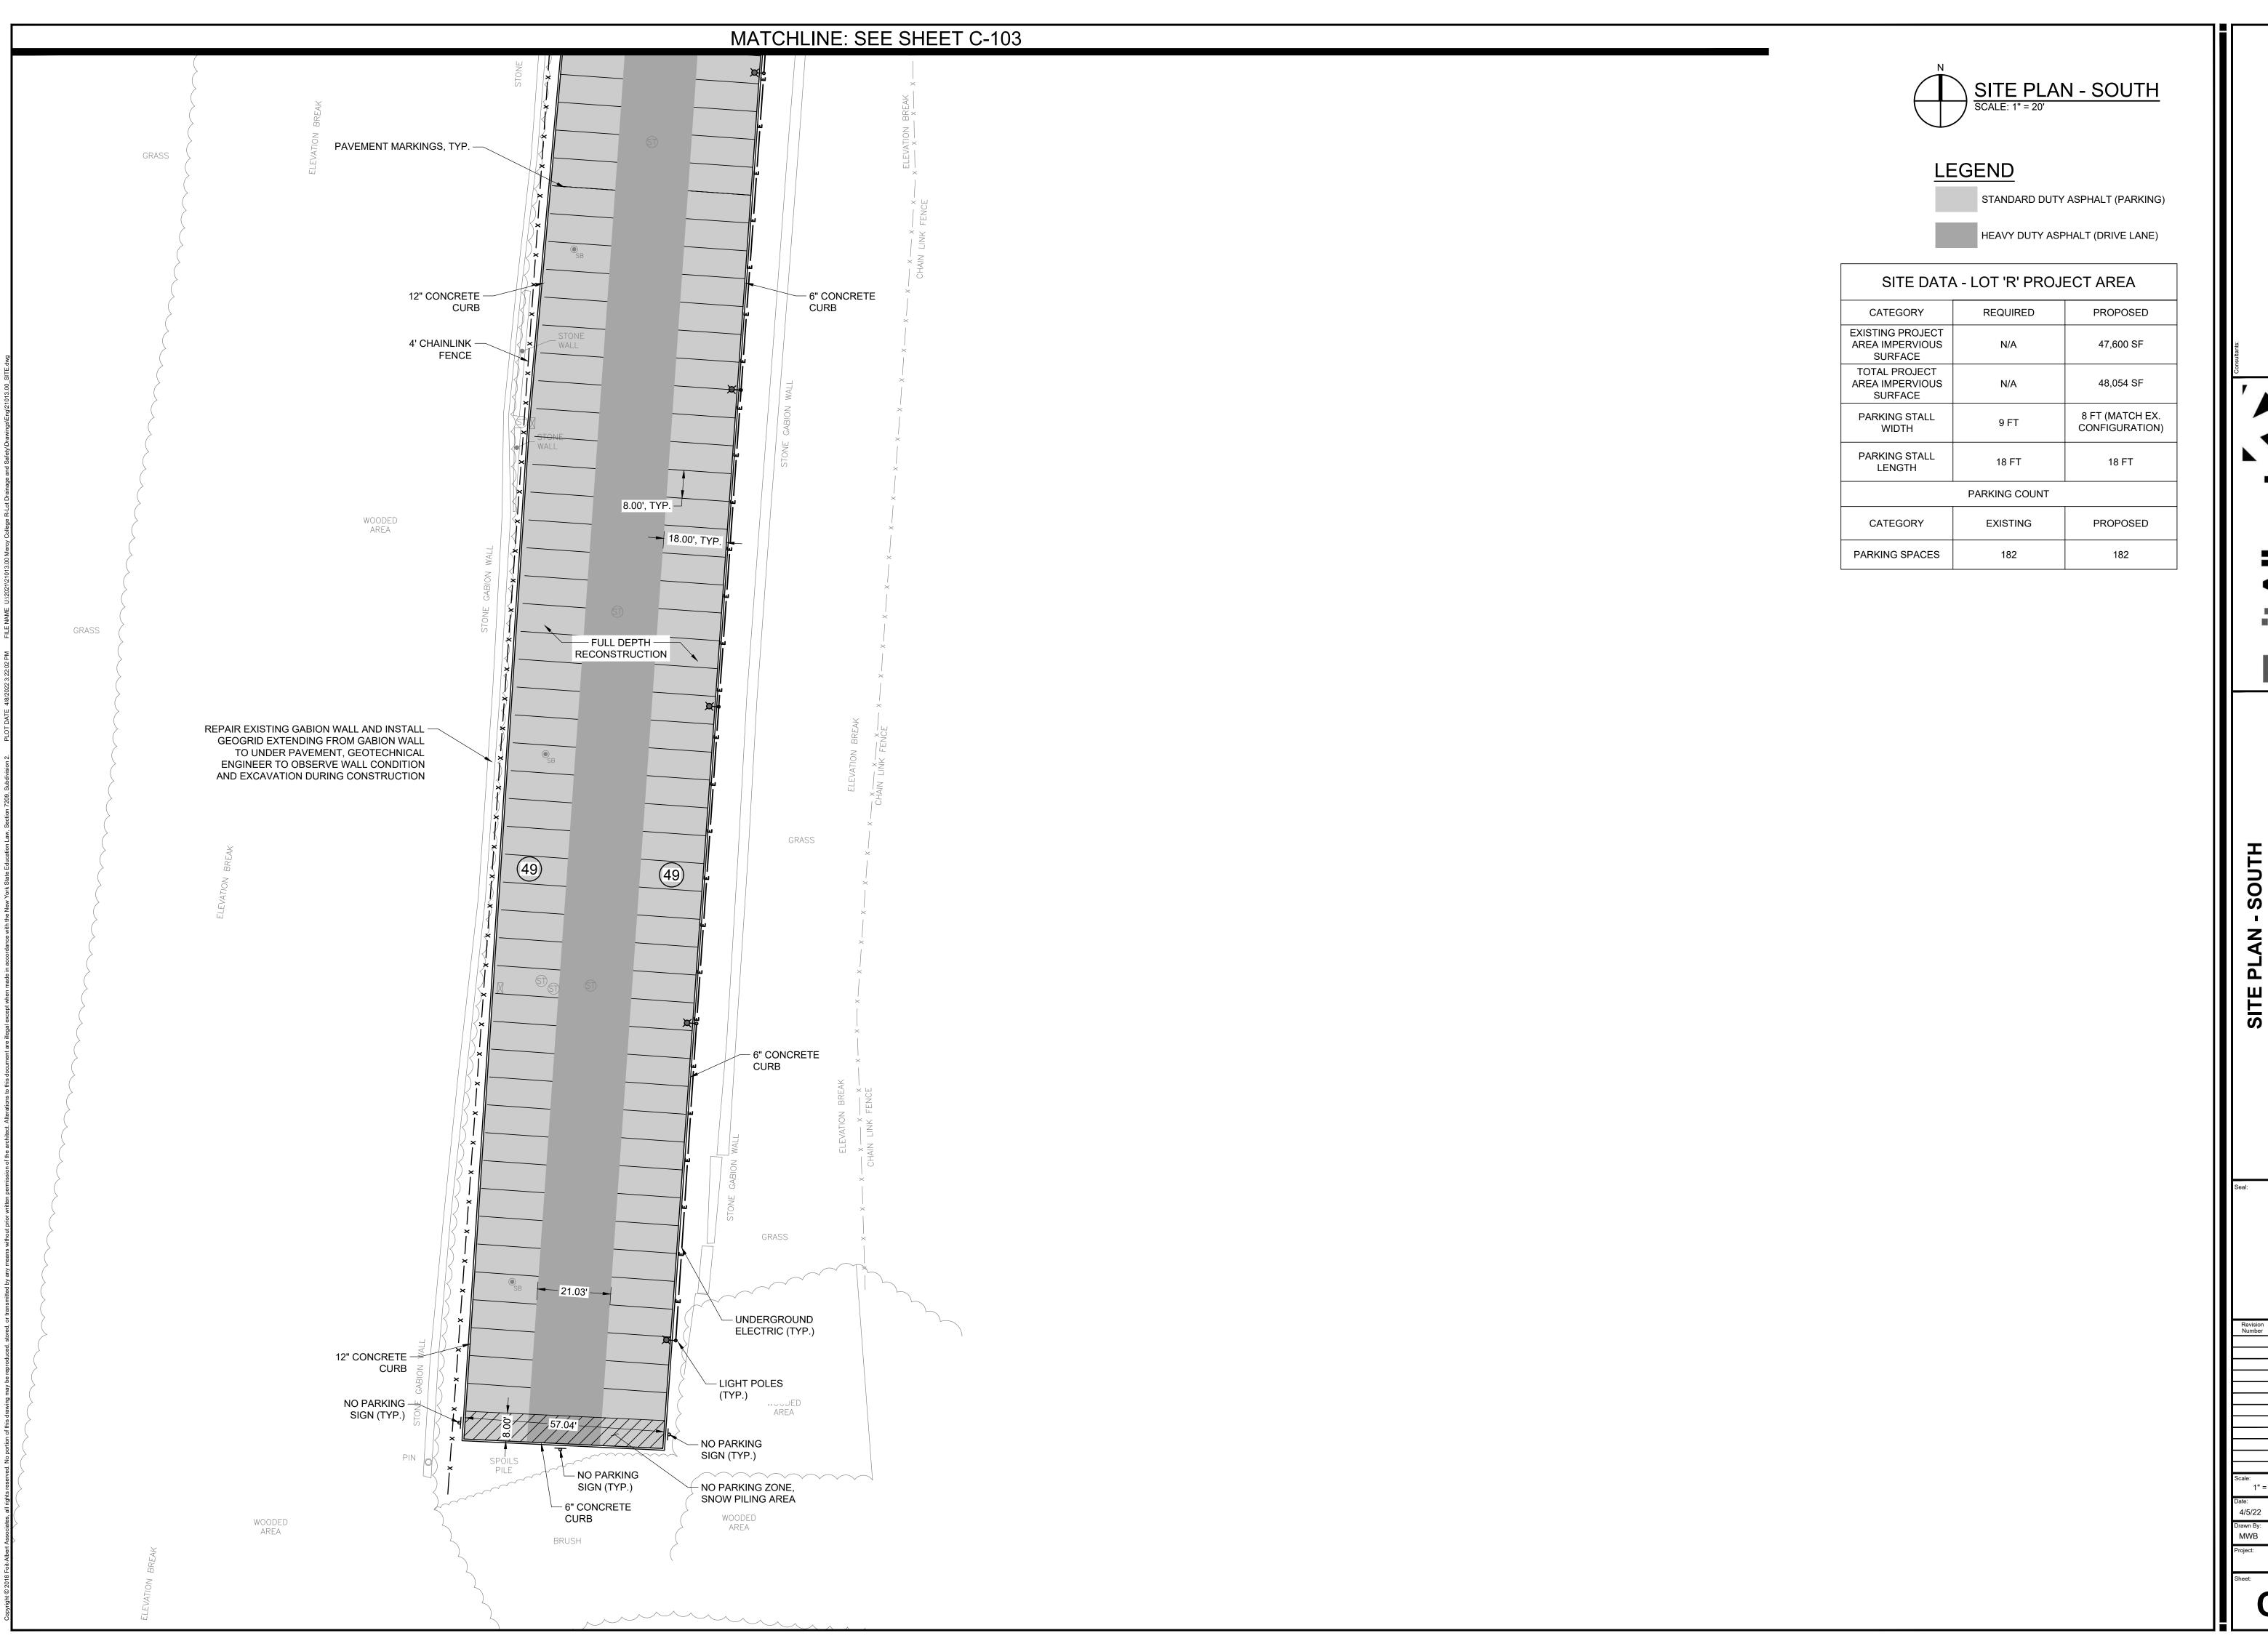












SOCIATE Surveying. Environment Surveying. Environment Surveying. Environment Surveying. Environment Surveying. Environment Surveying.

MERCY COLLEGE DOBBS FERR
PARKING LOT 'R' IMPROVEME


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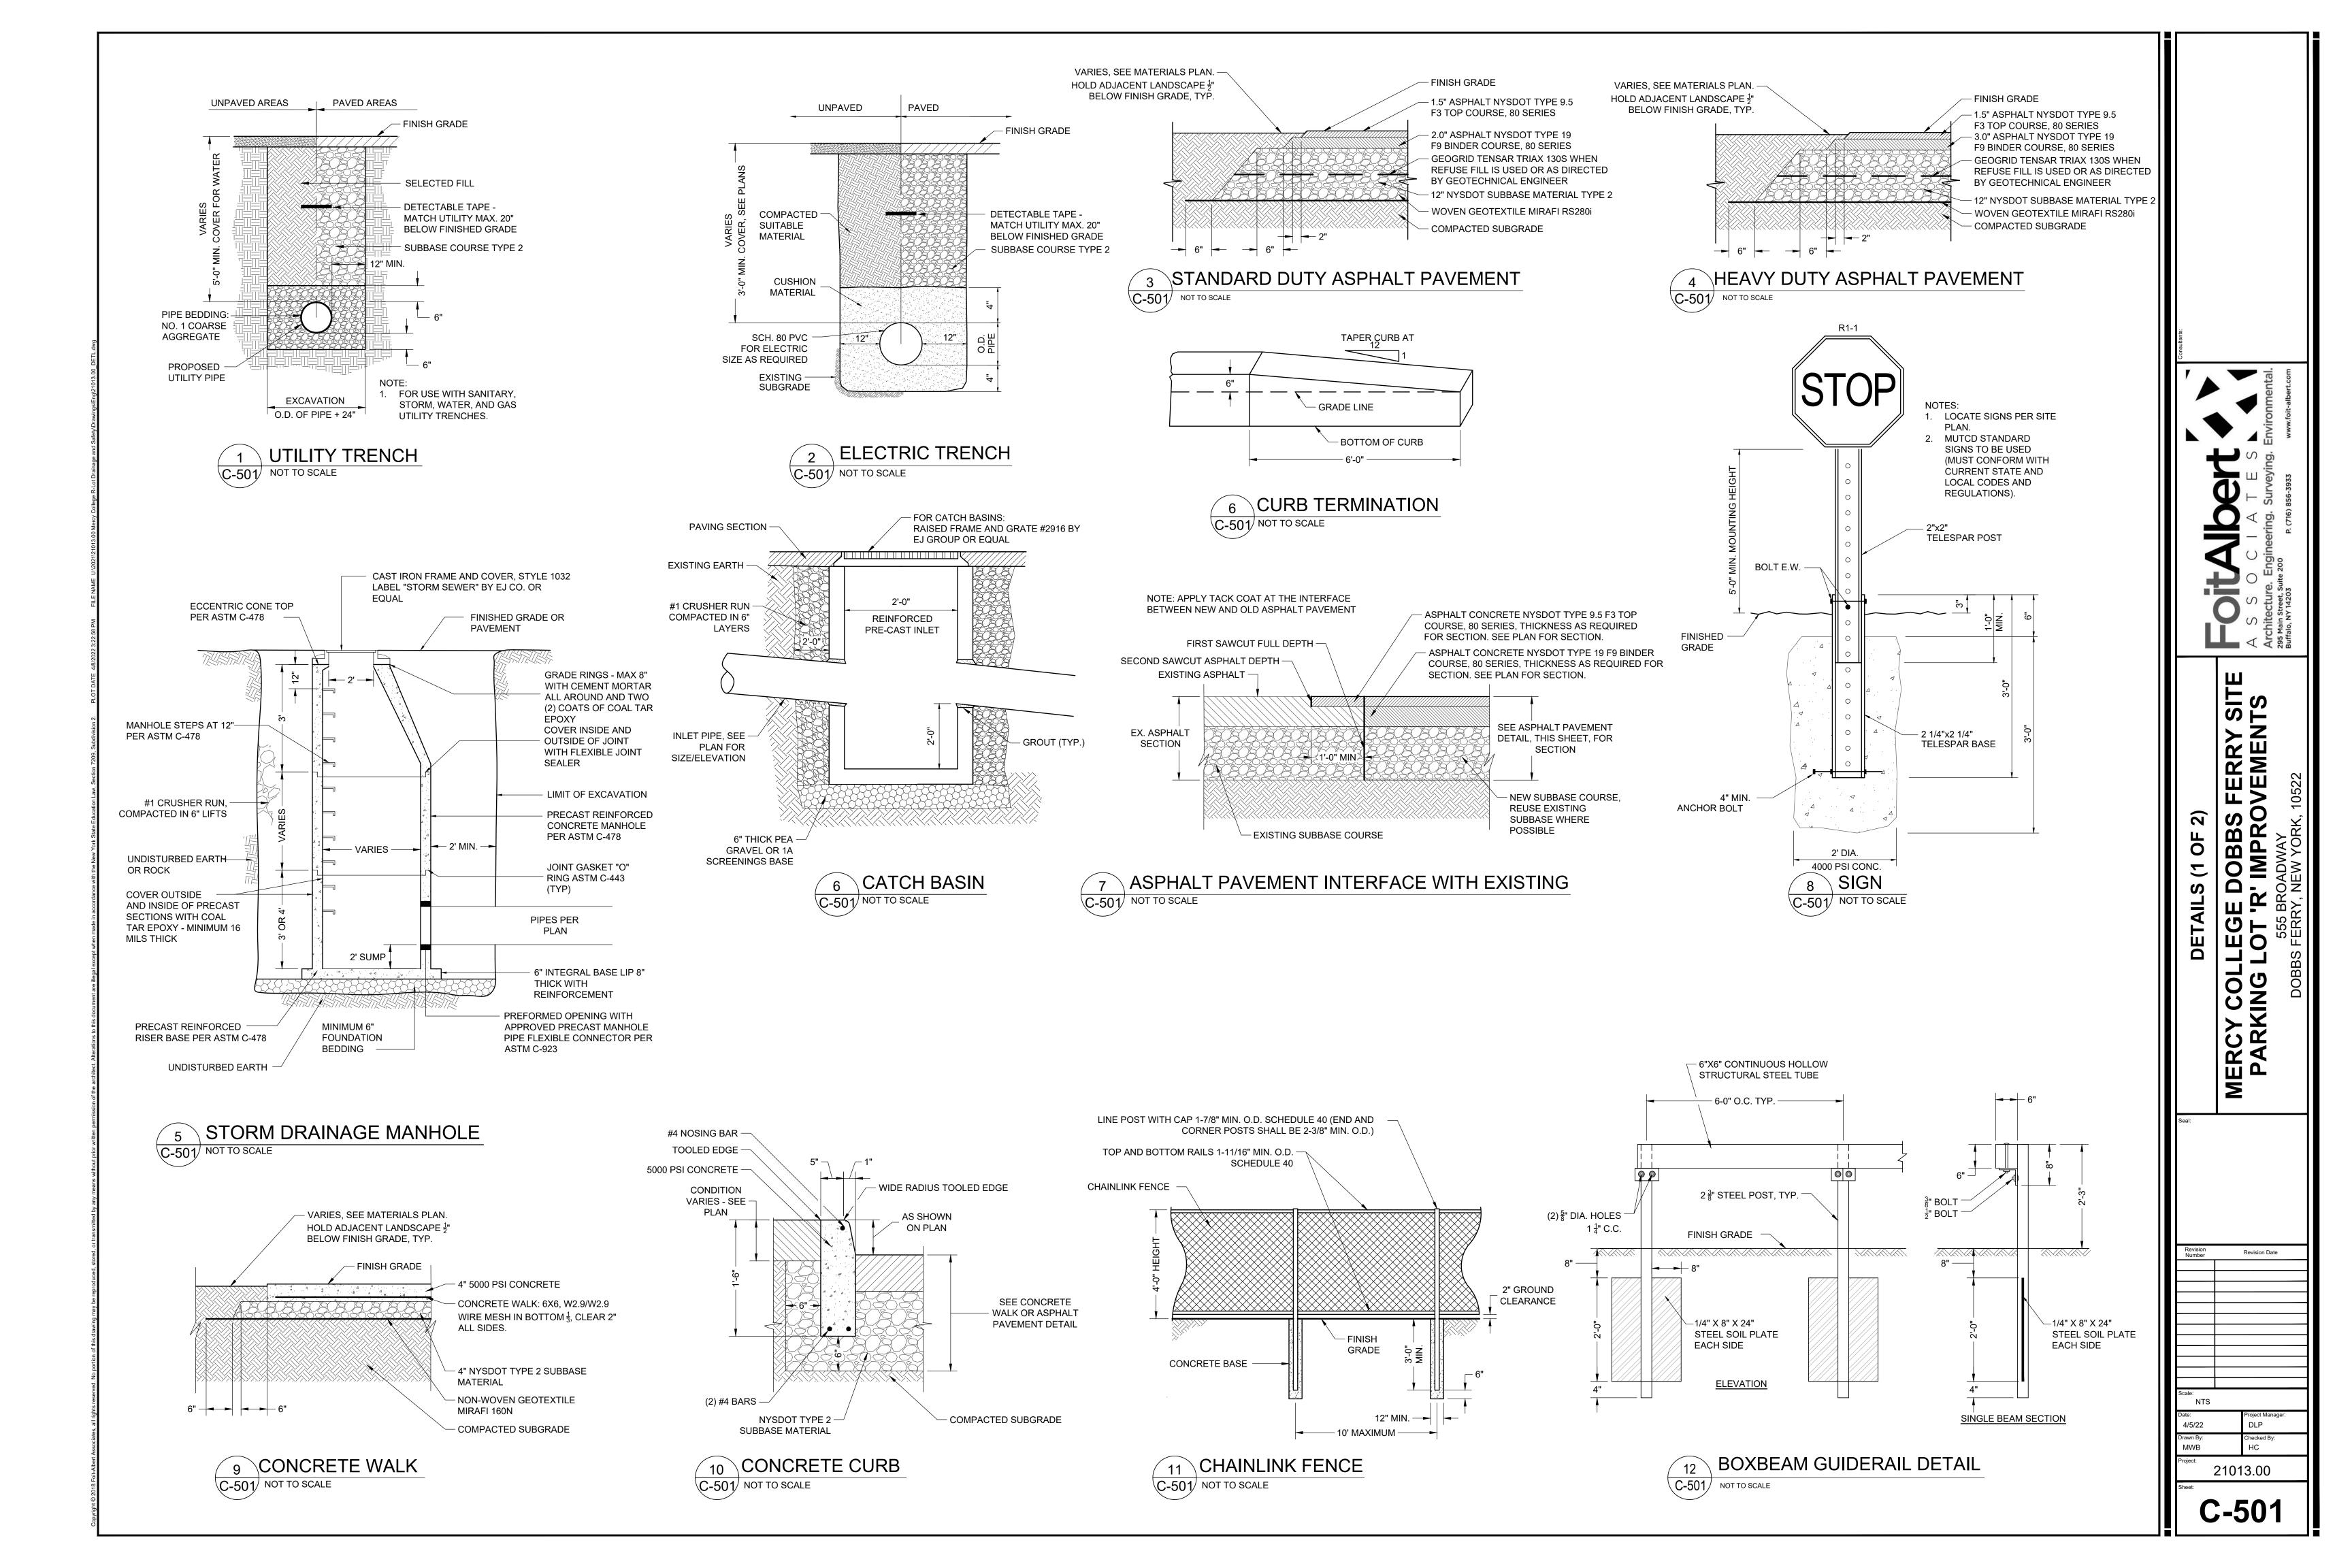
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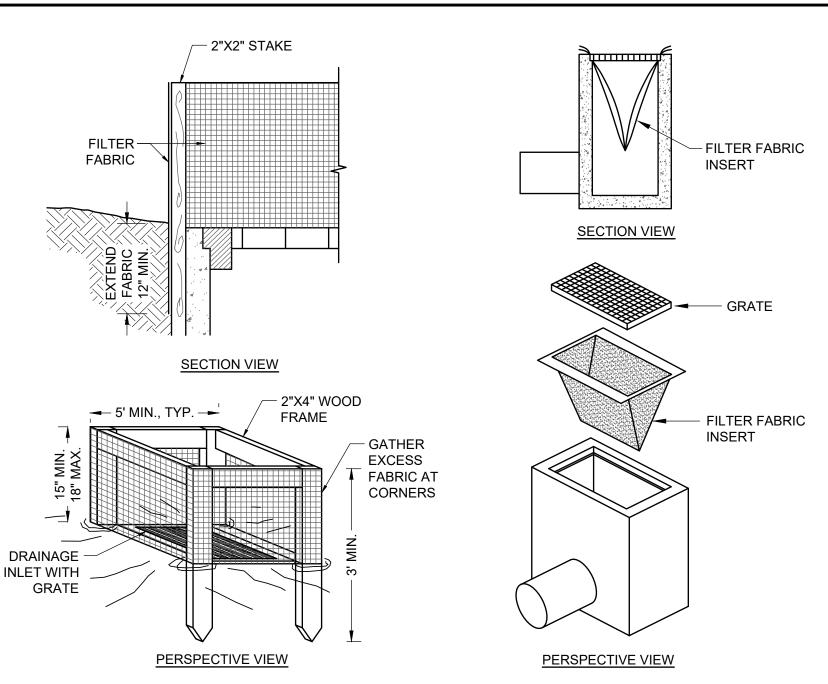
Project Manager:
DLP
Checked By:
HC

C-10







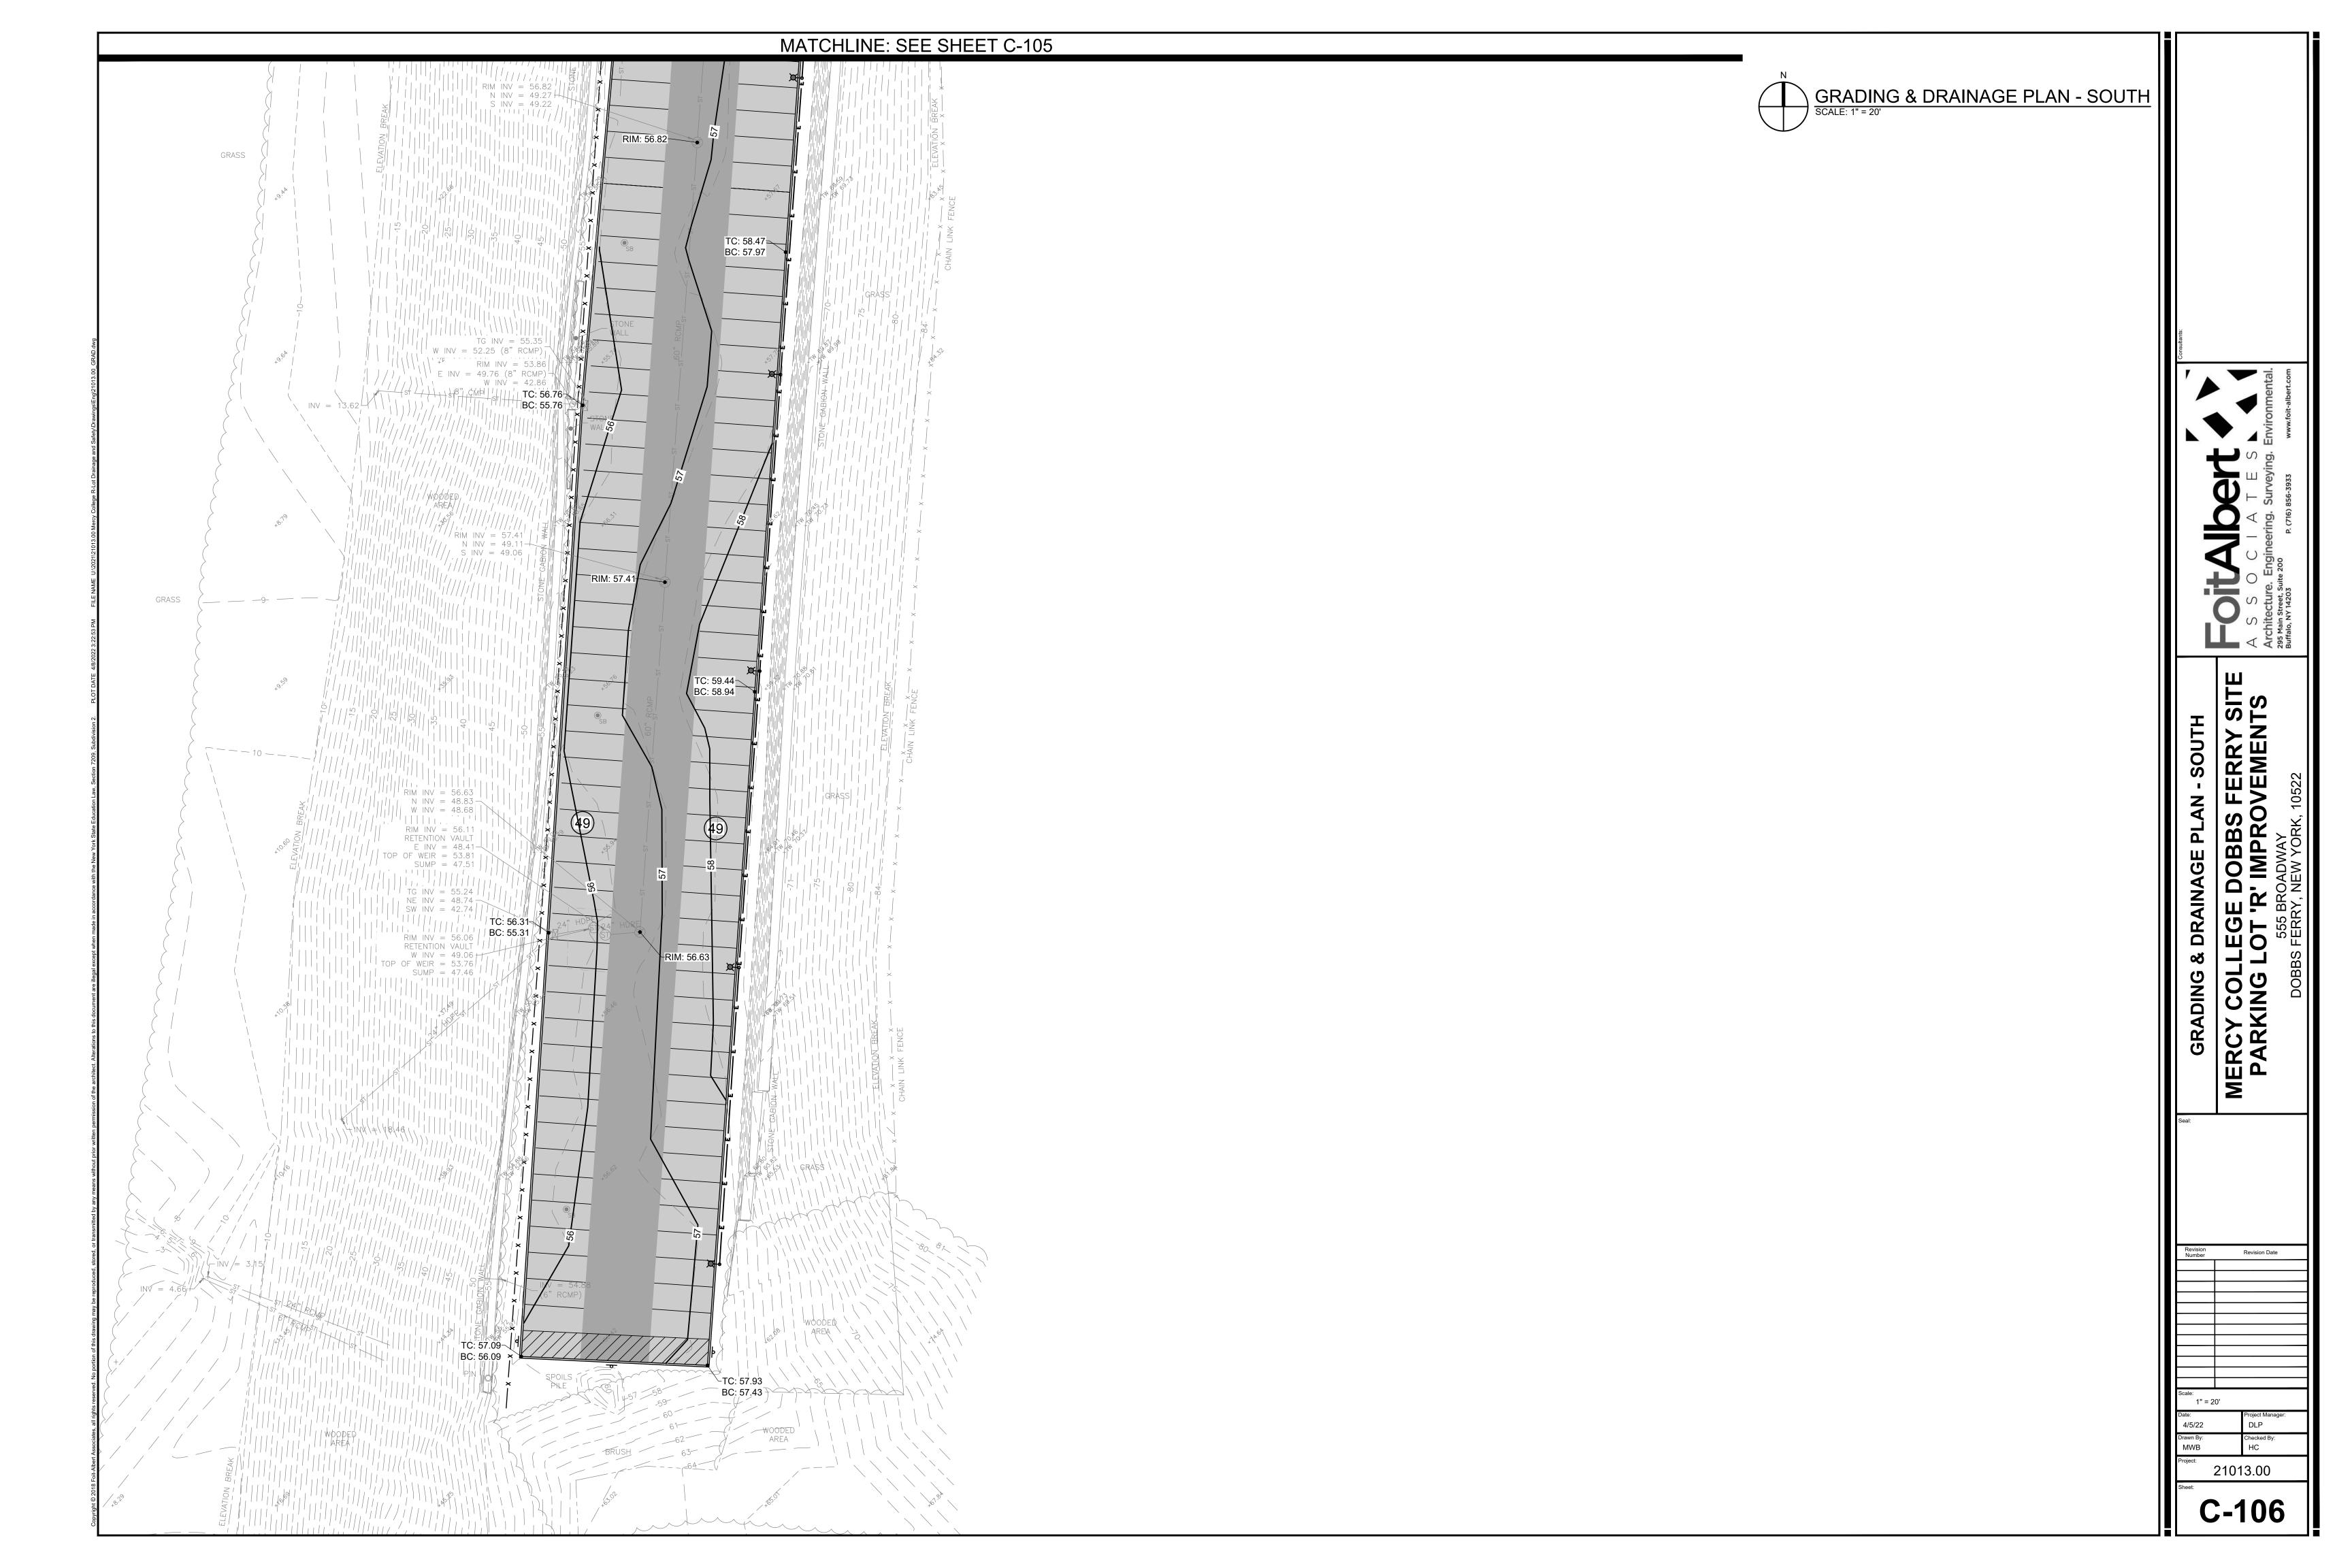

SILT FENCE INLET PROTECTION (FOR UNPAVED AREAS)

FILTER FABRIC INLET PROTECTION (FOR PAVED AREAS)

SILT FENCE INLET PROTECTION NOTES:

- FILTER FABRIC SHALL HAVE AN EOS OF 40-85. BURLAP MAY BE USED FOR SHORT TERM APPLICATIONS.
 CUT FABRIC FROM A CONTINUOUS ROLL TO ELIMINATE JOINTS. IF JOINTS ARE NEEDED THEY WILL BE
- OVERLAPPED TO THE NEXT STAKE.


 3. STAKE MATERIALS WILL BE STANDARD 2"X4" WOOD OR EQUIVALENT. METAL WITH A MINIMUM LENGTH OF 3 FEET.
- 4. SPACE STAKES EVENLY AROUND INLET 3 FEET APART AND DRIVE A MINIMUM 18 INCHES DEEP. SPANS GREATER THAN 3 FEET MAY BE BRIDGED WITH THE USE OF WIRE MESH BEHIND THE FILTER FABRIC FOR SUPPORT.
- 5. FABRIC SHALL BE EMBEDDED 1 FOOT MINIMUM BELOW GROUND AND BACKFILLED. IT SHALL BE SECURELY
- FASTENED TO THE STAKES AND FRAME.

 6. A 2"X4" WOOD FRAME SHALL BE COMPLETED AROUND THE CREST OF THE FABRIC FOR OVER FLOW STABILITY.


FILTER FABRIC INLET PROTECTION NOTES:

1. INSPECT ON A WEEKLY BASIS AND REMOVE SILT AS NECESSARY.



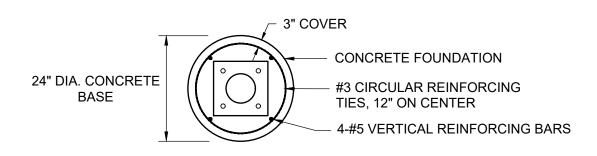


PLAN VIEW

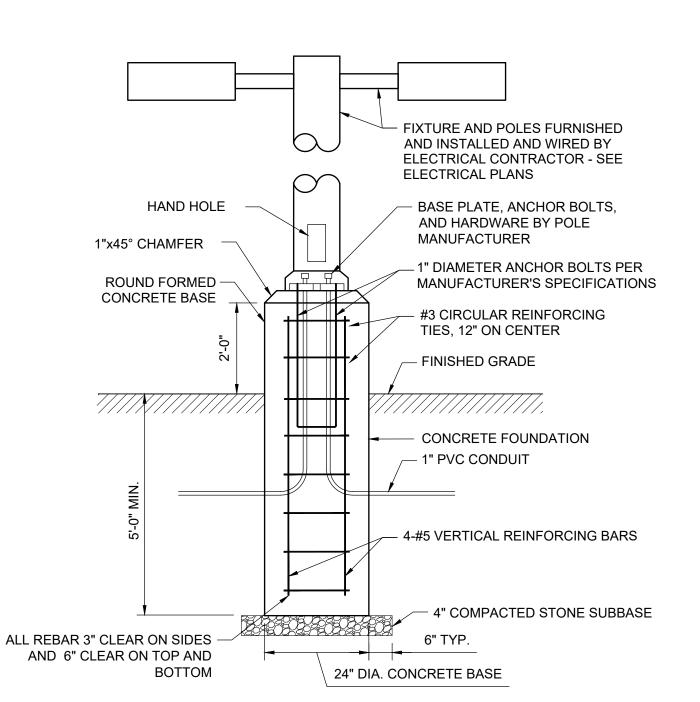

SECTION VIEW




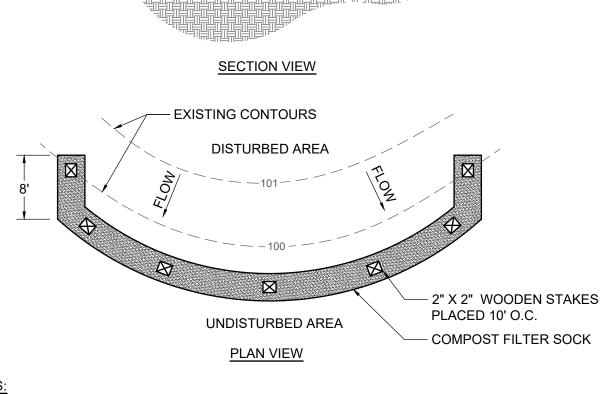


NOTES:

1. WHEN PLACED IN PAVEMENT AREAS, USE CONCRETE BLOCKS OR SANDBAGS AS NEEDED ON THE DOWNSTREAM SIDE OF FILTER SOCKS AND IN PLACE OF WOODEN STAKES TO HOLD FILTER SOCKS IN PLACE.

2 COMPOST FILTER SOCK DETAIL
C-502 NOT TO SCALE

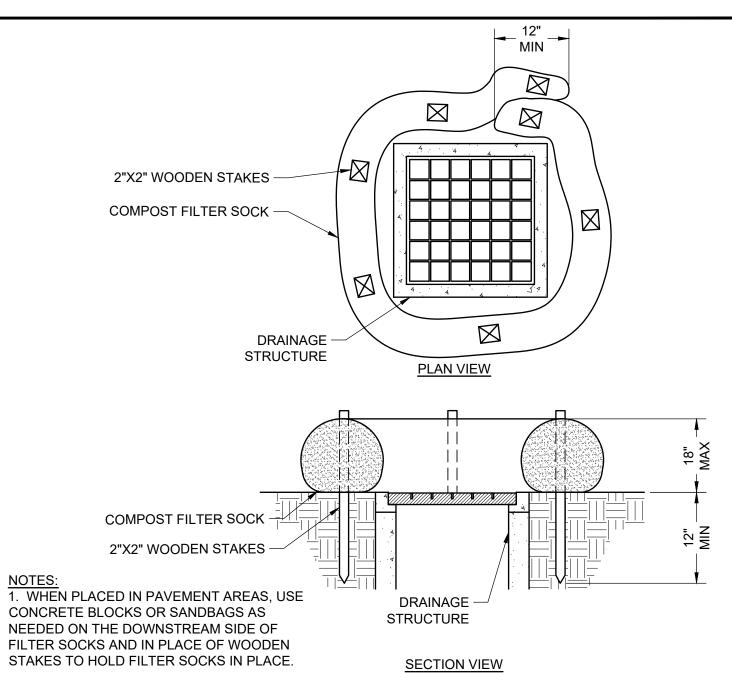

3 FILTER SOCK INLET PROTECTION DETAIL
C-502 NOT TO SCALE

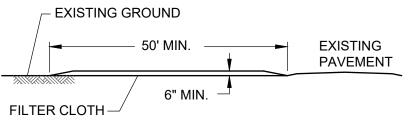

PROFILE VIEW

PLAN VIEW

NOTES:

BLOWN/PLACED FILTER MEDIA -

DISTURBED AREA

12" MIN

(IF NECESSARY)

1. STONE SIZE - USE 2" STONE, OR RECLAIMED OR RECYCLED CONCRETE EQUIVALENT.


- 2" X 2" WOODEN STAKES PLACED 10' O.C.

COMPOST FILTER SOCK

MHANHANHANHAA MAA

- 2. LENGTH NOT LESS THAN 50 FEET (EXCEPT ON A SINGLE RESIDENCE LOT WHERE A 30 FOOT MINIMUM LENGTH WOULD APPLY.
- 3. THICKNESS NOT LESS THAN SIX INCHES.
- 4. WIDTH 12 FOOT MINIMUM, BUT NOT LESS THAN THE FULL WIDTH AT POINTS WHERE INGRESS OR EGRESS OCCURS. 24 FOOT IF SINGLE ENTRANCE TO SITE.
- 5. FILTER CLOTH WILL BE PLACED OVER THE ENTIRE AREA PRIOR TO PLACING OF STONE.
- 6. SURFACE WATER ALL SURFACE WATER FLOWING OR DIVERTED TOWARD CONSTRUCTION ENTRANCES SHALL BE PIPED ACROSS THE ENTRANCE. IF PIPING IS IMPRACTICAL, A MOUNTABLE BERM WITH 5:1 SLOPES WILL BE PERMITTED.
- 7. MAINTENANCE THE ENTRANCE SHALL BE MAINTAINED IN A CONDITION WHICH WILL PREVENT TRACKING OR FLOWING OF SEDIMENT ONTO PUBLIC RIGHTS-OF-WAY. ALL SEDIMENT SPILLED, DROPPED, WASHED OR TRACKED ONTO PUBLIC RIGHTS-OF-WAY MUST BE REMOVED IMMEDIATELY.
- 8. WHEN WASHING IS REQUIRED, IT SHALL BE DONE ON AN AREA STABILIZED WITH STONE AND WHICH DRAINS INTO AN APPROVED SEDIMENT TRAPPING DEVICE.
- 9. PERIODIC INSPECTION AND NEEDED MAINTENANCE SHALL BE PROVIDED AFTER EACH

5 CONSTRUCTION ENTRANCE DETAIL NOT TO SCALE

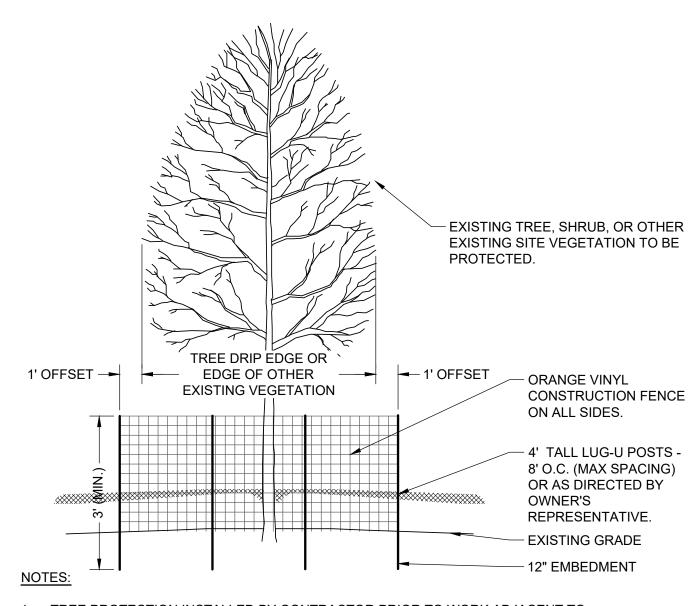

- 1. TREE PROTECTION INSTALLED BY CONTRACTOR PRIOR TO WORK ADJACENT TO PROTECTED VEGETATION.
- 2. CONTRACTOR IS RESPONSIBLE FOR MAINTAINING THE BARRIER THROUGHOUT THE DURATION OF WORK ADJACENT TO PROTECTED VEGETATION.

6 VEGETATION PROTECTION DETAIL
C-502 NOT TO SCALE

MERCY COLLEGE DOBBS FERI PARKING LOT 'R' IMPROVEM

Revision Number

Revision Date


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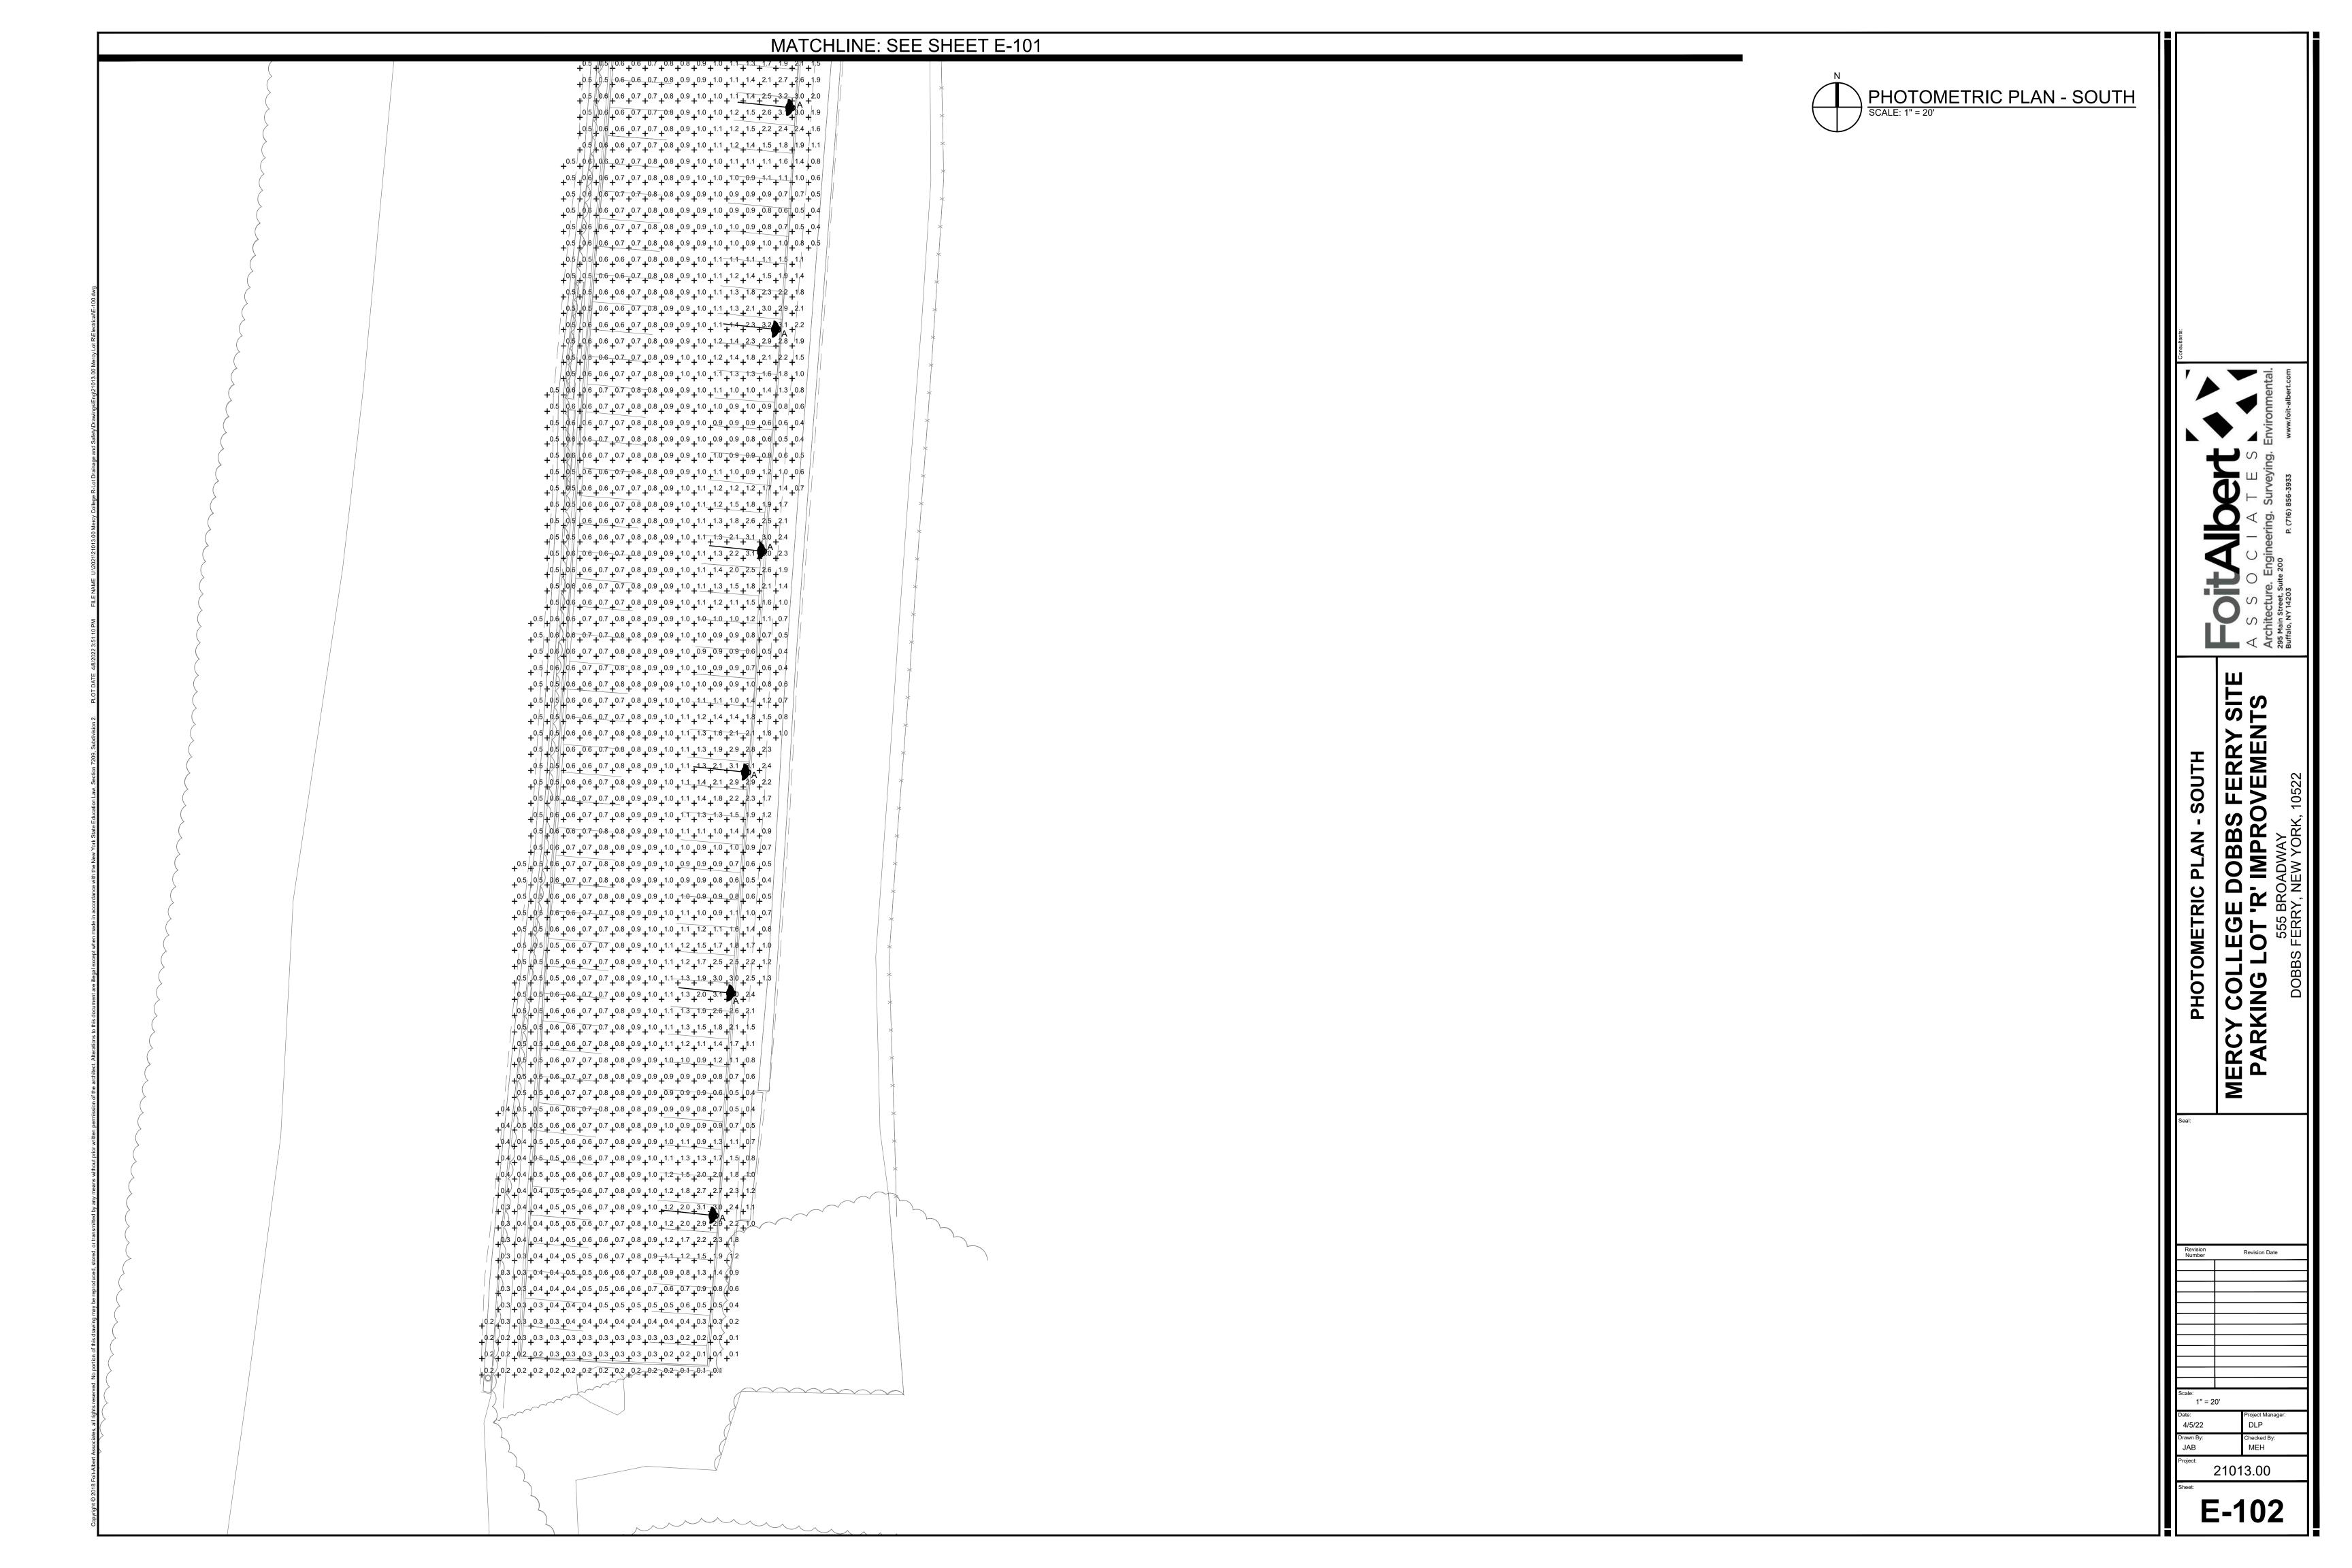
Project Manager:
DLP

Drawn By:
MWB

Project:

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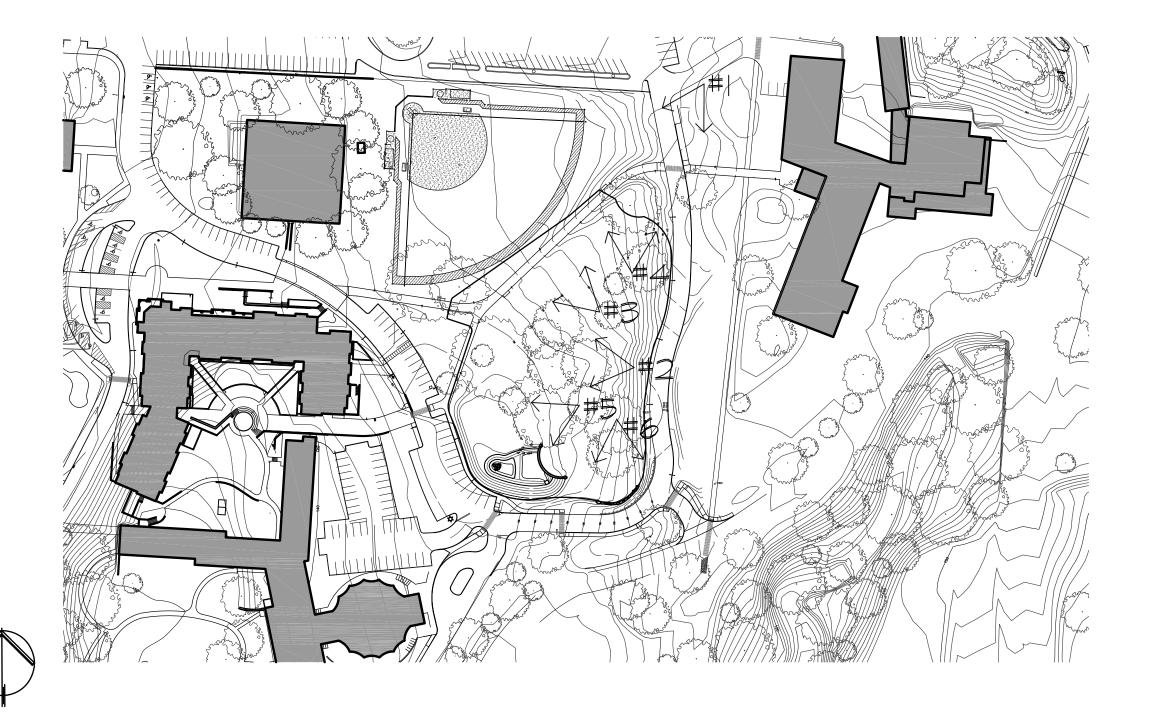
MERCY COLLEGE GROVE PAVILION

555 BROADWAY DOBBS FERRY, NY 10522

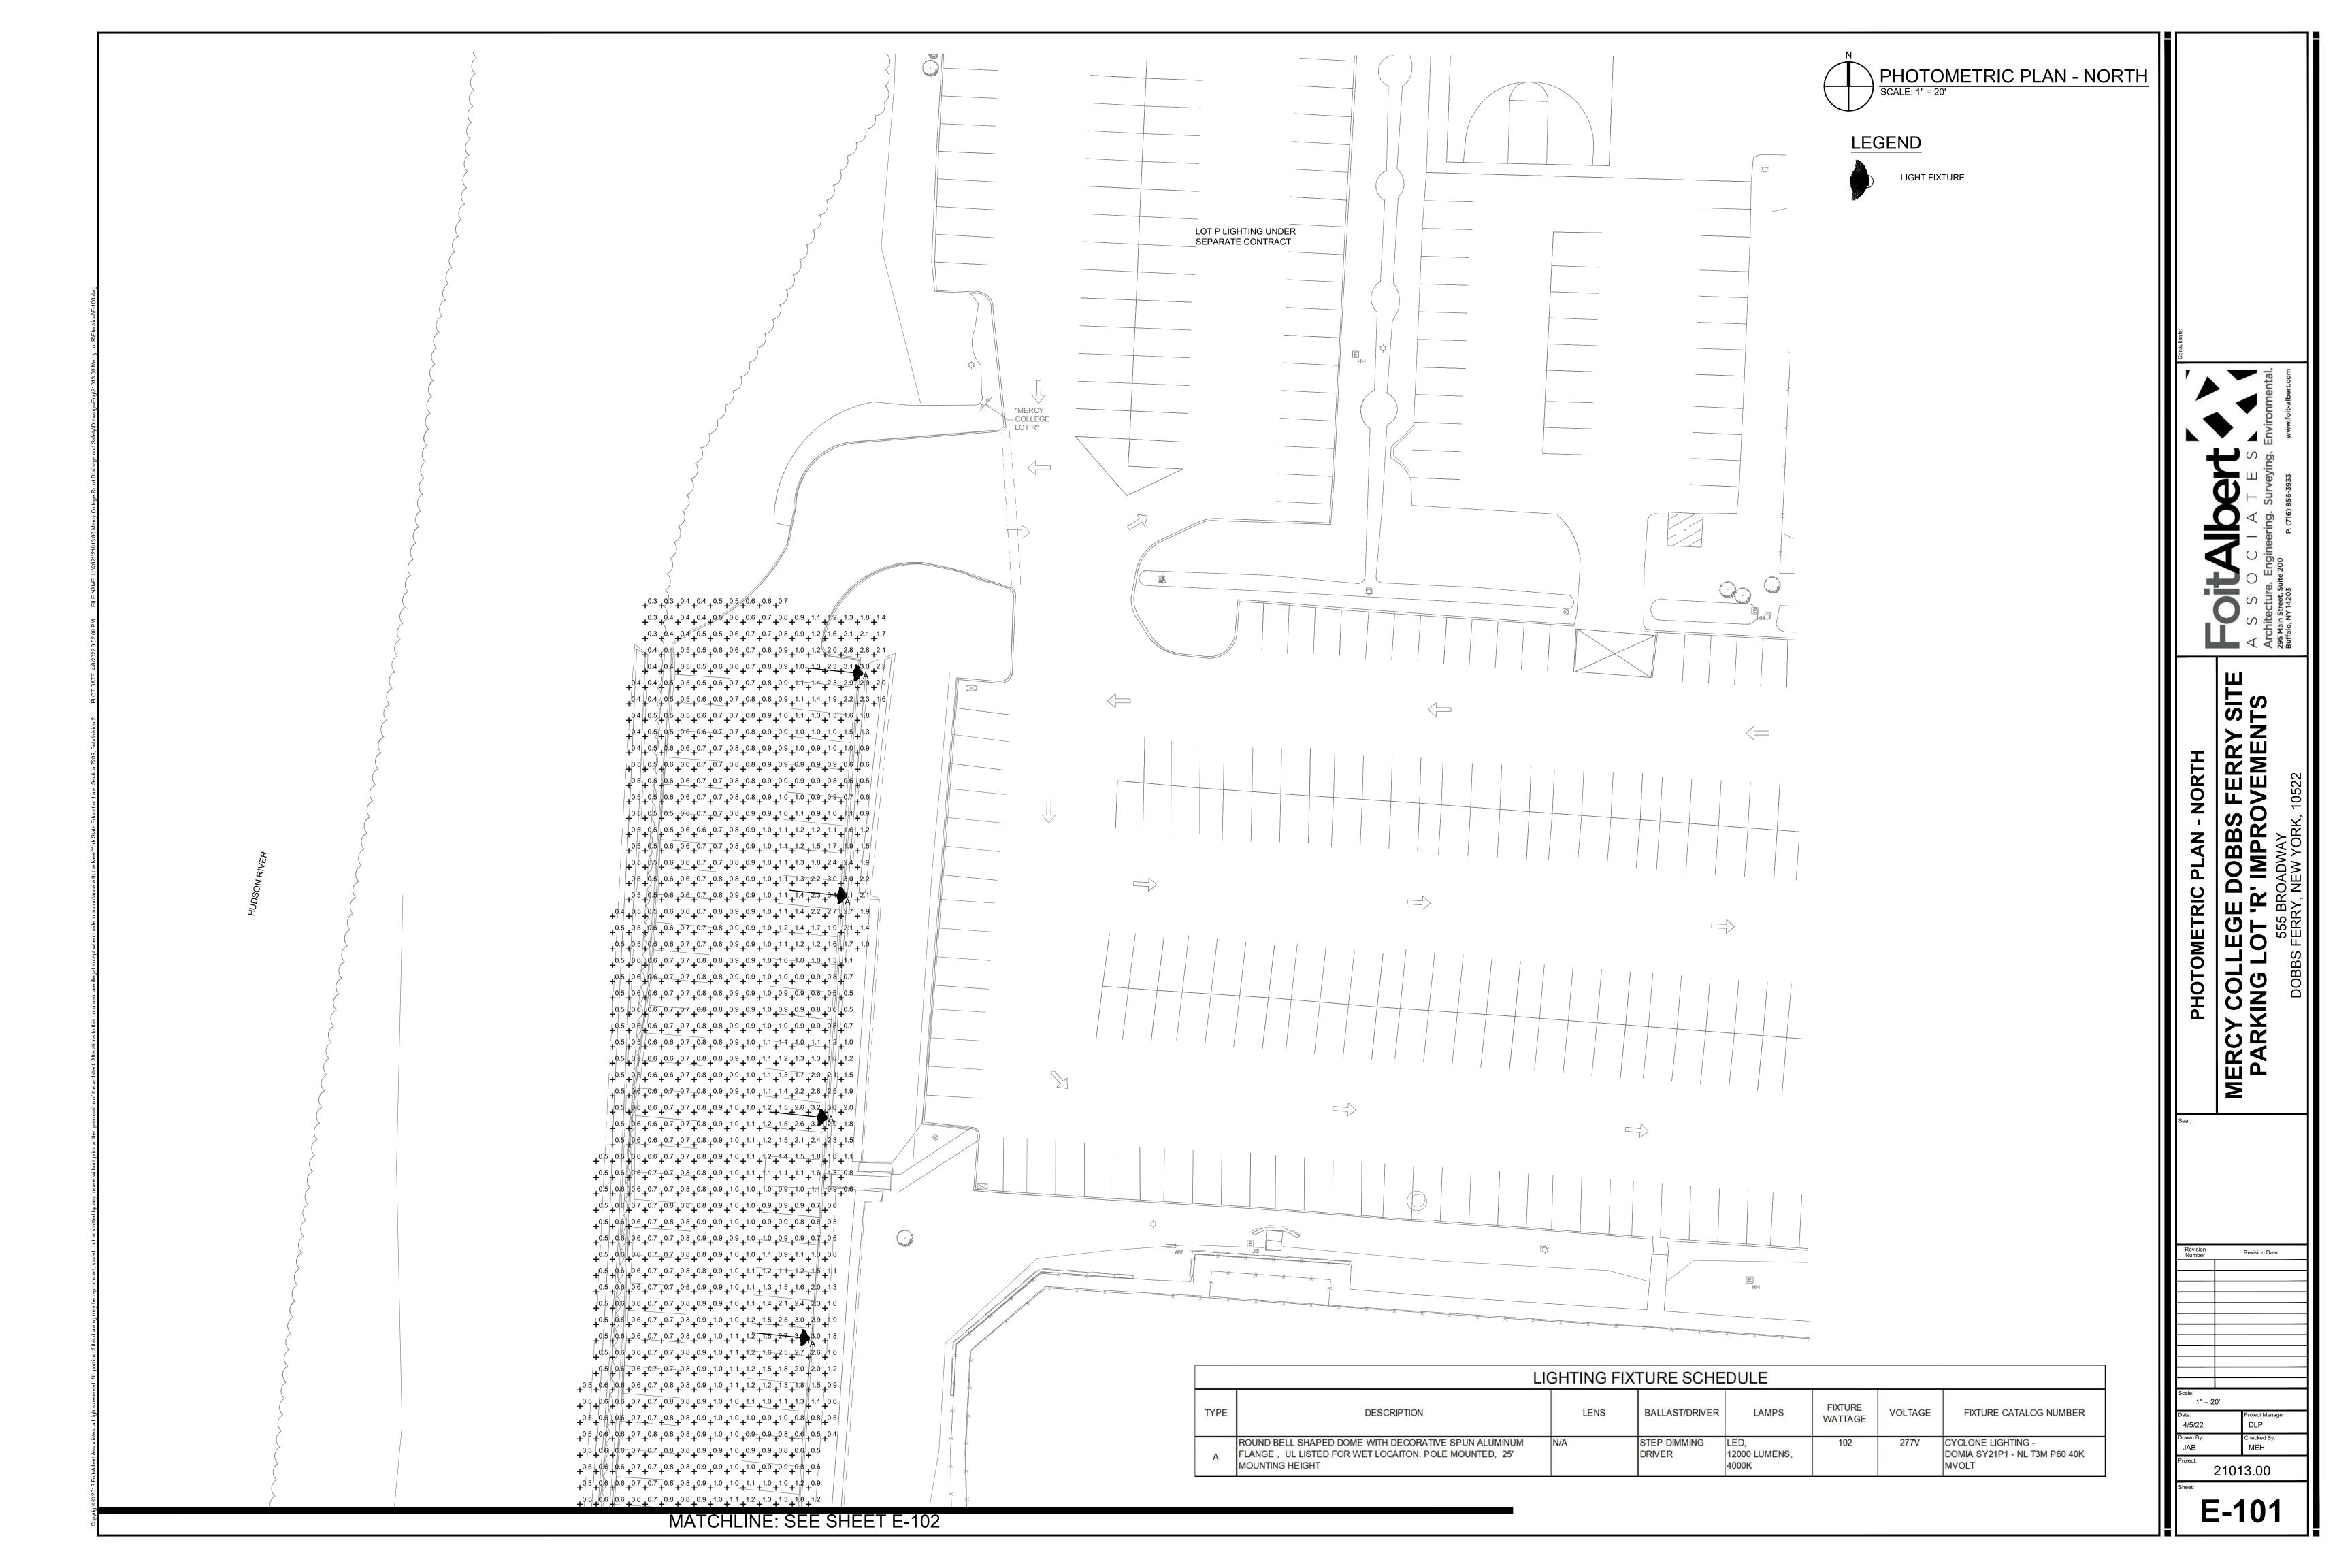ARCHITECT/ LANDSCAPE ARCHITECT
Alloy Design Studio PLLC
29 Perryridge Road
Greenwich, Connecticut 06830


PH: (203) 661-2723

LIST OF DRAWINGS	GENERAL NOTES	SITE PLAN	KEY PLAN
A-T Title Sheet	1. ALL MATERIALS, ASSEMBLIES, FORMS, AND METHODS OF CONSTRUCTION SHALL COMPLY WITH THESE DOCUMENTS AND ANY OF THE STATE AND LOCAL CODES AND STANDARDS AS WELL AS ANY REFERENCED WITHIN THESE DOCUMENTS.		PROJECT AREA
LANDSCAPE L-050 Contact Plan L-100 Removals Plan	 ALL CONTRACTORS AND SUBCONTRACTORS MUST CHECK AND VERIFY ALL EXISTING CONDITIONS AND DIMENSIONS AND REPORT AND DISCREPANCIES TO THE ARCHITECT. CONTRACTOR(S) MUST COMPLY AT ALL TIMES WITH OSHA RULES AND REQUIREMENTS. 		
L-200 Materials Plan	4. CONTRACTOR(S) SHALL BE SOLELY RESPONSIBLE FOR CONSTRUCTION MEANS, METHODS, TECHNIQUES, SEQUENCES, OR PROCEDURES OR FOR SAFETY PRECAUTIONS AND PROGRAMS IN CONJUNCTION WITH THE WORK.		
L-300 Grading Plan L-310 Site Drainage Diagram	5. MANDATORY INSPECTIONS: TRADE CONTRACTORS SHALL BE RESPONSIBLE FOR MAKING ALL ARRANGEMENTS FOR ANY MANDATORY INSPECTIONS WHICH ARE REQUIRED BY LOCAL BUILDING DEPARTMENTS. MANDATORY		
L-320 Site Utilities Diagram L-400 Planting Plan	INSPECTIONS SHALL COMPLY WITH LOCAL BUILDING DEPARTMENT REGULATIONS. 6. CONTRACTOR(S) MUST BE FAMILIAR WITH ALL OF THE DRAWINGS AND SPECIFICATIONS (CONTRACT DOCUMENTS) PERTAINING TO ALL OF THE TRADES CONNECTED WITH THE PROJECT.		
ARCHITECTURE A-100 Pavilion Plan	1. THE CONTRACTOR(S) SHALL STUDY AND COMPARE ALL DRAWINGS AND VERIFY ALL MEASUREMENT FIGURES BEFORE LAYING OUT OR CONSTRUCTING THE WORK. DEVIATION FROM THE DRAWINGS AND THE DIMENSIONS GIVEN THEREIN SHALL BE MADE ONLY AFTER WRITTEN APPROVAL OR CONFIRMATION IS REQUESTED BY THE CONTRACTOR(S) AND ISSUED BY THE ARCHITECT.		
A-150 Reflected Ceiling Plan A-200 Pavilion Elevations	8. WHENEVER ANY ADDITIONAL MATERIALS AND/OR WORKMANSHIP NOT SHOWN ARE REQUIRED TO COMPLETE THE WORK OF THE CONTRACT DOCUMENTS IN ACCORDANCE WITH THE OBVIOUS INTENT THEREOF, THE CONTRACTOR SHALL PROVIDE THESE MATERIALS AND WORKMANSHIP AT NO ADDITIONAL COST TO THE OWNER.		
A-300 Pavilion Sections	9. DAMAGE TO COLLEGE PROPERTY SHALL BE CORRECTED BY THE CONTRACTOR AT NO ADDITIONAL COST TO THE OWNER. IF CONTRACTOR DOES NOT CORRECT DAMAGES WITHIN ONE WEEK, THE OWNER SHALL AHVE THE RIGHT TO BACK CHARGE CONTRACTOR FOR ALL REPAIRS NECESSARY.		
	10. IN THE EVENT OF CONFLICTS, OMISSIONS, AMBIGUITIES, DISCREPANCIES AND /OR UNCLEAR CIRCUMSTANCES BETWEEN ANY OF THE REQUIREMENTS OF THE CONTRACT DOCUMENTS, THE REQUIREMENT THAT IS MOST INCLUSIVE AND OF HIGHEST QUALITY, AND/OR COST SHALL GOVERN. CONTRACTOR(S) SHALL (A) PROVIDE THE BETTER QUALITY OR GREATER QUANTITY OF WORK OR (B) COMPLY WITH THE MORE STRINGENT REQUIREMENT, EITHER OR BOTH, IN ACCORDANCE WITH THE ARCHITECT'S INTERPRETATION. NO EXTRA COMPENSATION SHALL BE AWARDED TO THE CONTRACTOR(S) BASED UPON A CLAIM OF AMBIGUITY OR UNCLEAR CIRCUMSTANCES IN THE CONTRACT DOCUMENTS.		
	11. THE CONTRACTOR(S) SHALL VERIFY THE ACCURACY OF ALL ELEVATIONS, DIMENSIONS, AND LOCATIONS AND REPORT ANY DISCREPANCY BETWEEN EXISTING CONDITIONS AND THE INFORMATION SHOWN ON THE DRAWINGS PRIOR TO THE START OF WORK. ANY ERRORS DUE TO THE CONTRACTOR(S) FAILURE TO VERIFY SUCH ELEVATIONS, DIMENSIONS, AND LOCATIONS SHALL BE RECTIFIED BY THE CONTRACTOR(S) WITHOUT CHANGE TO THE PROJECT SCHEDULE AND AT NO COST TO THE OWNER.	The state of the s	N.T.S.
	12. IF A CHANGE IN THE WORK IS FOUND NECESSARY DUE TO A DISCREPANCY BETWEEN ACTUAL FIELD CONDITIONS AND THE DRAWINGS, THE CONTRACTOR(S) SHALL SUBMIT DETAILED DRAWINGS OF SUCH DEPARTURE FOR THE APPROVAL OF THE ARCHITECT BEFORE MAKING ANY CHANGES.		PROJECT LOCATION PLAN
	13. CONTRACTOR(5) SHALL COORDINATE NEIGHBORHOOD STREET ACCESS, DELIVERY ROUTING, VEHICLE PARKING LOCATIONS, ACCEPTABLE HOURS FOR CONSTRUCTION AND MATERIAL DELIVERY WITH THE OWNER AND THE OWNER'S REPRESENTATIVE.	The state of the s	Nevis Labs Columbia
	14. CONTRACTOR(S) SHALL NOT CAUSE INTERRUPTION IN SERVICES SUCH AS POWER, WATER, OR HEAT WITHOUT THE APPROVAL OF THE OWNER AND OWNER'S REPRESENTATIVE.		Hudson House C
	15. CONTRACTOR(S) SHALL PROTECT ALL AREAS ADJACENT TO THE CONSTRUCTION AREA FROM DAMAGE BY CONSTRUCTION VEHICLES, EQUIPMENT, OR CONSTRUCTION PERSONNEL. ANY DAMAGE TO ADJACENT AREAS SHALL BE REPAIRED BY THE CONTRACTOR(S) WITH NO CHANGE TO THE PROJECT SCHEDULE AND AT NO COST TO THE OWNER.		Ardsley Ave W Ardsley Ave E Ardsley Curling Club Ardsley Country Club Mercy Country Club
	16. PROVISIONS SHALL BE MADE TO PREVENT THE PASSAGE OF DUST AND CONTAMINANTS INTO ADJACENT PARTS OF THE BUILDING WHICH ARE NOT PART OF THE CONSTRUCTION CONTRACT. PERIODIC INSPECTION AND REPAIRS OF THE CONTAINMENT BARRIERS MUST BE MADE TO PREVENT EXPOSURE TO DUST OR CONTAMINANTS.		Langdon Ave Worth Brook North Brook
	17. UNDER NO CIRCUMSTANCES SHALL THE CONTRACTOR(S) SUBMIT THE ARCHITECT'S OWN CONSTRUCTION DRAWINGS OR DETAILS AS THEIR SHOP DRAWINGS OR AS-BUILT DRAWINGS. SHOP DRAWINGS AND AS-BUILT DRAWINGS MUST BE ORIGINAL DOCUMENTS PROVIDED BY THE CONTRACTOR(S).		Sheman Ave Ready. Sheman Ave Ready. Sheman Ave Ready. William Willi
	18. SEE THE TECHNICAL SPECIFICATIONS FOR SHOP DRAWINGS, MOCK-UPS, FINISH SAMPLES AND OTHER SUBMISSION REQUIREMENTS. EACH CONTRACTOR SHALL MAINTAIN ONE SET OF ALL SUBMISSIONS (SHOP DRAWINGS, SAMPLES, PRODUCT LITERATURE, ETC.) ON THE JOB SITE AND AVAILABLE FOR REFERENCE. MOCK-UPS AND ACCEPTED SAMPLES SHALL BE AVAILABLE FOR REFERENCE. CONTRACTORS SHALL PROVIDE AS MANY MOCK-UPS OR SAMPLES AS NECESSARY IN ORDER TO OBTAIN OWNER'S/ARCHITECT'S APPROVAL.		Walgreens Maple St Sushi Mike's The Cookery The Cookery Dobbs Ferry Dobbs Ferry Dobbs Ferry Ashford Ave
	19. CONTROL AND EXPANSION JOINTS WILL BE REQUIRED IN ALL CMU AND BRICK (INTERIOR AND EXTERIOR), PER INDUSTRY STANDARDS (NATIONAL CONCRETE MASONRY INSTITUTE AND BRICK INSTITUTE OF AMERICA): SKETCHES SHOWING PRECISE JOINT LOCATIONS WILL BE SUBSEQUENTLY ISSUED BY THE ARCHITECT.		Dobbs Ferry The Masters School T
	ABBREVIATIONS		St.Cabrini Nursing iHome St.Cabrini Nursing iH
	ACD access door CU.IN. cubic inch(es) MAS masonary AD area drain CU.FT. cubic foot MTL material ALT alternate DET detail MET metal		
	ARCH architect (ural) DEMO demolish, demolision MISC miscellaneous ASPH asphalt DIAM diameter NIC not in contract BLDG building DIM dimension OC on center (s)	46.5	
	BM beam DIM dimension OUT outlet BRK brick DR door REF reference CAB cabinet D drain REM remove		1. 04/15/2022 PLANNING BOARD SUBMISSION
	CC construction DWG drawing REQ require (s) contractor E east STD standard		No. Date Revision Stamp
	CLL contract limit line EA each SD storm drain CJT control joint EJ expansion joint SYM symmetry(ical) CL'G ceiling FFE finished floor TEL telephone CMU concrete masonry elevation (level) Tig tongue it groove		Drawing Title Drawing No.
	CMU concrete masonry elevation (level) T&G tongue & groove unit FLR floor TC top of curb COL column FT feet TSL top of slab		TITLE SHEET Scale Job No. Date A-T
	CONC concrete HT height TW top of wall CONST construction HVAC heating/ventilating/ TYP typical	January Control of the state of	Not To Scale 2105 03/01/22
	CONT continuous air conditioning WD wood CONTR contractor HWD hardwood CRG cross grain HB hose bibb	The standard of the standard o	ALLOY DESIGN STUDIO PLLC. 29 Perryridge road
		N.T.S.	Greenwich, Connecticut 06830 (203) 661-2723 ctramutola@gmail.com



LEGEND

PHOTO KEY VIEW SHED

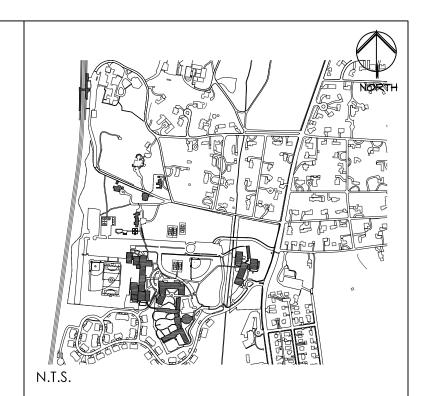

Key Plan Not to Scale



PHOTO: #1



PHOTO: #2



PHOTO: #3

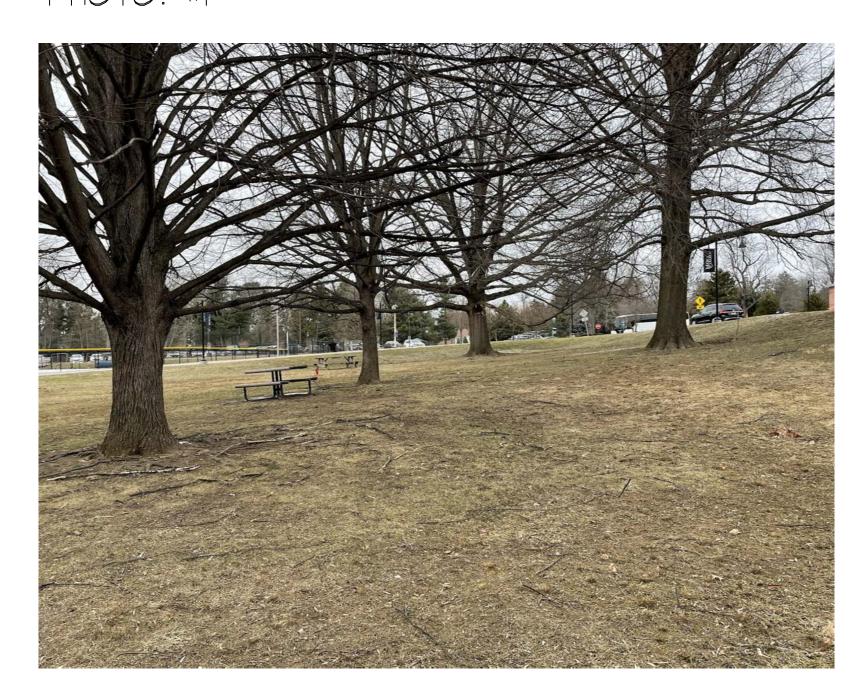


PHOTO: #4



PHOTO: #5



PHOTO: #6



04/15/2022 PLANNING BOARD SUBMISSION

Date Revision/Submission

Project Title

MERCY COLLEGE GROVE PAVILION

Mercy College 555 Broadway Dobbs Ferry, NY 10522

SITE PHOTOS

Scale	Job No.	Date	Drawing No.
AS SHOWN	2201	03/01/2022	T 0.50
Drawn	Checked	Approved	7L-()5(
CT	CT	CT	








BASE TO REMAIN


PROJECT LIMIT LINE

REMOVE MULCH, VEGETATION AND TOPSOIL DOWN TO SUBSOIL

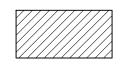


REMOVE EXISTING STAIRS,

REMOVE EXISTING BRICK

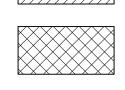

PAYING INCLUDING BASE

REMOVE EXISTING BOULDER WALL

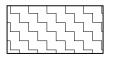

INCLUDING BASE



TREE PROTECTION

CLEAN CUT/STOP




EROSION CONTROL FENCING CONSTRUCTION



DEMOLITION AND REMOVAL NOTES

- 1. THE CONTRACTOR SHALL YERIFY ALL EXISTING UTILITIES AND FIELD CONDITIONS PRIOR TO COMMENCEMENT OF CONSTRUCTION OPERATIONS. ANY DISCREPANCIES SHALL BE BROUGHT TO THE IMMEDIATE ATTENTION OF THE OWNER'S REPRESENTATIVE FOR RESOLUTION PRIOR TO CONTINUING WORK.
- 2. ALL REMOVALS SHALL BE AS SHOWN ON THE CONTRACT DRAWINGS AND/OR AS DIRECTED BY THE OWNER'S REPRESENTATIVE TO THE SATISFACTION OF THE OWNER'S REPRESENTATIVE.
- 3. THE CONTRACTOR SHALL EXERCISE EXTREME CARE DURING REMOVAL OPERATIONS TO PROTECT EXISTING MATERIALS TO REMAIN EITHER BELOW GRADE OR ABOVE GRADE. ANY DAMAGE TO EXISTING MATERIALS RESULTING FROM CONSTRUCTION SHALL BE THE CONTRACTORS RESPONSIBILITY, AND SHALL BE RESTORED AT THE CONTRACTOR'S EXPENSE TO THE SATISFACTION OF THE OWNER'S REPRESENTATIVE.
- 4. PRIOR TO DEMOLITION, ALL MATERIALS TO BE REMOVED AND SALVAGED BY THE CONTRACTOR SHALL BE NEATLY STORED IN A SECURED AREA APPROVED BY THE OWNER'S REPRESENTATIVE.
- 5. VERIFY THE INTENDED DISPOSITION OF ALL ITEMS TO BE REMOVED AND SALVAGED, BUT NOT TO BE USED IN THE NEW IMPROVEMENTS WITH THE OWNER'S REPRESENTATIVE.
- 6. IF THERE IS ANY CONFUSION AS TO WHAT IS TO REMAIN AND WHAT IS TO BE REMOVED, THE CONTRACTOR SHALL NOTIFY THE OWNER'S REPRESENTATIVE FOR RESOLUTION PRIOR TO CONTINUING WITH WORK.
- 1. THE CONTRACTOR SHALL PROVIDE ALL TEMPORARY SHORING, BRACING AND DEWATERING REQUIRED OR AS DIRECTED TO PROTECT THE SAFETY OF ADJACENT STRUCTURES AND UTILITIES. SEE HELLER & JOHNSEN SOILS REPORT IN SPECIFICATIONS.
- 8. FILL AND COMPACT ALL FOUNDATION REMOVAL EXCAVATIONS WITH APPROVED BACKFILL TO MEET EXISTING GRADE.
- 9. WHERE NEW CONSTRUCTION ABUTS EXISTING PAYEMENTS, THE EXISTING MATERIAL SHALL BE CLEANLY SAWCUT TO PROVIDE A CLEAN NEAT MATCH WITH NO TRIP HAZARDS.
- 10. THERE SHALL BE NO STOCKPILING, STAGING OR MACHINERY AND VEHICULAR TRAFFIC ON AREAS OUTSIDE THE PROPERTY LINE. ANY DAMAGE TO EXISTING LAWN, TREES, SHRUBS AND ANY OTHER MATERIALS SHALL BE REPAIRED OR REPLACED BY THE CONTRACTOR AT NO COST TO THE OWNER AND TO THE SATISFACTION OF THE OWNER'S REPRESENTATIVE.
- 11. THE CONTRACTOR IS RESPONSIBLE FOR OBTAINING ALL NECESSARY PERMITS.
- 12. CONTRACTOR TO PROVIDE AND MAINTAIN EROSION \$ SEDIMENT CONTROL MEASURES THROUGHOUT THE DURATION OF THE PROJECT. TOPSOIL IS TO BE STOCKPILED IN A LOCATION APPROVED BY OWNER AND ENCLOSED BY SILT
- 13. THE VILLAGE ENGINEER AND BUILDING INSPECTOR MAY REQUIRE ADDITIONAL EROSION CONTROL MEASURES IF DEEMED APPROPRIATE TO MITIGATE UNFORESEEN SILTATION AND EROSION OF DISTURBED SOILS,
- 14. NO DEMOLITION MATERIAL TO BE BURIED ON SITE

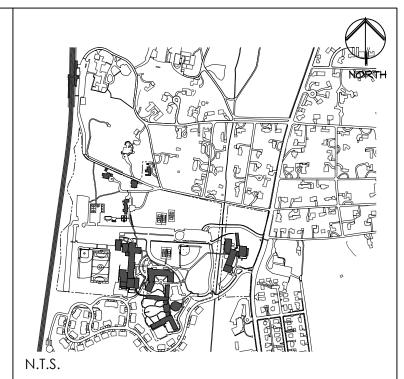

Key Plan Not to Scale

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Date




MERCY COLLEGE **GROVE PAVILION**

Mercy College 555 Broadway Dobbs Ferry, NY 10522

Drawing Title


REMOVALS PLAN


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GENERAL NOTES

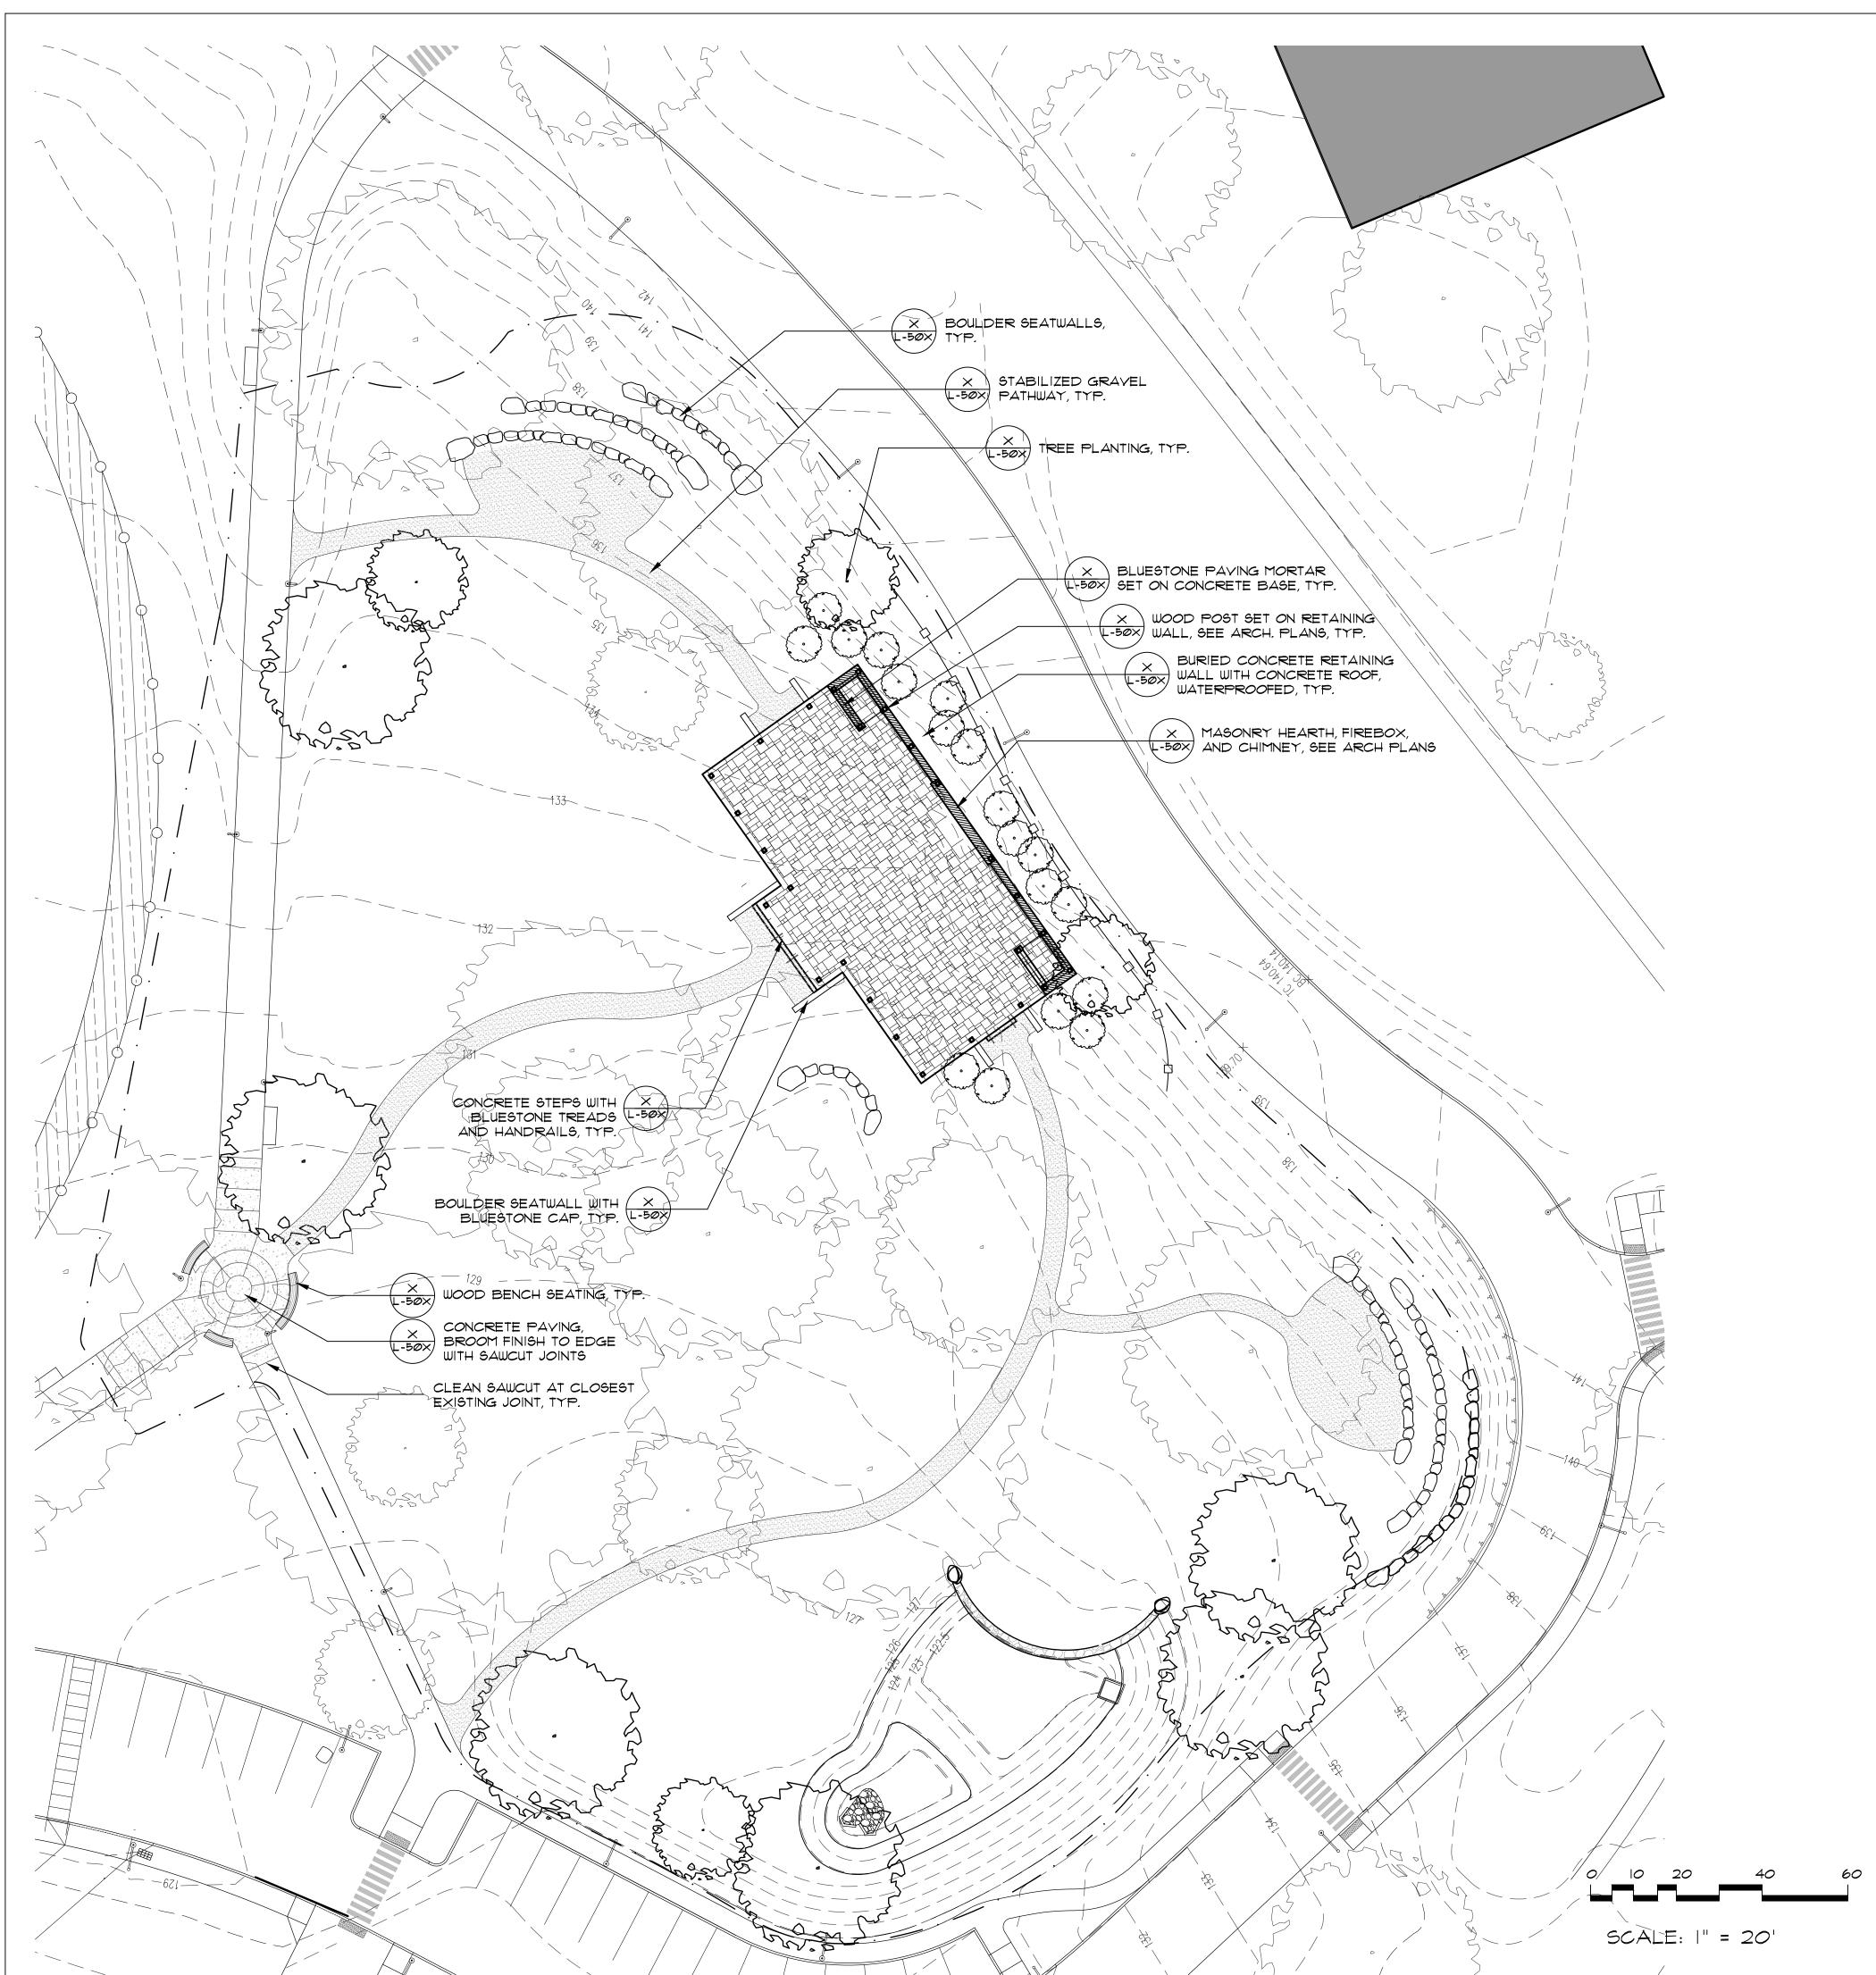- 1. THE CONTRACTOR SHALL VERIFY ALL FIELD CONDITIONS AND FAMILIARIZE THEMSELVES WITH THE SITE PRIOR TO COMMENCEMENT OF WORK. ACTUAL FIELD CONDITIONS MAY VARY FROM LAYOUT, DIMENSIONS AND EXISTING GRADES AS SHOWN ON THE PLANS. THE CONTRACTOR SHALL PERFORM THE WORK IN ACCORDANCE WITH EXISTING FIELD CONDITIONS. NOTIFY THE OWNER'S REPRESENTATIVE IN WRITING OF ANY DISCREPANCIES PRIOR TO CONTINUING
- 2. THE CONTRACTOR SHALL SECURE THE WORK AREA WITH SPECIFIED BARRIERS AND FENCING AND MAINTAIN A SAFE AND SECURE CONSTRUCTION SITE.
- 3. PEDESTRIAN AND VEHICULAR TRAFFIC ON ADJACENT ROADS AND SIDEWALKS SHALL BE MAINTAINED DURING CONSTRUCTION.
- 4. CONTRACTOR SHALL TAKE ALL NECESSARY PRECAUTIONS TO PREVENT DAMAGE OR INTERRUPTION TO EXISTING UTILITY SERVICE. ANY DAMAGE OR INTERRUPTION TO EXISTING UTILITY SERVICE SHALL BE RESTORED BY the CONTRACTOR AT NO EXPENSE TO THE OWNER.
- 5. THE CONTRACTOR SHALL COMPLY WITH ALL APPLICABLE AGENCIES AND UTILITY COMPANIES HAVING JURISDICTION (I.E. DEPARTMENT OF TRANSPORTATION, FIRE DEPARTMENT, DEPARTMENT OF ENVIRONMENTAL PROTECTION TELEPHONE, SEWER, GAS, ETC.), OBTAIN PERMITS AND PAY ANY FEES ASSOCIATED WITH WORK OF THIS PROJECT. SEE BIDDING GUIDE SCOPE OF WORK: WORK NOT INCLUDED FOR EXCLUSIONS.
- 6. IT IS ANTICIPATED THAT VARIOUS TYPES OF WORK FOR THIS CONTRACT WILL BE PERFORMED SIMULTANEOUSLY. THE CONTRACTOR SHALL BE RESPONSIBLE FOR COORDINATING WORK BETWEEN SUBCONTRACTORS AND UTILITY COMPANIES TO ENSURE COMPLETION OF HIS WORK IN A TIMELY AND WORKMAN LIKE MANNER.
- 1. THE CONTRACTOR SHALL PERFORM ALL WORK WITH CARE TO ENSURE MATERIALS TO REMAIN SHALL NOT BE DAMAGED. ANY DAMAGE TO MATERIAL TO REMAIN SHALL BE REPAIRED OR REPLACED TO THE SATISFACTION OF THE OWNER AND PAID FOR BY THE CONTRACTOR.
- 8. REMOVE AND DISPOSE OF ALL ITEMS DESIGNATED AS REMOVALS OFF-SITE IN A LEGAL MANNER. ALL EXISTING INLETS, BASINS AND CONNECTIONS WITHIN THE PROJECT LIMIT SHALL BE CLEANED AND CLEARED TO THE SATISFACTION OF THE OWNER'S REPRESENTATIVE.
- 9. UPON COMPLETION OF THE WORK THE CONTRACTOR SHALL RESTORE ALL "UNIMPROVED" AREAS UTILIZED FOR SITE ACCESS, STOCKPILING, CONSTRUCTION TRAILERS ETC. TO SERVICEABLE AND SAFE CONDITIONS AND TO THE SATISFACTION OF THE OWNER'S REPRESENTATIVE.



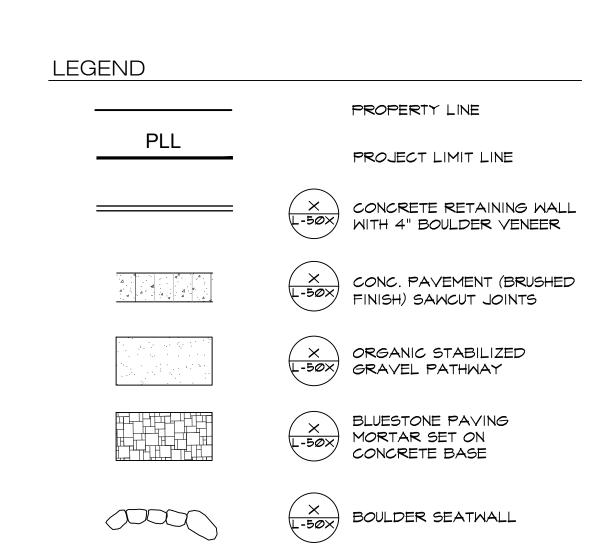

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MERCY COLLEGE **GROVE PAVILION**

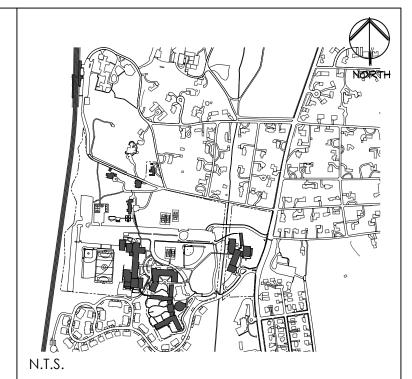Mercy College 555 Broadway Dobbs Ferry, NY 10522

Drawing Title

MATERIALS PLAN

Scale	Job No.	Date	Drawing No.
AS SHOWN	2201	03/01/2022	1 200
Drawn	Checked	Approved	7L-20U
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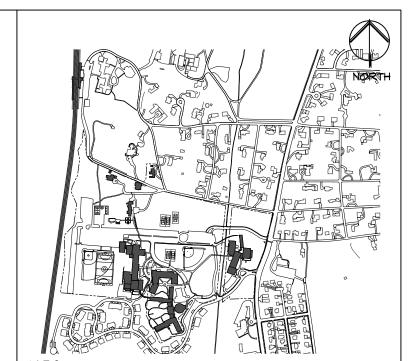
GRADING NOTES

- I. REFER TO THE TOPOGRAPHIC SURVEY FOR EXISTING UTILITIES AND ELEVATIONS.
- 2. PREPARE SUB-GRADE ELEVATIONS TO SUFFICIENT DEPTH TO INSURE NEW IMPROVEMENTS MEET EXISTING MATERIALS SMOOTHLY, EVENLY AND TO GRADE.
- 3. IN ALL CASES, PAVEMENTS SHALL BE PITCHED TO AWAY FROM BUILDING AND IN A MANNER THAT PREVENTS PONDING AND PUDDLING. CONTRACTOR SHALL PERFORM A DRAINAGE TEST OF ALL PAVEMENTS TO INSURE POSITIVE DRAINAGE.
- 4. THE CONTRACTOR SHALL BE RESPONSIBLE FOR DEWATERING AS REQUIRED TO MAINTAIN ALL TRENCHES AND EXCAVATIONS FREE FROM WATER DURING THE CONSTRUCTION OPERATIONS.
- 5. LOCATE NEW DRAINAGE STRUCTURES AT TRUE LOW POINT OF THEIR RESPECTIVE AREAS AS DETERMINED IN THE FIELD AND APPROVED BY THE OWNER'S REPRESENTATIVE.
- 6. ALL NEW PAVEMENTS SHALL MEET EXISTING FLUSH.
- 7. ALL PEDESTRIAN PATHS LONGITUDINAL PITCH IS NOT TO EXCEED 5% UNLESS OTHERWISE INDICATED AND CROSS PITCH NOT EXCEED 2% UNLESS OTHER WISE INDICATED
- 8. IMPORTED FILL MATERIAL SHALL BE CERTIFIED IN WRITING BY A NEW YORK STATE LICENSED PROFESSIONAL ENGINEER AS NON-CONTAMINATED CLEAN FILL SUITABLE FOR THE INTENDED USE

LEGEND

NORTH

	PROPERTY LINE
PLL	PROJECT LIMIT LINE
— — 190 — —	EXIST. CONTOUR
190	PROPOSED CONTOUR
+84.13	SPOT ELEVATION
+TW	TOP OF WALL
+BW	BOTTOM OF WALL
+TS	TOP OF STAIR
+B\$	BOTTOM OF STAIR
⁺ TR	TOP OF RAMP
⁺ BR	BOTTOM OF RAMP
S	EXISTING SANITARY SEWER MANHOLE
	EXISTING STORM DRAINAGE MANHOLE



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1.	04/15/2022	PLANNING BOARD SUBMISSION
No.	Date	Revision/Submission




MERCY COLLEGE GROVE PAVILION

Mercy College 555 Broadway Dobbs Ferry, NY 10522 Drawing Title

GRADING PLAN

Scale	JOD NO.	Date	Drawing No.
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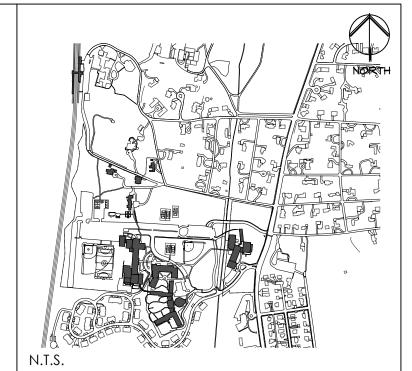


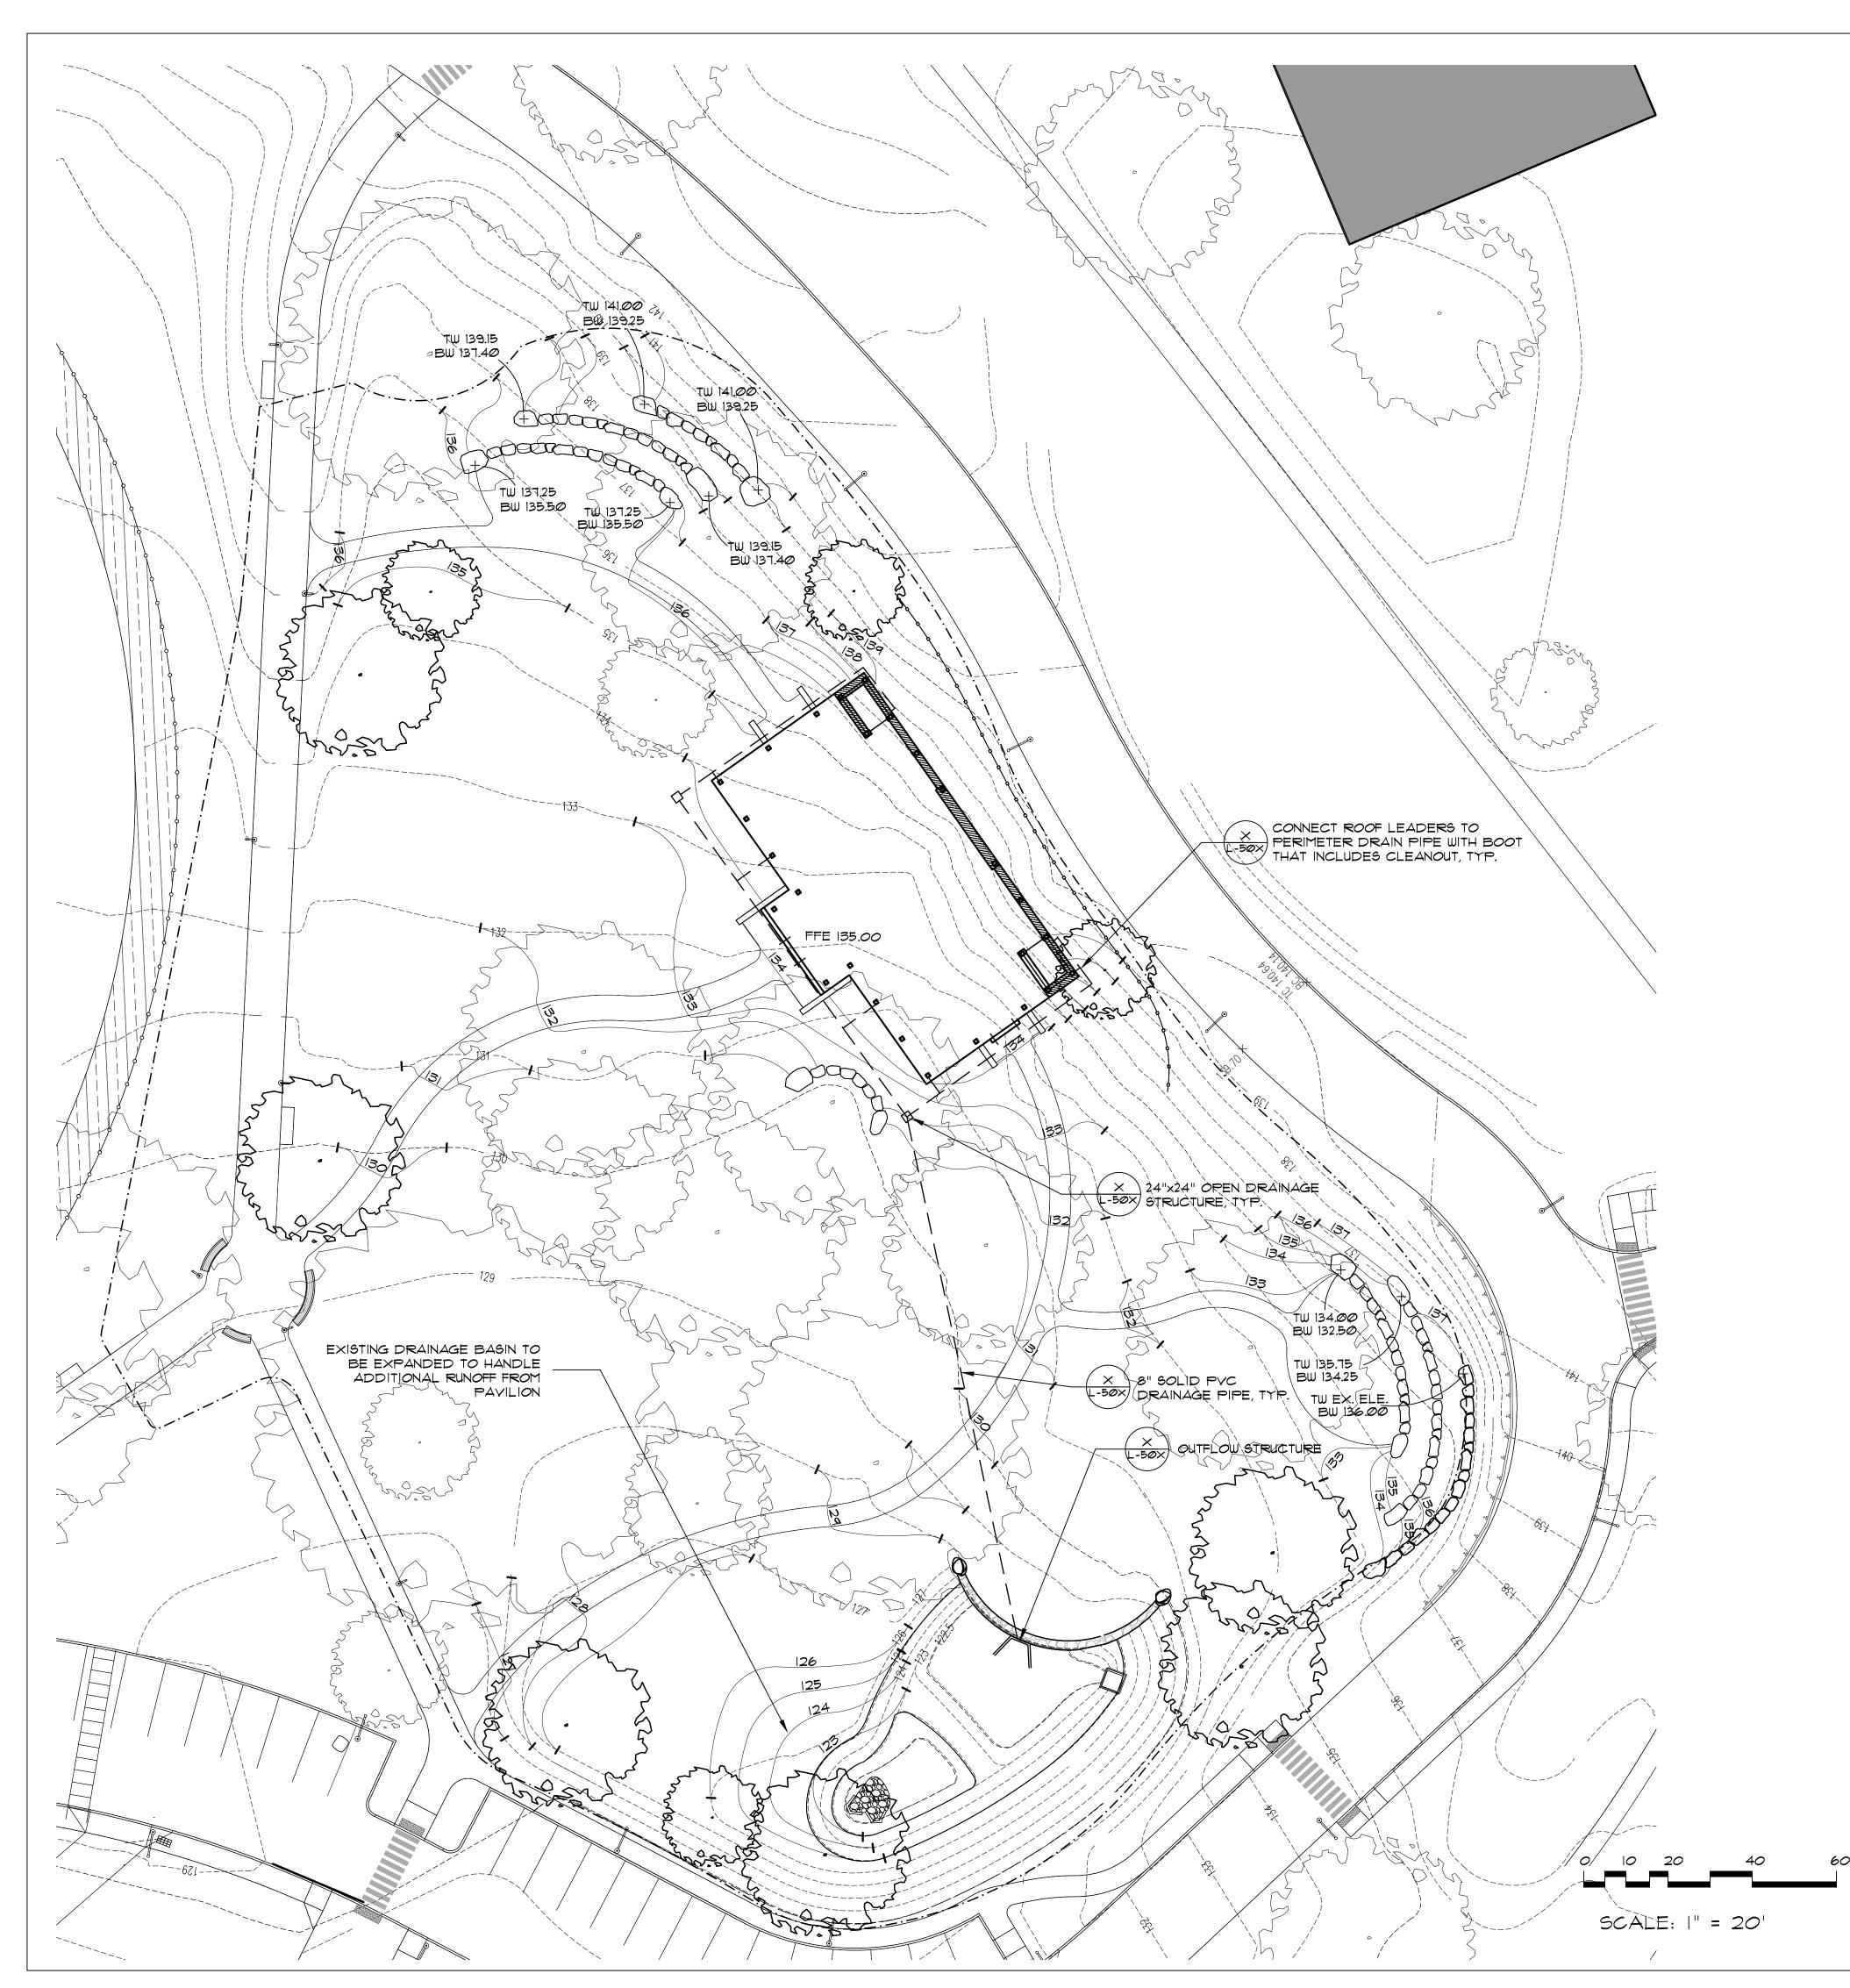GRADING NOTES

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- PREPARE SUB-GRADE ELEVATIONS TO SUFFICIENT DEPTH TO INSURE NEW IMPROVEMENTS MEET EXISTING MATERIALS SMOOTHLY, EVENLY AND TO GRADE.
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LEGEND

	PROPERTY LINE
PLL	PROJECT LIMIT LINE
————190————	EXIST. CONTOUR
190	PROPOSED CONTOUR
+84.13	SPOT ELEVATION
+⊤W	TOP OF WALL
+BW	BOTTOM OF WALL
+TS	TOP OF STAIR
+BS	BOTTOM OF STAIR
⁺ TR	TOP OF RAMP
⁺ BR	BOTTOM OF RAMP
S	EXISTING SANITARY SEWER MANHOLE
	EXISTING STORM DRAINAGE MANHOLE



Key Plan	Not to Scale

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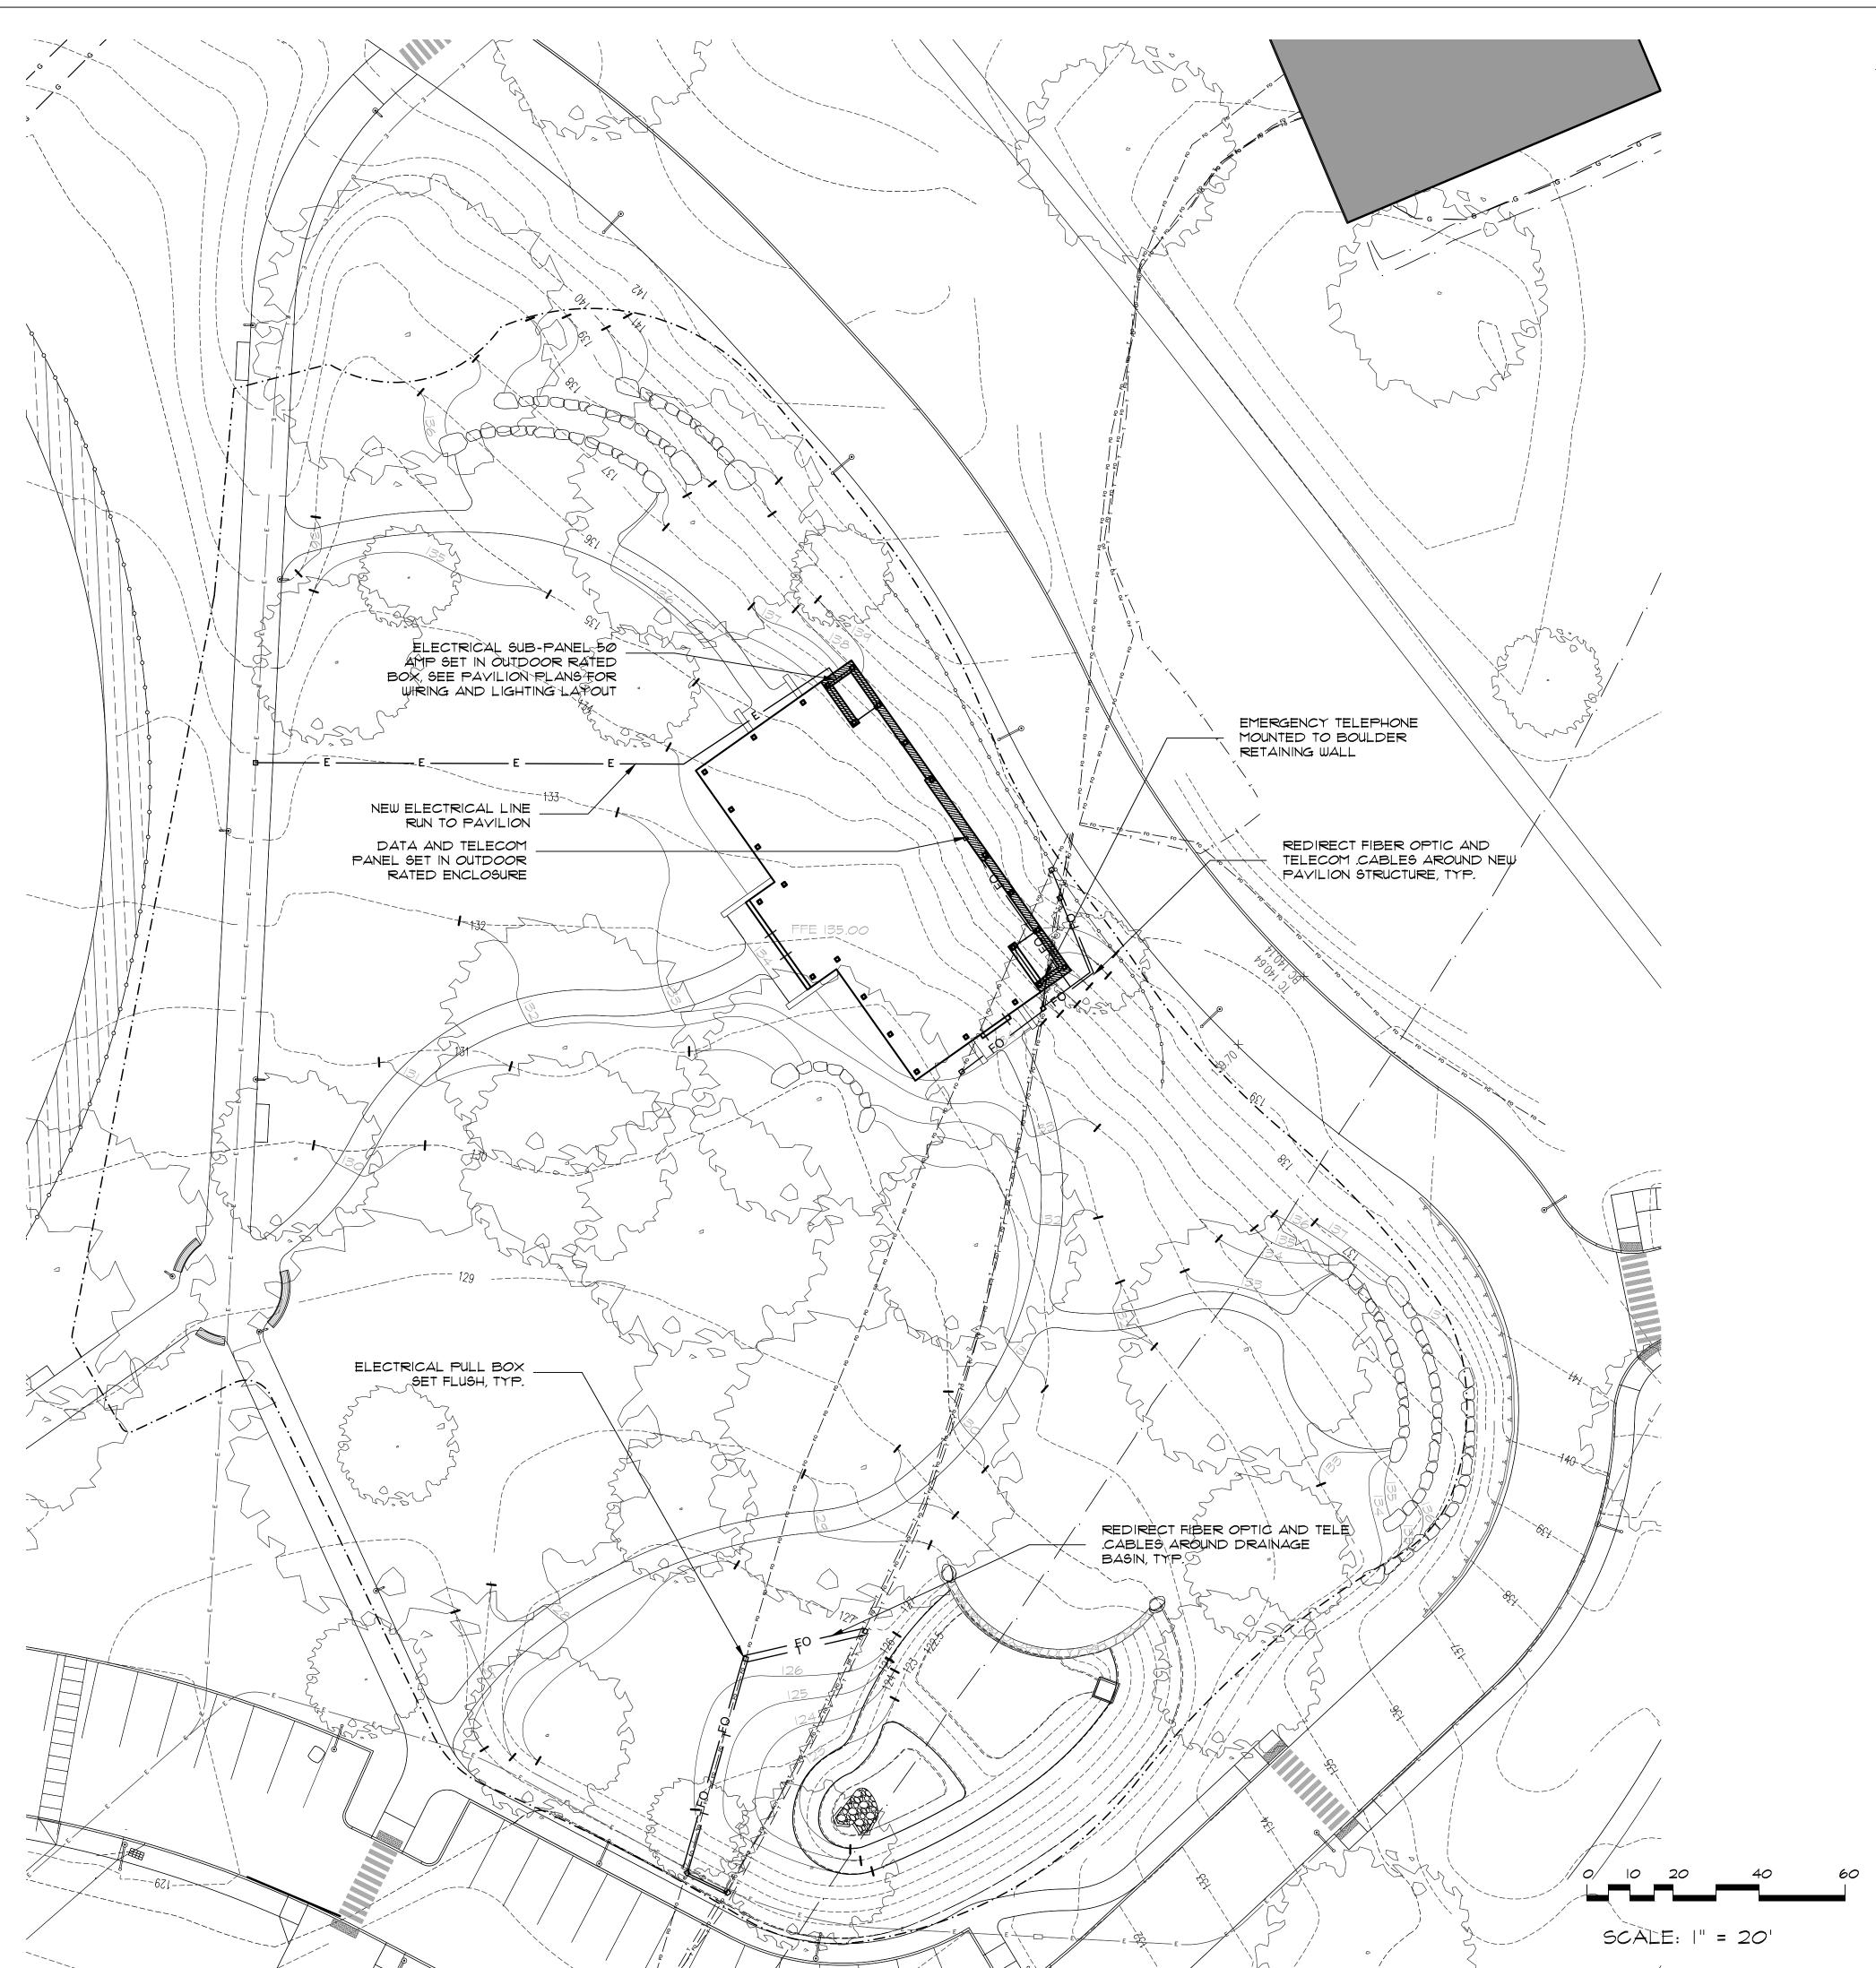
MERCY COLLEGE GROVE PAVILION

Mercy College 555 Broadway Dobbs Ferry, NY 10522

SITE DRAINAGE DIAGRAM

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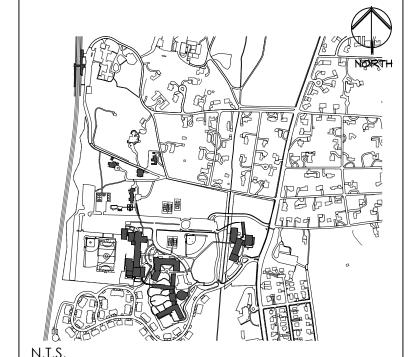


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- 2. PREPARE SUB-GRADE ELEVATIONS TO SUFFICIENT DEPTH TO INSURE NEW IMPROVEMENTS MEET EXISTING MATERIALS SMOOTHLY, EVENLY AND TO GRADE.
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LEGEND

	PROPERTY LINE
PLL	PROJECT LIMIT LINE
————190 — — —	EXIST. CONTOUR
S	EXISTING SANITARY SEWER MANHOLE
	EXISTING STORM DRAINAGE MANHOLE



Key Plan Not to Scale

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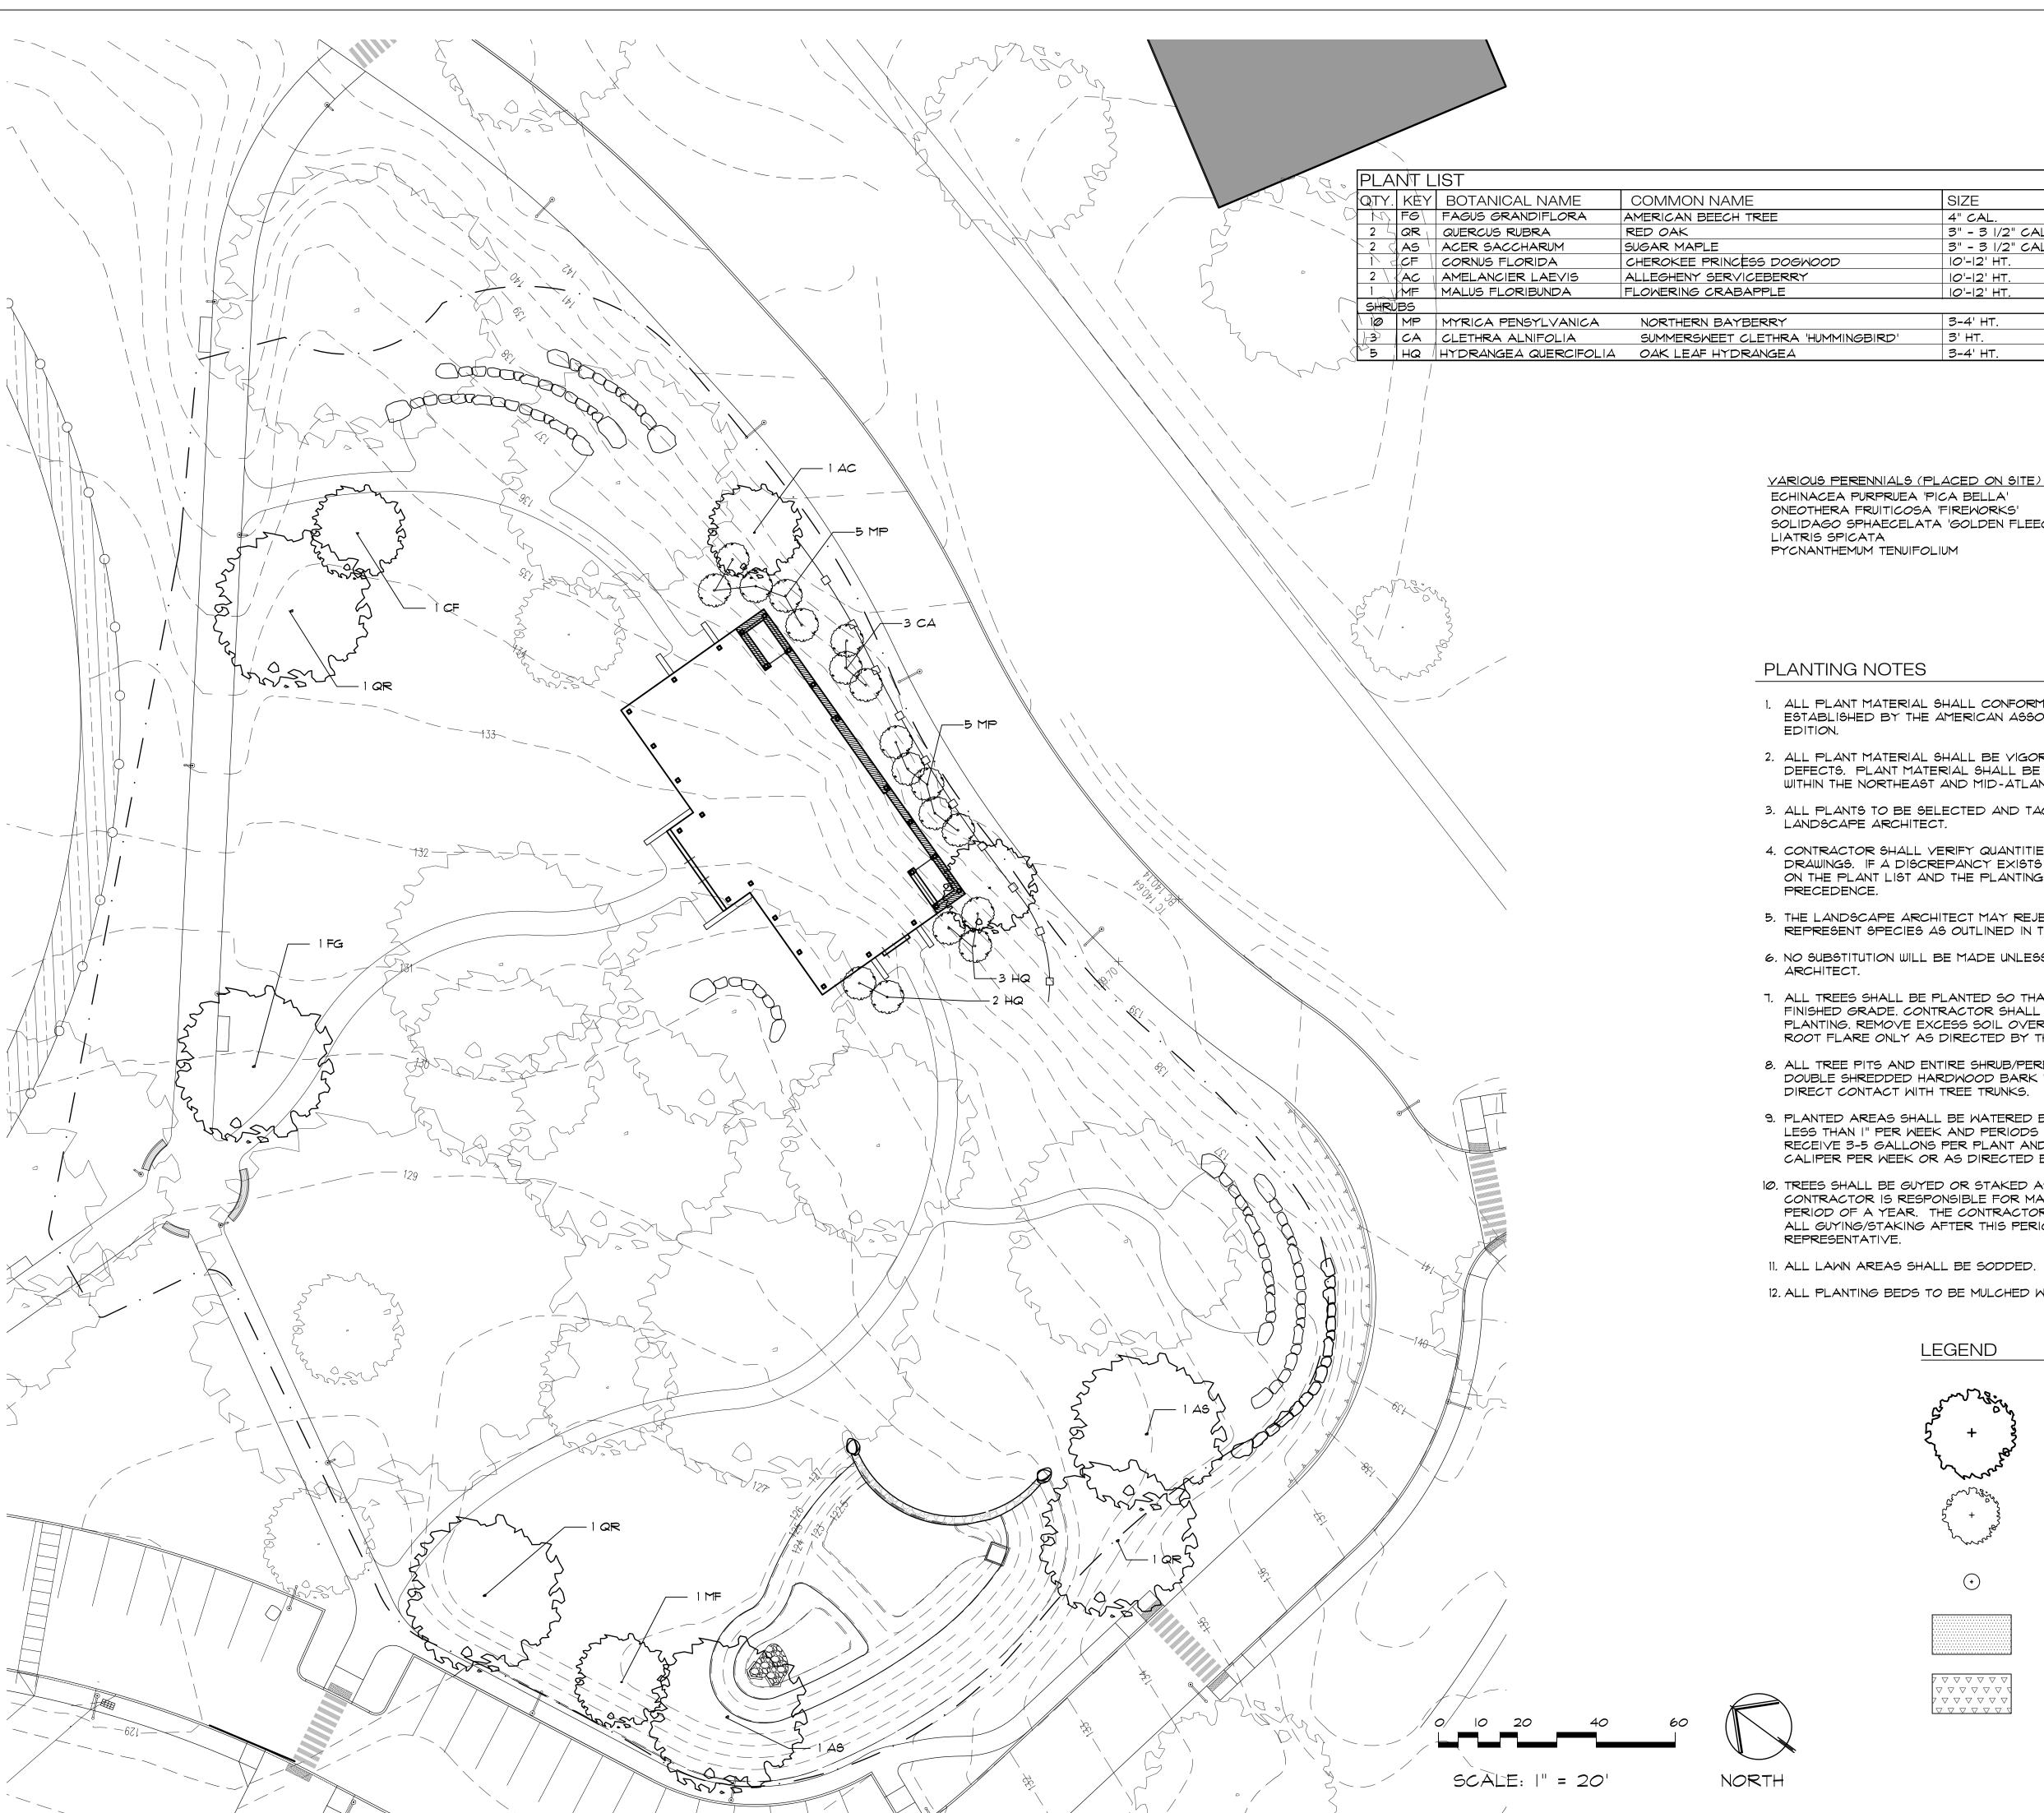
MERCY COLLEGE GROVE PAVILION


Mercy College 555 Broadway Dobbs Ferry, NY 10522

SITE UTILITY DIAGRAM

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Not to Scale Key Plan

ONEOTHERA FRUITICOSA 'FIREWORKS' SOLIDAGO SPHAECELATA 'GOLDEN FLEECE' LIATRIS SPICATA PYCNANTHEMUM TENUIFOLIUM

4" CAL.

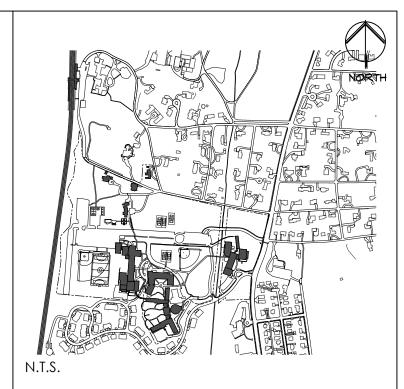10'-12' HT.

10'-12' HT

10'-12' HT.

3-4' HT

3-4' HT.

3' HT.

PLANTING NOTES

- 1. ALL PLANT MATERIAL SHALL CONFORM TO THE REQUIREMENTS AS ESTABLISHED BY THE AMERICAN ASSOCIATION OF NURSERYMAN, LATEST
- 2. ALL PLANT MATERIAL SHALL BE VIGOROUS AND FREE OF INJURY, INSECTS OR DEFECTS. PLANT MATERIAL SHALL BE STOCK FROM A RECOGNIZED NURSERY WITHIN THE NORTHEAST AND MID-ATLANTIC REGIONS.

COMMENTS

3" - 3 1/2" CAL. MULTI-STEM, THREE STEMS MIN.

3" - 3 1/2" CAL. FULL, SYMM., HEAD WITH SINGLE LEADER

QUANTITY

FULL, SYMM., HEAD WITH SINGLE LEADER

FULL, SYMM., HEAD WITH SINGLE LEADER

SOURCING FROM TWO DIFF. GROWERS


FULL, SYMM., HEAD WITH SINGLE LEADER

FULL, CLEAN FOLIAGE, FULL ROOT BASE

MULTI-STEM, THREE STEMS MIN.

MULTI-STEM, THREE STEMS MIN.

- 3. ALL PLANTS TO BE SELECTED AND TAGGED IN THE FIELD BY THE LANDSCAPE ARCHITECT.
- 4. CONTRACTOR SHALL VERIFY QUANTITIES AS SHOWN ON THE CONTRACT DRAWINGS. IF A DISCREPANCY EXISTS BETWEEN THE PLANT COUNT AS SHOWN ON THE PLANT LIST AND THE PLANTING PLAN(S), THE PLAN(S) SHALL TAKE PRECEDENCE.
- 5. THE LANDSCAPE ARCHITECT MAY REJECT ANY MATERIAL WHICH DOES NOT REPRESENT SPECIES AS OUTLINED IN THE PLANT LIST.
- 6. NO SUBSTITUTION WILL BE MADE UNLESS AUTHORIZED BY THE LANDSCAPE ARCHITECT.
- 7. ALL TREES SHALL BE PLANTED SO THAT THE ROOT FLARE IS I" 2" ABOVE FINISHED GRADE. CONTRACTOR SHALL VERIFY ROOT FLARE PRIOR TO PLANTING. REMOVE EXCESS SOIL OVER BALL AS REQUIRED TO EXPOSE THE ROOT FLARE ONLY AS DIRECTED BY THE LANDSCAPE ARCHITECT.
- 8. ALL TREE PITS AND ENTIRE SHRUB/PERENNIAL BEDS TO RECEIVE 2" LAYER OF DOUBLE SHREDDED HARDWOOD BARK MULCH. MULCH SHALL NOT COME IN DIRECT CONTACT WITH TREE TRUNKS.
- 9. PLANTED AREAS SHALL BE WATERED BY THE CONTRACTOR WHEN RAINFALL IS LESS THAN I" PER WEEK AND PERIODS OF EXCESSIVE HEAT. SHRUBS SHALL RECEIVE 3-5 GALLONS PER PLANT AND TREES 7-10 GALLONS PER INCH OF CALIPER PER WEEK OR AS DIRECTED BY THE LANDSCAPE ARCHITECT.
- 10. TREES SHALL BE GUYED OR STAKED AS INDICATED ON THE DRAWING. THE CONTRACTOR IS RESPONSIBLE FOR MAINTAINING ALL GUYING/STAKING FOR A PERIOD OF A YEAR. THE CONTRACTOR IS RESPONSIBLE FOR REMOVAL OF ALL GUYING/STAKING AFTER THIS PERIOD UPON DIRECTION OF THE OWNER'S REPRESENTATIVE.
- 11. ALL LAWN AREAS SHALL BE SODDED. SEE SPECIFICATIONS FOR TURF TYPE.
- 12. ALL PLANTING BEDS TO BE MULCHED WITH 2 INCHES OF CEDAR BARK MULCH.

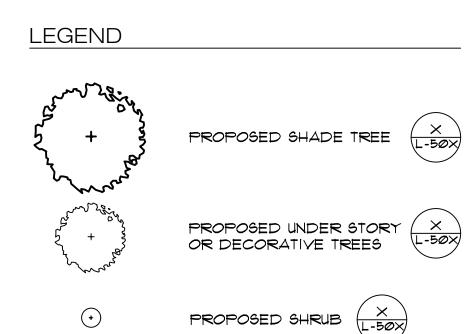

SEED AREA WITH
"NO MOW" SEED MIX (L-50)



PLANNING BOARD SUBMISSION

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Date

MERCY COLLEGE

GROVE PAVILION

Mercy College 555 Broadway Dobbs Ferry, NY 10522


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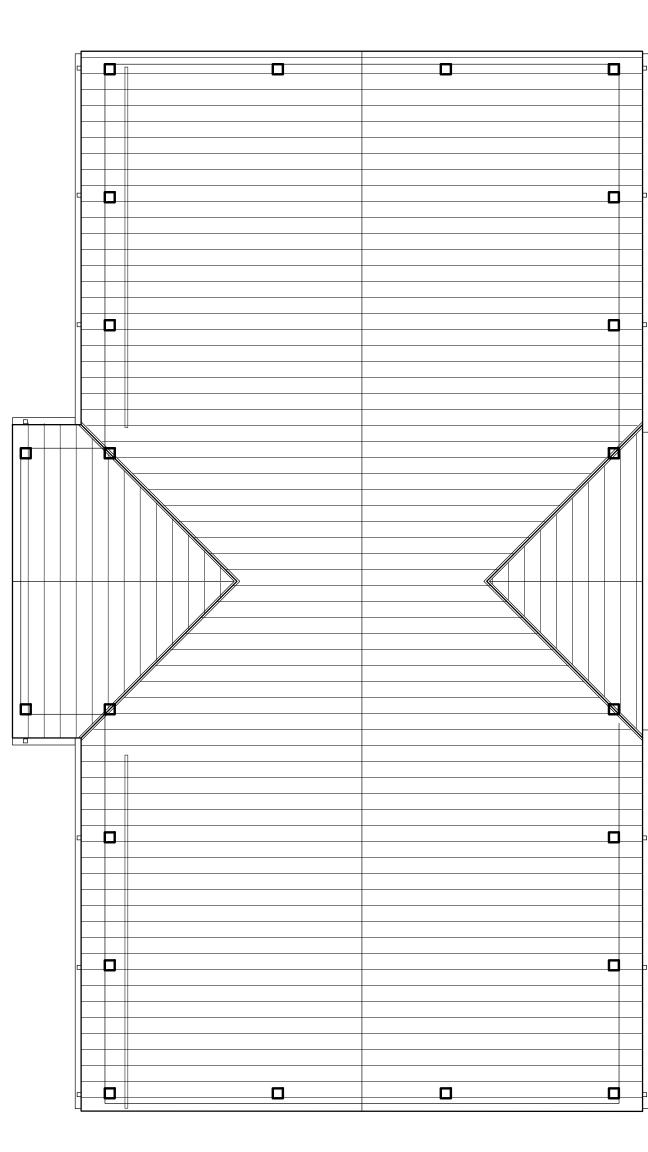
PLANTING PLAN

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NOTE:

FINAL CONSTRUCTION DRAWINGS INCLUDING CONNECTION
DETAILS, STRUCTURAL SIZING, AND FOOTINGS FOR PAVILION TO
BE PROVIDED BY HARMONY TIMBERWORKS



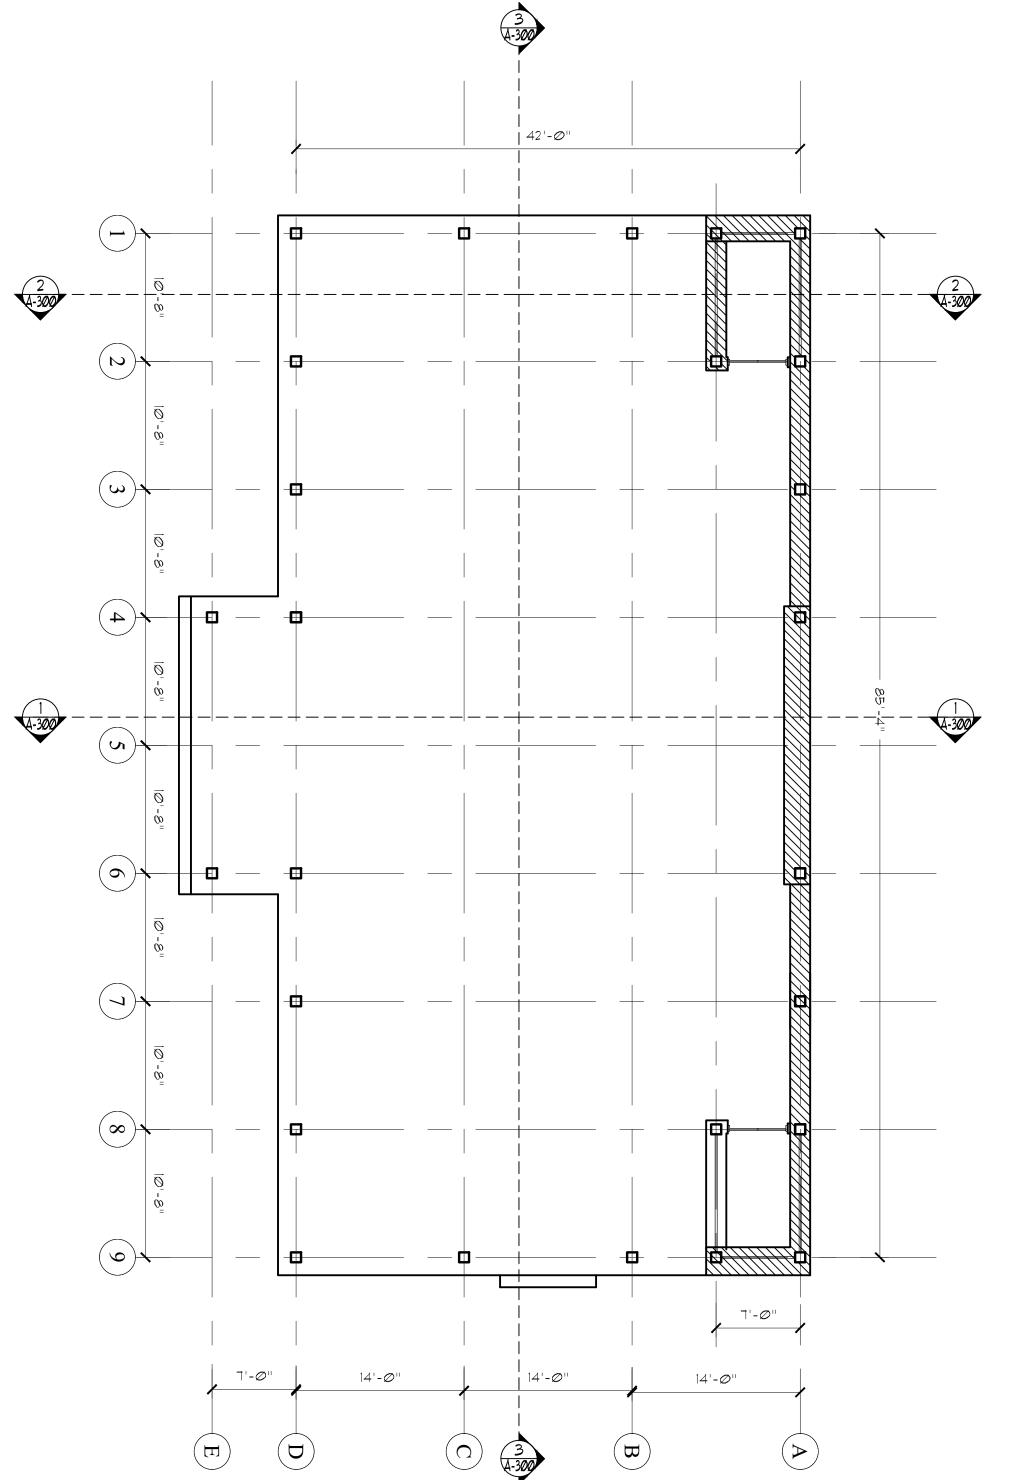

PAVILION PLAN

Drawing Title

Mercy College 555 Broadway Dobbs Ferry, NY 10522

Key Plan

Not to Scale

Drawing No. AS SHOWN 2201 CT CT

04/15/2022 PLANNING BOARD SUBMISSION

Date Revision/Submission

ALLOY DESIGN STUDIO PLLC
ARCHITECTURE - LANDSCAPE ARCHITECTURE
29 Perryridge road
Greenwich, Connecticut 06830 (203) 611-2723 Chris@alloydsgn.com

MERCY COLLEGE

GROVE PAVILION

PAVILION PLAN


FOUNDATION PLAN

PAVILION ROOF PLAN


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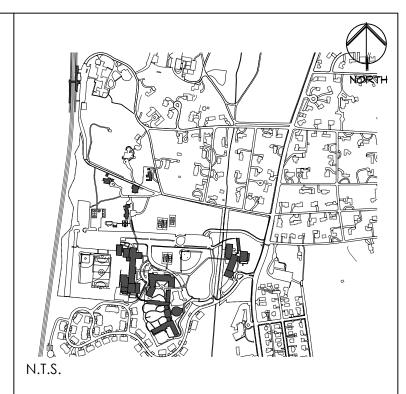
NOTE:

FINAL CONSTRUCTION DRAWINGS INCLUDING CONNECTION
DETAILS, STRUCTURAL SIZING, AND FOOTINGS FOR PAVILION TO
BE PROVIDED BY HARMONY TIMBERWORKS

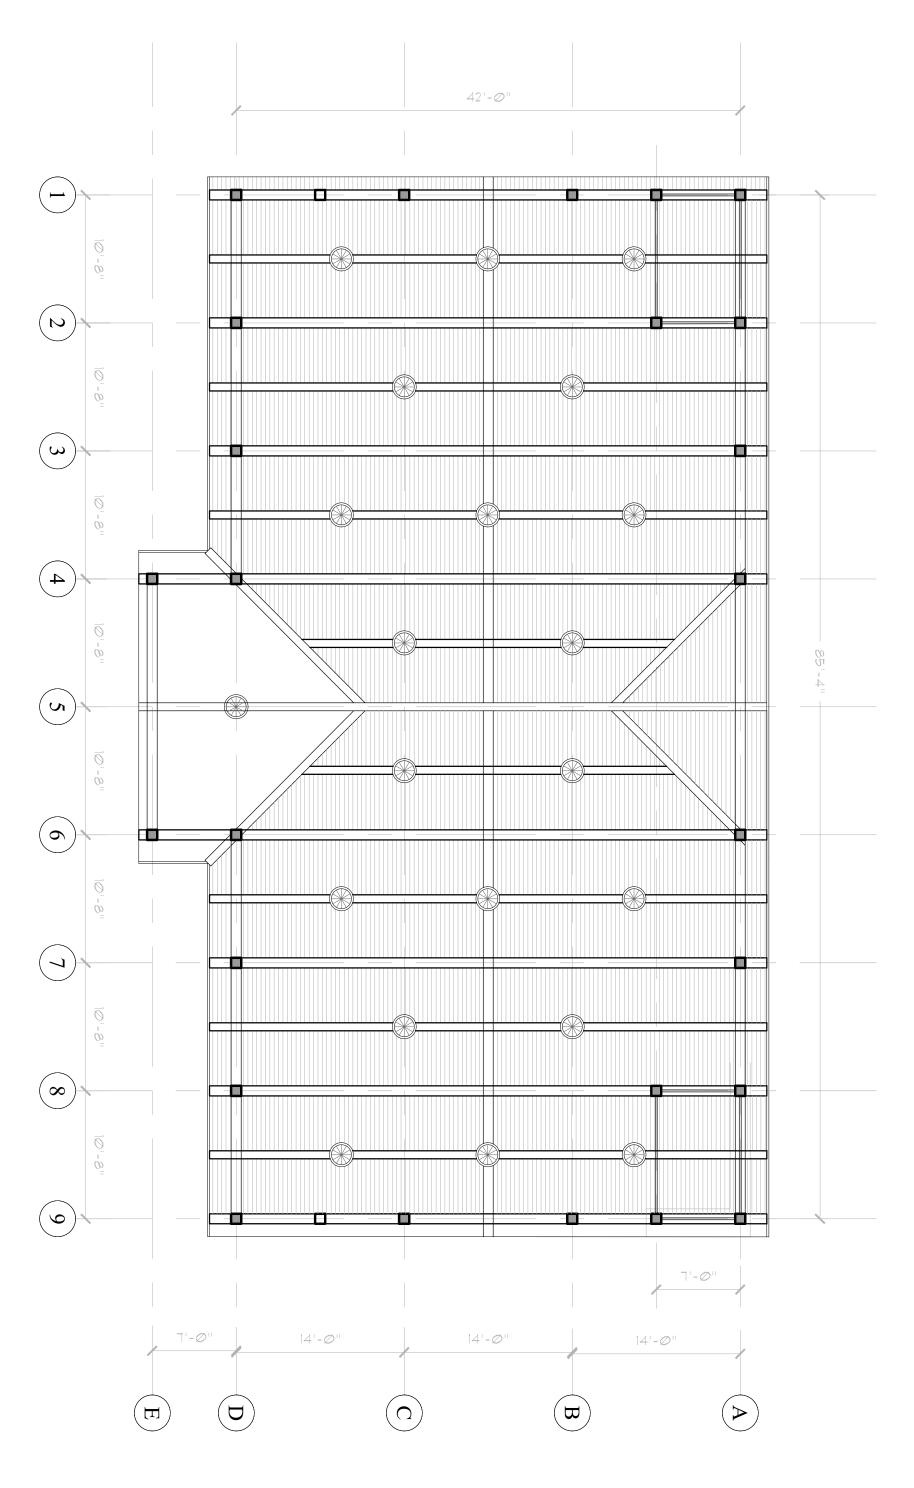

REFLECTED CEILING PLAN



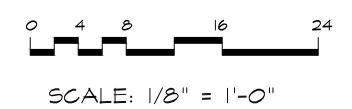

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1. 04/15/2022 PLANNING BOARD SUBMISSION

Date Revision/Submission




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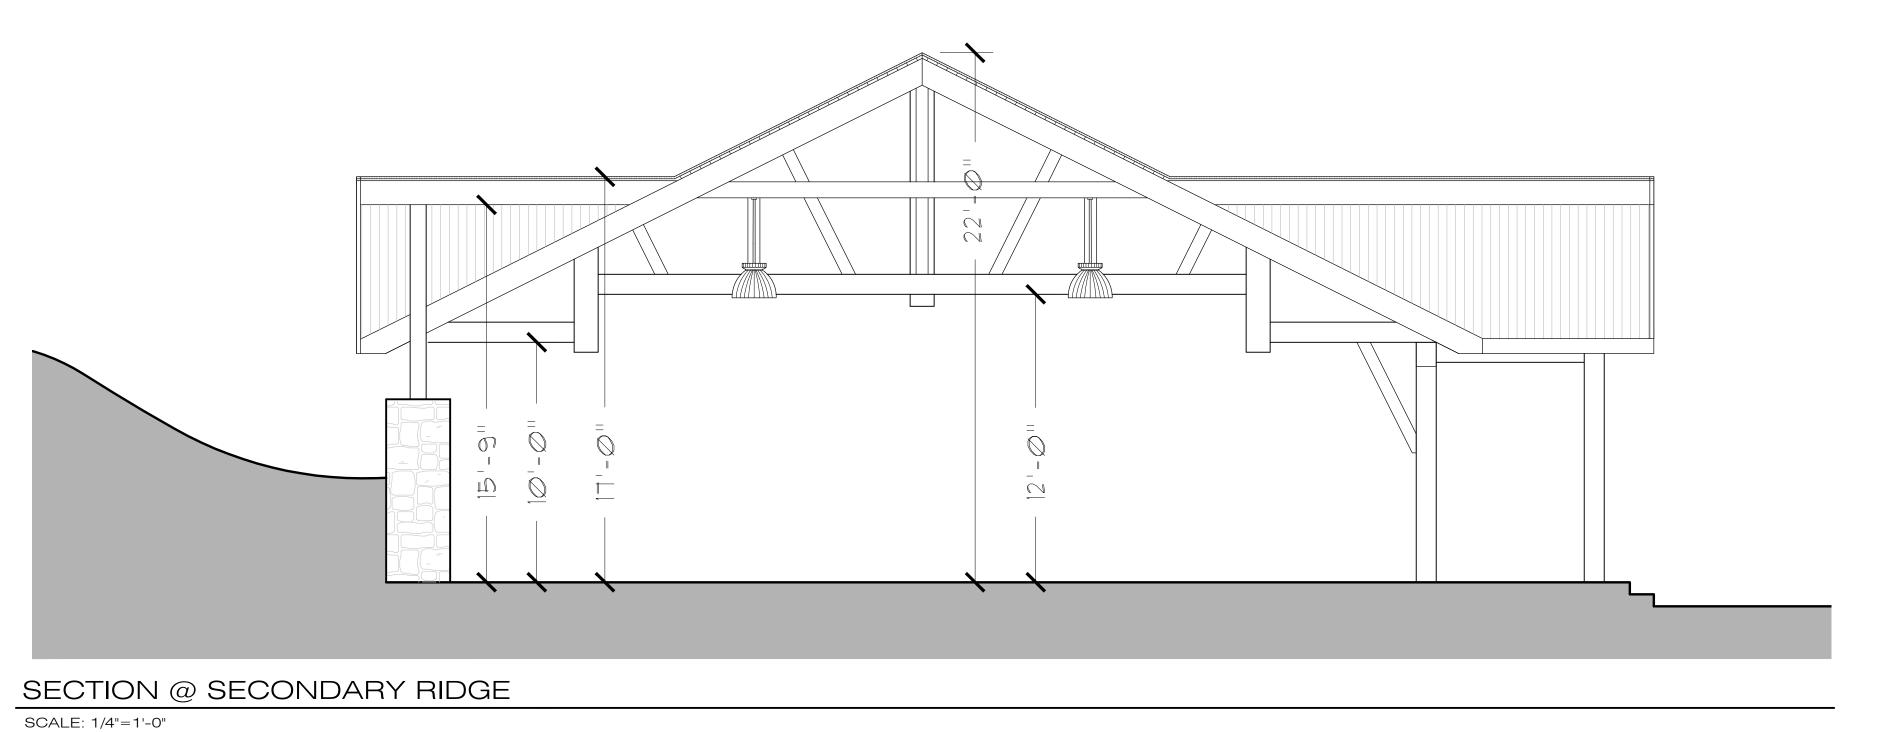
MERCY COLLEGE GROVE PAVILION

Mercy College 555 Broadway Dobbs Ferry, NY 10522


PAVILION REFLECTED CEILING PLAN


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2 SECTION @ LOCKABLE STORAGE SCALE: 1/4"=1'-0"



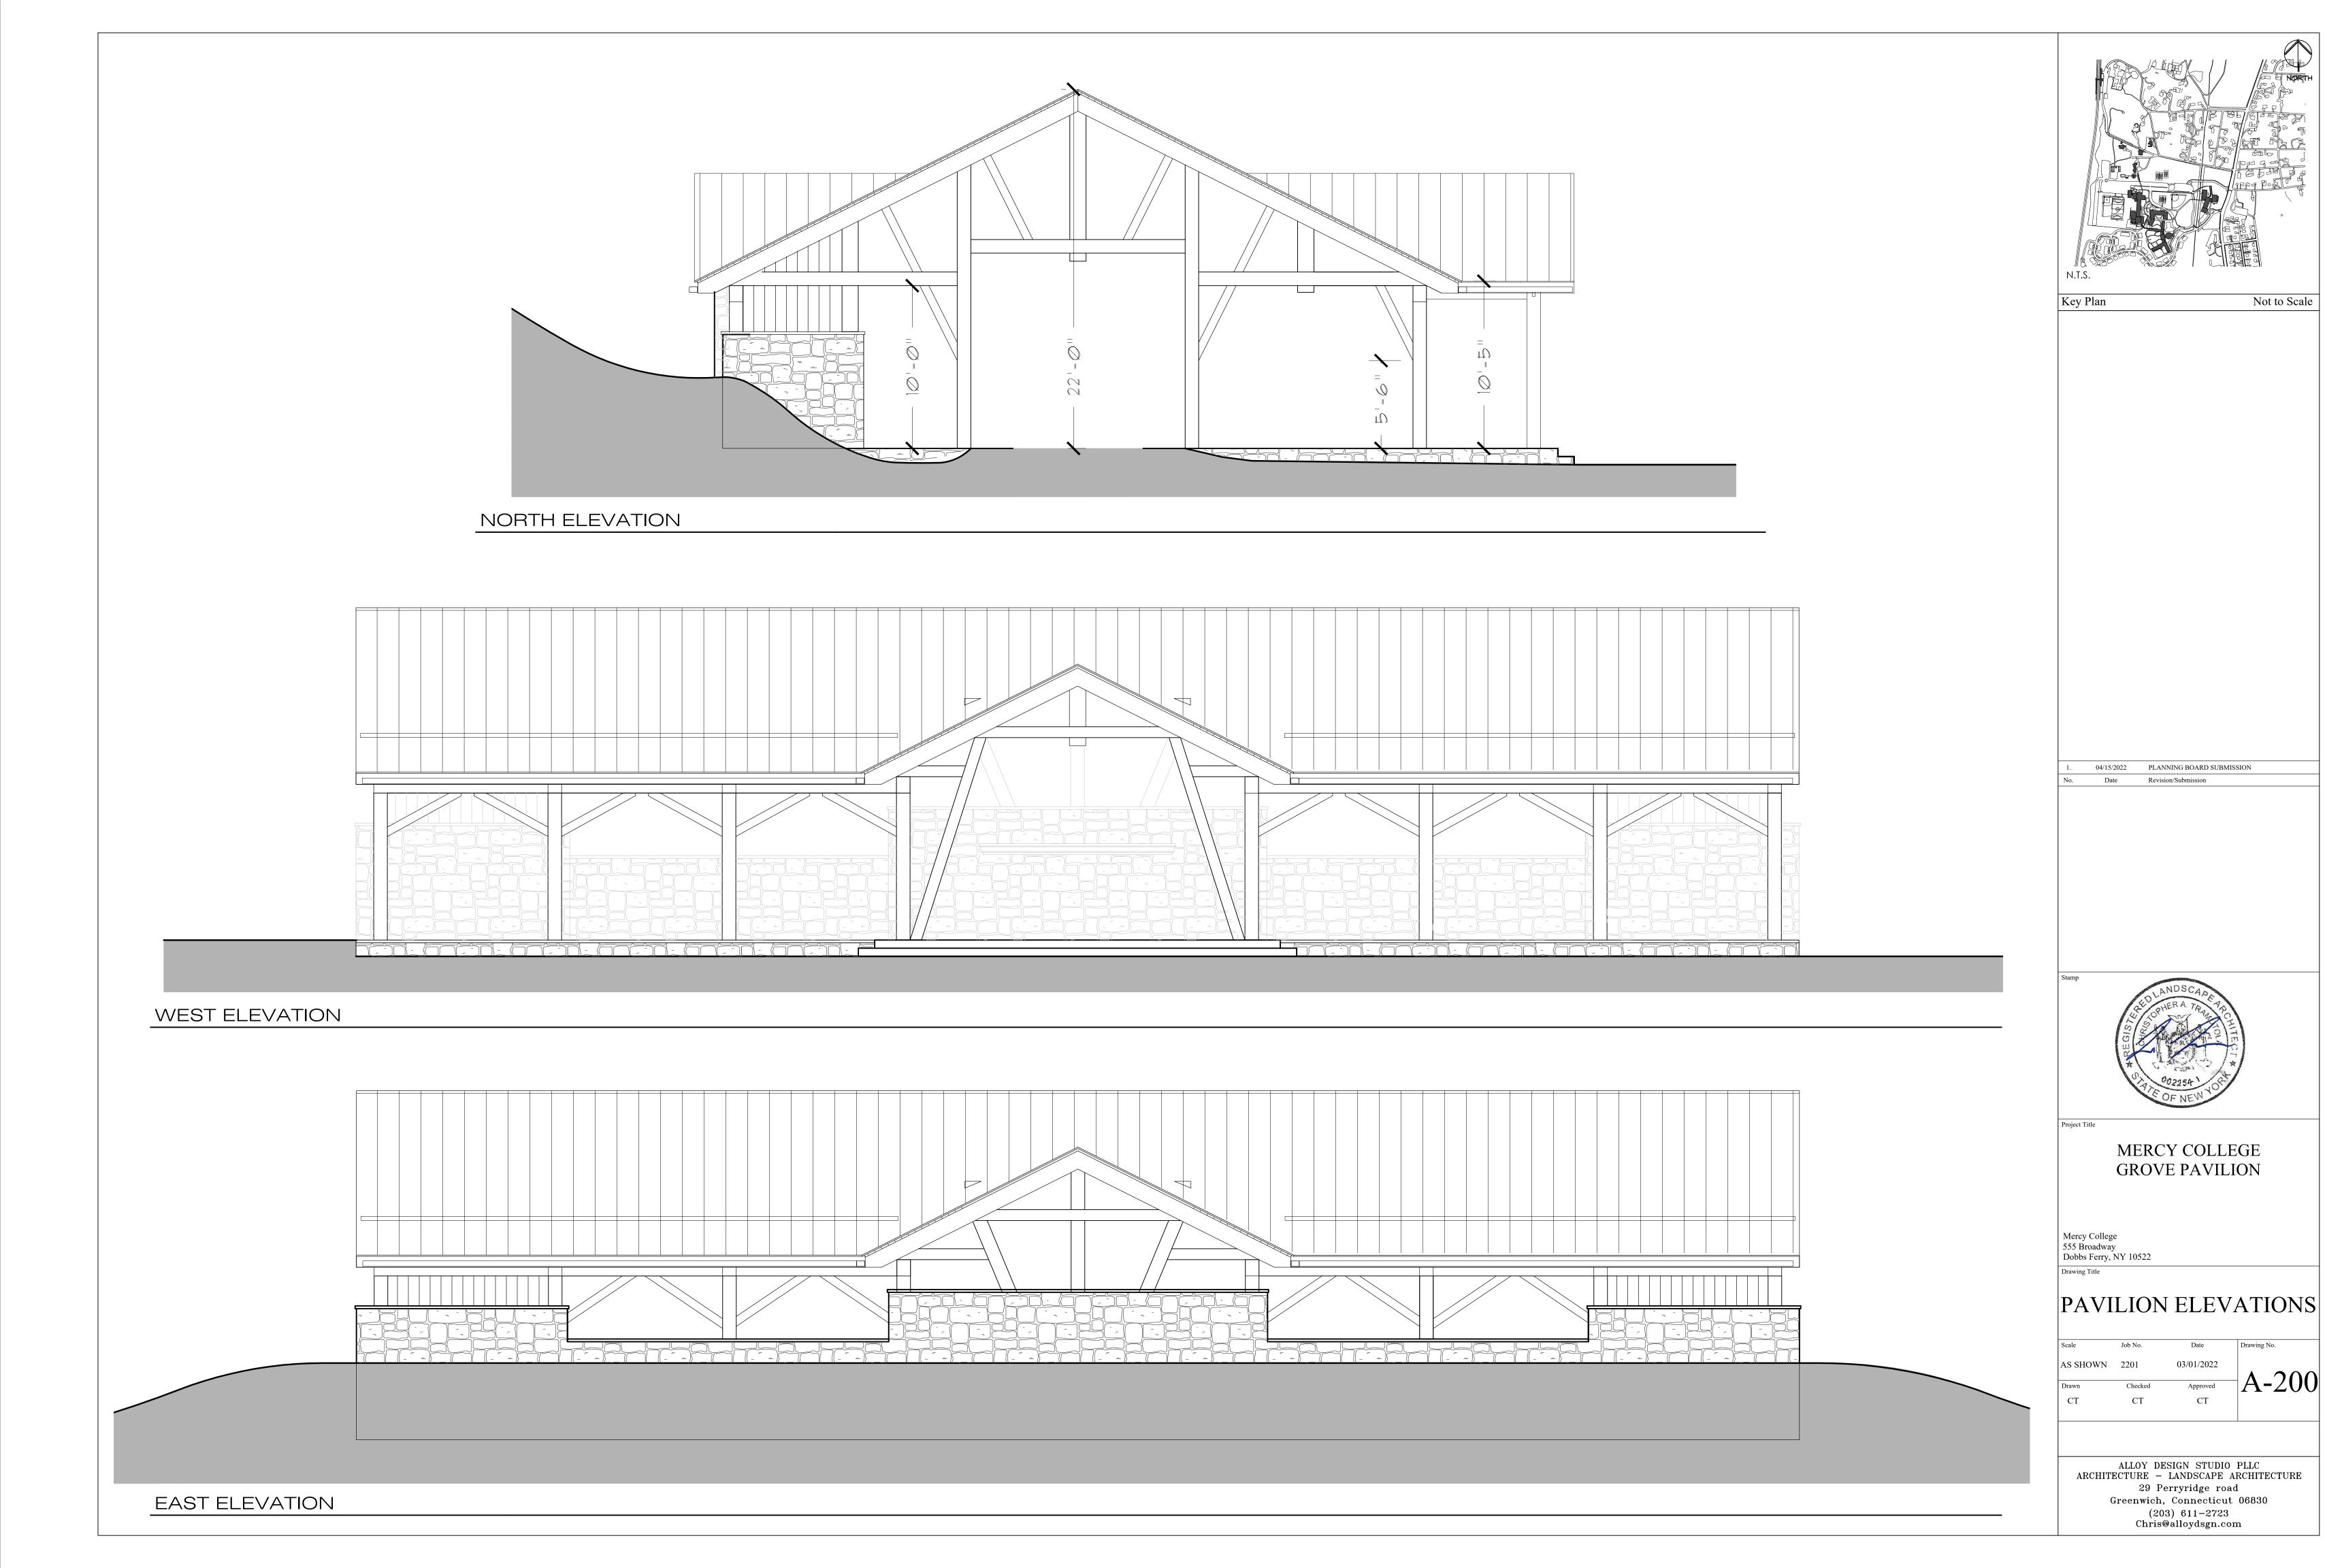

Key Plan	Not to Scale
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04/15/2022 PLANNING BOARD SUBMISSION Date Revision/Submission

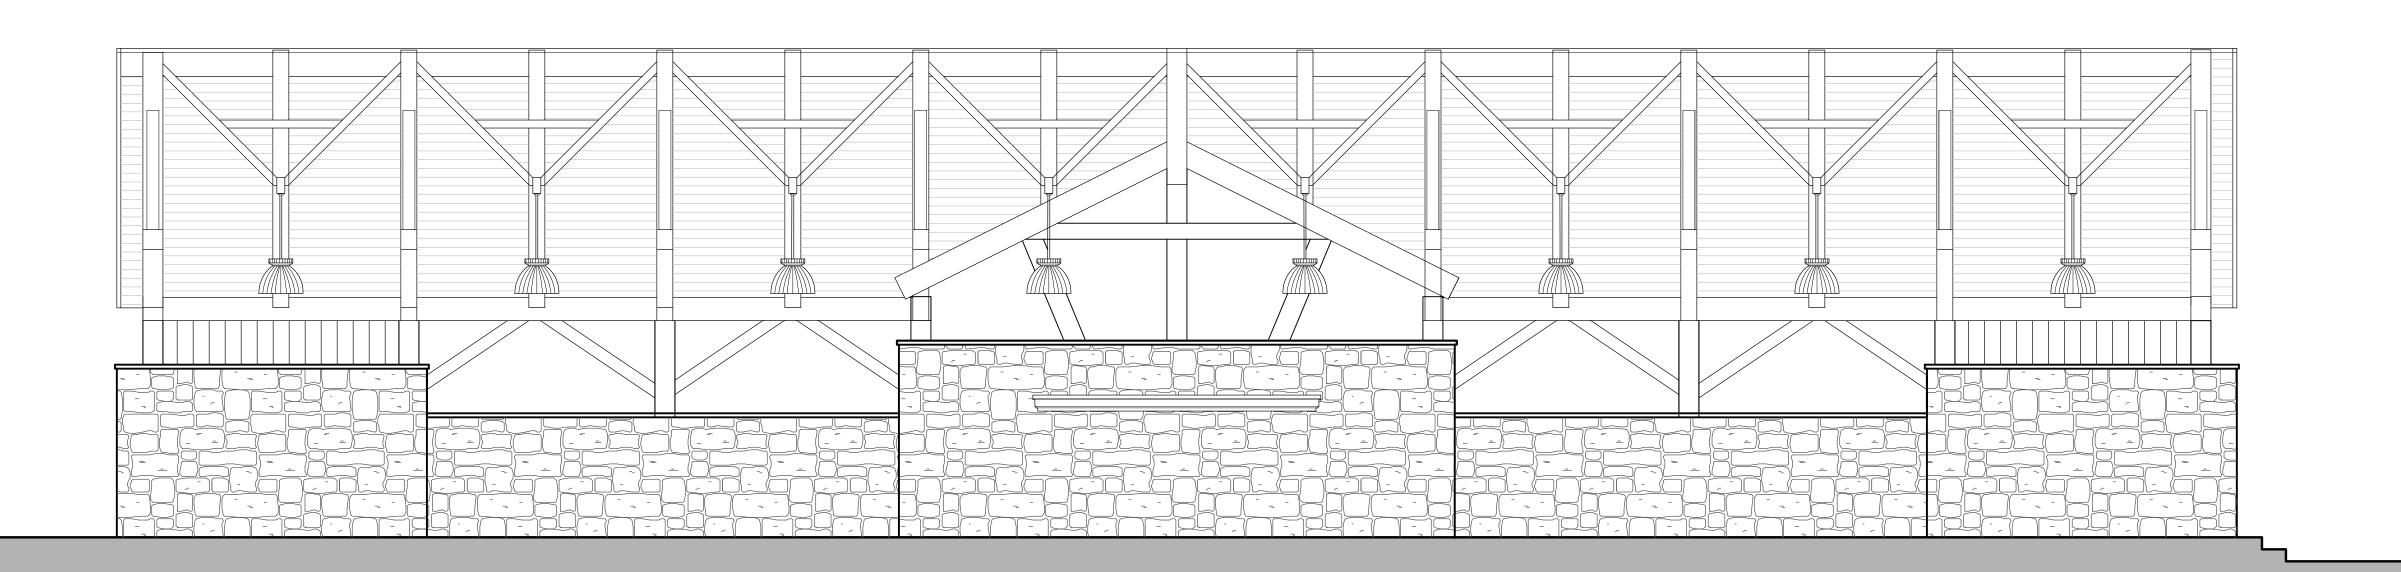

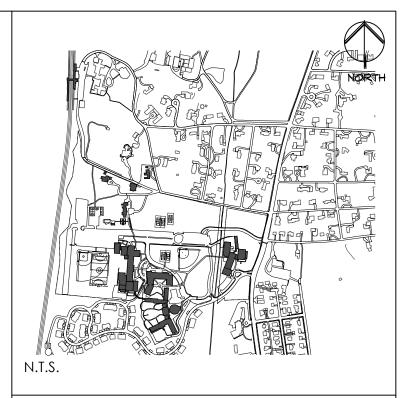MERCY COLLEGE **GROVE PAVILION**

Mercy College 555 Broadway Dobbs Ferry, NY 10522

Drawing Title

PAVILION SECTIONS

Scale	Job No.	Date	Drawing No.
AS SHOWN	2201	03/01/2022	A 200
Drawn	Checked	Approved	7A-3U
CT	CT	CT	

ALLOY DESIGN STUDIO PLLC ARCHITECTURE – LANDSCAPE ARCHITECTURE 29 Perryridge road Greenwich, Connecticut 06830 (203) 611-2723 Chris@alloydsgn.com

3 SECTION @ MAIN RIDGE

SCALE: 1/4"=1'-0"

SCALE: 1/4"=1'-0"