BEN-ZVI RESIDENCE - SINGLE FAMILY HOME ADDITION AND RENOVATION 243 JUDSON AVENUE DOBBS FERRY, NEW YORK 10522

TABLE OF CONTENTS

SURVEYS G-100.00 SP-100.00 SITE PLAN D-100.00 **DEMOLITION PLANS AND NOTES** CONSTRUCTION PLANS, DETAILS, AND NOTES A-100.00 A-101.00 CONSTRUCTION PLANS, DETAILS, AND NOTES A-102.00 FOUNDATION AND 1ST FLOOR FRAMING PLANS AND NOTES A-103.00 2ND FLOOR, ATTIC AND ROOF FRAMING PLANS AND NOTES A-130.00 REFLECTED CEILING PLANS, DETAILS & NOTES A-131.00 REFLECTED CEILING PLANS, DETAILS & NOTES A-200.00 EXISTING EXTERIOR ELEVATIONS PROPOSED EXTERIOR ELEVATIONS A-201.00 A-202.00 PROPOSED EXTERIOR ELEVATIONS A-300 00 BUILDING SECTIONS CONSTRUCTION DETAILS A-400.00 A-700.00 DOOR SCHEDULE AND DETAILS

WINDOW SCHEDULE AND DETAILS

GENERAL NOTES

A-701.00

1. SCOPE OF WORK: ADDITION TO REAR OF EXISTING SINGLE FAMILY HOME TO INCLUDE A NEW MUDROOM ON THE FIRST FLOOR AND EXPANSION OF AN EXISTING BEDROOM ON THE SECOND FLOOR. ADDITION TO REAR OF EXISTING SINGLE FAMILY HOME TO INCLUDE A NEW YOGA ROOM OFF THE FAMILY ROOM ON THE FIRST FLOOR AND A NEW MASTER SUITE ON THE SECOND FLOOR. RENOVATION OF CURRENT MASTER BEDROOM INTO A NEW LAUNDRY ROOM, WORK STATION, AND CLOSET AREA.

2. ALL WORK SHALL CONFORM TO THE REQUIREMENTS OF THE NEW YORK STATE RESIDENTIAL BUILDING CODE, AND LOCAL MUNICIPAL BUILDING CODE, FIRE DEPARTMENT REGULATIONS, UTILITY COMPANY REQUIREMENTS, AND THE BEST TRADE PRACTICES.

3. BEFORE COMMENCING WORK, THE CONTRACTOR SHALL FILE ALL REQUIRED CERTIFICATES OF INSURANCE WITH THE DEPARTMENT OF BUILDINGS, OBTAIN ALL REQUIRED PERMITS, AND PAY ALL FEES REQUIRED BY GOVERNING MUNICIPAL AGENCIES.

4. THE CONTRACTOR SHALL VERIFY ALL EXISTING CONDITIONS IN THE FIELD PRIOR TO COMMENCING WORK, AND SHALL REPORT ANY DISCREPANCIES BETWEEN DRAWINGS AND FIELD CONDITIONS TO THE ARCHITECT.

5. MINOR DETAILS NOT USUALLY SHOWN OR SPECIFIED, BUT NECESSARY FOR PROPER CONSTRUCTION OF ANY PART OF THE WORK SHALL BE INCLUDED AS IF THEY WERE INDICATED IN THE DRAWINGS.

6. THE CONTRACTOR SHALL COORDINATE ALL WORK PROCEDURES WITH REQUIREMENTS OF LOCAL AUTHORITIES, BUILDING MANAGEMENT, OR BOARD OF DIRECTORS.

7. THE CONTRACTOR SHALL BE RESPONSIBLE FOR THE PROTECTION OF ALL CONDITIONS AND MATERIALS WITHIN THE PROPOSED CONSTRUCTION AREA. THE CONTRACTOR SHALL DESIGN AND INSTALL ADEQUATE SHORING AND BRACING FOR ALL STRUCTURAL OR REMOVAL TASKS. THE CONTRACTOR SHALL HAVE SOLE RESPONSIBILITY FOR ANY DAMAGE OR INJURIES CAUSED BY OR DURING THE EXECUTION OF THE WORK.

8. THE CONTRACTOR SHALL LAY OUT HIS OWN WORK, AND SHALL PROVIDE ALL DIMENSIONS REQUIRED FOR OTHER TRADES: PLUMBING, ELECTRICAL, ETC.

9. PLUMBING AND ELECTRICAL WORK SHALL BE PERFORMED BY PERSONS LICENSED IN THEIR TRADES, WHO SHALL ARRANGE FOR AND OBTAIN INSPECTIONS AND REQUIRED SIGN-OFFS.

10. THE CONTRACTOR SHALL DO ALL CUTTING, PATCHING, REPAIRING AS REQUIRED TO PERFORM ALL OF THE WORK INDICATED ON THE DRAWINGS, AND ALL OTHER WORK THAT MAY BE REQUIRED TO COMPLETE THE JOB.

11. ALL PIPING AND WIRING SHALL BE REMOVED TO A POINT OF CONCEALMENT AND SHALL BE PROPERLY

CAPPED OR PLUGGED.

12. THE ARCHITECT HAS NOT BEEN RETAINED TO PROVIDE SUPERVISION.

13. THE CONTRACTOR SHALL BE RESPONSIBLE FOR PROVIDING SIDEWALK SHED FOR PROTECTION OF THE

14. ALL PAINTS, COATINGS AND PRIMERS APPLIED TO THE INTERIOR SURFACES SHALL NOT EXCEED THE FOLLOWING VOC CONTENT LIMITS (AS ESTABLISHED BY GREEN SEAL STANDARD GC-11, PAINTS, EDITION 3.1, JULY 2013, AS AMENDED):

FLAT PAINT: 50G/L FLAT NON-FLAT PAINT: 150G/L NON-FLAT

15.CLEAR WOOD FINISHES, FLOOR COATINGS, STAINS, SEALERS, AND SHELLACS, APPLIED TO INTERIOR SURFACES, SHALL NOT EXCEED THE FOLLOWING VOC CONTENT LIMITS (AS ESTABLISHED BY SOUTH COAST AIR QUALITY MANAGEMENT DISTRICT RULE 1113, ARCHITECTURAL COATINGS, JUNE 3, 2011, AS AMENDED):

VARNISH: 275 G/I

LAQUER: 275 G/L SHELLAC: 730 G/L CLEAR, 550 G/L PIGMENTED

SEALERS: 100 G/L WATERPROOFINGS, 275 G/L SANDING, 100G/L ALL OTHERS.

16. NO MATERIALS SHALL CONTAIN ADDED UREA FORMALDEHYDE.

17. A MINIMUM OF 25% OF CONSTRUCTION WASTE BY WEIGHT SHALL BE RECYCLED, REPURPORSED AND OR / REUSED AND NOT SENT TO LANDFILL OR INCINERATOR.

18. FOUNDATIONS ARE TO BE SIGNED OFF BY ARCHITECT OR ENGINEER PRIOR TO ANY RECONSTRUCTION.

19. DESIGN LOADS ARE AS FOLLOWS PER SQUARE FOOT:


| LOCATION | LIVE | DEAD | DEFLECTION LIMIT | |
|---------------------------|-------------|-------|------------------|--|
| ROOMS OTHER THAN SLEEPING | 40lb. | 10lb. | L/360 | |
| SLEEPING | 30lb. | 10lb. | L/360 | |
| ATTIC (NON STORAGE) | 10lb. | 5lb. | L/240 | |
| ATTIC (STORAGE) | 20lb. | 10lb. | L/240 | |
| ROOF (WITH FIN. CLG.) | 20lb.(SNOW) | 15lb. | L/240 | |
| ROOF (NO FIN. CLG.) | 20lb.(SNOW) | 7lb. | L/240 | |

CANBOLS AND WALEDIALS LECEVID

FINISH WOOD

| 21WRC | ILS AND MATERIALS LEGEND | | |
|------------|------------------------------------|---------------|--------------|
| | | | |
| | EXISTING WALLS TO REMAIN | (004) | WINDOW KEY |
| | CONCRETE | 006 | DOOR KEY |
| | EARTH | ROOM NAME | |
| \searrow | WOOD BLOCKING CONTINUOUS | # SQ FT | ROOM KEY |
| | WOOD BLOCKING INTERMEDIATE (SHIMS) | | |
| | BRICK | # Scale: xxxx | DRAWING NAME |
| | STEEL | X | DETAIL KEY |
| | | \ AXXX | DEIAILKEI |

PLOT PLAN SCALE: 1" = 200'

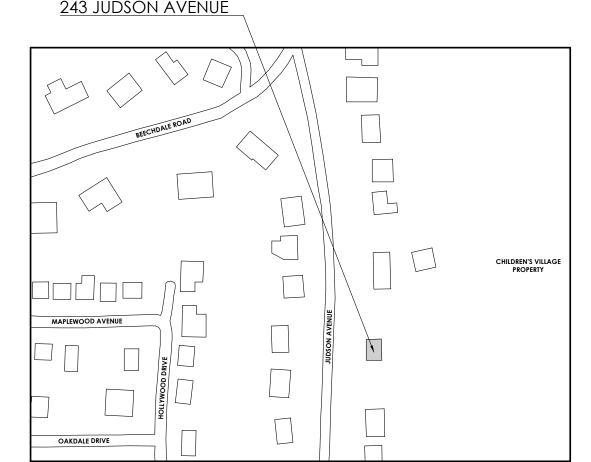

TENANT SAFETY PLAN

2015 BUILDING CODE - TENANT PROTECTION PLAN NOTES ALL CONSTRUCTION WORK TO COMPLY WITH THE 2020 NEW YORK STATE RESIDENTIAL CODE

1. EGRESS: AT ALL TIMES IN THE COURSE OF CONSTRUCTION PROVISION SHALL BE MADE FOR ADEQUATE EGRESS AS REQUIRED BY THIS CODE AND THE TENANT PROTECTION PLAN SHALL IDENTIFY THE EGRESS THAT WILL BE PROVIDED. REQUIRED EGRESS SHALL NOT BE OBSTRUCTED AT ANY TIME.

2. FIRE SAFETY: ALL NECESSARY LAWS AND CONTROLS, INCLUDING THOSE WITH RESPECT TO OCCUPIED DWELLINGS, AS WELL AS ADDITIONAL SAFETY MEASURES NECESSITATED BY THE CONSTRUCTION SHALL BE

3. HEALTH REQUIREMENTS: SPECIFICATION OF METHODS TO BE USED FOR CONTROL OF DUST, DISPOSAL OF CONSTRUCTION DEBRIS, PEST CONTROL AND MAINTENANCE OF SANITARY FACILITIES, AND LIMITATION OF NOISE TO ACCEPTABLE LEVELS SHALL BE INCLUDED.

4.1. THERE SHALL BE INCLUDED A STATEMENT OF COMPLIANCE WITH APPLICABLE PROVISIONS OF LAW RELATING TO LEAD AND ASBESTOS.

5. STRUCTURAL SAFETY: NO STRUCTURAL WORK SHALL BE DONE THAT MAY ENDANGER THE OCCUPANTS.

6. NOISE RESTRICTIONS: WHERE HOURS OF THE DAY OR THE DAYS OF THE WEEK IN WHICH CONSTRUCTION WORK MAY BE UNDERTAKEN ARE LIMITED PURSUANT TO LOCAL MUNICIPALITY NOISE CONTROL CODE, SUCH

ZONING

| TABLE 1: BUILDING INFO | | | |
|------------------------|--------------|------|-------------------|
| ADDRESS | SBL | ZONE | USE |
| 243 JUDSON AVENUE | 3.171-151-17 | OF-4 | 1 FAMILY DWELLING |

NOTE: PROPERTY OWNERS ALSO OWN SBL 3.171-151-15, BUT THERE IS A SMALL EASEMENT LOT BETWEEN THE TWO PROPERTIES (SBL 3.171-151-16).

TABLE 2: BUILDING DIMENSIONS


| | EXISTING | PROPOSED | MIN. ALLOWABLE | COMMENTS |
|--|------------------------|------------------------|----------------|---|
| LOT AREA (SF) | 18,837 SF. | 18,837 SF. (NO CHANGE) | 10,000 SF. | |
| LOT WIDTH (FT) | 111.20' | 111.20' (NO CHANGE) | 100'-0'' | |
| LOT DEPTH (FT) | 163.19' | 163.19' (NO CHANGE) | 100'-0'' | |
| COVERAGE BY BUILDING (SF) | 1,186 SF. | 1,471 SF. | | |
| COVERAGE BY BUILDING (%) | 6.3% | 7.8% | 20% (MAX) | |
| IMPERVIOUS SURFACE (SF) | 2,596 SF. | 2,787 SF. | | |
| IMPERVIOUS SURFACE (%) | 13.8% | 14.8% | 40% (MAX) | |
| FRONT YARD SET BACK (FT) | 66.5' | 66.5' (NO CHANGE) | 25'-0'' | |
| REAR YARD SET BACK (FT) | 74.3' | 65.7' | 25'-0'' | |
| SIDE YARD SET BACK, EACH (FT) NORTH (N) & SOUTH (S) | 10.3' (E) 24.4' (W) | 10.3' (E) 21.1' (W) | 12'-0" | EXISTING NON-CONFORMING (VARIANCE REQUIRED) |

TABLE 3: HEIGHT

| | existing | PROPOSED | MAX. ALLOWABLE |
|------------------------------|----------|-------------------|----------------|
| NUMBER OF STORIES | 2.5 | 2.5 | 2.5 |
| BUILDING HEIGHT (FROM FRONT) | 26.5' | 26.5' (NO CHANGE) | 35'-0" |
| BUILDING HEIGHT (FROM REAR) | 27.2' | 27.2' (NO CHANGE) | 35'-0" |

| | CLIMATE AND GEOGRAPHIC DESIGN CRITERIA | | | | | | | | |
|--------------|--|------------------------|------------|------------------------|----------------------|-----------------------|-------------------|--------------------------|-----------------|
| GROUND (1) | WIND | SEISMIC | S | SUBJECT TO DAMAGE FROM | | | AIR | ICE SHEILD | |
| SNOW LOAD | SPEED (MPH) | DESIGN CATEGORY (g) | WEATHERING | FROSTLINE DEPTH (b) | TERMITE(c) | DECAY(d) | FREEZING INDEX | UNDERLAYMENT REQUIRED | FLOOD HAZARD |
| 30LBS | 115 SPECIAL WIND REGION | С | SEVERE | 42" | MODERATE TO HEAVY | SLIGHT TO MODERATE | 2000 | YES | N/A |

SCALE: NTS

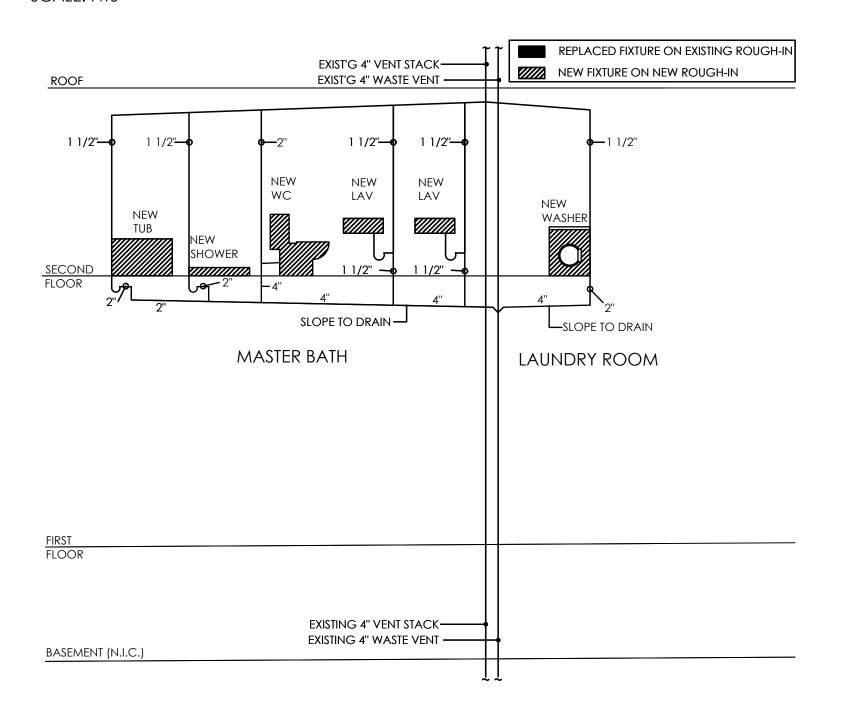

PLUMBING SYSTEMS SUCH AS SANITARY, WASTE, VENT, WATER DISTRIBUTION, GAS AND ALL ASSOCIATED EQUIPMENT WILL BE INSTALLED AND MAINTAINED IN ACCORDANCE WITH THE FULL REQUIREMENTS OF NEW YORK CITY 2014 PLUMBING CODE.

101.4.3 ADDITIONS, ALTERATIONS, RENOVATIONS OR REPAIRS:

1. THE SANITARY SYSTEM SHALL BE PROVIDED IN FULL ACCORDANCE WITH THE GENERAL PROVISIONS OF SECTION PC301.

2. THE MATERIALS USED IN THE PLUMBING SYSTEMS WILL BE PROVIDED IN FULL ACCORDANCE WITH SECTIONS PC302 AND PC303.

3. EQUIPMENT HOOK-UP AND THE JOINING WILL BE IN FULL COMPLIANCE WITH SECTIONS PC605 AND

4. THE INSTALLATION OF FIXTURES WILL B E IN FULL ACCORDANCE WITH PC CHAPTER 4

5. TRAPS FOR FIXTURES AND DRAIN LINES WILL BE PROVIDED AND CLEANOUTS INSTALLED IN FULL

COMPLIANCE WITH SECTIONS PC412, PC708 AND PC CHAPTER 10.

6. VERTICAL AND HORIZONTAL PIPING WILL BE HUNG AND SUPPORTED AS DIRECTED IN SPECIFICATIONS AND WITH FULL COMPLIANCE WITH SECTION PC308.

7. THE WATER SUPPLY SYSTEMS OF THE SUBJECT BUILDING SHALL BE INSTALLED AND MAINTAINED IN FULL COMPLIANCE WITH PC CHAPTER 6.

8. THE SANITARY DRAINAGE SYSTEM WILL BE SIZED AND INSTALLED IN FULL COMPLIANCE WITH PC

9. THE VENT PIPING FOR THE SANITARY DRAINAGE SYSTEMS OF THE SUBJECT BUILDING WILL BE

INSTALLED IN FULL COMPLIANCE WITH SECTION PC702 & PC CHAPTER 9.

10. THE STORM DRAINAGE SYSTEM AND PIPING WILL BE INSTALLED IN FULL COMPLIANCE WITH PC 11. GAS PIPING AND EQUIPMENT WILL BE INSTALLED IN FULL COMPLIANCE WITH NEW YORK STATE

12. ALL TRENCHING SHALL BE DONE IN ACCORDANCE WITH THE REQUIREMENTS OF SECTION PC306.

13. RAT PROOFING SHALL BE IN ACCORDANCE WITH SECTION PC304.

14. TEMPORARY TOILET FACILITIES SHALL BE PROVIDED FOR WORKMAN AS PER SECTION PC311.

ENERGY CODE COMPLIANCE

| WESTCHESTER: CLIMATE ZONE 4A | | | |
|------------------------------|-------------|-----------------|---------|
| COMPONENT: | REQUIREMENT | PROPOSED DESIGN | DRAWING |
| FENESTRATION U FACTOR: | 0.35 | 0.35 | A-700 |
| SKYLIGHT U FACTOR: | 0.60 | N/A | |
| CEILING R-VALUE | 38 | 38 | A-400 |
| FRAME WALL U-FACTOR | .082 | .082 | A-400 |
| MASS WALL U VALUE | .141 | N/A | |
| FLOOR R- VALUE | 19 | 19 | A-400 |
| BASEMENT WALL R-VALUE | 10/ 13 c | N/A | |
| SLAB R VALUE | 10, 2FTd | N/A | |
| CRAWL SPACE WALL R- VALUE | 10/13C | 10/13C | A-400 |
| | | | |

MATTHEW CORDONE ARCHITECT PLLC 92 North Broadway Irvington, NY 10533 phone: 917.749.8071 mcordone@mcapllc.net

OWNERS:

AVI & RUTHIE BEN-ZVI 243 JUDSON AVENUE DOBBS FERRY, NY 10522

CONSULTANTS

KEY PLAN

REVISIONS 5/24/2021 7/15/2021 PLANNING BOARD SET

SEAL & SIGNATURE




PROJECT:


SINGLE FAMILY HOME ADDITION 243 JUDSON AVENUE DOBBS FERRY, NY 10522


DRAWING TITLE: TITLE SHEET

DATE: 02/22/2021 **DWG NO:**

DRAWN BY: LCG T-100.00 **CHECKED BY:** MVC

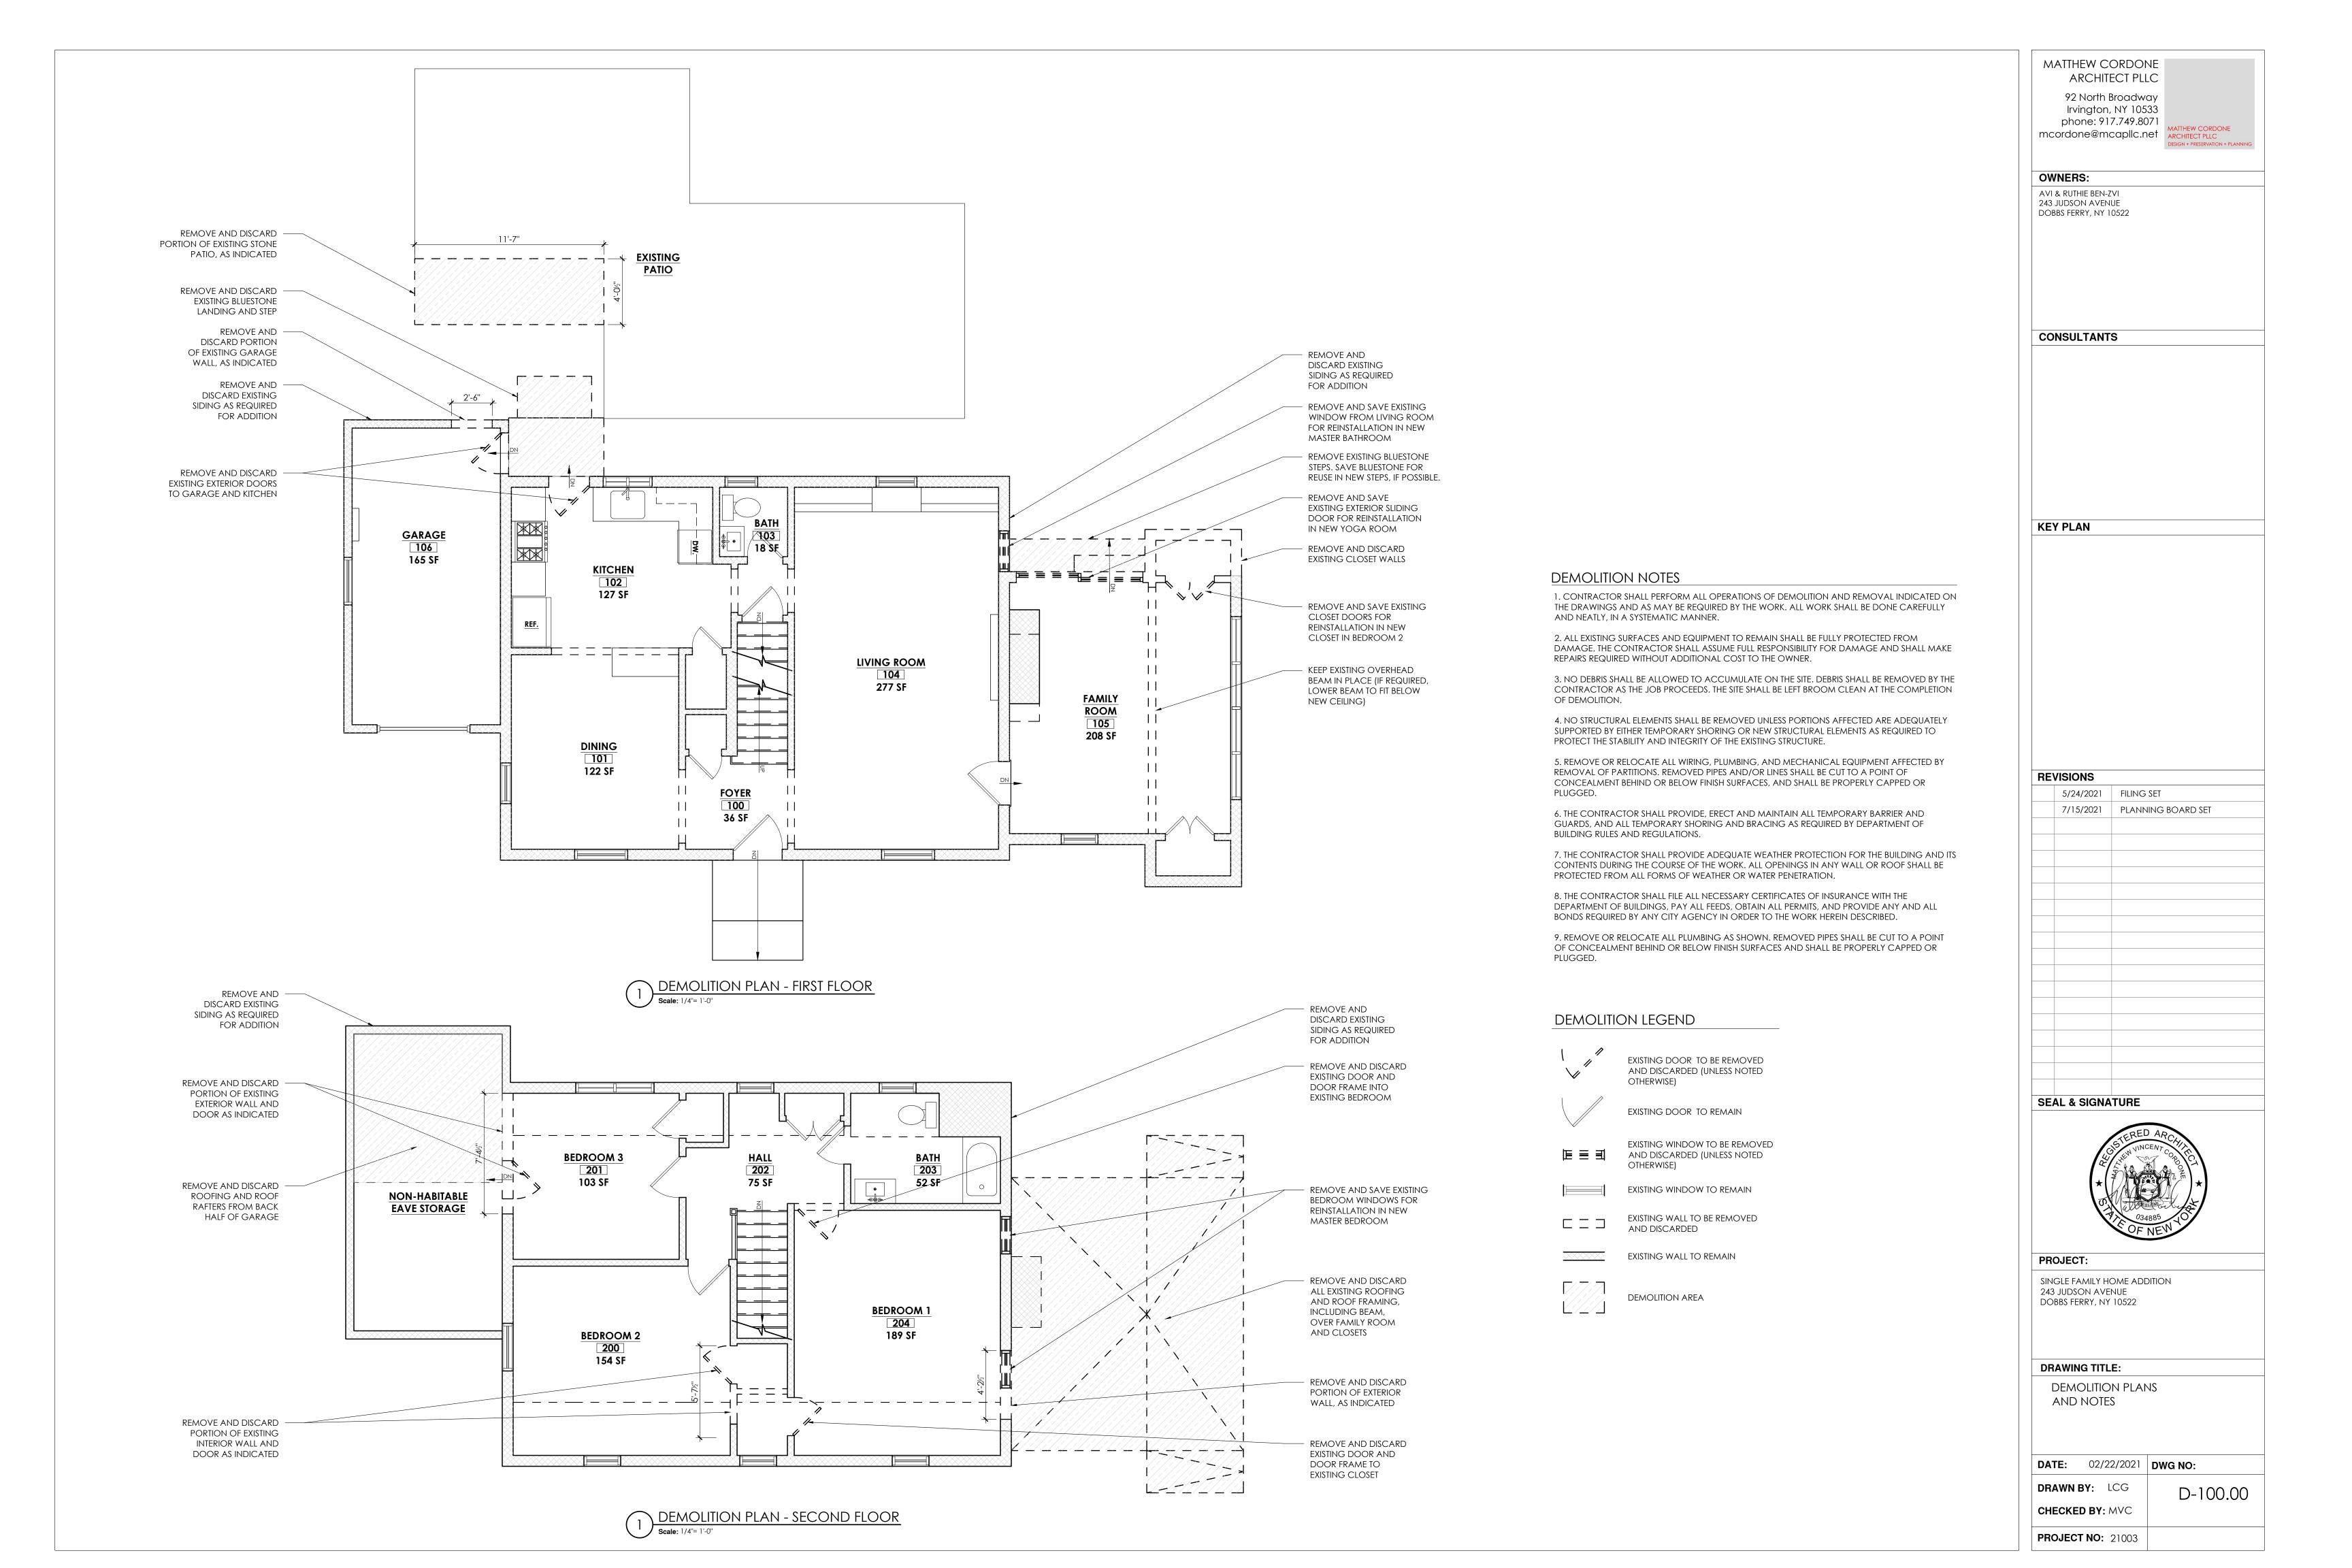

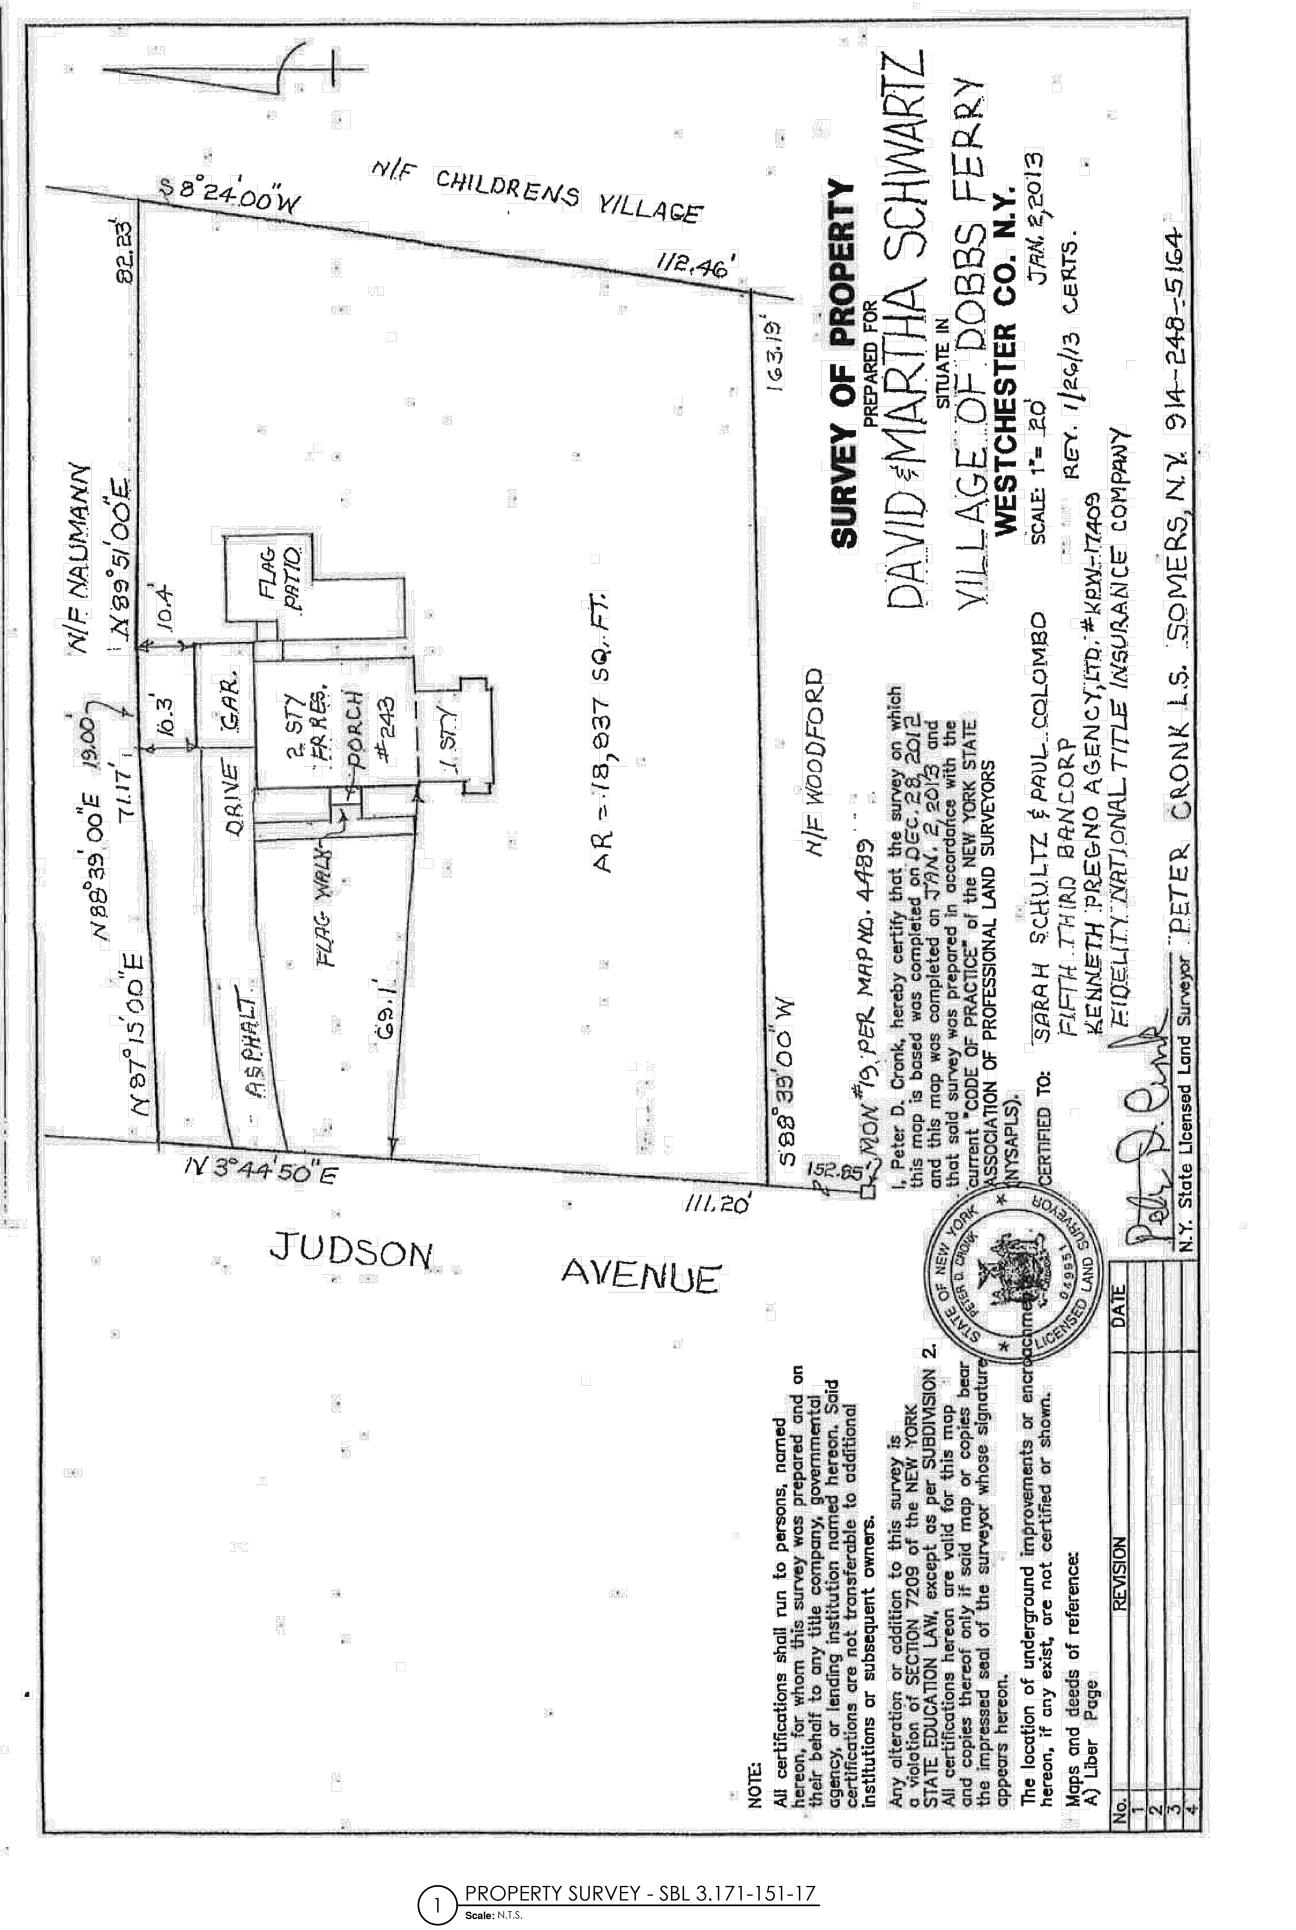

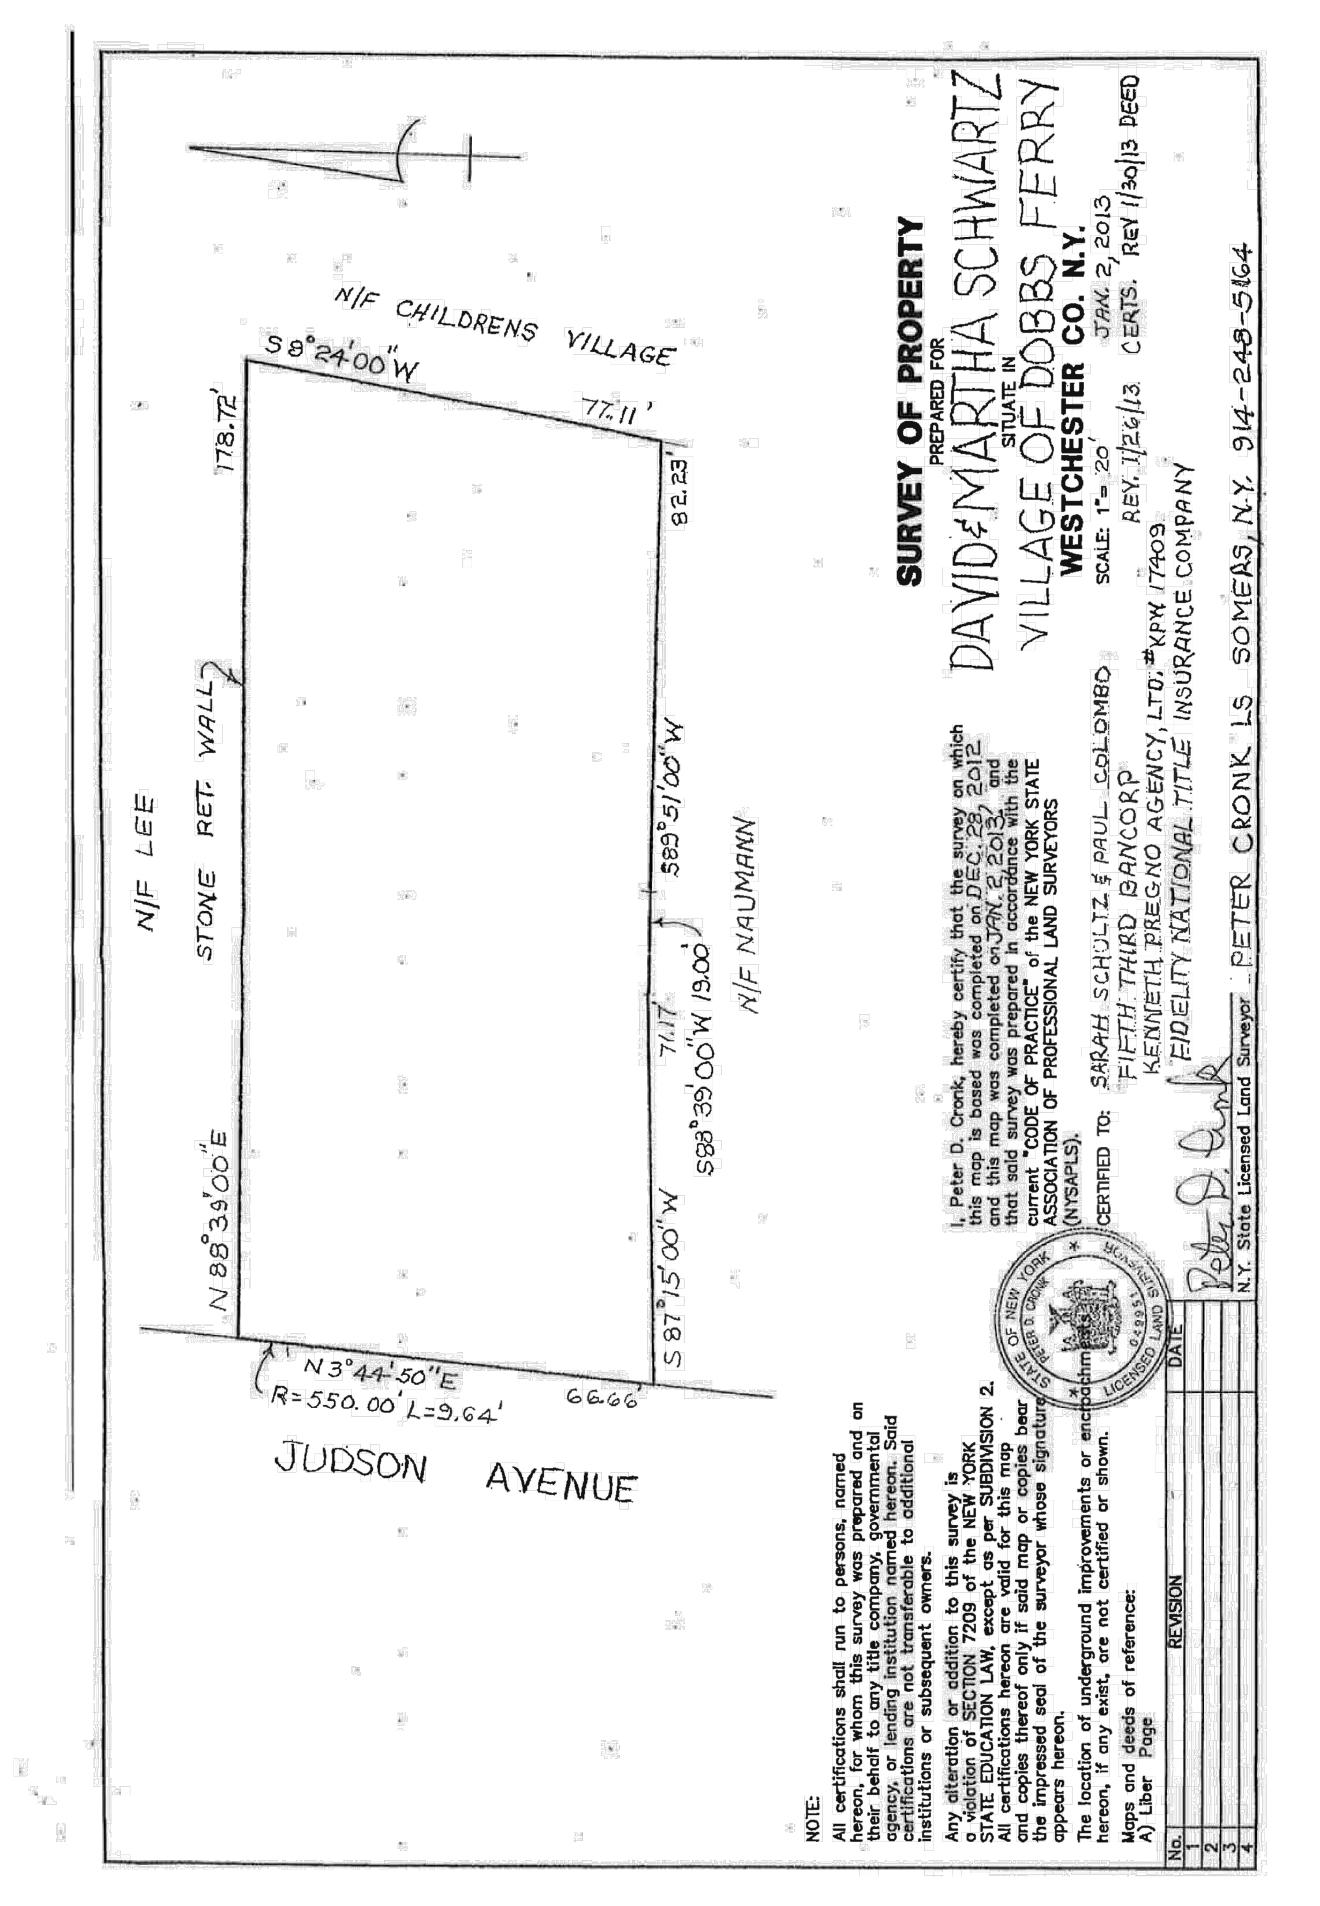


92 North Broadway
Irvington, NY 10533
phone: 917.749.8071
mcordone@mcapllc.net **OWNERS:** AVI & RUTHIE BEN-ZVI 243 JUDSON AVENUE DOBBS FERRY, NY 10522 CONSULTANTS **KEY PLAN REVISIONS** 5/24/2021 FILING SET 7/15/2021 PLANNING BOARD SET SEAL & SIGNATURE PROJECT: SINGLE FAMILY HOME ADDITION 243 JUDSON AVENUE DOBBS FERRY, NY 10522 **DRAWING TITLE:** SURVEYS **DATE:** 02/22/2021 **DWG NO:** DRAWN BY: LCG G-100.00 CHECKED BY: MVC


PROJECT NO: 21003

MATTHEW CORDONE ARCHITECT PLLC

PROPERTY SURVEY - SBL 3.171-151-15

Scale: N.T.S.

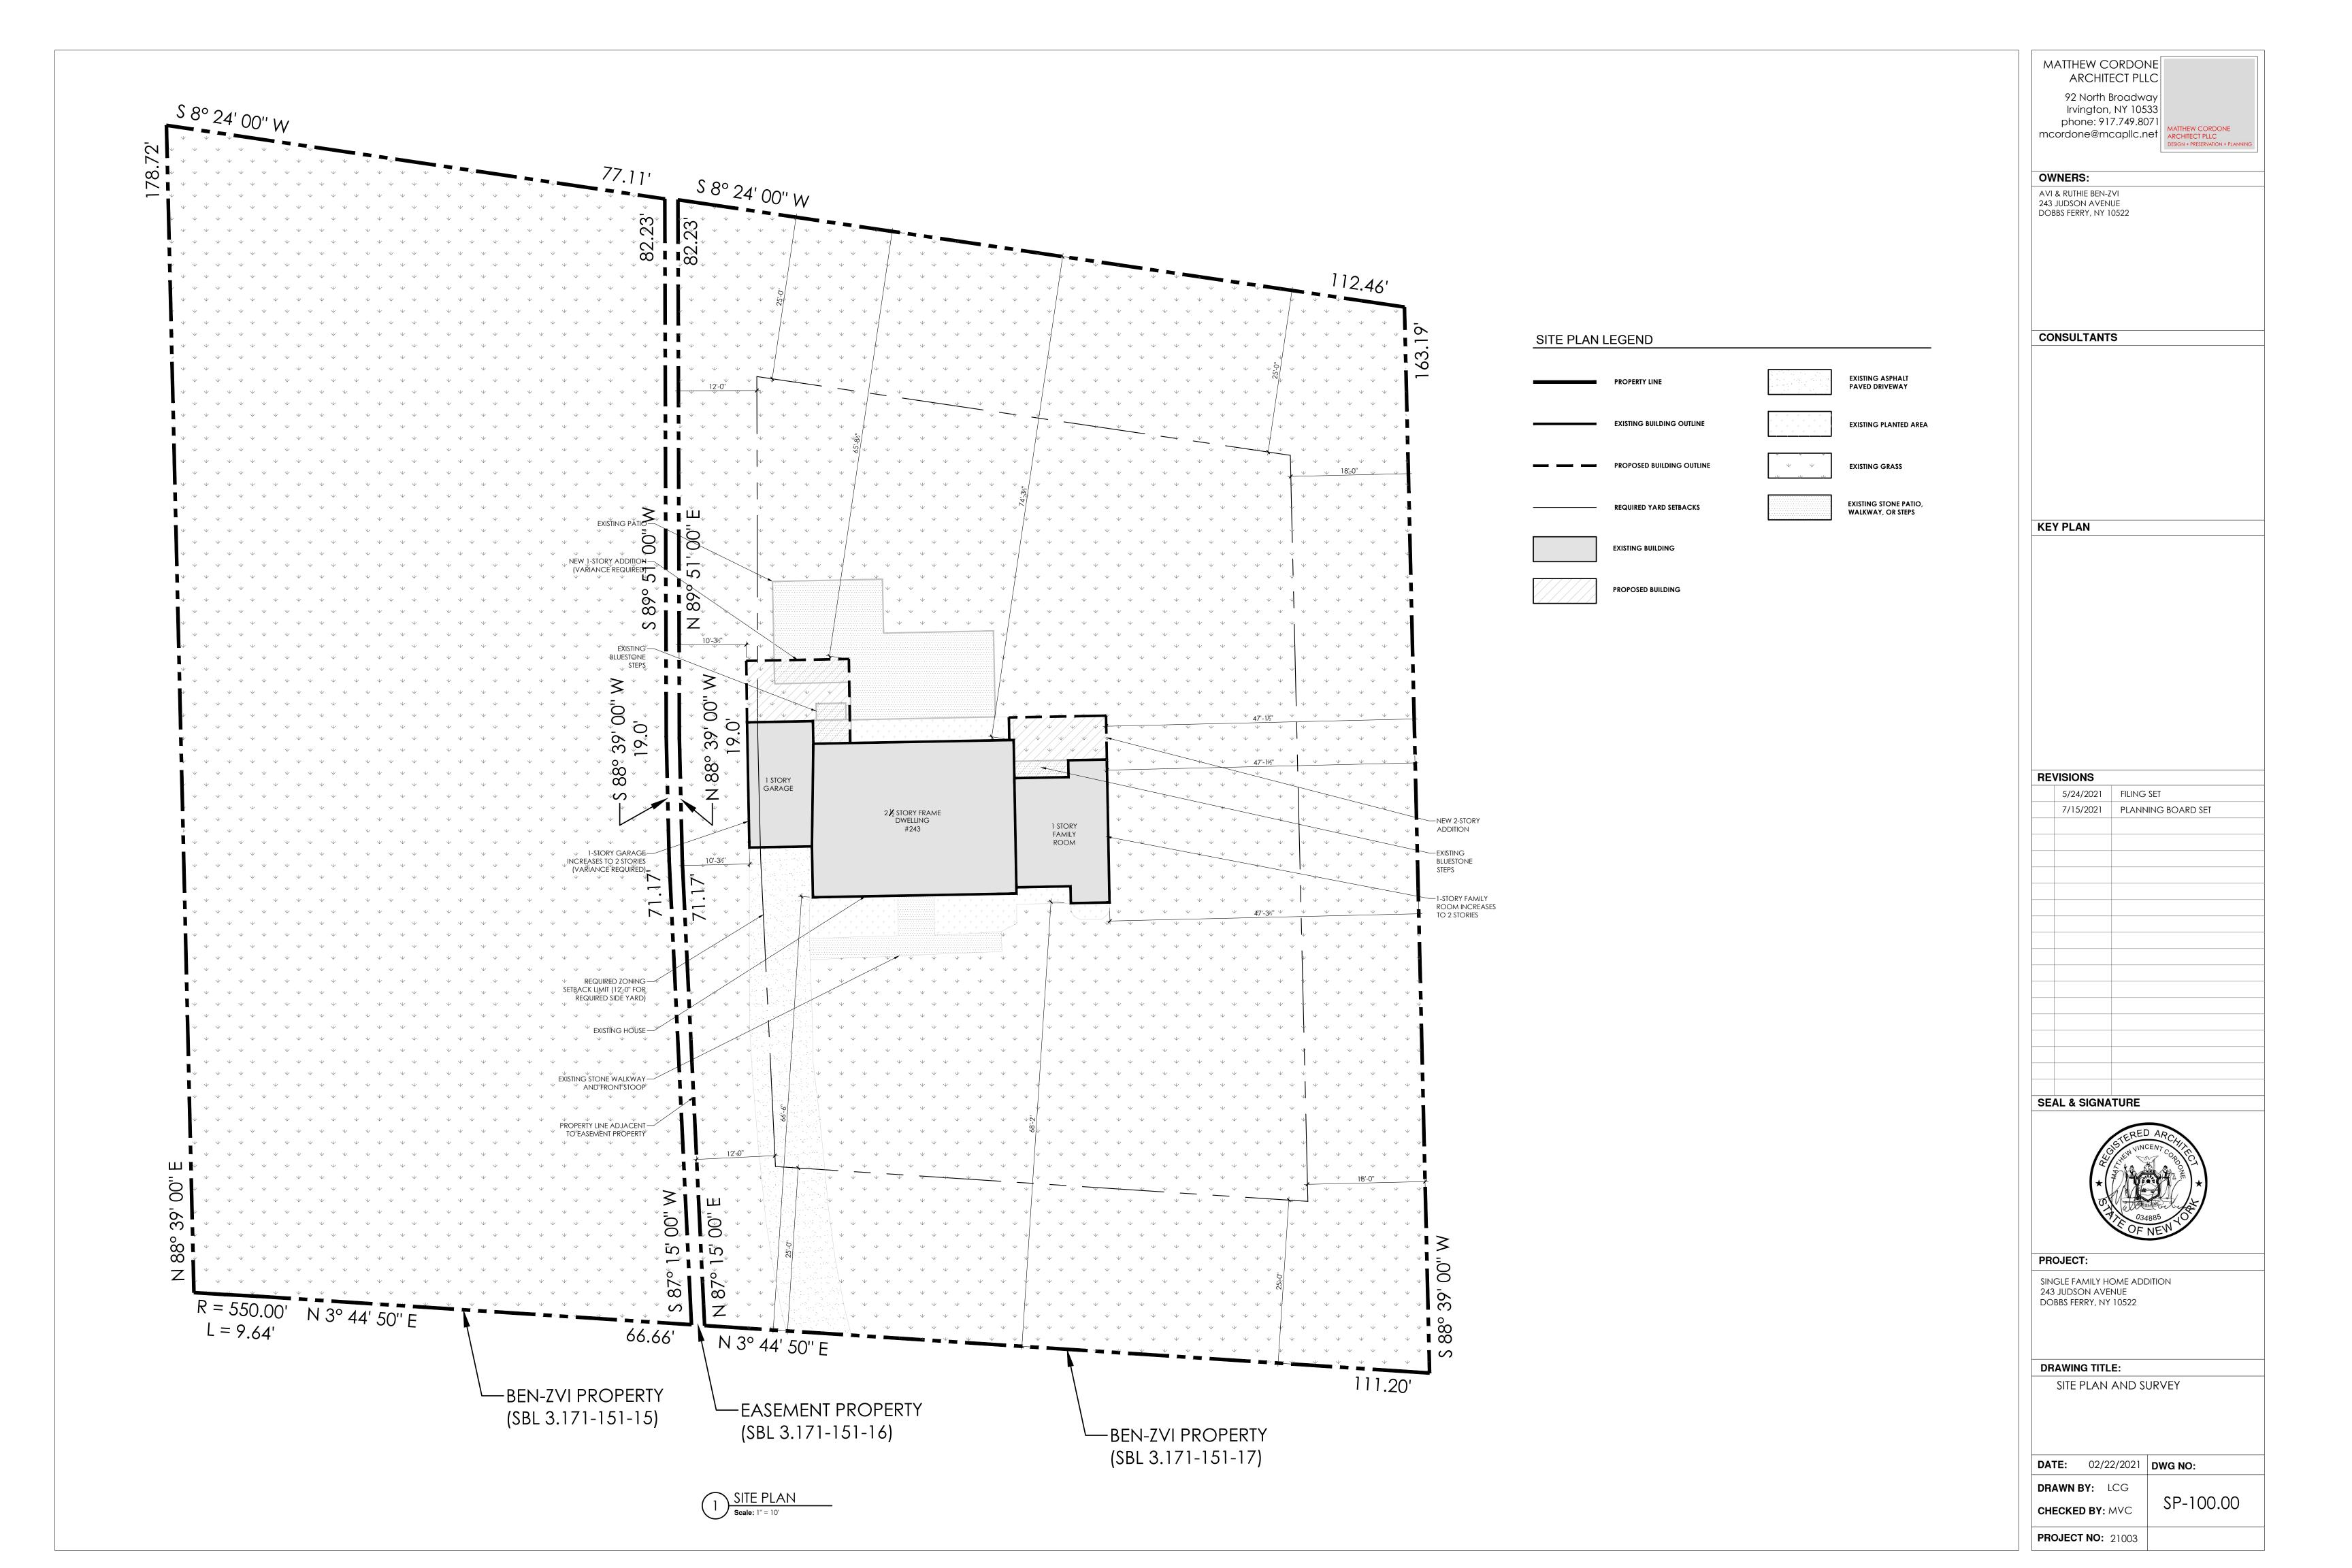

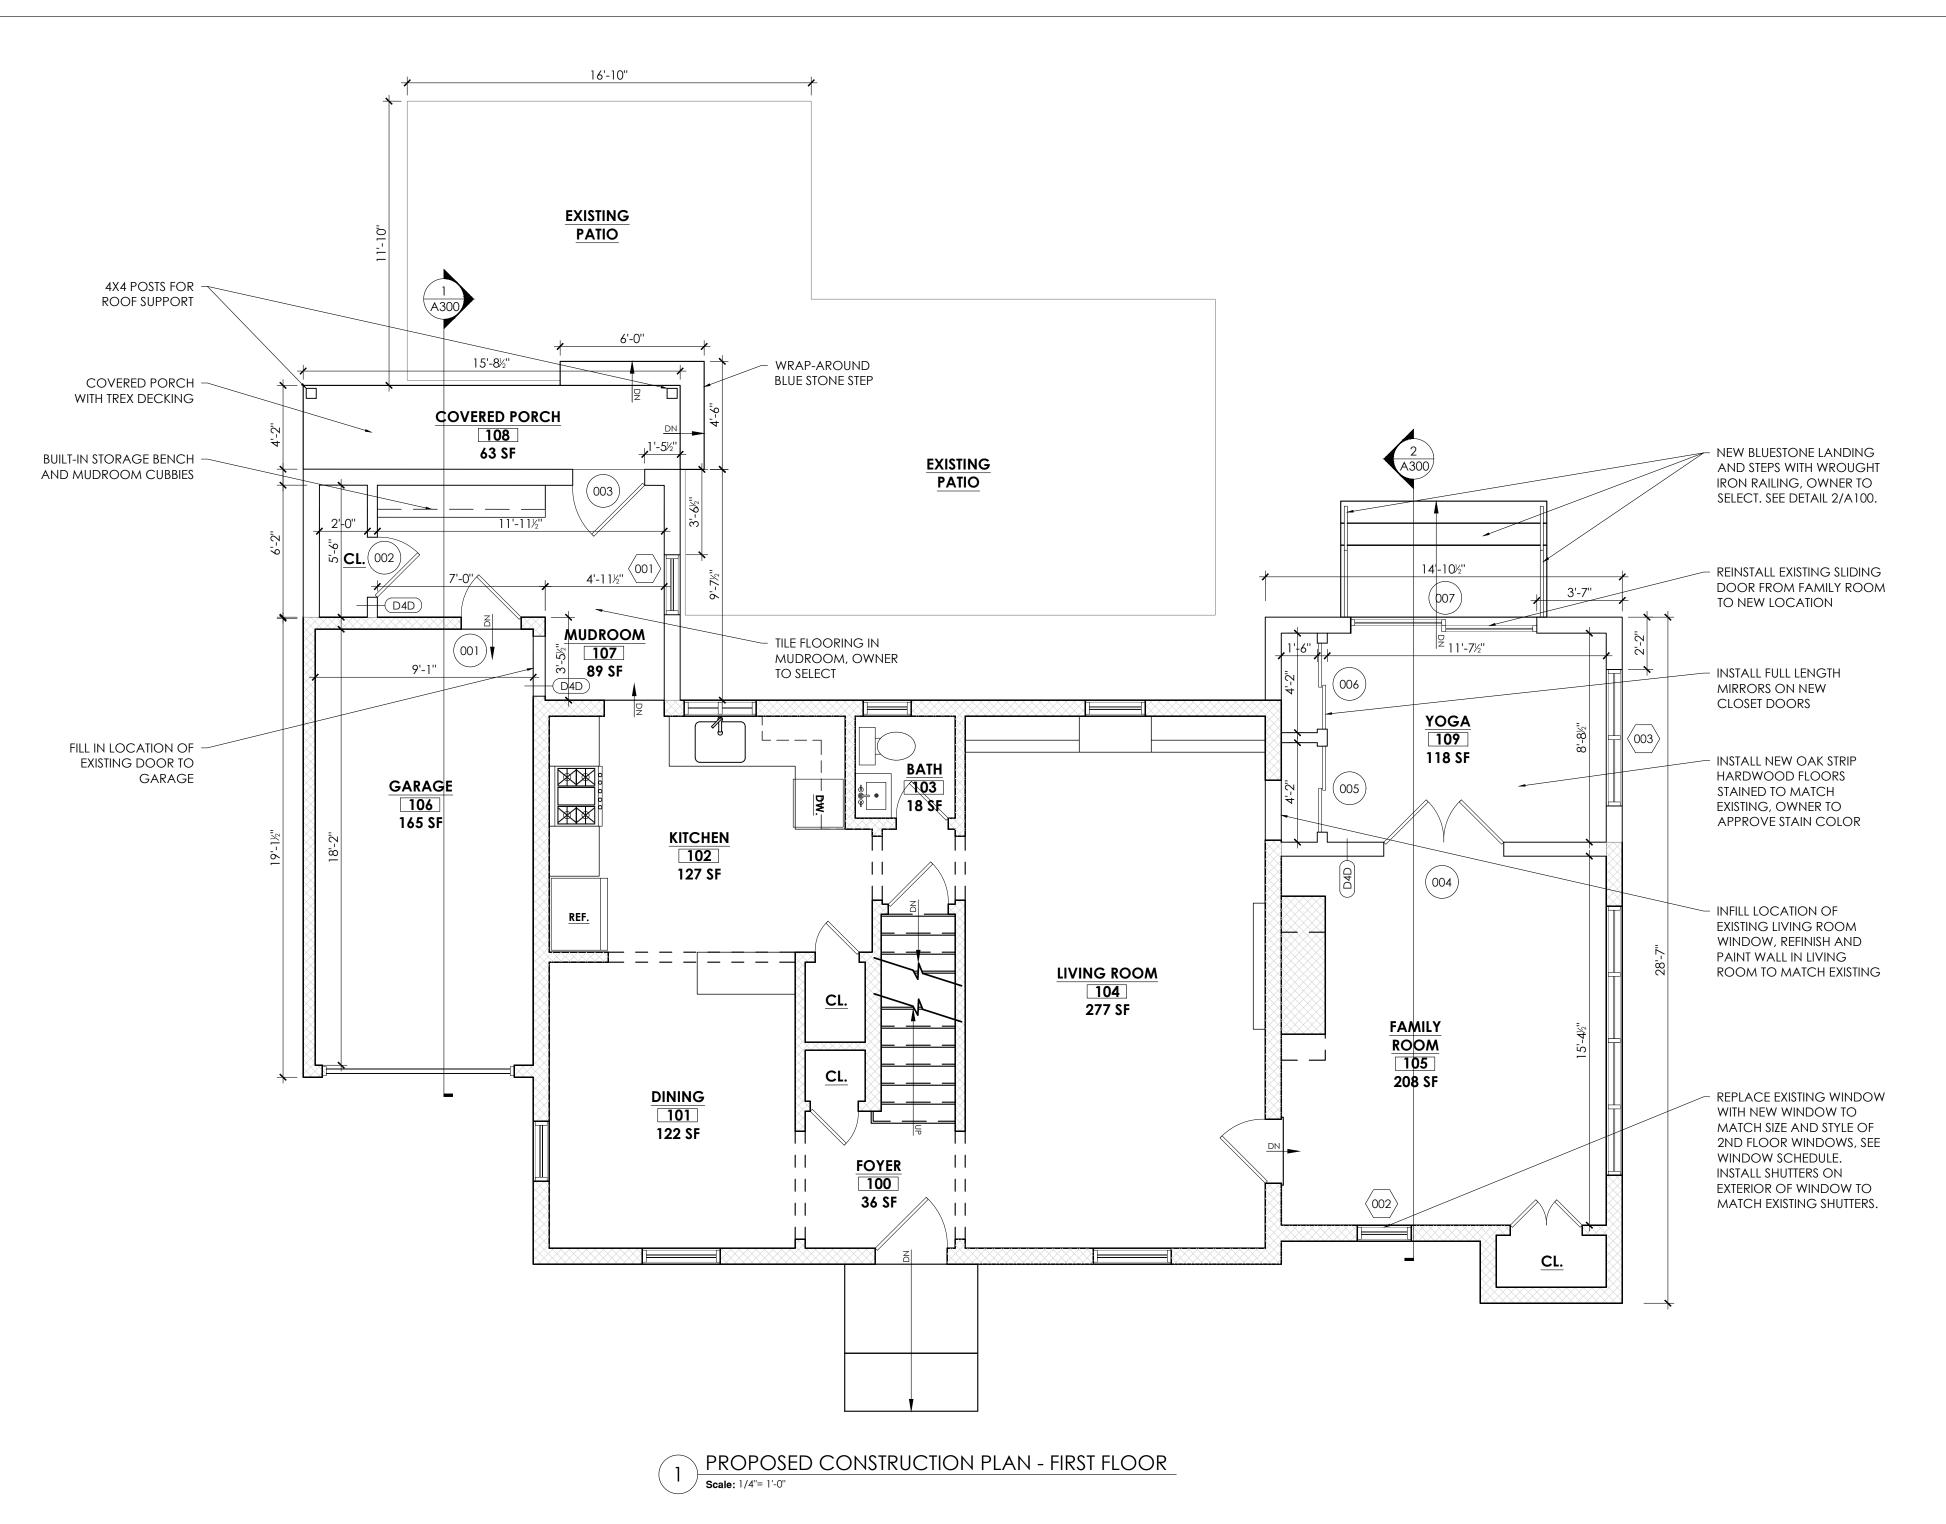

CONSTRUCTION NOTES

1. CONTRACTOR IS TO IMMEDIATELY NOTIFY ARCHITECT OF DISCREPANCIES THAT MAY PROHIBIT OR AFFECT THE CONSTRUCTION ANY PART OF THE INTENDED

2. ALL WALL PARTITIONS NOT DESIGNATED BY A PARTITION LEGEND KEY ARE TO BE AUTOMATICALLY DESIGNATED AS ______ UNLESS OTHERWISE NOTED.


3. DIMENSIONS ARE TAKEN FROM FINISH MATERIAL TO FINISH MATERIAL.

4. UPON COMPLETION OF DEMOLITION, THE CONTRACTOR SHALL WALK THE AREA OF WORK WITH THE ARCHITECT TO CONFIRM LAYOUT OF NEW PARTITIONS

5. COORDINATE ALL NEW SERVICES AND WASTE/DRAIN LINES WITH BUILDING'S EXISTING SERVICES.

6. ALL GLASS SHALL BE LASER OR ACID ETCHED.

WALL PARTITION LEGEND

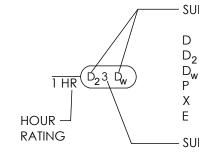


- SURFACE CODE ONE LAYER DRYWALL TWO LAYERS DRYWALL WATER RESISTANT DRYWALL PLASTER EXPOSED SURFACE EXISTING TO REMAIN


 $1\frac{1}{2}$ " Furring Strips H 7/8" FURRING STRIP 2 $1\frac{1}{2}$ " WOOD STUD 3 $2\frac{1}{2}$ " WOOD STUD 4 $3\frac{1}{2}$ " WOOD STUD

E EX SUBSTRATE TO REMAIN

– SUPPORT CODE M4 4" (NOM) CMU SUBSTRATE M6 6" (NOM) CMU SUBSTRATE M8 8" (NOM) CMU SUBSTRATE C CONCRÉTE SUBSTRATE

WALL PARTITION DETAILS

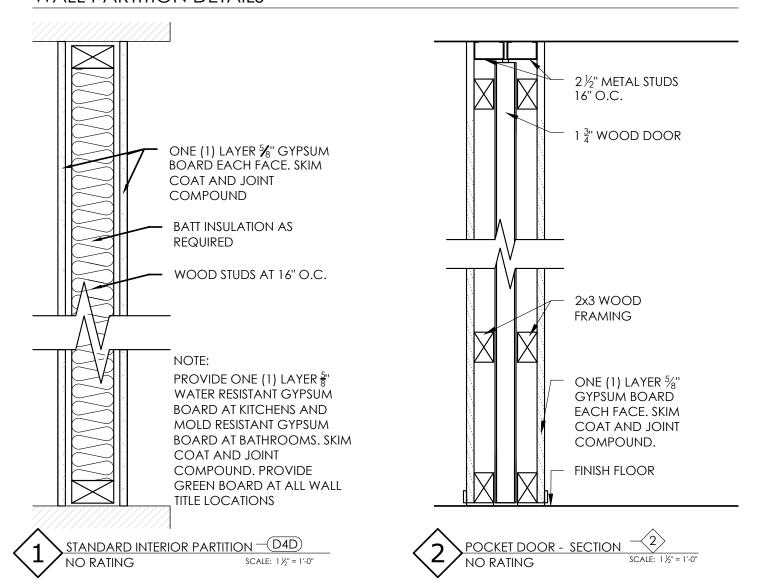

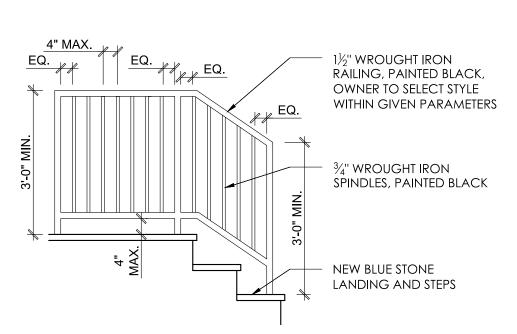

PAILING ELEVATION

Scale: 1/2"=1'-0"

MATTHEW CORDONE ARCHITECT PLLC 92 North Broadway Irvington, NY 10533 phone: 917.749.8071 mcordone@mcapllc.net ARCHITECT PLLC

AVI & RUTHIE BEN-ZVI 243 JUDSON AVENUE DOBBS FERRY, NY 10522

OWNERS:

CONSULTANTS

KEY PLAN

REVISIONS 5/24/2021 FILING SET 7/15/2021 PLANNING BOARD SET

SEAL & SIGNATURE



PROJECT: SINGLE FAMILY HOME ADDITION 243 JUDSON AVENUE


DOBBS FERRY, NY 10522

DRAWING TITLE: CONSTRUCTION PLANS, DETAILS, & NOTES

DATE: 02/22/2021 **DWG NO**:

DRAWN BY: LCG CHECKED BY: MVC

A-100.00

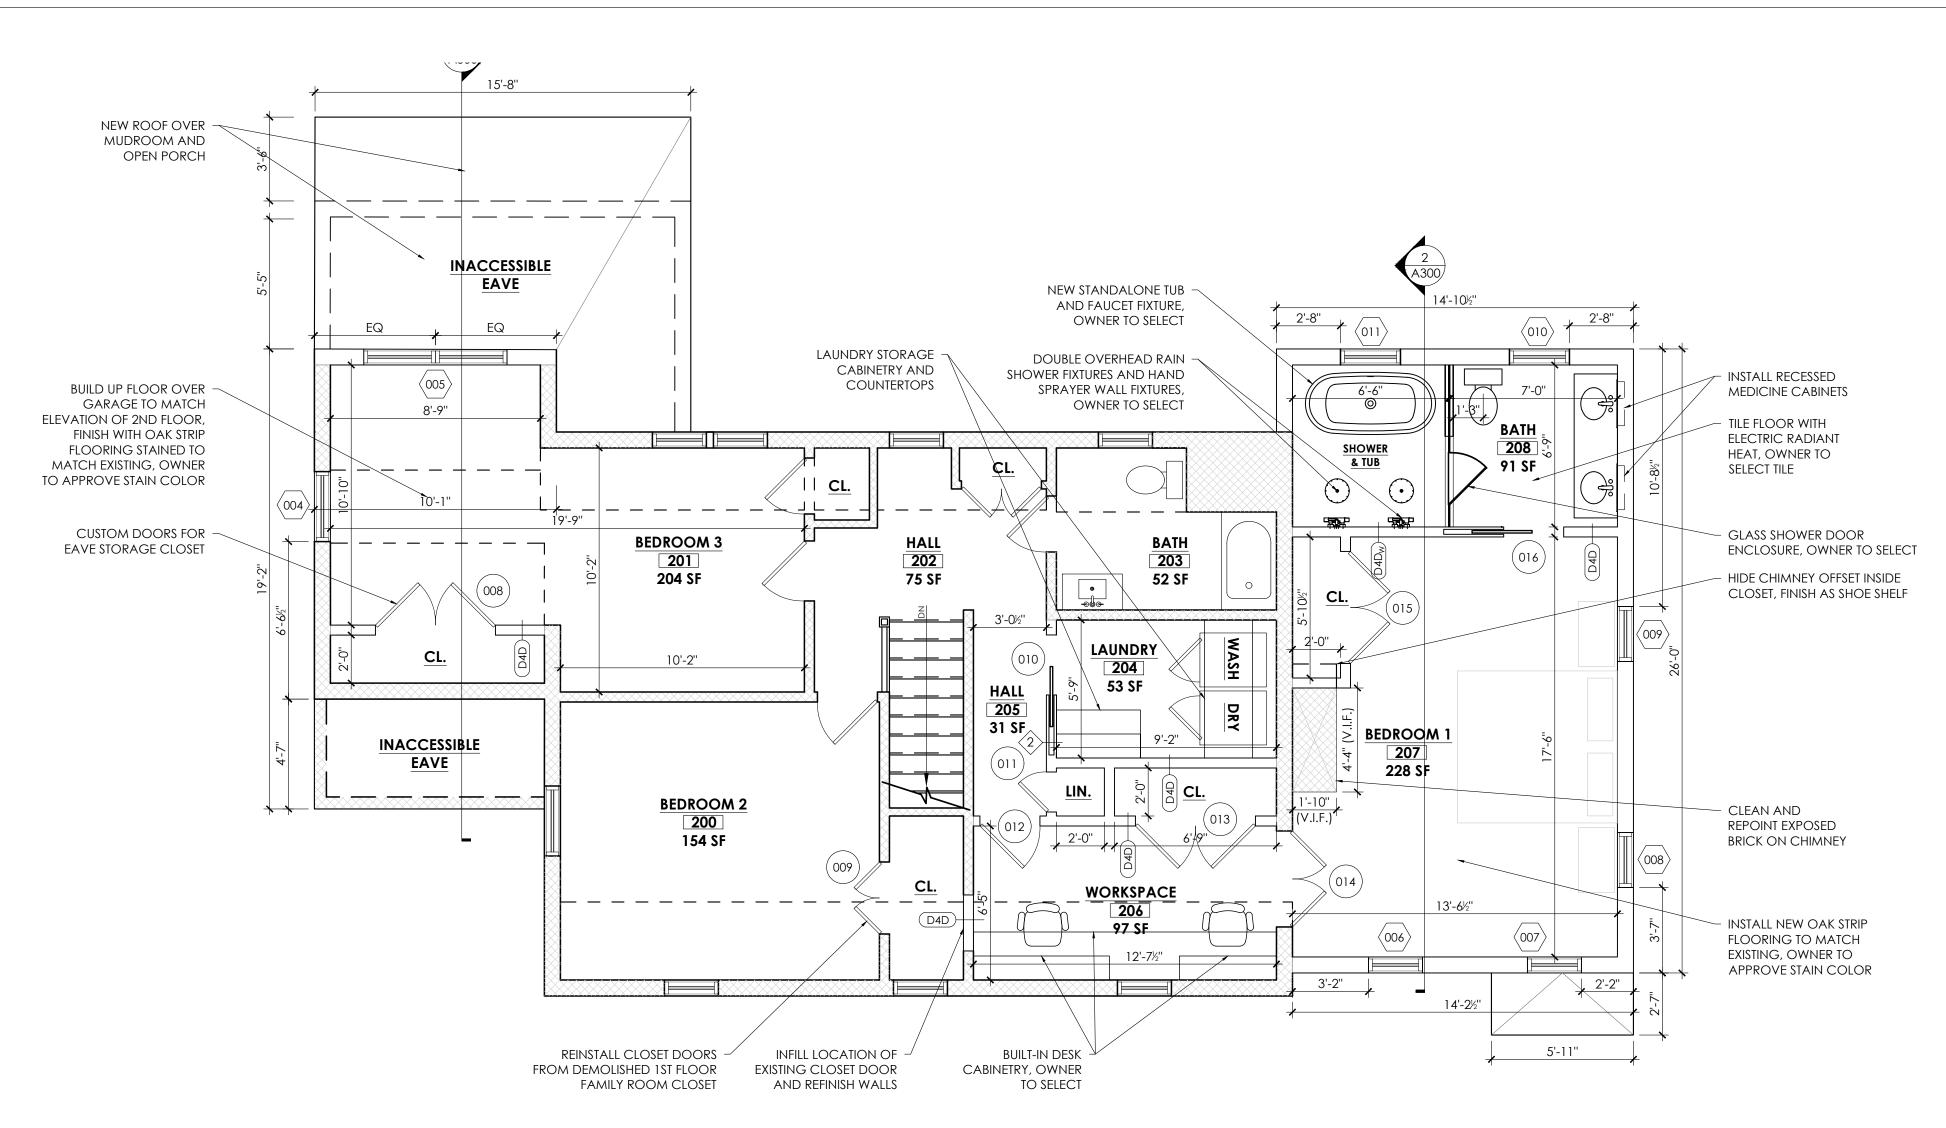

PROPOSED CONSTRUCTION PLAN - SECOND FLOOR

Scale: 1/4"= 1'-0"


CONSTRUCTION NOTES


1. CONTRACTOR IS TO IMMEDIATELY NOTIFY ARCHITECT OF DISCREPANCIES THAT MAY PROHIBIT OR AFFECT THE CONSTRUCTION ANY PART OF THE INTENDED

- 2. ALL WALL PARTITIONS NOT DESIGNATED BY A PARTITION LEGEND KEY ARE TO BE AUTOMATICALLY DESIGNATED AS ______ UNLESS OTHERWISE NOTED. SEE A 100 FOR WALL PARTITION DETAILS.
- 3. DIMENSIONS ARE TAKEN FROM FINISH MATERIAL TO FINISH MATERIAL.
- 4. UPON COMPLETION OF DEMOLITION, THE CONTRACTOR SHALL WALK THE AREA OF WORK WITH THE ARCHITECT TO CONFIRM LAYOUT OF NEW PARTITIONS

5. COORDINATE ALL NEW SERVICES AND WASTE/DRAIN LINES WITH BUILDING'S

EXISTING SERVICES. 6. ALL GLASS SHALL BE LASER OR ACID ETCHED.

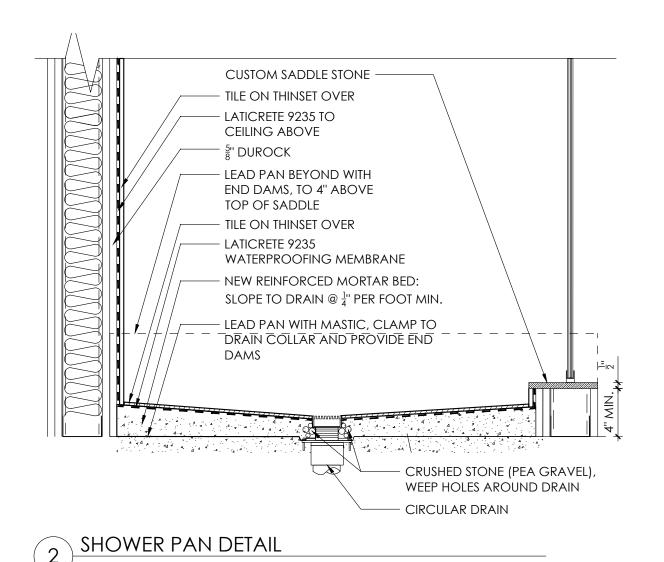

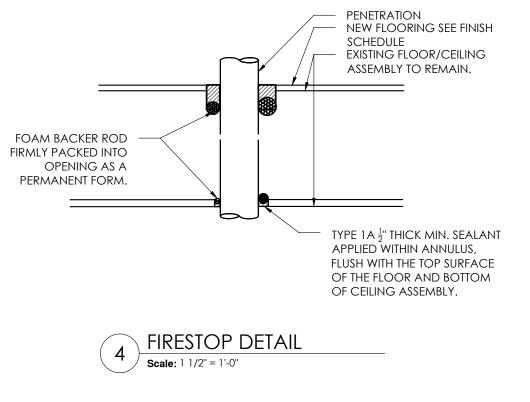

PROJECT: **DRAWING TITLE: CHECKED BY:** MVC

MATTHEW CORDONE ARCHITECT PLLC 92 North Broadway Irvington, NY 10533 phone: 917.749.8071 mcordone@mcapllc.net ARCHITECT PLLC

OWNERS: AVI & RUTHIE BEN-ZVI 243 JUDSON AVENUE DOBBS FERRY, NY 10522

CONSULTANTS

KEY PLAN

REVISIONS 5/24/2021 FILING SET 7/15/2021 PLANNING BOARD SET

SEAL & SIGNATURE



SINGLE FAMILY HOME ADDITION


243 JUDSON AVENUE DOBBS FERRY, NY 10522

CONSTRUCTION PLANS, DETAILS, & NOTES

DATE: 02/22/2021 | **DWG NO:**


DRAWN BY: LCG

A-101.00

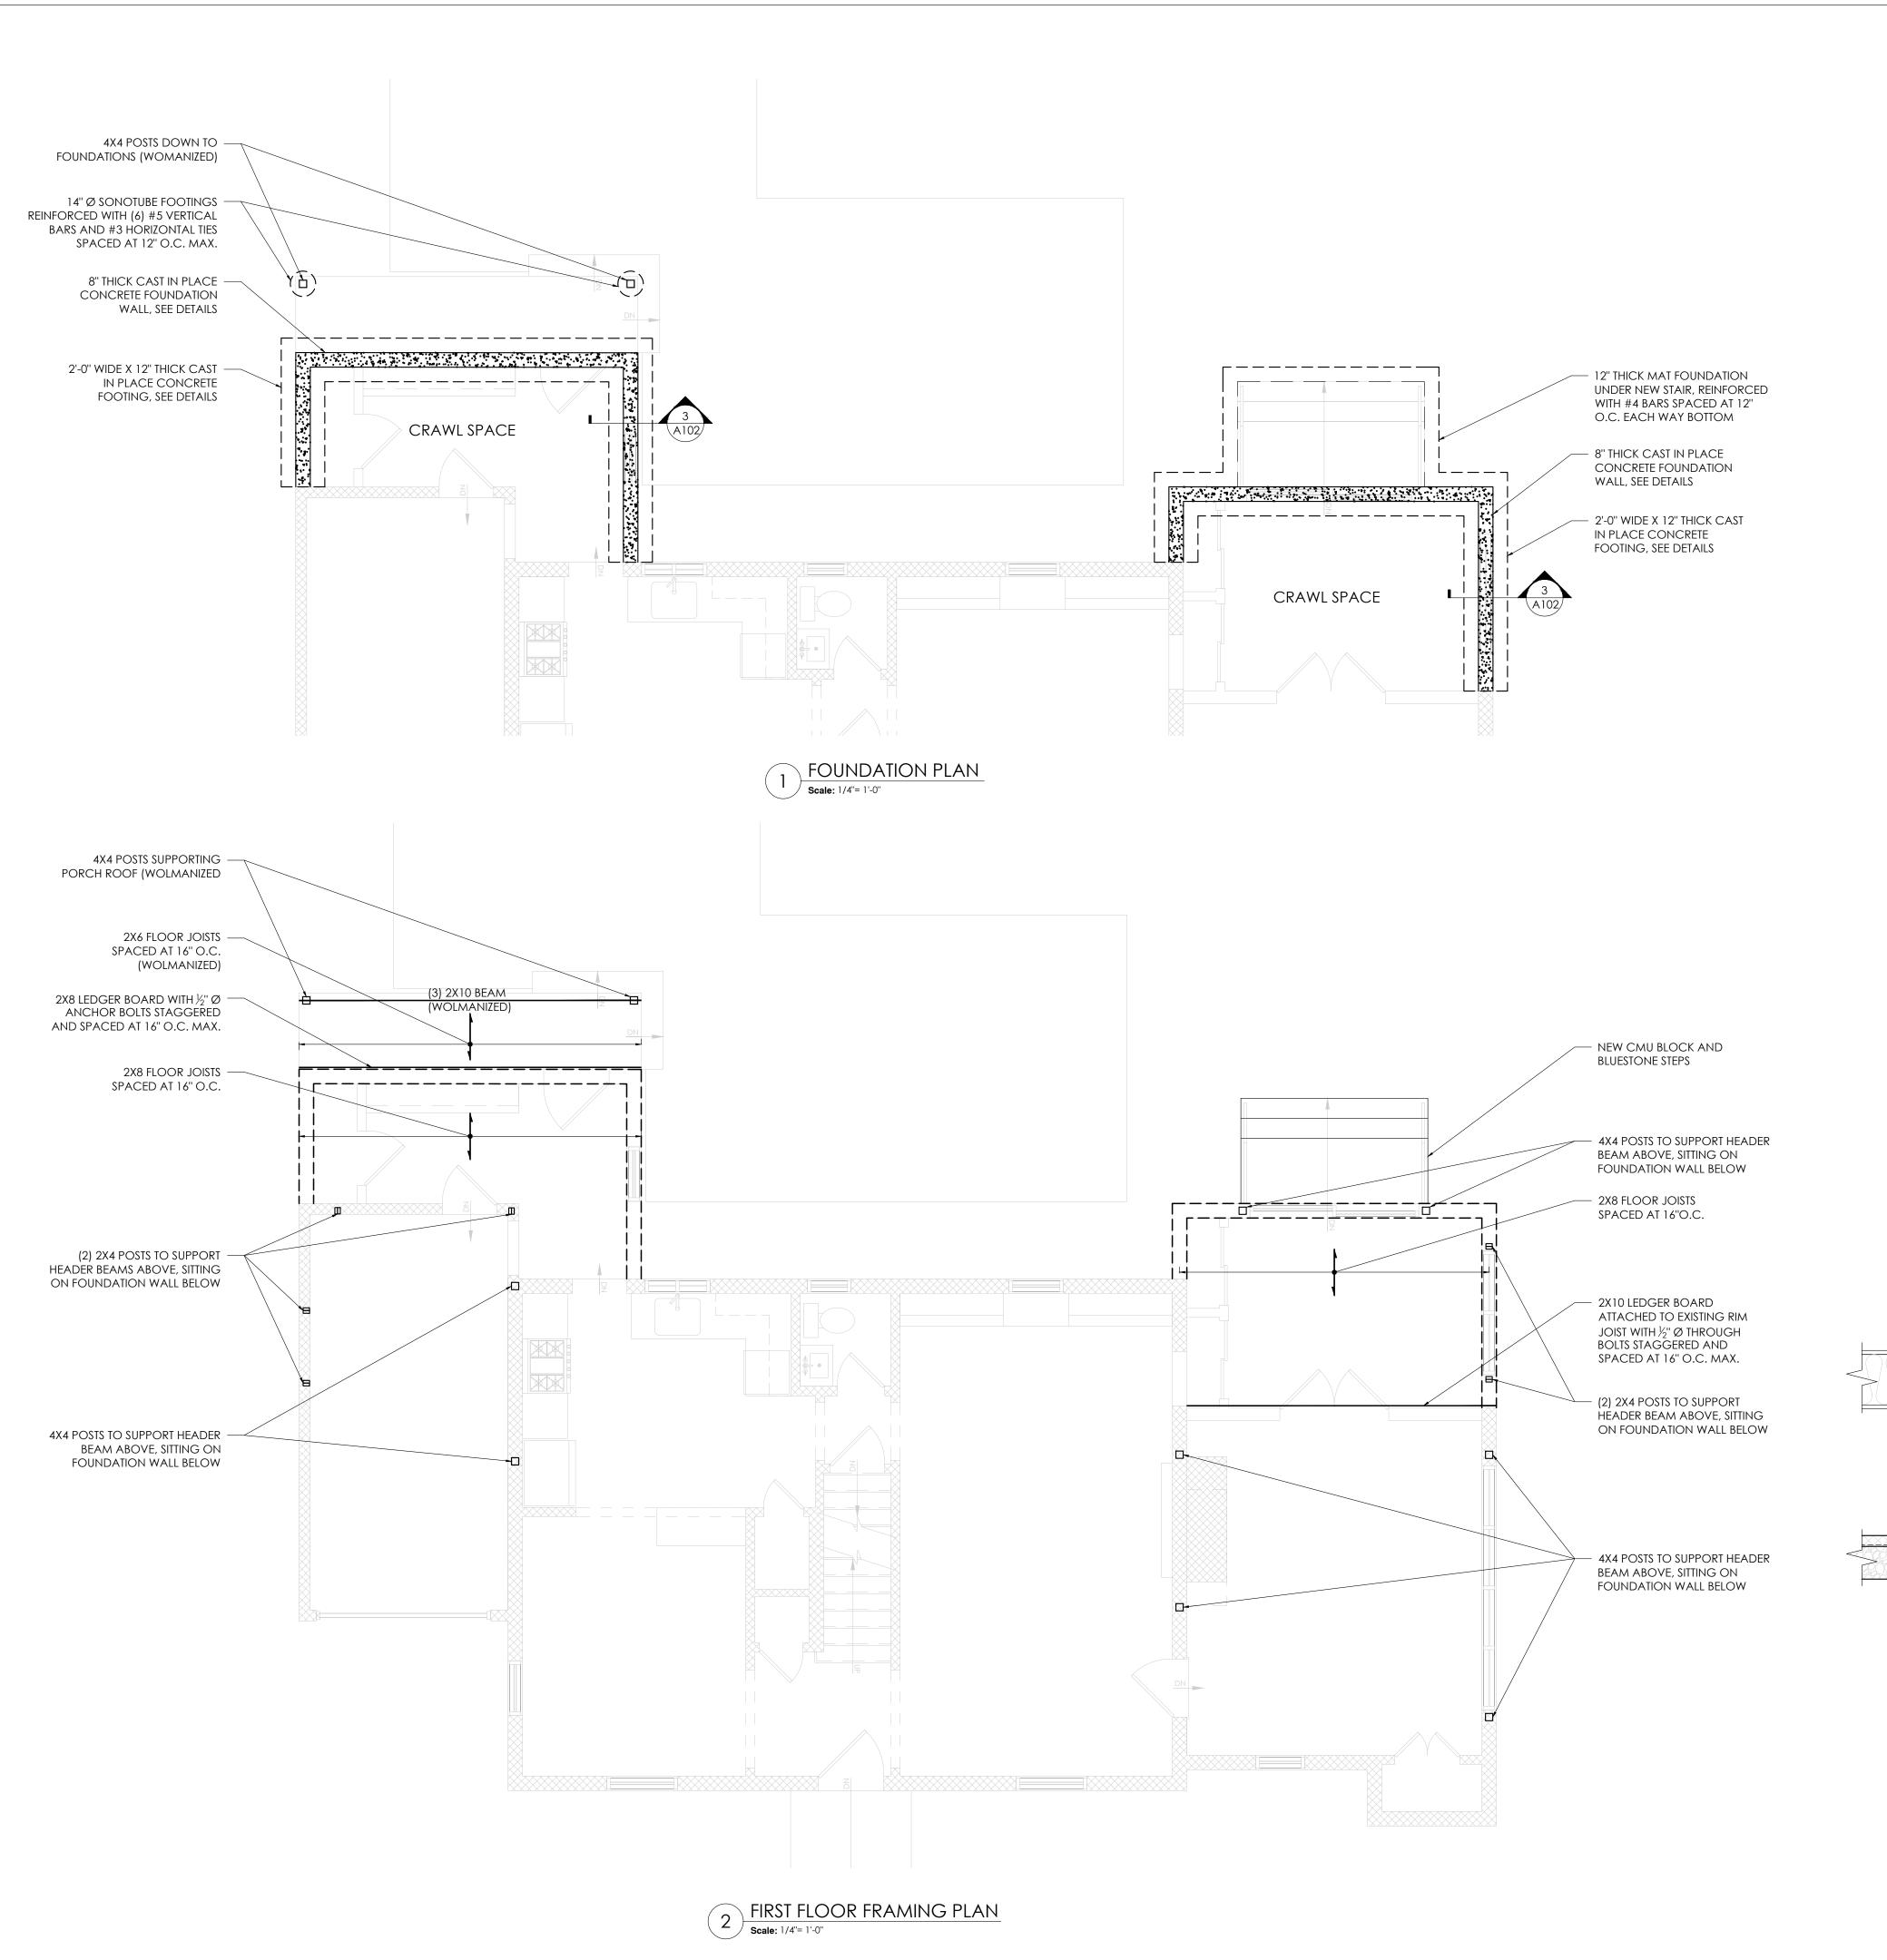

STRUCTURAL CONSTRUCTION NOTES

- 1. FRAMING SHOWN IS WITHIN THE FLOOR LEVEL REFERENCED BY THE PLAN TITLE, NOT ABOVE, UNLESS OTHERWISE NOTED. SEE ARCHITECTURAL DRAWINGS FOR TOP OF FINISH FLOOR
- 2. CONTRACTOR IS TO IMMEDIATELY NOTIFY ARCHITECT/ENGINEER OF DISCREPANCIES THAT MAY PROHIBIT OR AFFECT THE CONSTRUCTION OF ANY PART OF THE INTENDED DESIGN.
- 3. CONTRACTOR TO PROPERLY SHORE FRAMING BEFORE REMOVING ANY LOAD-BEARING WALLS, BEAMS, OR POSTS. REMOVE SHORING ONLY WHEN NEW HEADER BEAMS AND ASSOCIATED FRAMING ARE PROPERLY SECURED ACCORDING TO STRUCTURAL PLANS AND DETAILS.
- 4. ALL STRUCTURAL STEEL SHALL CONFORM TO THE REQUIREMENTS OF THE AISC "SPECIFICATIONS STRUCTURAL STEEL FOR BUILDINGS" 13TH EDITION AND ALL CURRENT SUPPLEMENTS AND ADDENDA. FOR OTHER CODE AND SPECIFICATION REQUIREMENTS, SEE THE CONTRACT SPECIFICATIONS.
- 5. ALL STEEL WIDE FLANGE SHAPES SHALL CONFORM TO ASTM A992 (50 KSI). ALL STEEL PIPE SHALL CONFORM TO ASTM A53 TYPE E, GRADE B OR TYPE S GRADE B. ALL STEEL TUBES SHALL CONFORM TO ASTM A500, GRADE B. ALL OTHER STEEL SHAPES, PLATES, BARS, AND RODS, SHALL CONFORM TO ASTM A36 (36KSI), UNLESS NOTED OTHERWISE.
- 6. ALL NEW STRUCTURAL LUMBER TO BE DOUGLAS FIR LARCH GR. 1 OR BETTER, UNLESS OTHERWISE
- 7. LVL BEAMS TO BE TRUJOIST MICROLLAM 2.0E. SEE PLANS FOR SIZE AND NUMBER OF PLIES.
- 8. ALL NEW WOOD POSTS TO HAVE MECHANICAL COLUMN CAP FASTENERS AT TOP AND MECHANICAL COLUMN BASE FASTENERS AT BOTTOM, BY SIMPSON STRONG TIE OR APPROVED
- 9. ALL NEW STEEL POSTS TO BE ATTACHED AT TOP WITH (4) ½" Ø LAG BOLTS THROUGH CAP PLATE INTO BEAM ABOVE AND AT BOTTOM WITH (4) $\frac{1}{2}$ " Ø POST-INSTALLED ANCHOR BOLTS THROUGH BASE PLATE INTO EXISTING CONCRETE FOUNDATIONS BELOW.
- 10. NEW CAST IN PLACE CONCRETE FOOTINGS TO HAVE I'C = 4,000 PSI MIN. FOOTINGS TO BE PLACED ON COMPACTED NATIVE SOIL WITH A MINIMUM BEARING CAPACITY OF 2,000 PSF. BOTTOM OF NEW FOOTINGS PLACED WITHIN HEATED BUILDING ENVELOPE TO BE NO LESS THAN 12" BELOW FINISHED GRADE. BOTTOM OF EXTERIOR FOOTING TO BE NO LESS THAN 3'-6" BELOW FINISHED GRADE.
- 11. THE ENGINEERED LUMBER/TRUSS IDENTIFICATION SIGN SHOWN BELOW SHALL BE AFFIXED TO THE ELECTRICAL BOX, ATTACHED TO THE EXTERIOR OF THE RESIDENTIAL STRUCTURE, PRIOR TO ISSUANCE OF A CERTIFICATE OF OCCUPANCY OR A CERTIFICATE OF COMPLIANCE. THE SIGN INDICATES THAT TRUSS TYPE CONSTRUCTION, PRE-ENGINEERED WOOD CONSTRUCTION, AND/OR TIMBER CONSTRUCTION IS UTILIZED IN THE STRUCTURE OF THE HOME.
- 12. THE ENGINEERED LUMBER/TRUSS IDENTIFICATION SIGN SHALL BE MADE OF A STURDY, NON-FACING AND WEATHER RESISTANT MATERIAL.
- 13. THE ENGINEERED LUMBER/TRUSS IDENTIFICATION SIGN SHALL BE IN COMPLIANCE WITH PART 1265 OF TITLE 19 NYCRR.

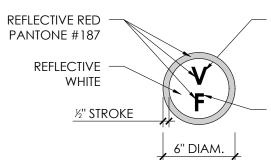


ALPHABET DESIGNATION OF CONSTRUCTION TYPE BASED ON SECTION 602 OF THE NYS BUILDING CODE

DESIGNATION FOR STRUCTURAL COMPONENTS THAT ARE TRUSS TYPE CONSTRUCTION:

ENGINEERED LUMBER AND TRUSS INDENTIFICATION SIGN

'F' = FLOOR FRAMING (INCLUDING GIRDERS & BEAMS) 'R' = ROOF FRAMING 'FR' = FLOOR AND ROOF FRAMING

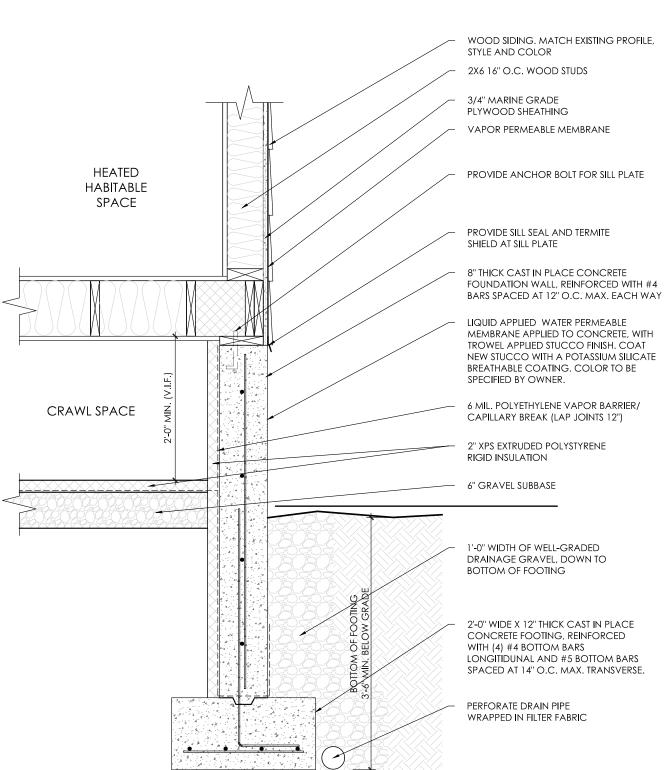



MATTHEW CORDONE ARCHITECT PLLC 92 North Broadway Irvington, NY 10533 phone: 917.749.8071

mcordone@mcapllc.net ARCHITECT PLLC

OWNERS:

AVI & RUTHIE BEN-ZVI 243 JUDSON AVENUE DOBBS FERRY, NY 10522

CONSULTANTS

KEY PLAN

REVISIONS

FILING SET 5/24/2021 7/15/2021 PLANNING BOARD SET

SEAL & SIGNATURE



PROJECT:

SINGLE FAMILY HOME ADDITION 243 JUDSON AVENUE DOBBS FERRY, NY 10522

DRAWING TITLE:

FOUNDATION AND 1ST FLOOR FRAMING PLANS AND NOTES


DATE: 02/22/2021 | **DWG NO:**


DRAWN BY: LCG

A-102.00

PROJECT NO: 21003


CHECKED BY: MVC

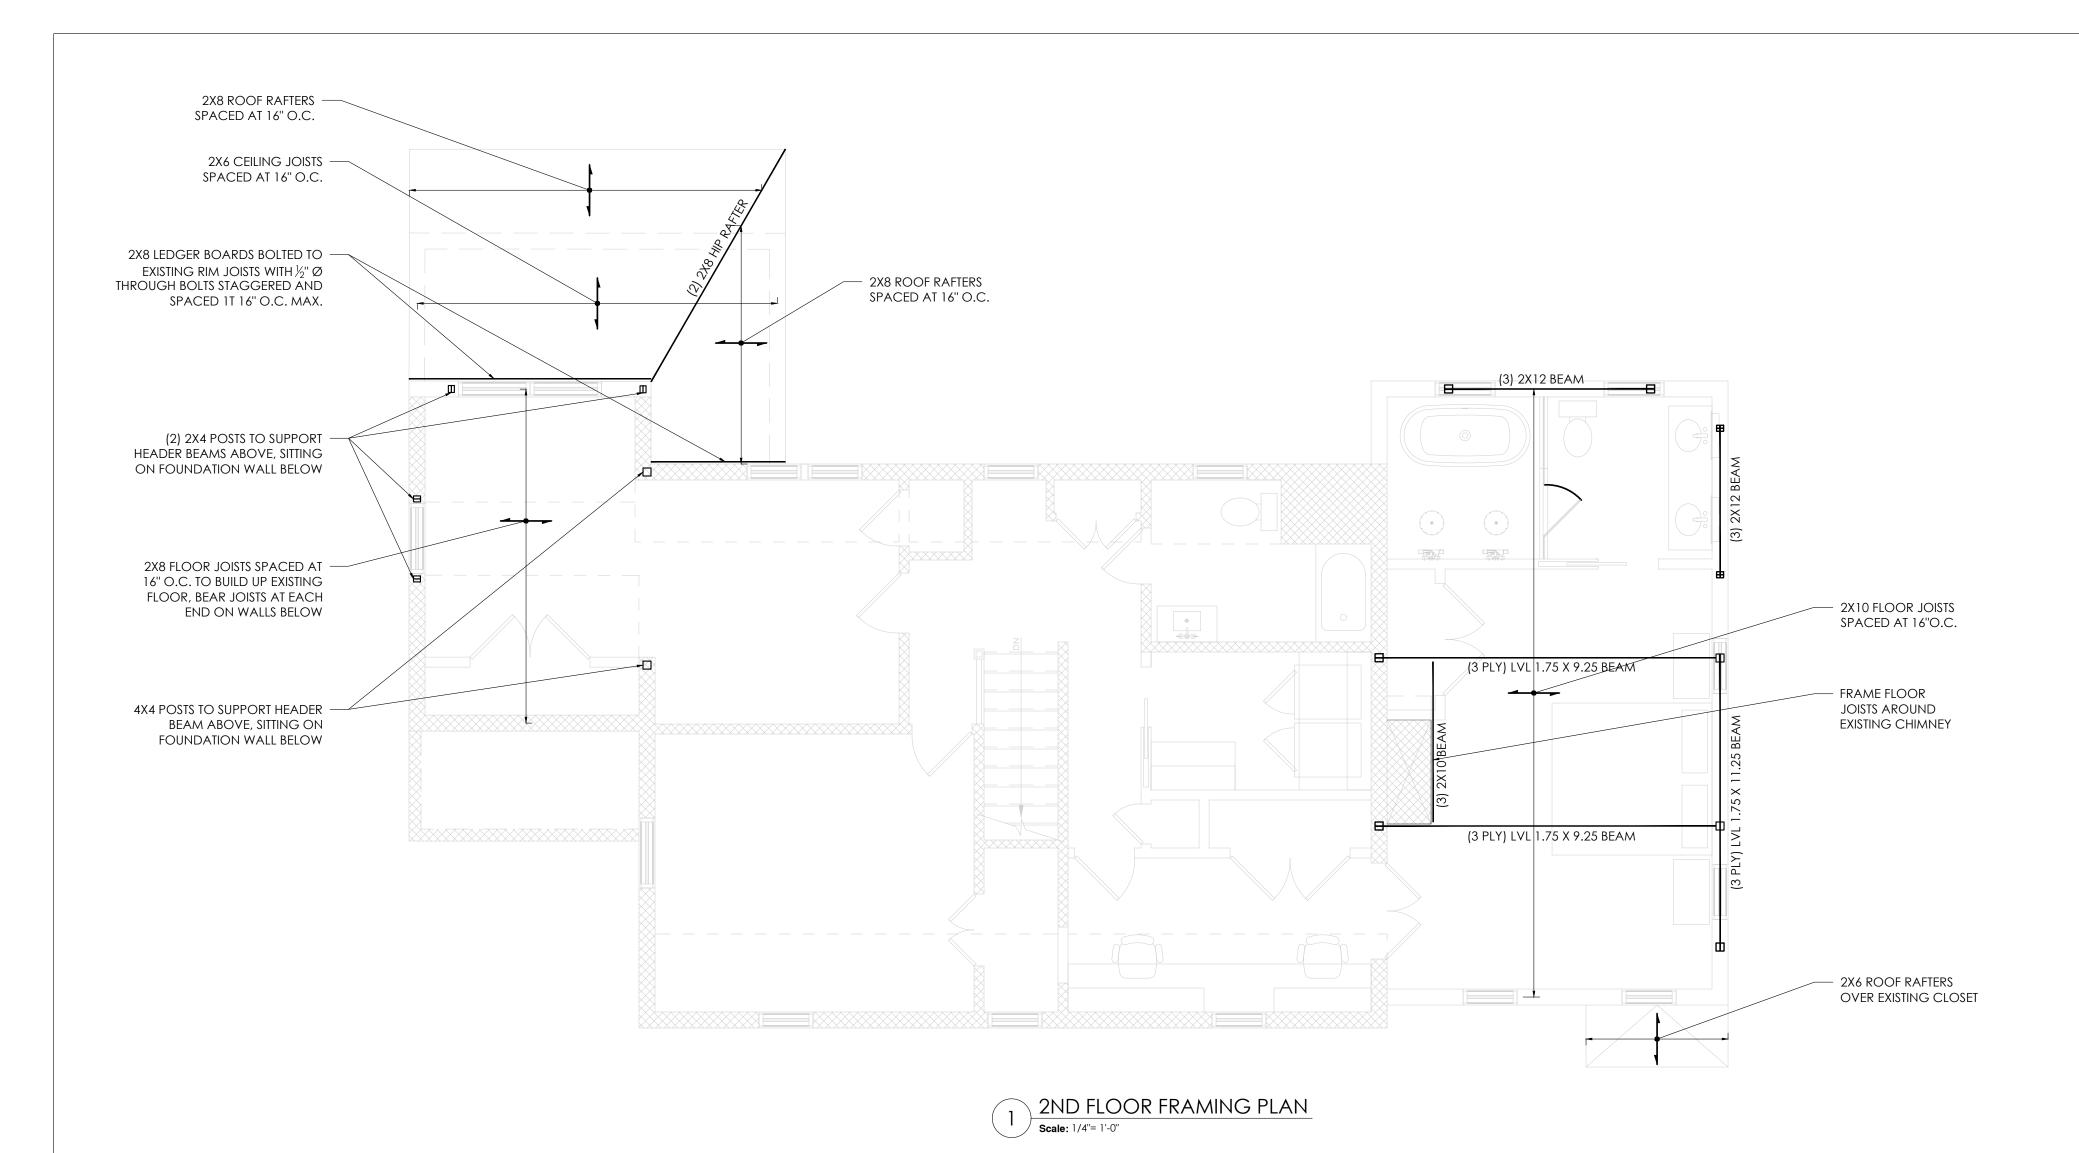

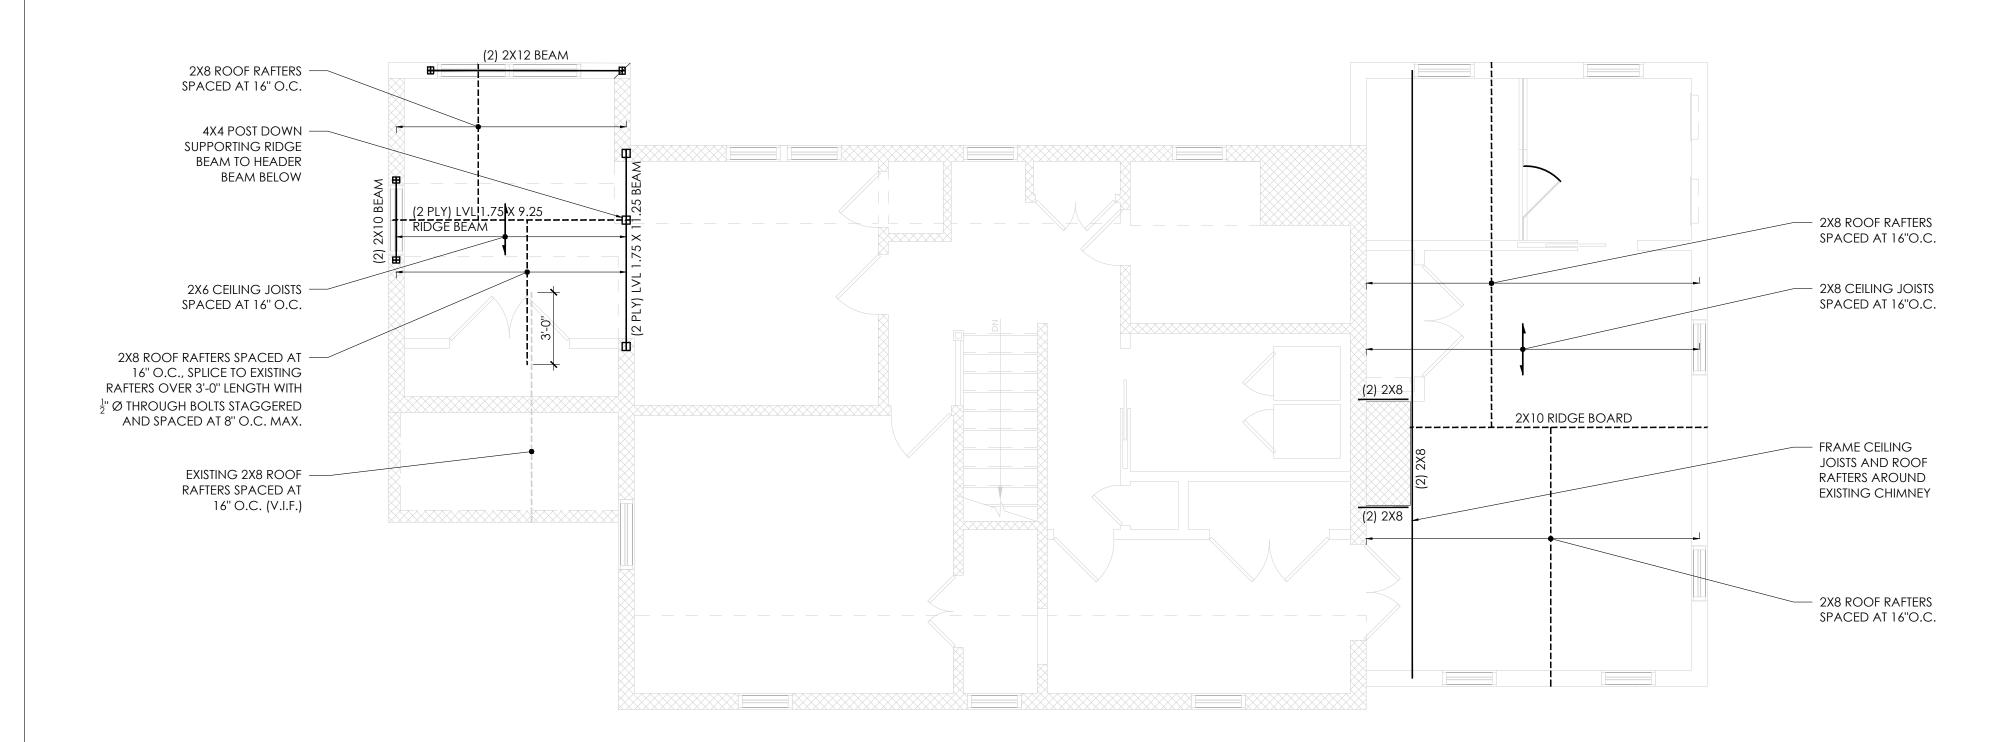

STRUCTURAL CONSTRUCTION NOTES

- 1. FRAMING SHOWN IS WITHIN THE FLOOR LEVEL REFERENCED BY THE PLAN TITLE, NOT ABOVE, UNLESS OTHERWISE NOTED. SEE ARCHITECTURAL DRAWINGS FOR TOP OF FINISH FLOOR ELEVATIONS.
- 2. CONTRACTOR IS TO IMMEDIATELY NOTIFY ARCHITECT/ENGINEER OF DISCREPANCIES THAT MAY PROHIBIT OR AFFECT THE CONSTRUCTION OF ANY PART OF THE INTENDED DESIGN.
- 3. CONTRACTOR TO PROPERLY SHORE FRAMING BEFORE REMOVING ANY LOAD-BEARING WALLS, BEAMS, OR POSTS. REMOVE SHORING ONLY WHEN NEW HEADER BEAMS AND ASSOCIATED FRAMING ARE PROPERLY SECURED ACCORDING TO STRUCTURAL PLANS AND DETAILS.
- 4. ALL STRUCTURAL STEEL SHALL CONFORM TO THE REQUIREMENTS OF THE AISC "SPECIFICATIONS STRUCTURAL STEEL FOR BUILDINGS" 13TH EDITION AND ALL CURRENT SUPPLEMENTS AND ADDENDA. FOR OTHER CODE AND SPECIFICATION REQUIREMENTS, SEE THE CONTRACT SPECIFICATIONS.
- 5. ALL STEEL WIDE FLANGE SHAPES SHALL CONFORM TO ASTM A992 (50 KSI). ALL STEEL PIPE SHALL CONFORM TO ASTM A53 TYPE E, GRADE B OR TYPE S GRADE B. ALL STEEL TUBES SHALL CONFORM TO ASTM A500, GRADE B. ALL OTHER STEEL SHAPES, PLATES, BARS, AND RODS, SHALL CONFORM TO ASTM A36 (36KSI), UNLESS NOTED OTHERWISE.
- 6. ALL NEW STRUCTURAL LUMBER TO BE DOUGLAS FIR LARCH GR. 1 OR BETTER, UNLESS OTHERWISE
- 7. LVL BEAMS TO BE TRUJOIST MICROLLAM 2.0E. SEE PLANS FOR SIZE AND NUMBER OF PLIES.
- 8. ALL NEW WOOD POSTS TO HAVE MECHANICAL COLUMN CAP FASTENERS AT TOP AND MECHANICAL COLUMN BASE FASTENERS AT BOTTOM, BY SIMPSON STRONG TIE OR APPROVED
- 9. ALL NEW STEEL POSTS TO BE ATTACHED AT TOP WITH (4) $\frac{1}{2}$ " Ø LAG BOLTS THROUGH CAP PLATE INTO BEAM ABOVE AND AT BOTTOM WITH (4) $\frac{1}{2}$ " Ø POST-INSTALLED ANCHOR BOLTS THROUGH BASE PLATE INTO EXISTING CONCRETE FOUNDATIONS BELOW.
- 10. NEW CAST IN PLACE CONCRETE FOOTINGS TO HAVE I'C = 4,000 PSI MIN. FOOTINGS TO BE PLACED ON COMPACTED NATIVE SOIL WITH A MINIMUM BEARING CAPACITY OF 2,000 PSF. BOTTOM OF NEW FOOTINGS PLACED WITHIN HEATED BUILDING ENVELOPE TO BE NO LESS THAN 12" BELOW FINISHED GRADE. BOTTOM OF EXTERIOR FOOTING TO BE NO LESS THAN 3'-6" BELOW FINISHED GRADE.
- 11. THE ENGINEERED LUMBER/TRUSS IDENTIFICATION SIGN SHOWN BELOW SHALL BE AFFIXED TO THE ELECTRICAL BOX, ATTACHED TO THE EXTERIOR OF THE RESIDENTIAL STRUCTURE, PRIOR TO ISSUANCE OF A CERTIFICATE OF OCCUPANCY OR A CERTIFICATE OF COMPLIANCE. THE SIGN INDICATES THAT TRUSS TYPE CONSTRUCTION, PRE-ENGINEERED WOOD CONSTRUCTION, AND/OR TIMBER CONSTRUCTION IS UTILIZED IN THE STRUCTURE OF THE HOME.
- 12. THE ENGINEERED LUMBER/TRUSS IDENTIFICATION SIGN SHALL BE MADE OF A STURDY, NON-FACING AND WEATHER RESISTANT MATERIAL.
- 13. THE ENGINEERED LUMBER/TRUSS IDENTIFICATION SIGN SHALL BE IN COMPLIANCE WITH PART 1265

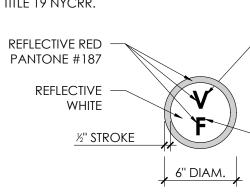

ENGINEERED LUMBER AND TRUSS INDENTIFICATION SIGN ALPHABET DESIGNATION OF CONSTRUCTION TYPE BASED ON SECTION 602 OF THE NYS **BUILDING CODE**

DESIGNATION FOR STRUCTURAL COMPONENTS THAT ARE TRUSS TYPE CONSTRUCTION:

'F' = FLOOR FRAMING (INCLUDING GIRDERS & BEAMS) 'R' = ROOF FRAMING 'FR' = FLOOR AND ROOF FRAMING

MATTHEW CORDONE ARCHITECT PLLC 92 North Broadway Irvington, NY 10533 phone: 917.749.8071 mcordone@mcapllc.net ARCHITECT PLLC

OWNERS: AVI & RUTHIE BEN-ZVI 243 JUDSON AVENUE DOBBS FERRY, NY 10522

CONSULTANTS

KEY PLAN

REVISIONS

5/24/2021 FILING SET 7/15/2021 PLANNING BOARD SET **SEAL & SIGNATURE**

PROJECT: SINGLE FAMILY HOME ADDITION 243 JUDSON AVENUE DOBBS FERRY, NY 10522

DRAWING TITLE: 2ND FLOOR, ATTIC AND ROOF

DATE: 02/22/2021 | **DWG NO**:


FRAMING PLANS AND NOTES

DRAWN BY: LCG

PROJECT NO: 21003

A-103.00 **CHECKED BY:** MVC

ATTIC AND ROOF FRAMING PLAN

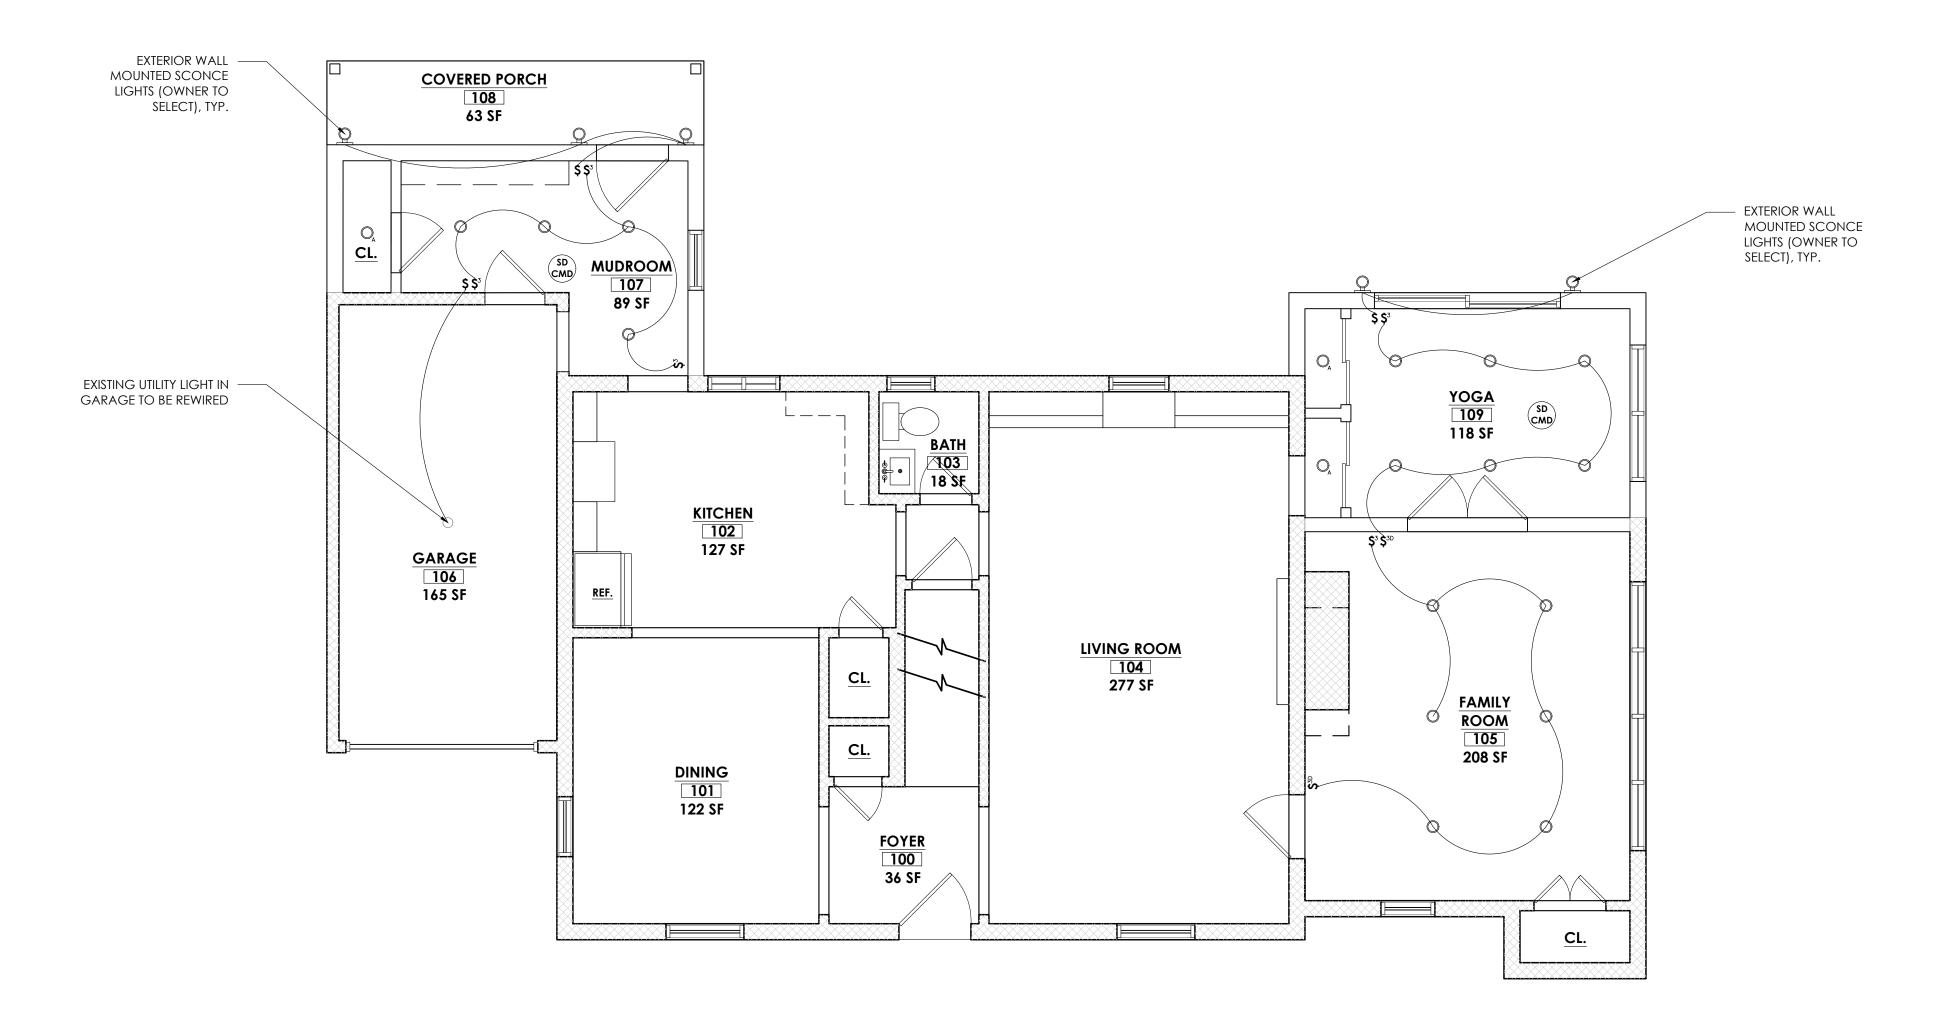

REFLECTED CEILING PLAN - FIRST FLOOR
Scale: 1/4"= 1'-0"

REFLECTED CEILING PLAN SYMBOLS

| \circ | EXISTING UTILITY LIGHT |
|-------------------------|--|
| 0 | 4" RECESSED LED LIGHT |
| 0 | 4" RECESSED LED CLOSET LIGHT ON AUTO SWITCH CONNECTED TO DOO |
| T | OUTDOOR SCONCE LIGHT |
| 000 | WALL MOUNTED VANITY LIGHT |
| | SEMI-FLUSH MOUNT FEATURE BEDROOM LIGHT |
| | FLUSH MOUNT BEDROOM LIGHT |
| | MECHANICAL VENT (50 CFM MIN) |
| SD | SMOKE AND CARBON MONOXIDE DETECTOR |
| \$ | TWO-POLE LIGHT SWITCH |
| \$ ³ | THREE-POLE LIGHT SWITCH |
| \$ ^{3D} | THREE-POLE LIGHT SWITCH WITH DIMMER |
| Gcc | GFCI DUPLEX THREE-PRONG OUTLET AT COUNTER HEIGHT (44" AFF) |
| USB | DUPLEX THREE-PRONG USB OUTLET AT DESK HEIGHT (40" AFF) |
| ∂ _A | DUPLEX THREE-PRONG OUTLET FOR APPLIANCE |

REFLECTED CEILING NOTES

FINISH FOR EXHAUST FAN GRILL.

1. CONTRACTOR IS TO IMMEDIATELY NOTIFY ARCHITECT OF DISCREPANCIES THAT MAY PROHIBIT OR AFFECT THE CONSTRUCTION ANY PART OF THE INTENDED DESIGN.

2. ALL CEILINGS DESIGNATED FOR GYPSUM BOARD FINISH SHALL RECEIVE 3/4" GYPSUM BOARD LEVEL 4 FINISH.

3. ALL RECESSED FIXTURES ARE TO BE EQUALLY SPACED AND/OR LOCATED AS INDICATED. ALL RECESSED FIXTURES ARE TO BE TRIMMED WITH WHITE COLLARS. 4. ALL BATHROOM EXHAUST FANS SHALL BE SIZED FOR 50 CFM. PROVIDE WHITE

5. ALL LIGHTING EXCEPT FOR CLOSET LIGHTS SHALL BE SWITCHED TO DIMMERS. 6. PROVIDE LOW PROFILE WHITE SMOKE AND CARBON MONOXIDE DETECTORS.

7. ALL NEW LIGHTS SHALL HAVE THE ABILITY TO REDUCE LIGHTING LOADS BY

8. 75% OF ALL PERMANENTLY INSTALLED INTERIOR LIGHT FIXTURES SHALL BE FITTED WITH HIGH EFFICIENCY LAMPS.

9. INSTALL ALL OUTLETS AT 18" HEIGHT, UNLESS NOTED OTHERWISE.

DETECTORS ARE TO BE HARD WIRED WITH BATTERY BACK UP.

10. NEW CEILING SHALL HAVE BATT INSULATION R32.

MATTHEW CORDONE ARCHITECT PLLC 92 North Broadway Irvington, NY 10533 phone: 917.749.8071 mcordone@mcapllc.net

OWNERS:

AVI & RUTHIE BEN-ZVI 243 JUDSON AVENUE DOBBS FERRY, NY 10522

CONSULTANTS

KEY PLAN

REVISIONS 5/24/2021 FILING SET 7/15/2021 PLANNING BOARD SET

SEAL & SIGNATURE



PROJECT:

SINGLE FAMILY HOME ADDITION 243 JUDSON AVENUE DOBBS FERRY, NY 10522


DRAWING TITLE:

REFLECTED CEILING PLANS

DATE: 02/22/2021 **DWG NO:**

A-130.00

DRAWN BY: LCG CHECKED BY: MVC

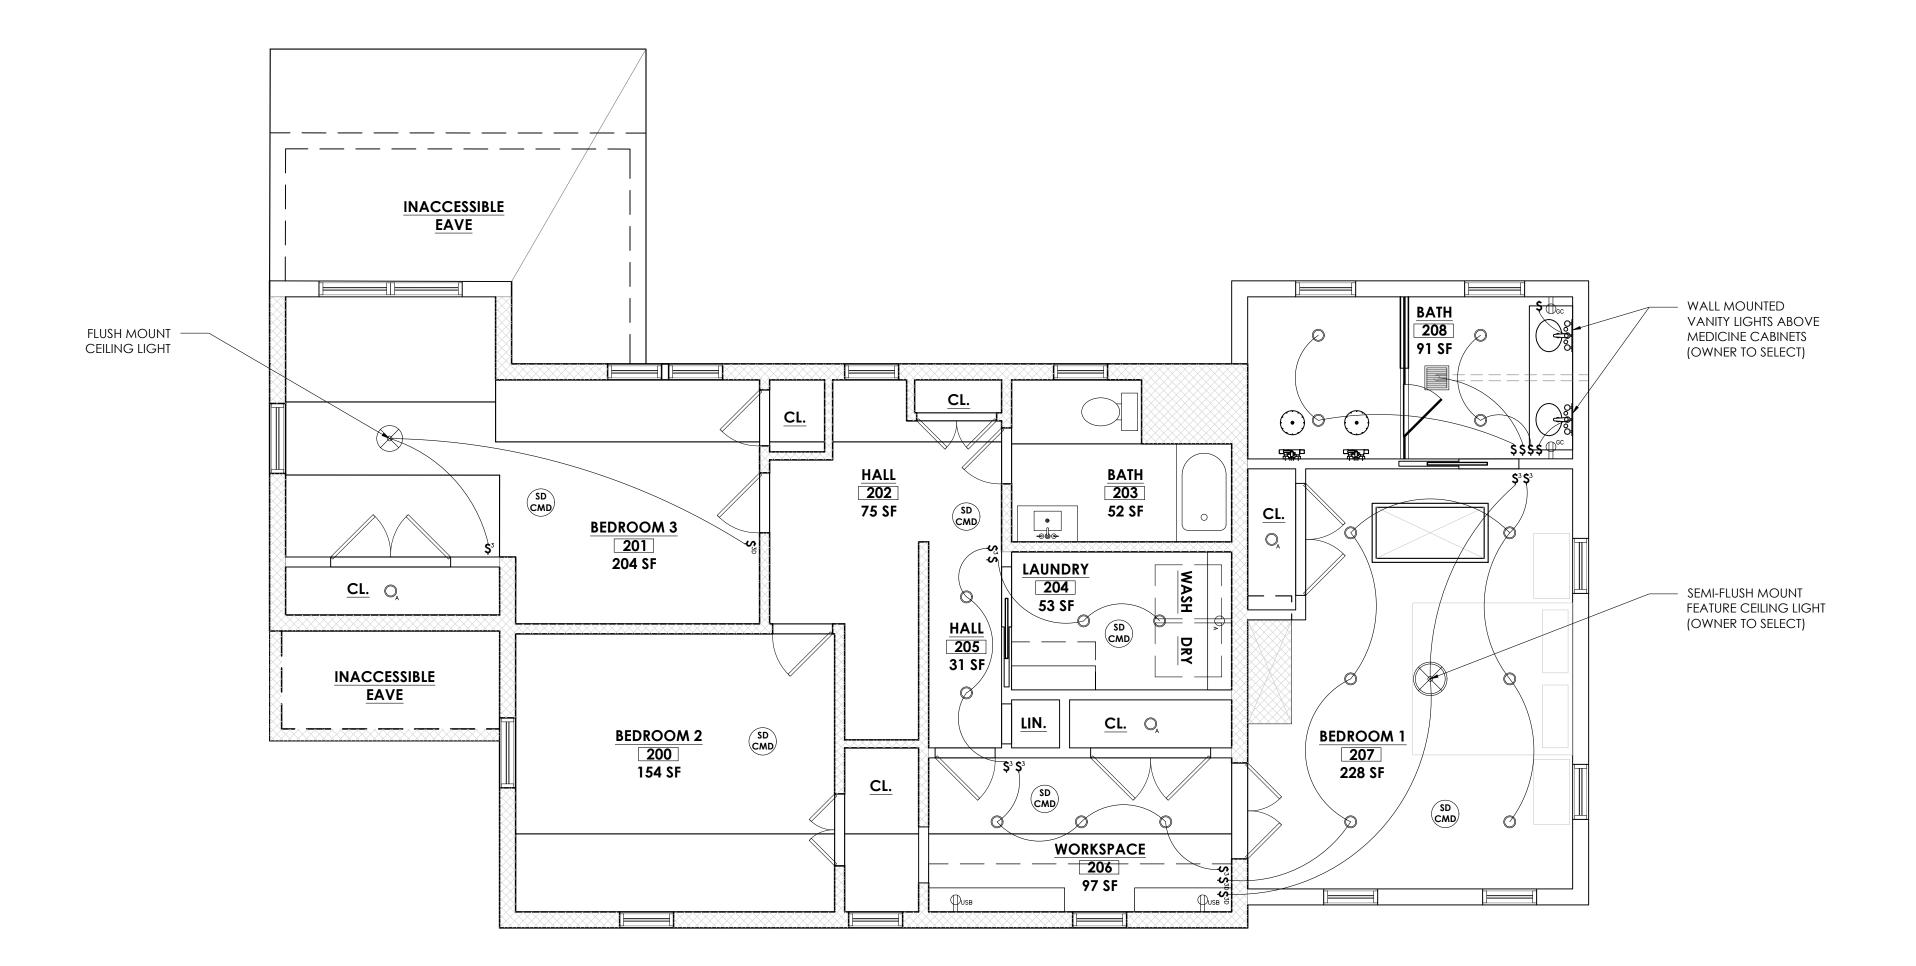

REFLECTED CEILING PLAN - SECOND FLOOR

Scale: 1/4"= 1'-0"

REFLECTED CELLING PLAN SYMBOLS

| KEFLEC | TED CEILING PLAIN STMBOLS |
|------------------------|--|
| 0 | 4" RECESSED LED LIGHT |
| 0 | 4" RECESSED LED CLOSET LIGHT ON AUTO SWITCH CONNECTED TO DOO |
| 7 | OUTDOOR SCONCE LIGHT |
| 000 | WALL MOUNTED VANITY LIGHT |
| | SEMI-FLUSH MOUNT FEATURE BEDROOM LIGHT |
| | FLUSH MOUNT BEDROOM LIGHT |
| | MECHANICAL VENT (50 CFM MIN) |
| CMD | SMOKE AND CARBON MONOXIDE DETECTOR |
| \$ | TWO-POLE LIGHT SWITCH |
| \$ ³ | THREE-POLE LIGHT SWITCH |
| \$ ^{3D} | THREE-POLE LIGHT SWITCH WITH DIMMER |
| Ж | GFCI DUPLEX THREE-PRONG OUTLET AT COUNTER HEIGHT (44" AFF) |

REFLECTED CEILING NOTES

1. CONTRACTOR IS TO IMMEDIATELY NOTIFY ARCHITECT OF DISCREPANCIES THAT MAY PROHIBIT OR AFFECT THE CONSTRUCTION ANY PART OF THE INTENDED DESIGN.

2. ALL CEILINGS DESIGNATED FOR GYPSUM BOARD FINISH SHALL RECEIVE 3/4" GYPSUM BOARD LEVEL 4 FINISH.

3. ALL RECESSED FIXTURES ARE TO BE EQUALLY SPACED AND/OR LOCATED AS INDICATED. ALL RECESSED FIXTURES ARE TO BE TRIMMED WITH WHITE COLLARS.

4. ALL BATHROOM EXHAUST FANS SHALL BE SIZED FOR 50 CFM. PROVIDE WHITE FINISH FOR EXHAUST FAN GRILL.

5. ALL LIGHTING EXCEPT FOR CLOSET LIGHTS SHALL BE SWITCHED TO DIMMERS. 6. PROVIDE LOW PROFILE WHITE SMOKE AND CARBON MONOXIDE DETECTORS.

DETECTORS ARE TO BE HARD WIRED WITH BATTERY BACK UP. 7. ALL NEW LIGHTS SHALL HAVE THE ABILITY TO REDUCE LIGHTING LOADS BY

8. 75% OF ALL PERMANENTLY INSTALLED INTERIOR LIGHT FIXTURES SHALL BE

FITTED WITH HIGH EFFICIENCY LAMPS.

9. Install all outlets at 18" height, unless noted otherwise. 10. NEW CEILING SHALL HAVE BATT INSULATION R32.

MATTHEW CORDONE ARCHITECT PLLC 92 North Broadway Irvington, NY 10533 phone: 917.749.8071 mcordone@mcapllc.net ARCHITECT PLLC

OWNERS:

AVI & RUTHIE BEN-ZVI 243 JUDSON AVENUE DOBBS FERRY, NY 10522

CONSULTANTS

KEY PLAN

REVISIONS 5/24/2021 FILING SET 7/15/2021 PLANNING BOARD SET

SEAL & SIGNATURE



PROJECT:

SINGLE FAMILY HOME ADDITION 243 JUDSON AVENUE DOBBS FERRY, NY 10522

DRAWING TITLE:


REFLECTED CEILING PLANS


DATE: 02/22/2021 **DWG NO:**

DRAWN BY: LCG

CHECKED BY: MVC

A-131.00

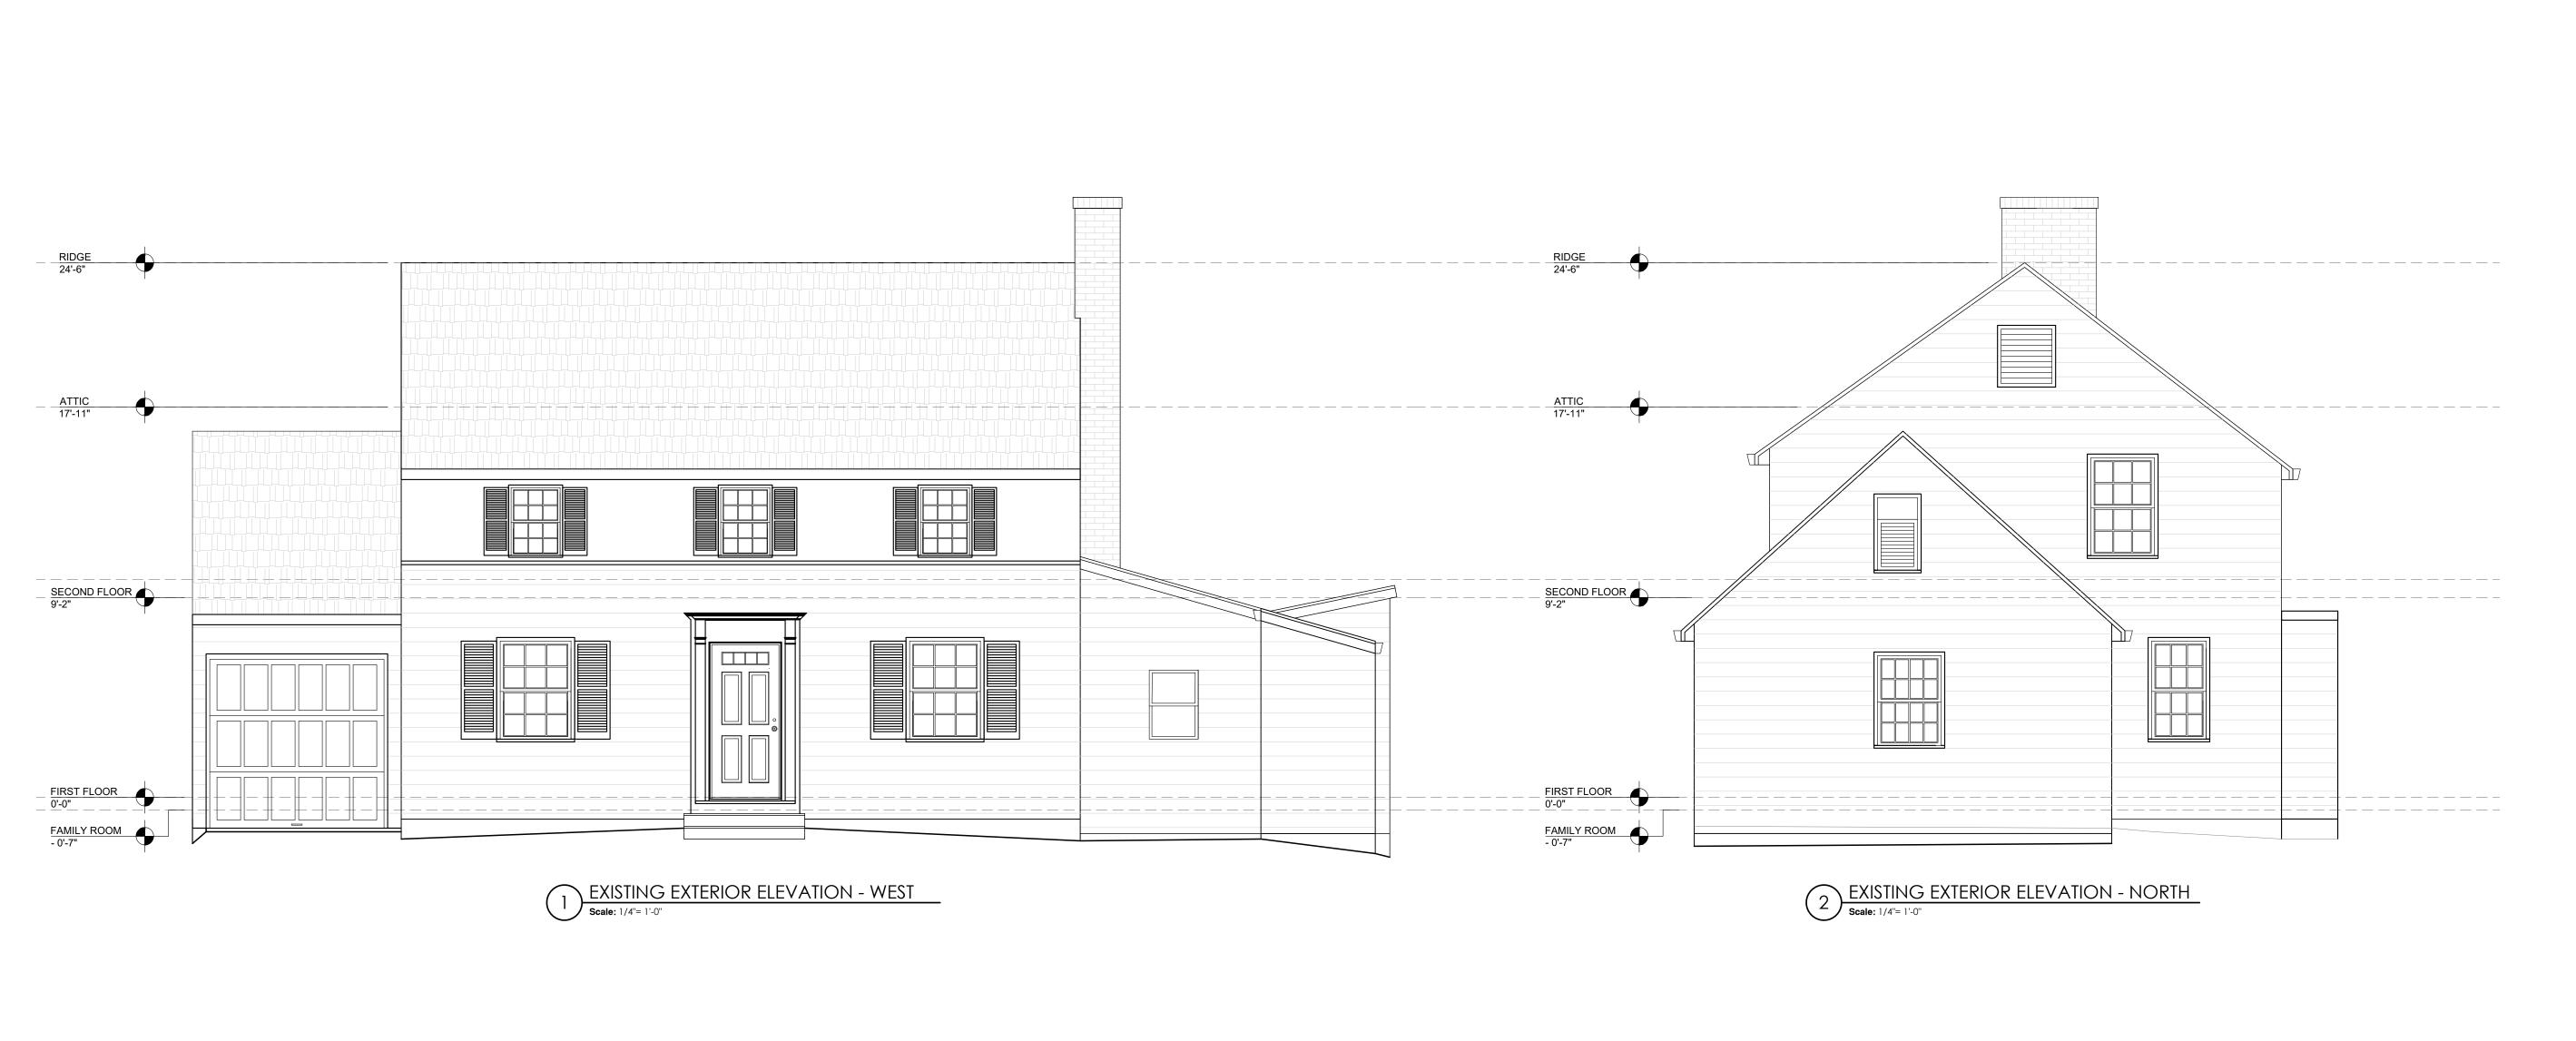

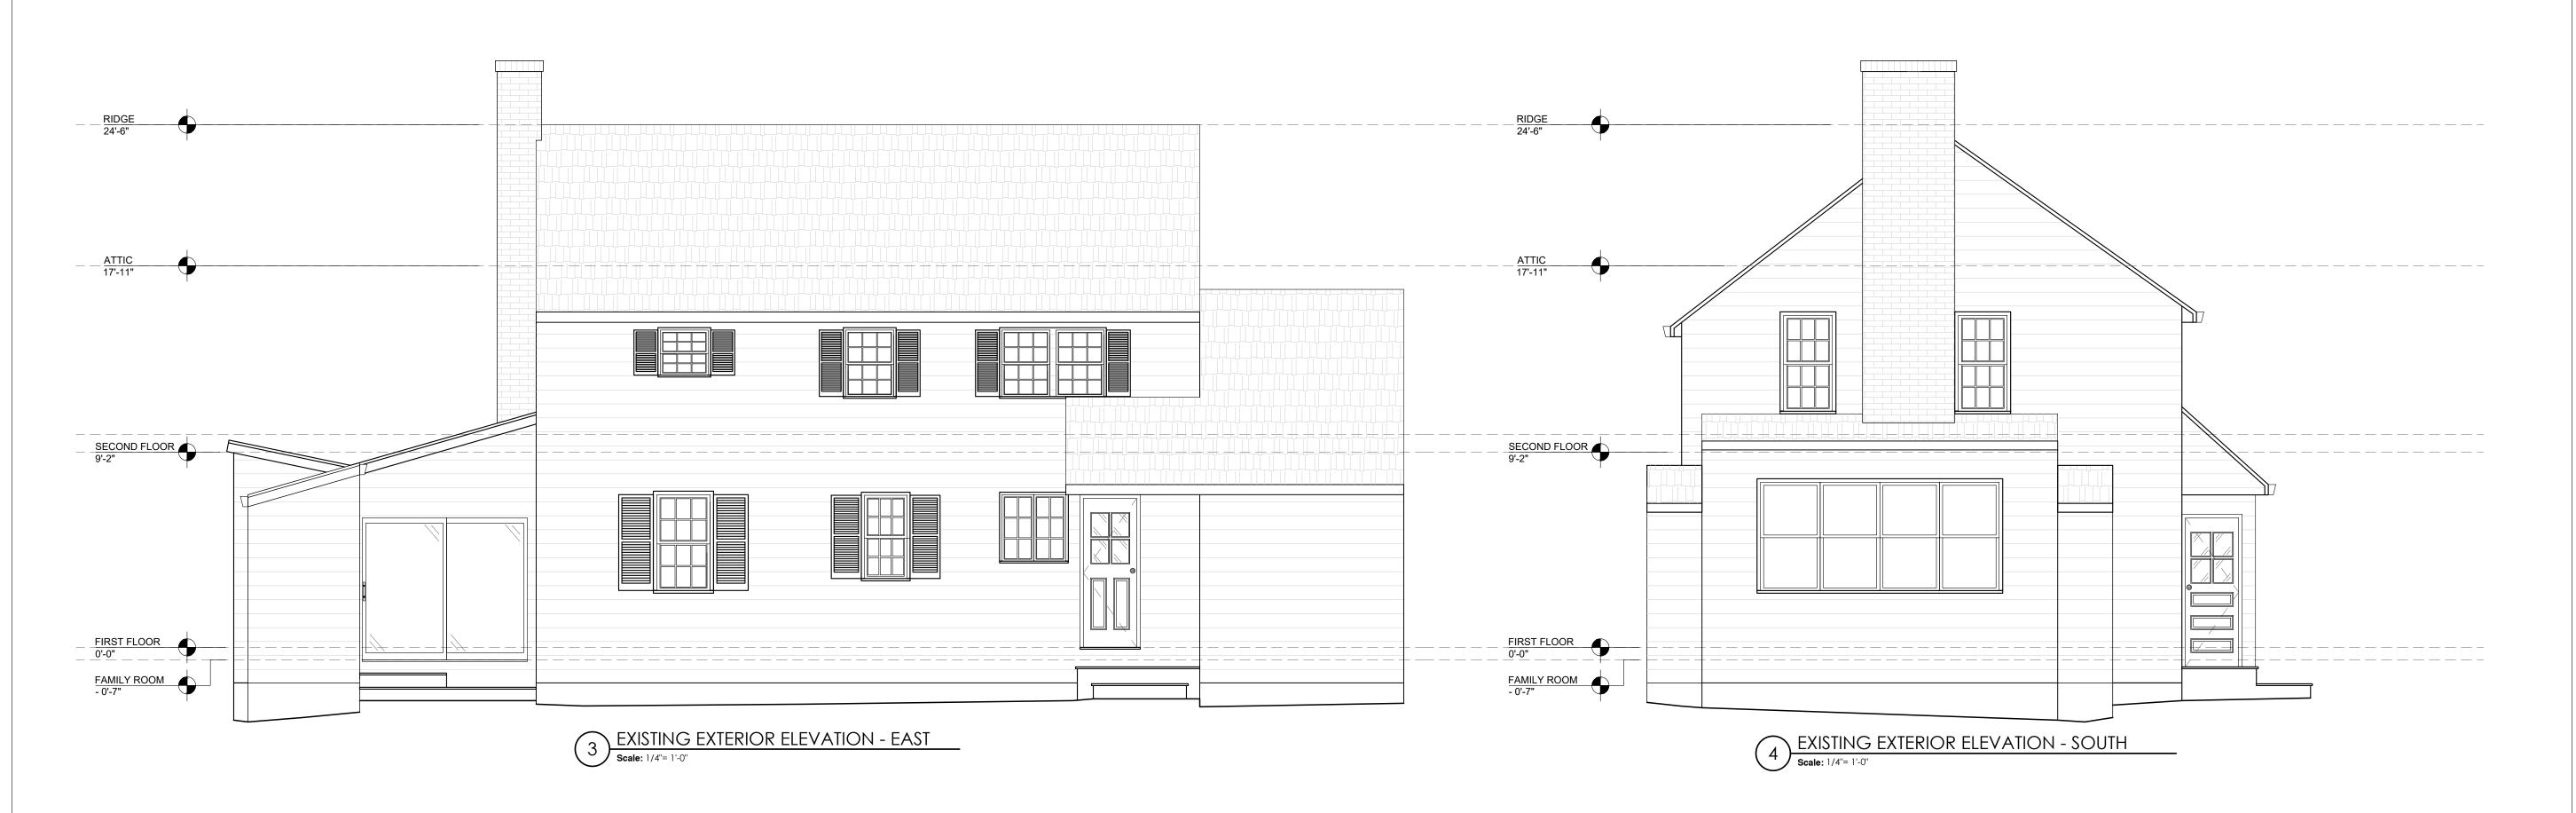

MATTHEW CORDONE ARCHITECT PLLC 92 North Broadway
Irvington, NY 10533
phone: 917.749.8071
mcordone@mcapllc.net

OWNERS:

AVI & RUTHIE BEN-ZVI 243 JUDSON AVENUE DOBBS FERRY, NY 10522

CONSULTANTS

KEY PLAN

REVISIONS 5/24/2021 FILING SET

7/15/2021 PLANNING BOARD SET

SEAL & SIGNATURE



PROJECT:

SINGLE FAMILY HOME ADDITION 243 JUDSON AVENUE DOBBS FERRY, NY 10522

DRAWING TITLE:

EXISTING ELEVATIONS

DATE: 02/22/2021 **DWG NO**:

DRAWN BY: LCG

A-200.00 CHECKED BY: MVC





PROPOSED EXTERIOR ELEVATION - NORTH

Scale: 1/4"= 1'-0"

MATTHEW CORDONE ARCHITECT PLLC 92 North Broadway Irvington, NY 10533 phone: 917.749.8071 mcordone@mcapllc.net

OWNERS:

AVI & RUTHIE BEN-ZVI 243 JUDSON AVENUE DOBBS FERRY, NY 10522

CONSULTANTS

KEY PLAN

REVISIONS 5/24/2021 FILING SET

7/15/2021 PLANNING BOARD SET

SEAL & SIGNATURE



PROJECT:

SINGLE FAMILY HOME ADDITION 243 JUDSON AVENUE DOBBS FERRY, NY 10522

DRAWING TITLE:

PROPOSED ELEVATIONS

DATE: 02/22/2021 **DWG NO:**

DRAWN BY: LCG

CHECKED BY: MVC

A-201.00





MATTHEW CORDONE ARCHITECT PLLC 92 North Broadway
Irvington, NY 10533
phone: 917.749.8071
mcordone@mcapllc.net

OWNERS:

AVI & RUTHIE BEN-ZVI 243 JUDSON AVENUE DOBBS FERRY, NY 10522

CONSULTANTS

KEY PLAN

REVISIONS 5/24/2021 FILING SET 7/15/2021 PLANNING BOARD SET

SEAL & SIGNATURE



PROJECT:

SINGLE FAMILY HOME ADDITION 243 JUDSON AVENUE DOBBS FERRY, NY 10522


DRAWING TITLE:

PROPOSED ELEVATIONS


DATE: 02/22/2021 **DWG NO:**

DRAWN BY: LCG CHECKED BY: MVC

A-202.00

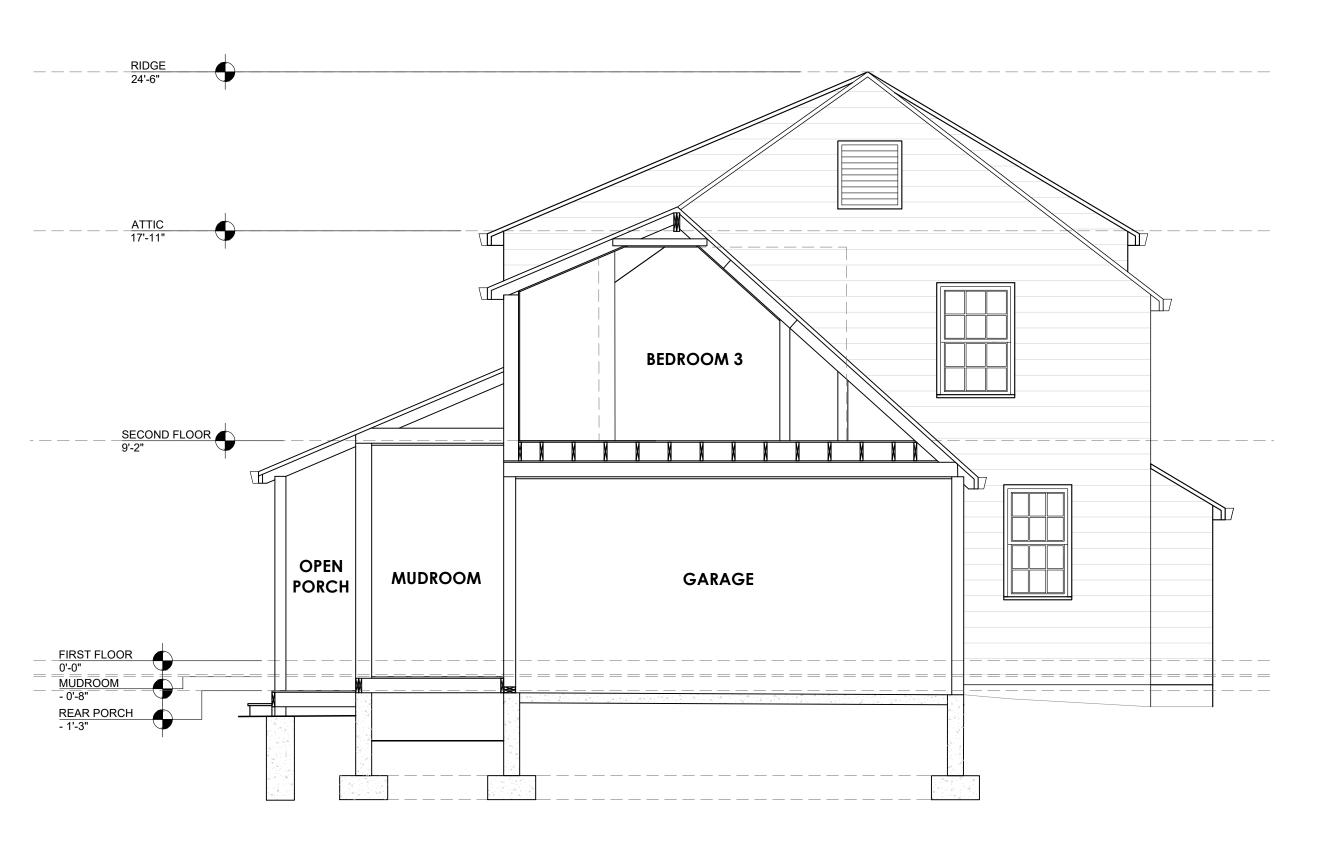

PROPOSED BUILDING SECTION Scale: 1/4"= 1"-0"

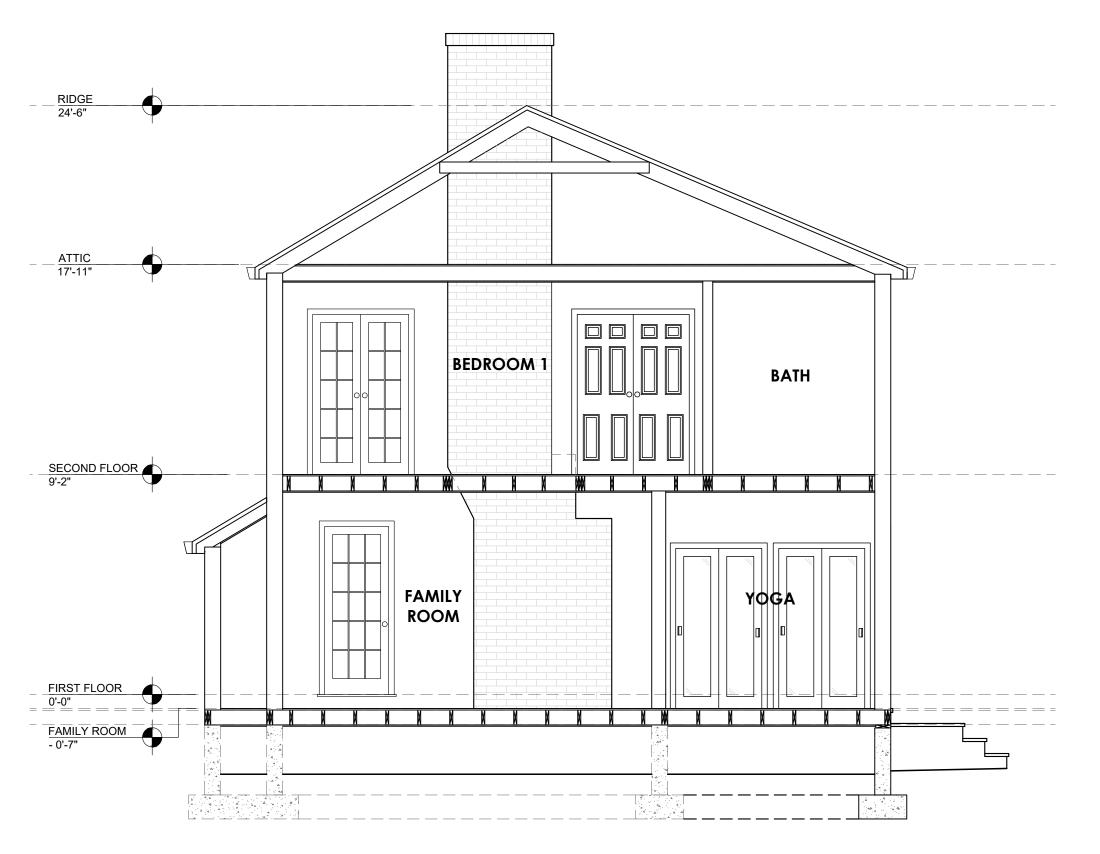

PROPOSED BUILDING SECTION

Scale: 1/4"= 1'-0"

MATTHEW CORDONE ARCHITECT PLLC 92 North Broadway Irvington, NY 10533 phone: 917.749.8071 mcordone@mcapllc.net

OWNERS:

AVI & RUTHIE BEN-ZVI 243 JUDSON AVENUE DOBBS FERRY, NY 10522

CONSULTANTS

KEY PLAN

REVISIONS 5/24/2021 FILING SET 7/15/2021 PLANNING BOARD SET

SEAL & SIGNATURE



PROJECT:

SINGLE FAMILY HOME ADDITION 243 JUDSON AVENUE DOBBS FERRY, NY 10522


DRAWING TITLE:

PROPOSED BUILDING SECTIONS

DATE: 02/22/2021 **DWG NO:**

DRAWN BY: LCG CHECKED BY: MVC


A-300.00

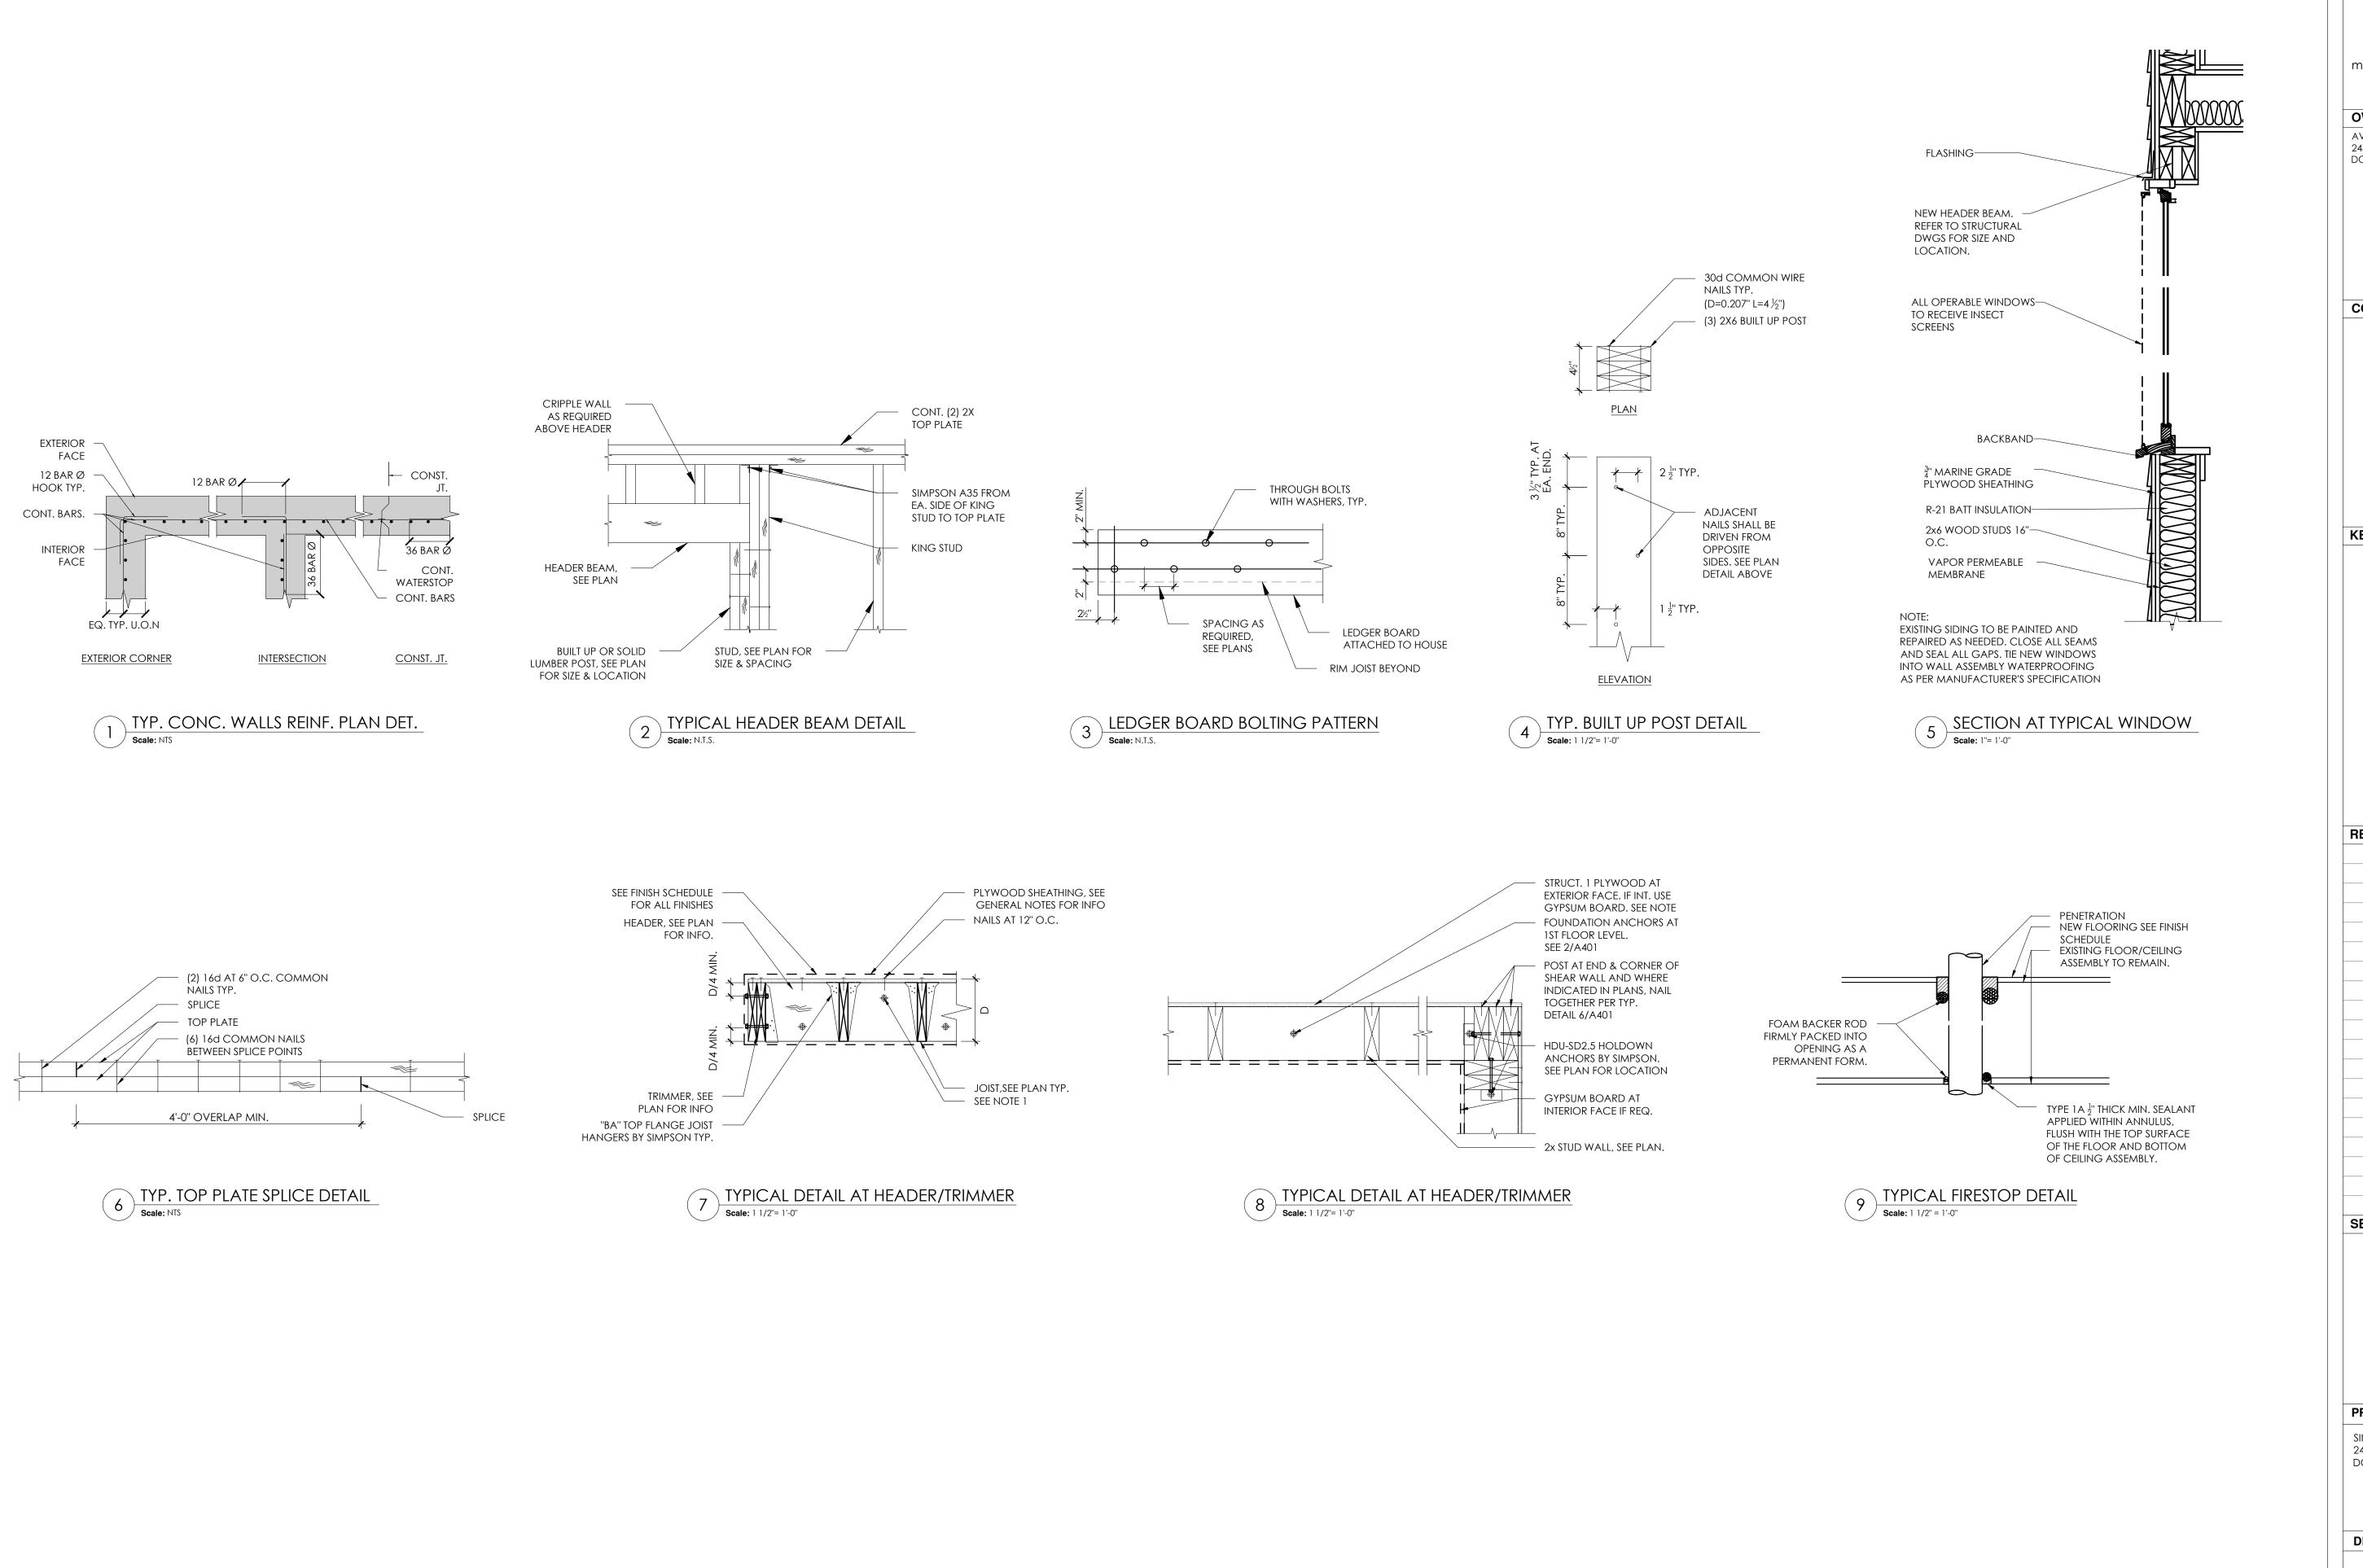

92 North Broadway Irvington, NY 10533 phone: 917.749.8071 mcordone@mcapllc.net ARCHITECT PLLC **OWNERS:** AVI & RUTHIE BEN-ZVI 243 JUDSON AVENUE DOBBS FERRY, NY 10522 **CONSULTANTS KEY PLAN REVISIONS** 5/24/2021 FILING SET 7/15/2021 PLANNING BOARD SET **SEAL & SIGNATURE** PROJECT: SINGLE FAMILY HOME ADDITION 243 JUDSON AVENUE DOBBS FERRY, NY 10522 **DRAWING TITLE:** CONSTRUCTION DETAILS **DATE:** 02/22/2021 **DWG NO:** DRAWN BY: LCG A-400.00 **CHECKED BY:** MVC PROJECT NO: 21003

MATTHEW CORDONE

ARCHITECT PLLC

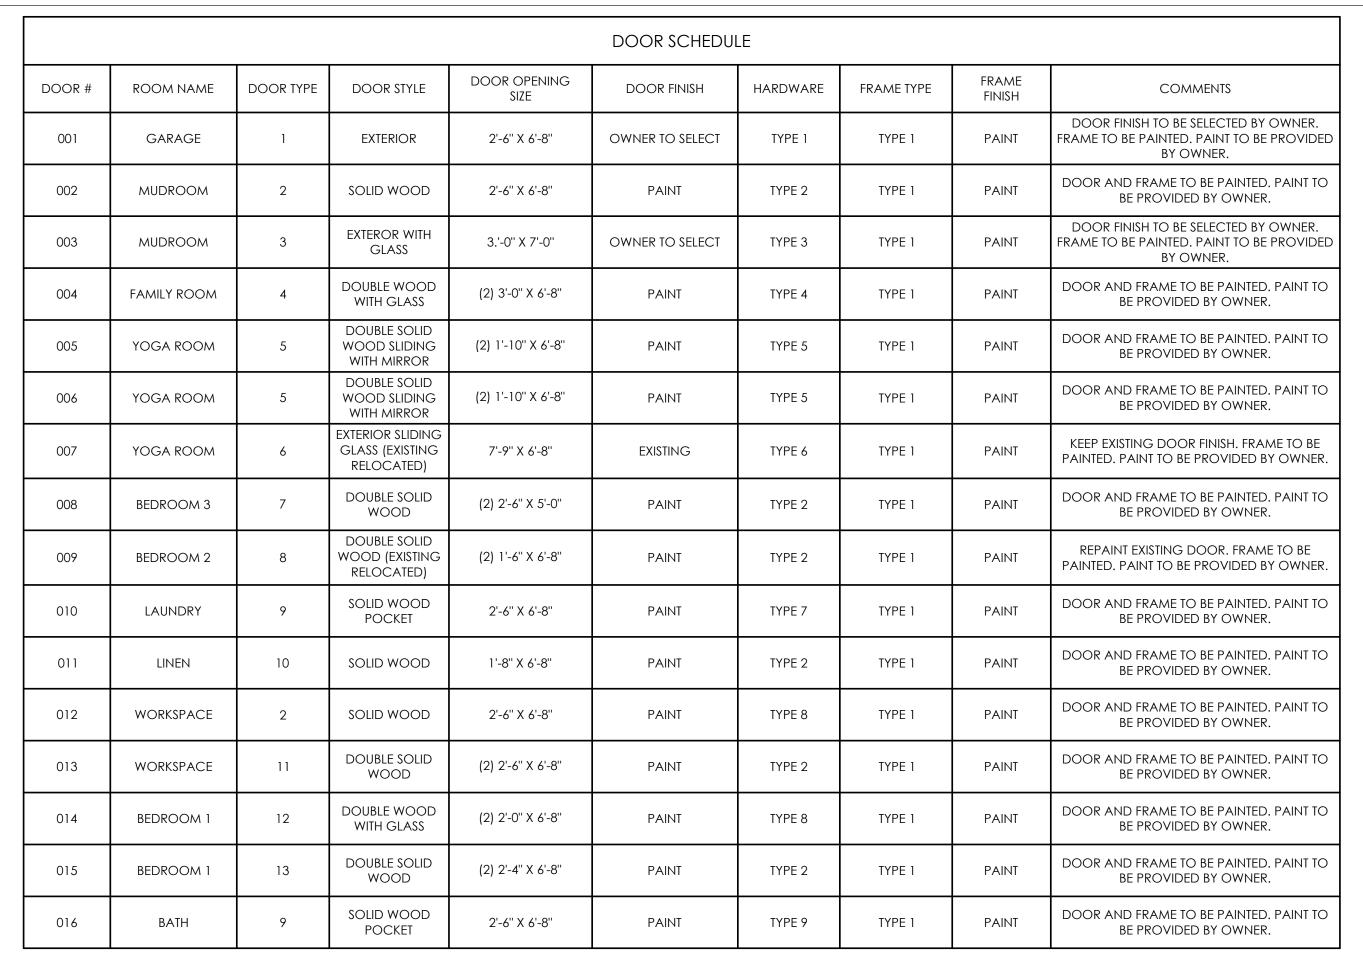

HEIGHT

TYPE 3

TYPE 2

HEIGHT

TYPE 1

DOOR HARDWARE TYPES DOOR FRAME TYPES

TYPE 1

STANDARD HEIGHT

TYPE 5

TYPE 1: EXTERIOR RESIDENTIAL GRADE DOOR WITH PASSAGE LOCKSET. HARDWARE TO BE SPECIFIED BY OWNER.

TYPE 2: INTERIOR RESIDENTIAL GRADE DOOR WITH EXTERIOR KNOB. OWNER TO SPECIFY HARDWARE.

TYPE 3: EXTERIOR RESIDENTIAL GRADE DOOR WITH SECURITY LOCKSET. OWNER TO SPECIFY HARDWARE.

TYPE 4: INTERIOR RESIDENTIAL GRADE DOOR WITH KNOBS ON BOTH SIDES. OWNER TO SPECIFY HARDWARE.


INTERIOR RESIDENTIAL GRADE DOOR WITH FLUSH MOUNT EXTERIOR PULLS. OWNER TO SPECIFY HARDWARE.

TYPE 6: EXISTING EXTERIOR RESIDENTIAL GRADE DOOR. USE EXISTING HARDWARE.

TYPE 7: INTERIOR RESIDENTIAL GRADE DOOR WITH FLUSH MOUNT PULLS ON BOTH SIDES. OWNER TO SELECT HARDWARE.

TYPE 8: INTERIOR RESIDENTIAL GRADE DOOR WITH PRIVACY LOCKSET. OWNER TO SELECT HARDWARE.

TYPE 9: INTERIOR RESIDENTIAL GRADE DOOR WITH FLUSH MOUNT PULLS ON BOTH SIDES AND PRIVACY LOCKSET. OWNER TO SELECT HARDWARE.

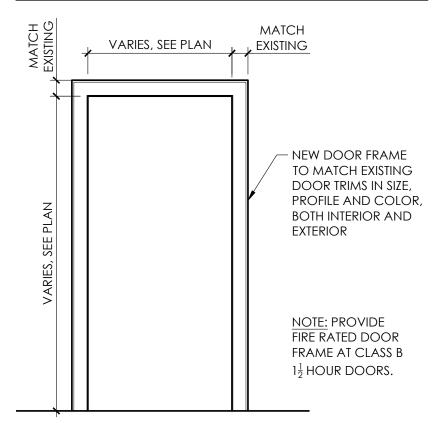

3'-9½" (V.I.F.)

TYPE 6

— EXISTING VINYL

SLIDING DOOR,

AND GLASS

RELOCATED

– EXISTING

HARDWARE

TO REMAIN

MATTHEW CORDONE

ARCHITECT PLLC

92 North Broadway

Irvington, NY 10533

phone: 917.749.8071

mcordone@mcapllc.net ARCHITECT PLLC

CONSULTANTS

OWNERS:

AVI & RUTHIE BEN-ZVI

243 JUDSON AVENUE

DOBBS FERRY, NY 10522

KEY PLAN

REVISIONS

| | 5/24/2021 | FILING SET |
|--|-----------|--------------------|
| | 7/15/2021 | PLANNING BOARD SET |
| | | |
| | | |
SEAL & SIGNATURE



PROJECT: SINGLE FAMILY HOME ADDITION 243 JUDSON AVENUE

DOBBS FERRY, NY 10522

DRAWING TITLE:

DOOR SCHEDULE AND DETAILS

DATE: 02/22/2021 | **DWG NO**:

DRAWN BY: LCG **CHECKED BY:** MVC

PROJECT NO: 21003

A-700.00


DOOR TYPES - EXTERIOR DOOR, OWNER TO SELECT - SOLID WOOD - EXTERIOR - SOLID WOOD – SOLID WOOD DOOR, OWNER INTERIOR DOOR DOUBLE SLIDING AND GLASS TO SELECT TO MATCH INTERIOR DOUBLE DOORS WITH FULL EXISTING DOORS FRENCH DOOR LENGTH MIRRORS - KNOBS TO BE MOUNTED AT STANDARD HEIGHT - KNOBS TO BE - KNOBS TO BE – KNOBS TO BE - FLUSH MOUNT MOUNTED AT MOUNTED AT MOUNTED AT PULLS TO BE STANDARD STANDARD STANDARD MOUNTED AT


2'-4'' - SOLID WOOD - SOLID WOOD - SOLID WOOD – SOLID WOOD INTERIOR SLIDING AND GLASS POCKET DOOR INTERIOR DOUBLE INTERIOR DOUBLE INTERIOR DOUBLE DOOR TO MATCH - SOLID WOOD - EXISTING SOLID TO MATCH DOOR TO MATCH - SOLID WOOD FRENCH DOOR EXISTING DOORS EXISTING DOORS INTERIOR DOUBLE WOOD INTERIOR EXISTING DOORS INTERIOR DOOR DOOR TO MATCH DOUBLE DOOR, TO MATCH EXISTING DOORS RELOCATED **EXISTING DOORS** - KNOBS TO BE - PULLS TO BE $O|\mathcal{O}_{\bullet}$ - KNOBS TO BE – KNOBS TO BE MOUNTED AT - KNOBS TO BE - EXISTING MOUNTED AT MOUNTED AT MOUNTED AT STANDARD MOUNTED AT HARDWARE STANDARD STANDARD STANDARD HEIGHT STANDARD TO REMAIN HEIGHT - KNOBS TO BE HEIGHT HEIGHT HEIGHT MOUNTED AT HALF HEIGHT TYPE 7 TYPE 11 TYPE 9 TYPE 10 TYPE 13 TYPE 8 TYPE 12


HEIGHT

TYPE 4

| | WINDOW SCHEDULE | | | | | | | | |
|----------|-----------------|-----------------------|--------------------|----------|---------|------------------------------|--|--|--|
| WINDOW # | WINDOW TYPE | WIDTH | HEIGHT | MATERIAL | GLAZE | ACTION | COMMENTS | | |
| 001 | TYPE 1 | 2'-0'' | 4'-0'' | VINYL | THERMAL | DOUBLE HUNG | USE ANDERSEN 400 SERIES WINDOW. ALL WINDOWS TO HAVE MINIMUM U-35 FACTOR. | | |
| 002 | TYPE 2 | 2'-3'' | 4'-0'' | VINYL | THERMAL | DOUBLE HUNG | USE ANDERSEN 400 SERIES WINDOW. ALL WINDOWS TO HAVE MINIMUM U-35 FACTOR. | | |
| 003 | TYPE 3 | 5'-7 ½'' | 5'-1" (V.I.F.) | WOOD | THERMAL | DOUBLE HUNG DOUBLE WINDOW | MATCH EXISTING WINDOWS IN FAMILY ROOM IN SIZE, STYLE, FINISH, AND COLOR. ALL WINDOWS TO HAVE MINIMUM U-35 FACTOR. | | |
| 004 | TYPE 4 | 2'-11" | 4'-6" | VINYL | THERMAL | DOUBLE HUNG | USE ANDERSEN 400 SERIES WINDOW. ALL WINDOWS TO HAVE MINIMUM U-35 FACTOR. | | |
| 005 | TYPE 5 | 5'-11 5 '' | 1'-5" | VINYL | THERMAL | DOUBLE AWNING | USE ANDERSEN 400 SERIES WINDOW. ALL WINDOWS TO HAVE MINIMUM U-35 FACTOR. | | |
| 006 | TYPE 2 | 2'-3'' | 4'-0'' | VINYL | THERMAL | DOUBLE HUNG | USE ANDERSEN 400 SERIES WINDOW. ALL WINDOWS TO HAVE MINIMUM U-35 FACTOR. | | |
| 007 | TYPE 2 | 2'-3" | 4'-0'' | VINYL | THERMAL | DOUBLE HUNG | USE ANDERSEN 400 SERIES WINDOW. ALL WINDOWS TO HAVE MINIMUM U-35 FACTOR. | | |
| 008 | TYPE 6 | 2'-3 ½" (V.I.F.) | 4'-6'' (V.I.F.) | VINYL | THERMAL | DOUBLE HUNG | EXISTING WINDOW RELOCATED FROM FORMER BEDROOM 1. | | |
| 009 | TYPE 6 | 2'-3 ½" (V.I.F.) | 4'-6'' (V.I.F.) | VINYL | THERMAL | DOUBLE HUNG | EXISTING WINDOW RELOCATED FROM FORMER BEDROOM 1. | | |
| 010 | TYPE 7 | 2'-6'' (V.I.F.) | 4'-6'' (V.I.F.) | VINYL | THERMAL | DOUBLE HUNG | MATCH EXISTING WINDOW RELOCATED FROM LIVING ROOM IN SIZE, STYLE, FINISH, AND COLOR (SEE WINDOW 011). ALL WINDOWS TO HAVE MINIMUM U-35 FACTOR. | | |
| 011 | TYPE 7 | 2'-6'' (V.I.F.) | 4'-6'' (V.I.F.) | VINYL | THERMAL | DOUBLE HUNG | EXISTING WINDOW RELOCATED FROM LIVING ROOM. | | |

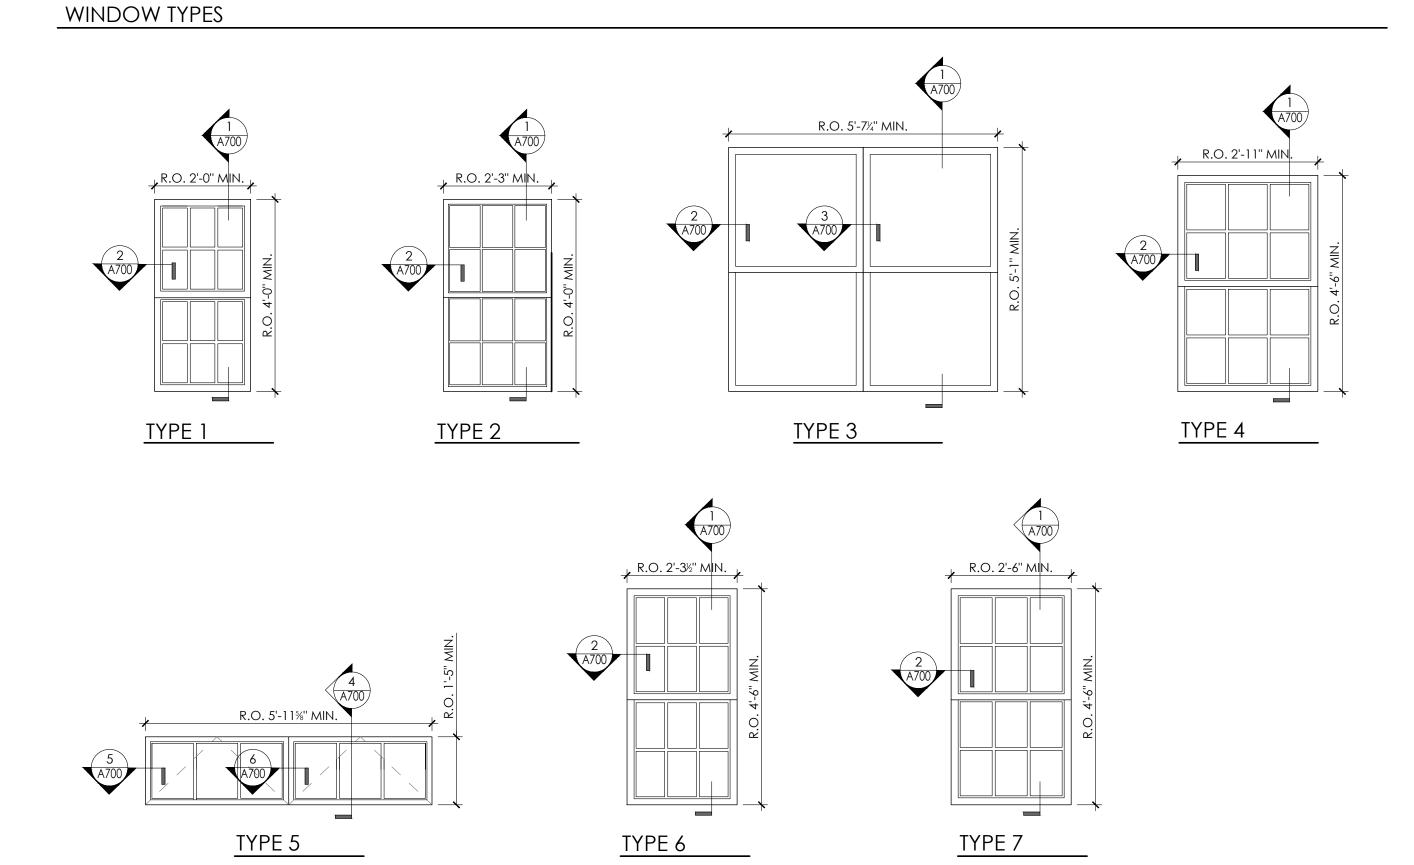

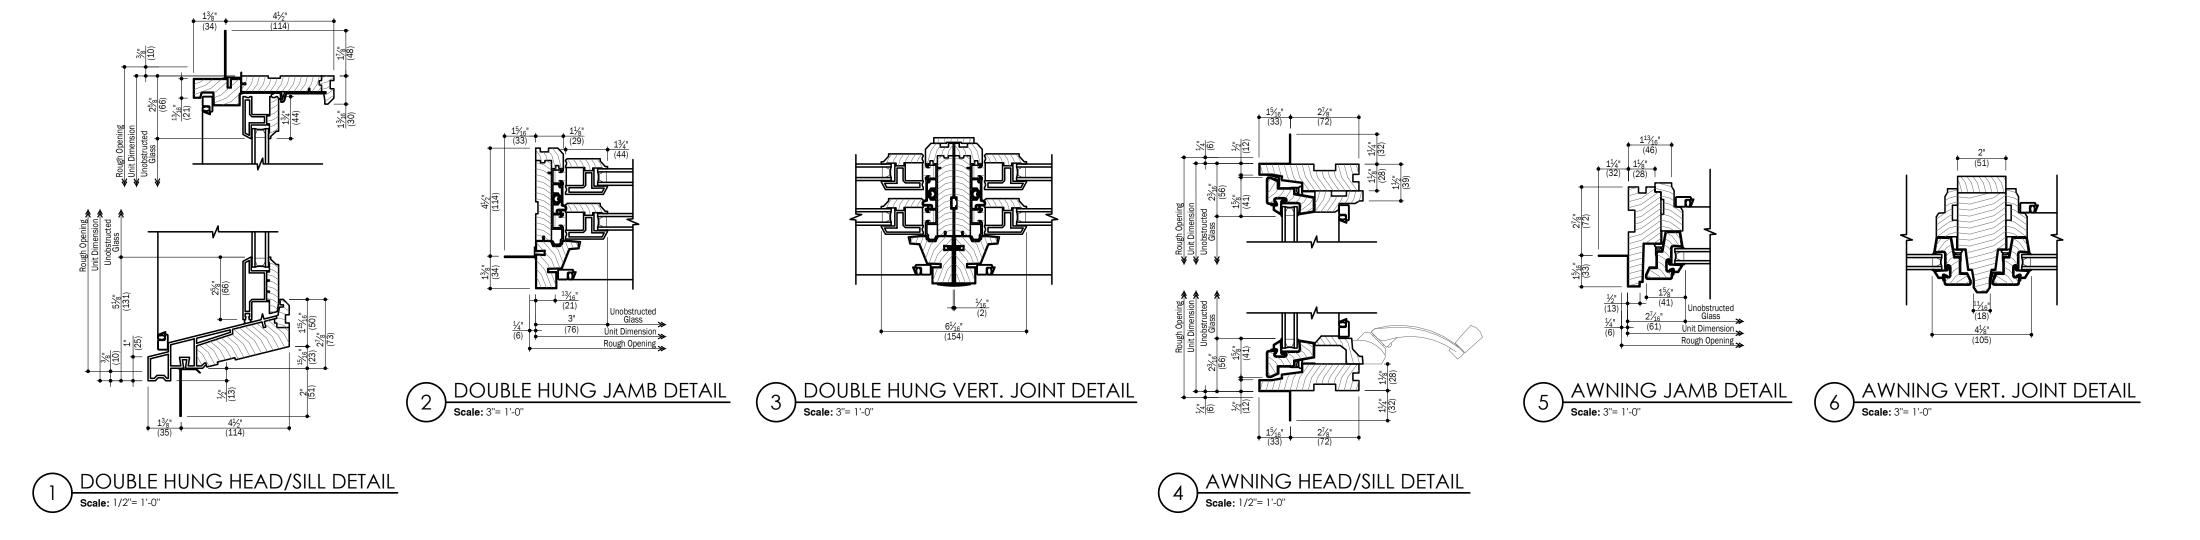

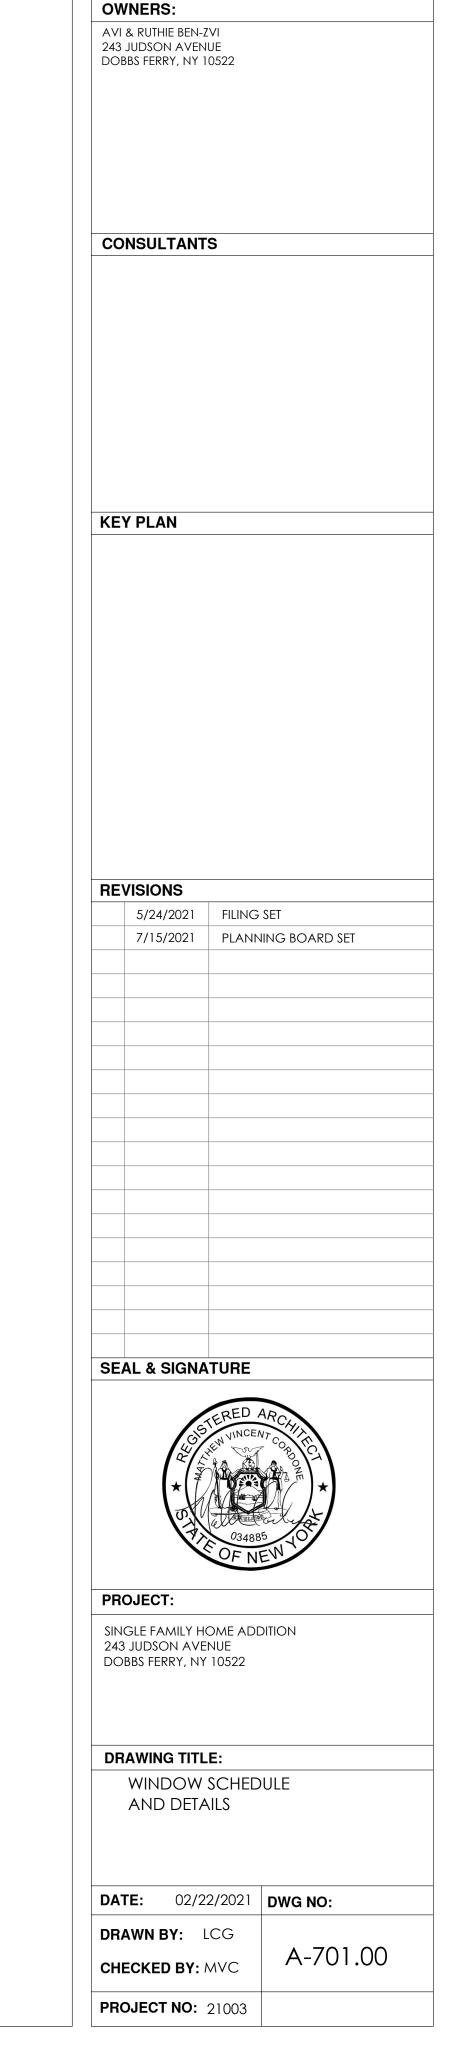

MATTHEW CORDONE ARCHITECT PLLC

92 North Broadway
Irvington, NY 10533
phone: 917.749.8071
mcordone@mcapllc.net