

PROFILE STA. 0+00 TO STA. 1+01 HORIZONTAL SCALE: 1" = 10' VERTICAL SCALE: 1" = 5'

ZONING ANALYSIS TABLE			
SECTION: 3.70 BLOCK: 151	DISTRICT: OF4 (One-Family Residence)		
LOT: 18 REGULATION	REQ'D	EVISTING	PROPOSED
Lot size (s.f.)	10,000	18,991.0	18,991.0
Net lot area (per 300-34A(2))	10,000	17,910.0	17,910.0
Min. Lot Width (ft.)	100	120.5	120.5
Min. Lot Depth (ft.)	100	152.7	152.7
Min. Yards			
- Front (ft.)	25	66.0	44.0
- Side 1 (ft.)	12	31.3	12.0
- Side Both (ft.)	30	80.4	54.1
- Rear (ft.)	25	56.5	43.6
Max. Bldg. Coverage (sf)	4,178	1,239	3,158
Max. Bldg. Coverage (%)	22.0%	6.5%	16.6%
Max. Impervious Cov. (sf)	7596.4	4580	7548
Max. Impervious Cov. (%)	40.0%	24.1%	39.7%

LEGEND

PROPERTY LINE PROPOSED BELGIAN BLOCK CURB PROPOSED ASPHALT DRIVEWAY PROPOSED BLUESTONE PATIO PROPOSED CONCRETE MECHANICAL PAD PROPOSED PERVIOUS PAVER WALKWAY PROPOSED GRAVEL WALKWAY PROPOSED STONE MASONRY WALL PROPOSED CONTOUR PROPOSED SPOT +361.30 GRADE PROPOSED STORM PIPE PROPOSED DRAIN PROPOSED FENCE PROPOSED TRENCH DRAIN ENGINEER: HUDSON ENGINEERING & CONSULTING 45 KNOLLWOOD ROAD — SUITE 201 ELMSFORD, NY 10523 PROPOSED WATER SERVICE PROPOSED SANITARY SEWER SERVICE LANDSCAPE ARCHITECT: ASPECT 120 LANDSCAPE ARCHITECTURE

EXISTING INFORMATION SHOWN HEREON PROVIDED BY TC MERRITTS LAND SURVEYORS DATED JUNE 2, 2021

GRAPHIC SCALE

(IN FEET)

1 inch = 10 ft.

PROPOSED DWELLING 253 JUDSON AVENUE VILLAGE OF DOBBS FERRY WESTCHESTER COUNTY - NEW YORK

PROJECT INFORMATION:
PROPERTY OWNER & APPLICANT:
MICHAEL MARFIONE

SURVEYOR: TC MERRITTS LAND SURVEYORS

41 CEDAR STREET APT 3 DOBBS FERRY, NY 10522

394 BEDFORD ROAD PLEASANTVILLE, NY 10570

470 CHAMBERLAIN AVENUE PATERSON, NJ 07522

90 NORTH BROADWAY SUITE 223 IRVINGTON, NY 10533

ARCHITECT:

EVANS ARCHITECTS




SITE PLAN


HUDSON


ENGINEERING CONSULTING, P.C.

45 Knollwood Road — Suite 201
Elmsford, New York 10523 T: 914-909-0420 F: 914-560-2086

Date: 06/10/21 Scale: 1" = 10'
Designed By: T.K.
Checked By: M.S.
Sheet No.

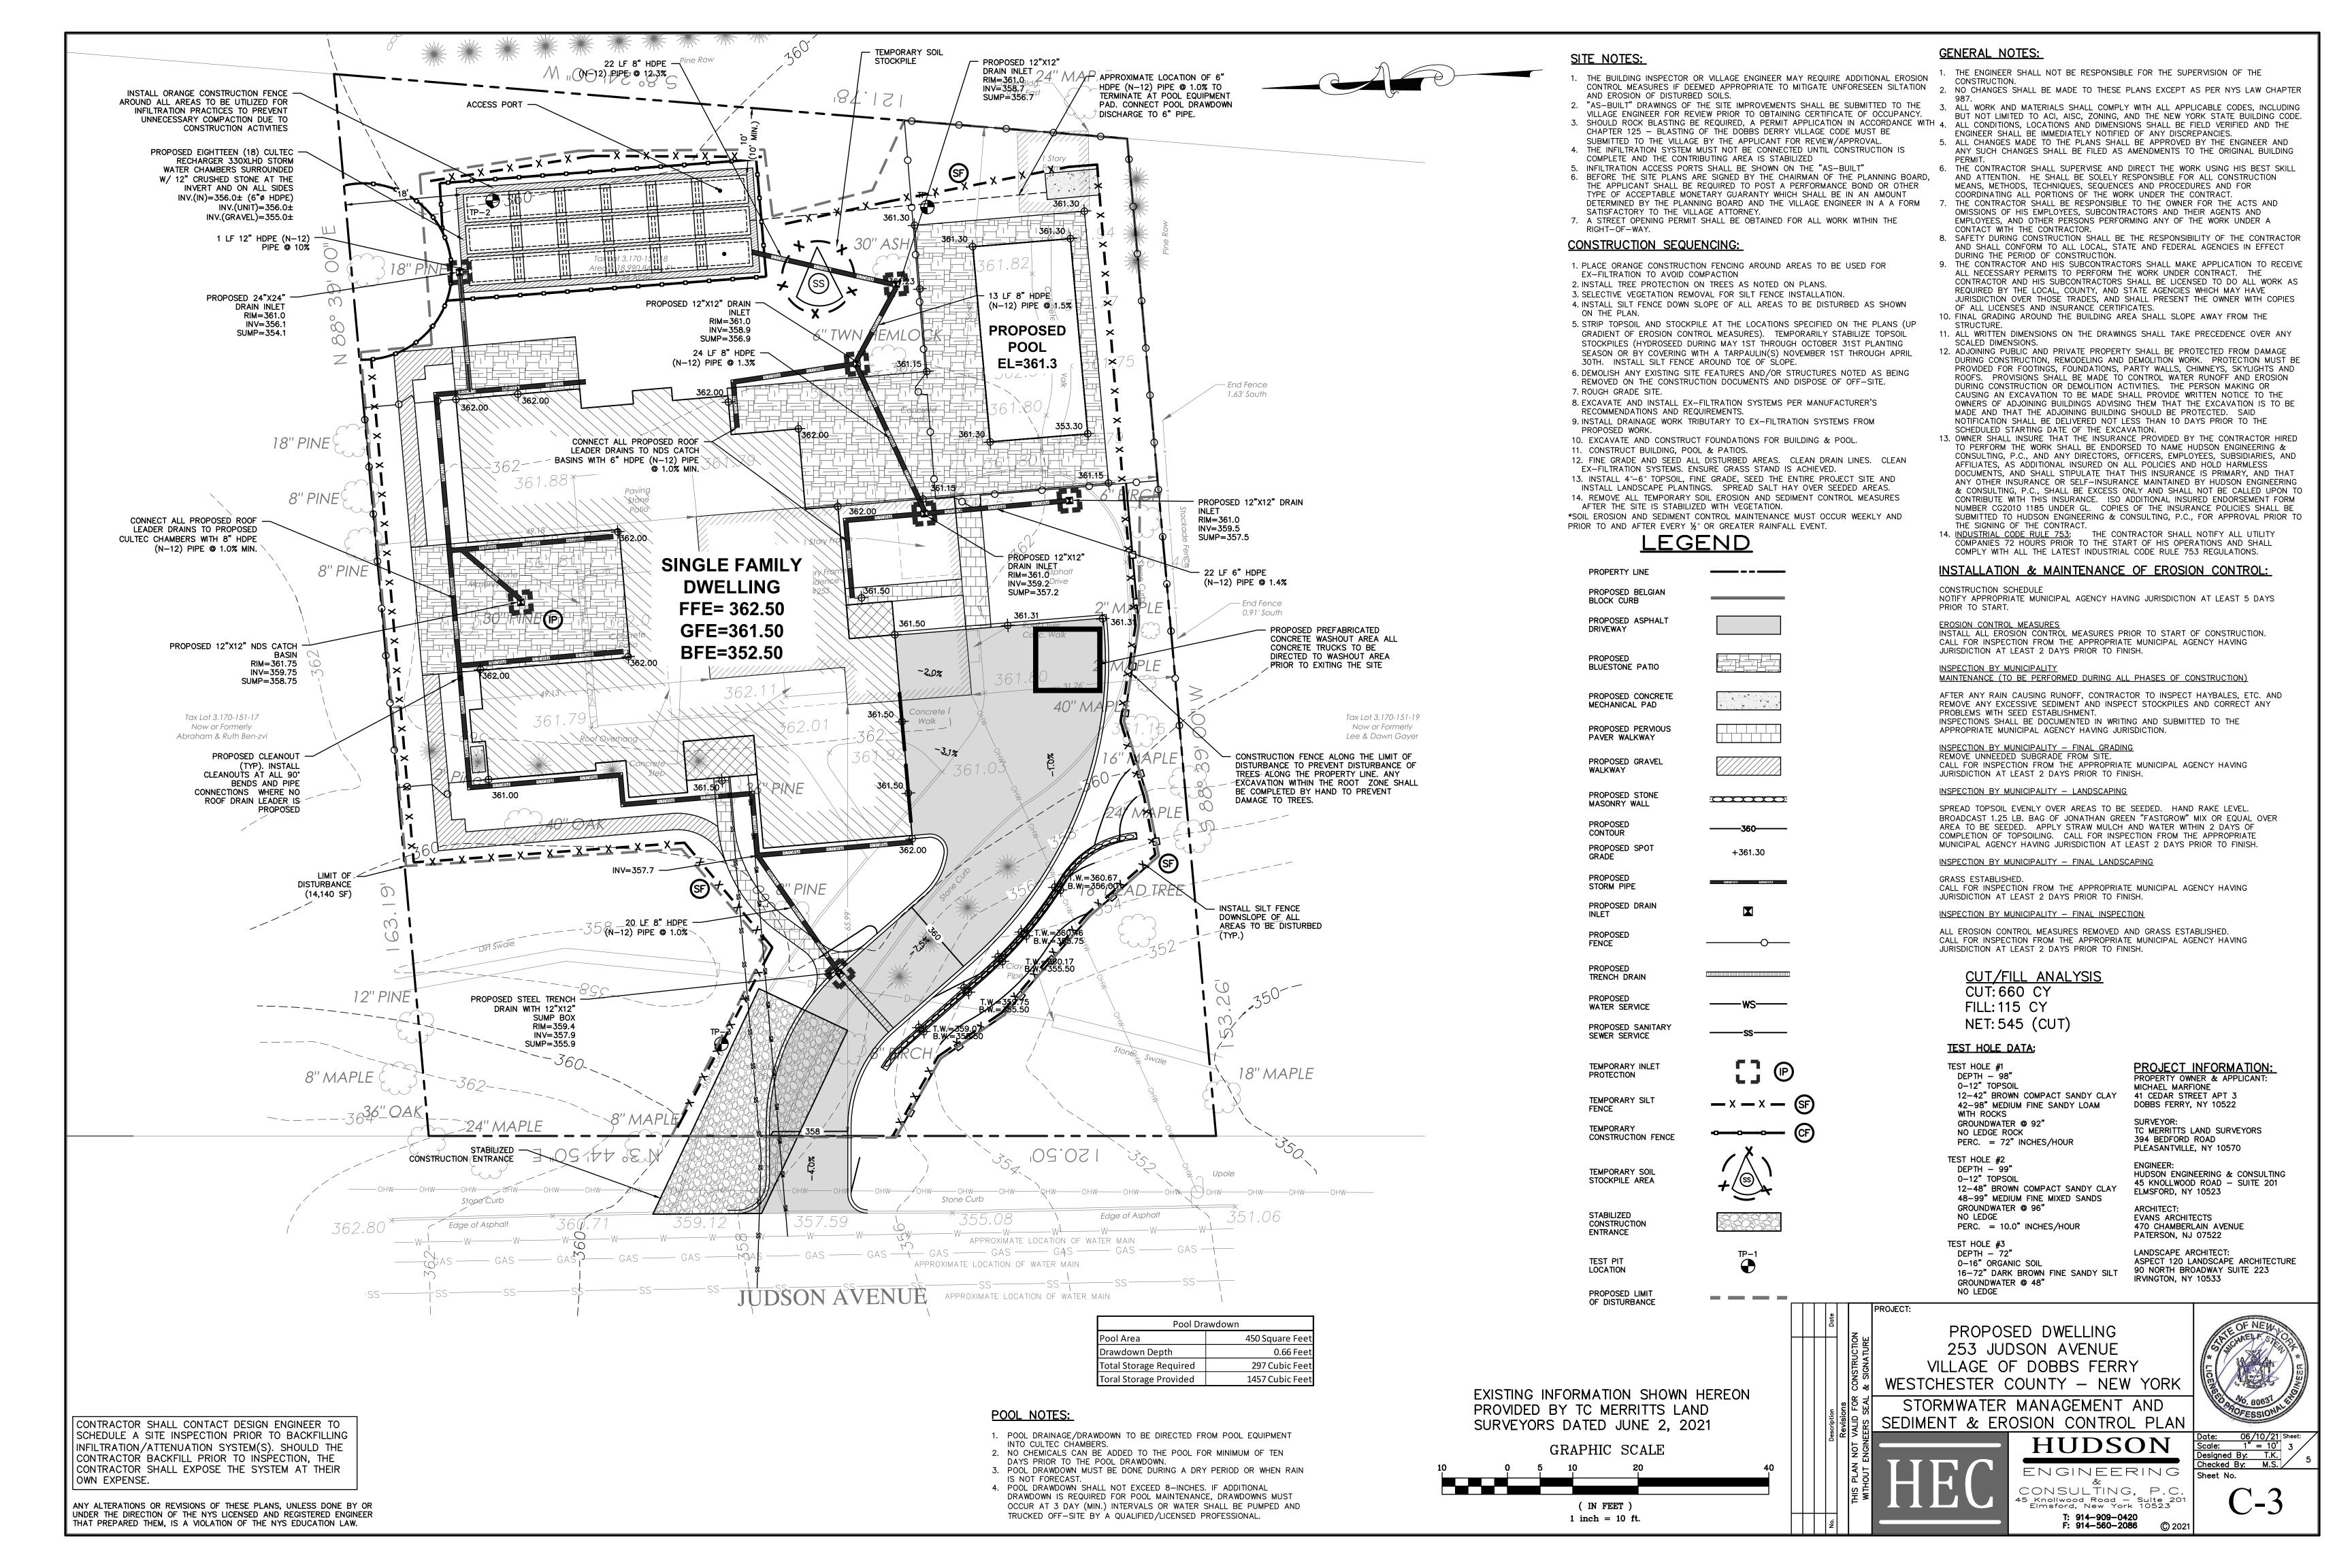

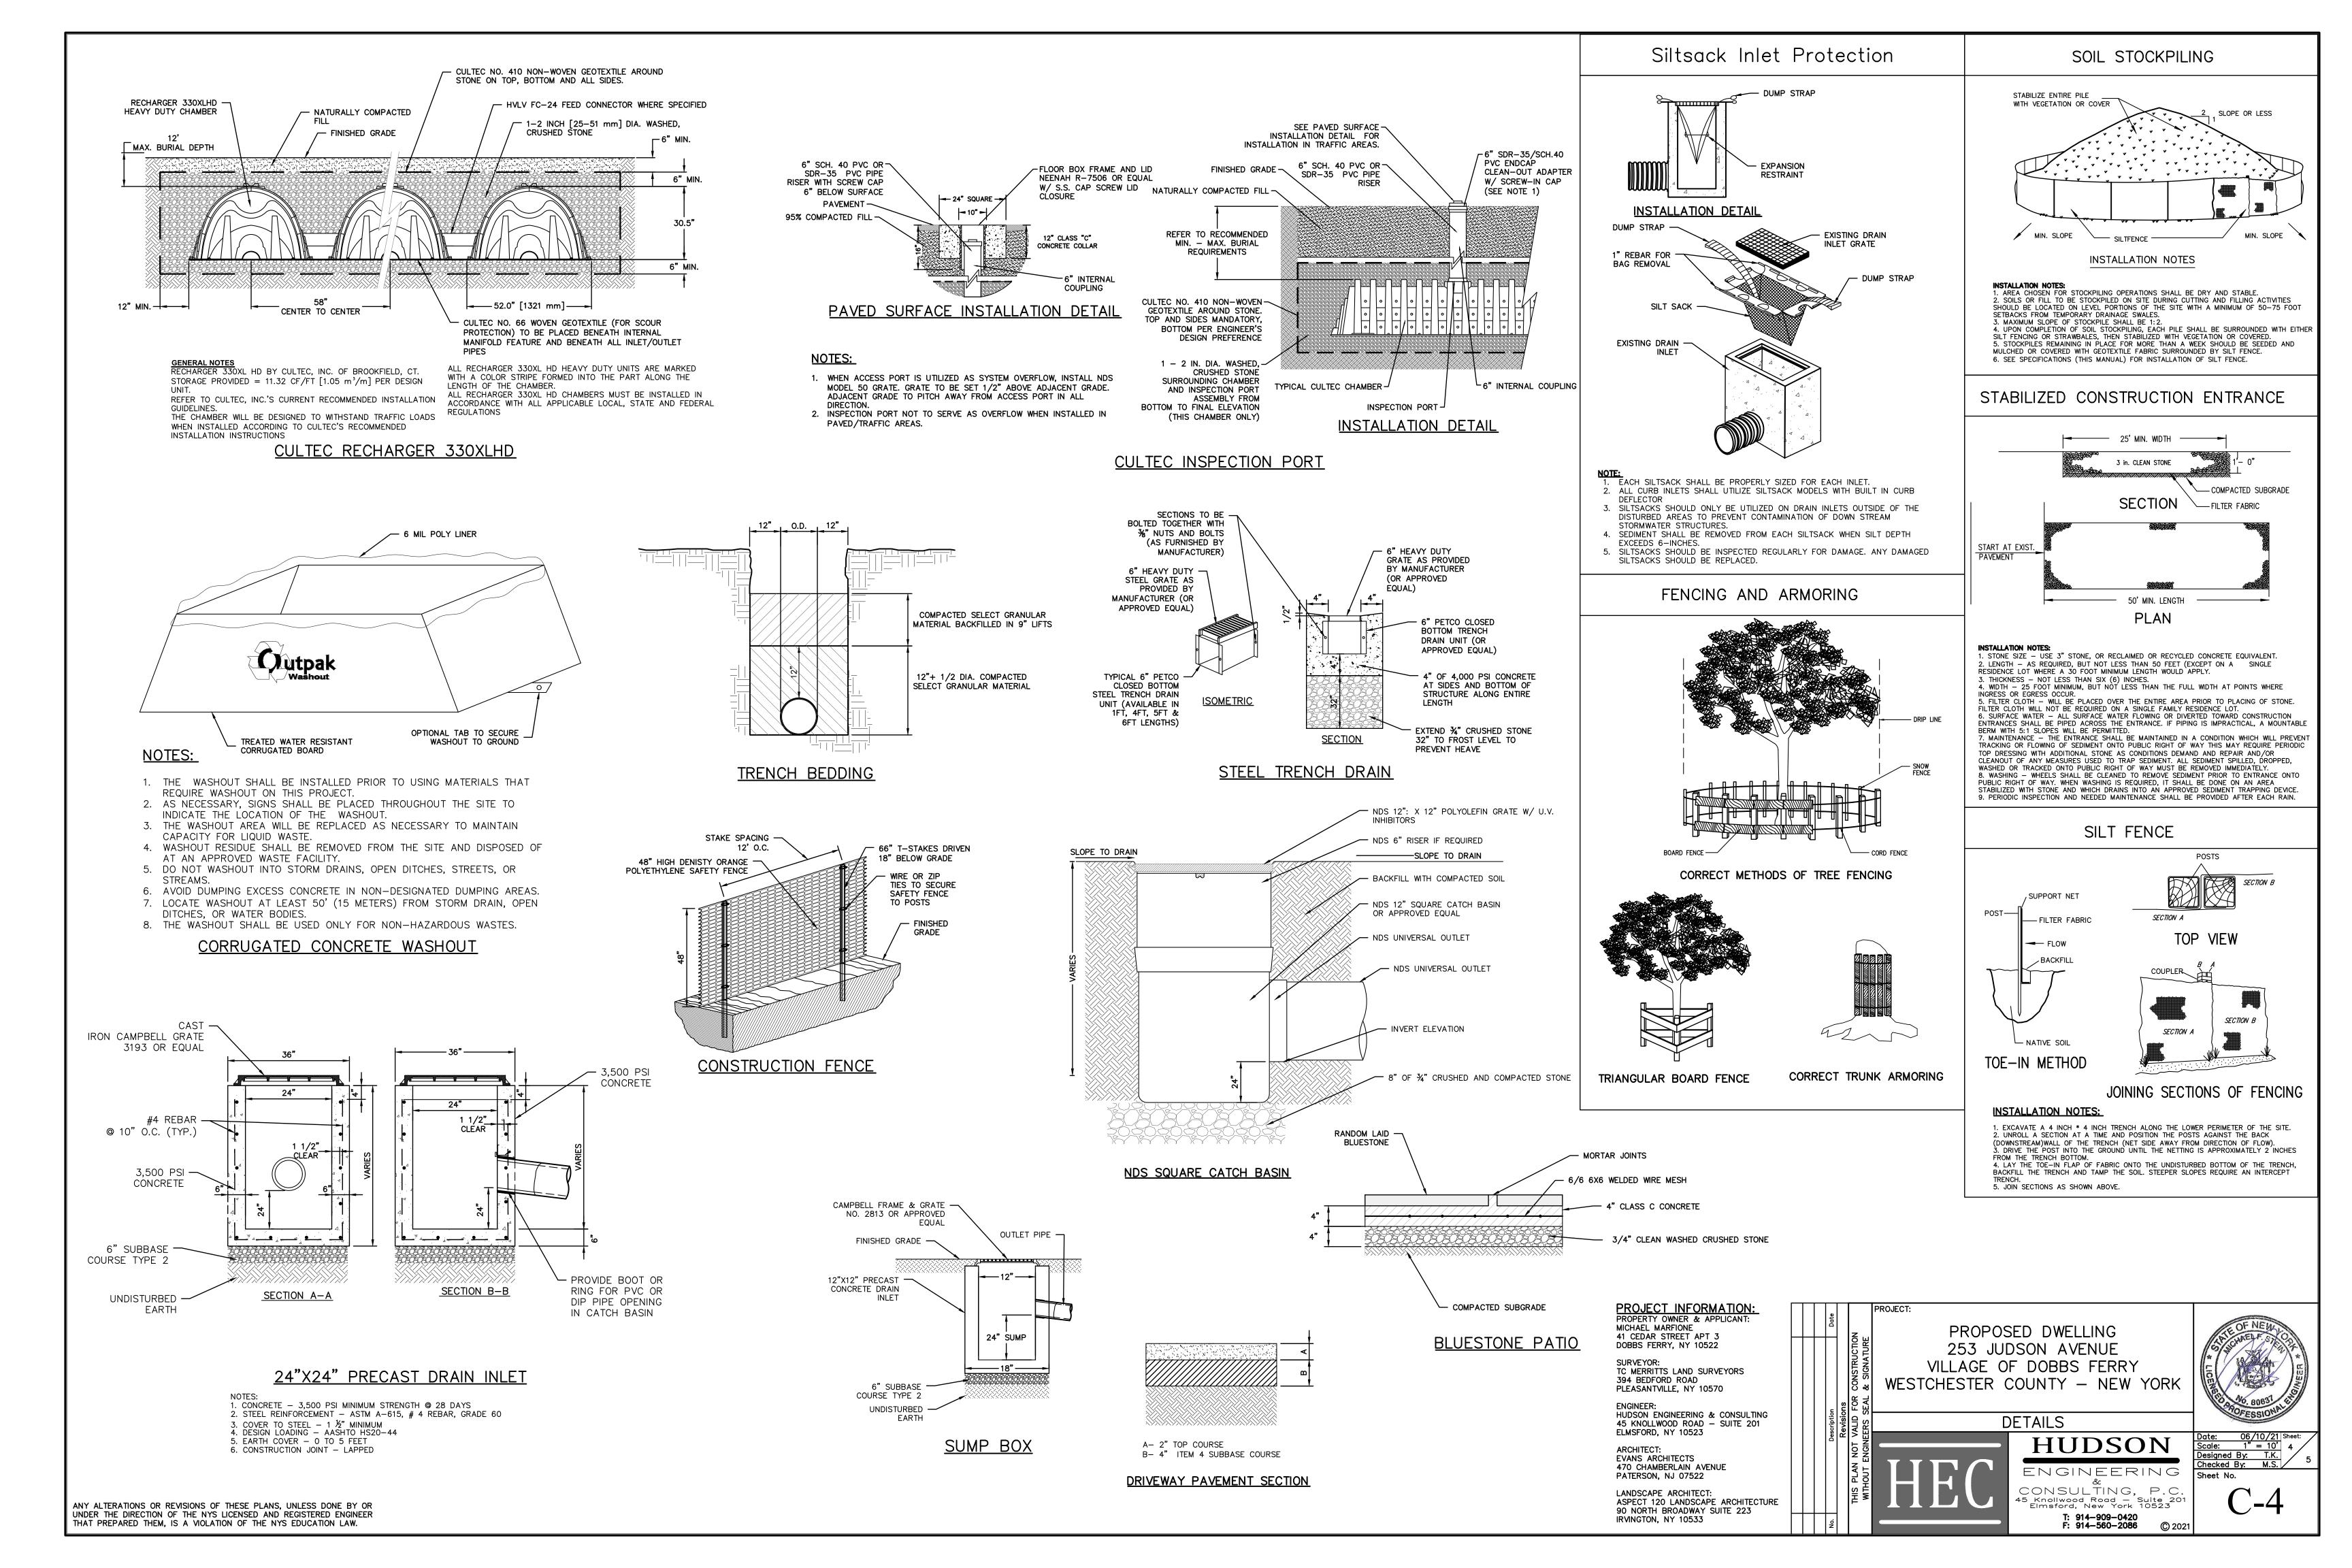

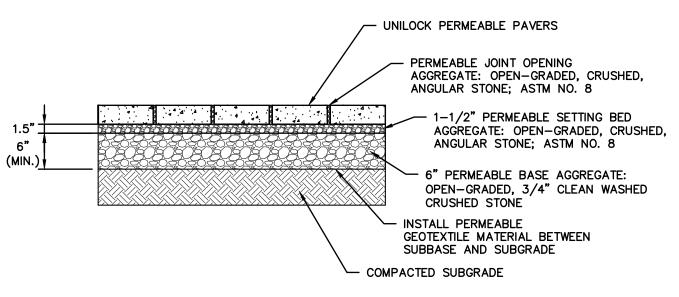

PERMEABLE PAVERS WALKWAY

PERMEABLE SURFACE NOTES:

- 1. STONE FOR INFILTRATION BEDS SHALL BE 3/4 INCH UNIFORMLY GRADED COARSE AGGREGATE WITH A WASH LOSS OF NO MORE THAN 0.5% IN ACCORDANCE WITH PROJECT SPECIFICATIONS, VOID SPACE SHALL BE 40% AS MEASURED BY ASTM-C29.
- 2. NONWOVEN GEOTEXTILE SHALL CONSIST OF NEEDLED NONWOVEN POLYPROPYLENE FIBERS AND MEET THE FOLLOWING PROPERTIES: 3. GRAD TENSILE STRENGTH (ASTM-D4632) >=120 LBS, MULLEN BURST STRENGTH (ASTM-D3786) >= 225 LBS, FLOW RATE (ASTM-D4491) >= 95GALLONS/MINUTE/SQUARE FOOT UV RESISTANCE AFTER 500 HRS (ASTM-D4355) >=70%. HEAT-SET OR HEAT-CALENDARED FABRICS ARE NOT PERMITTÉD. GEOTEXTILE FABRIC SHALL BE MIRAFI 140 N OR APPROVED
- 3. SURFACE SLOPE SHALL BE BETWEEN 1% (MINIMUM) AND 5% (MAXIMUM).
- 4. PERMEABLE PAVERS SHALL NOT BE INSTALLED ON WET SURFACES OR WHEN THE AMBIENT AIR TEMPERATURE IS 50 DEGREES FAHRENHEIT OR LOWER.
- 5. FILTER FABRIC AND STONE SHOULD BE KEPT CLEAN OF SOIL/SEDIMENT DURING THE INSTALLATION PROCESS. IF INSPECTION INDICATES THAT SOIL SEDIMENT HAS ENTERED ANY OF THE INFILTRATION SEEPAGE BEDS, APPROPRIATE MEASURES (i.e. CLEANING THE SOIL/SEDIMENT FROM THE FABRIC, STONE, ETC. AND OR REPLACEMENT OF THE FABRIC AND STONE) SHOULD BE ADDRESSED.
- 6. ALL STONE FOR THE CONSTRUCTION OF THE PERMEABLE PAVERS SHOULD BE UNIFORMLY GRADED AND CLEAN WASHED AGGREGRATE.
- 7. GEOTEXTILE AND BED AGGREGATE FOR PERVIOUS PAVERS SHOULD BE PLACED IMMEDIATELY AFTER APPROVAL OF SUBGRADE PREPARATION. ADJACENT STRIPS OF GEOTEXTILE SHOULD OVERLAP A MINIMUM OF 16 INCHES, AND SHOULD BE SECURED AT LEAST 4 FEET OUTSIDE OF BED TO PREVENT ANY RUNOFF OR SEDIMENT FROM ENTERING THE STORAGE BED. THIS EDGE STRIP SHOULD REMAIN IN PLACE UNTIL ALL BARE SOILS OR DISTURBED AREAS CONTIGIOUS TO THE BED ARE STABILIZED. AS THE SITE IS FULLY STABILIZED, EXCESS GEOTEXTILE ALONG BED EDGES CAN BE CUT BACK TO THE BED
- 8. PLANTED AREAS ADJACENT TO THE PERVIOUS PAVERS SHOULD BE MAINTAINED AND INSPECTED ON A SEMIANNUAL BASIS.

PERMEABLE PAVER MAINTENANCE PROCEDURES


GENERAL MAINTENANCE PROCEDURES:

PERMEABLE PAVER AREA SHOULD BE SWEPT/BLOWN CLEAN AS PART OF GENERAL LAWN/YARD MAINTENANCE SCHEDULE. AREA SHOULD REMAIN FREE OF CONTAMINANTS SUCH AS GRASS/HEDGE CLIPPINGS, MULCH, SOIL, ETC. TO ENSURE MAXIMUM PERMEABILITY.


PERMEABLE PAVER AREA SHALL BE TWICE A YEAR (EARLY SPRING & LATE FALL) TO MAINTAIN MAXIMUM INFILTRATION. IF PONDING IS OBSERVED, THE AREA SHALL BE VACUUMED AND JOINT AGGREGATE REPLACED TO THE LIP OF THE PAVER. PAVEMENT WASHING SYSTEMS OR COMPRESSED AIR UNITS ARE NOT RECOMMENDED FOR MAINTENANCE. IMMEDIATELY CLEAN ANY SOIL DEPOSITED ON THE SURFACE.

WINTER MAINTENANCE PROCEDURES:

ABRASIVES SUCH AS SAND OR CINDERS SHOULD NOT BE APPLIED ON OR ADJACENT TO THE PERVIOUS PAVERS. SNOW PLOWING IS ACCEPTABLE, PROVIDED IT IS DONE BY SETTING THE BLADE SLIGHTLY HIGHER THAN USUAL (APPROXIMATELY 1 INCH). SALT IS ACCEPTABLE FOR USE AS A DEICER ON THE PERVIOUS SURFACE, THOUGH NONTÓXIC, ORGANIC DEICERS APPLIED EITHER AS BLENDED MAGNESIUM CHLORIDE BASED LIQUID PRODUCTS, OR AS PRETREATED SALT ARE PREFERABLE.

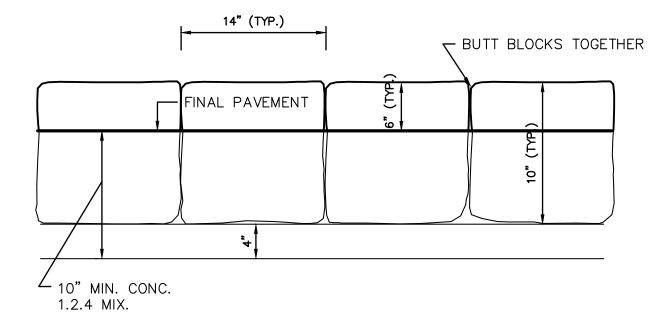


ELEVATION

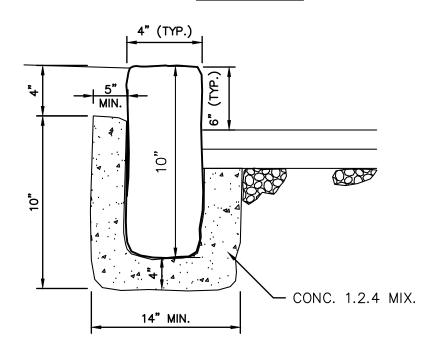

<u>SECTION</u>


BELGIUM BLOCK CURB DETAIL

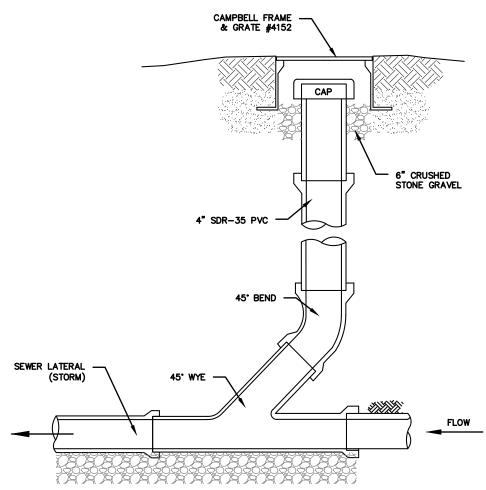

NOTES (STORM SEWER):


1. REFER TO PLAN FOR SPECIFIC PIPE SIZING AND SLOPE SPECIFICATIONS; HOWEVER, IN GENERAL, ALL STORM SEWER SERVICES TO BE 6"Ø SCH. 40 @ 1.0% MINIMUM. 2. CLEANOUTS SHALL BE PLACED BEFORE SIGNIFICANT PIPE BEND LOCATIONS (I.E., JUNCTIONS, 90-DEGREE BENDS, ETC.) UNLESS A ROOF LEADER DOWNSPOUT CONNECTION IS

SEWER CLEANOUT DETAIL (GRAVITY) (STORM)

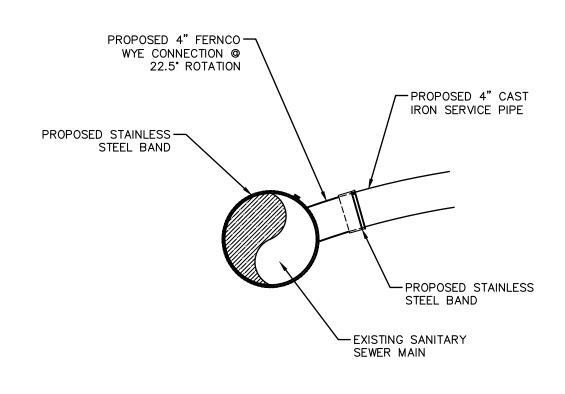


SEWER SADDLE CONNECTION

- 1. ALL HARDWARE SHALL BE STAINLESS STEEL
- 2. CONNECTION SHALL BE MADE IN ACCORDANCE WITH MANUFACTURER'S REQUIREMENTS AND INSTRUCTIONS.
- 3. CONNECTION ANGLE SHALL BE BETWEEN 22.5° AND 45°.

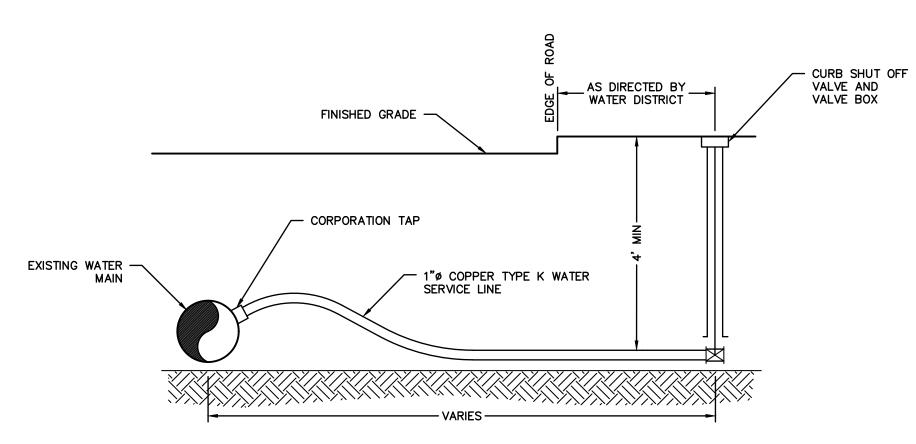

- 1. WATER DISTRICT TO FURNISH AND INSTALL CORPORATION TAP, SERVICE LINE, AND CURB SHUT OFF VALVE AND VALVE BOX.
- 2. CONTRACTOR TO EXCAVATE, MAINTAIN, BACKFILL, AND RESTORE TRENCH
- FOR THE TAP, SERVICE LINE, AND CURB SHUT OFF VALVE. 3. CONTRACTOR TO TAKE OUT PERMIT, PAY FEE, AND TO FOLLOW ALL RULES AND REGULATIONS OF THE LOCAL UTILITY AGENCY.

WATER SERVICE LATERAL

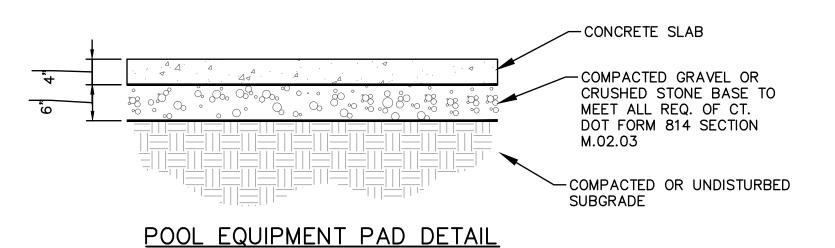


PROJECT INFORMATION: PROPERTY OWNER & APPLICANT MICHAEL MARFIONE 41 CEDAR STREET APT 3 DOBBS FERRY, NY 10522

TC MERRITTS LAND SURVEYORS 394 BEDFORD ROAD PLEASANTVILLE, NY 10570

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ARCHITECT: EVANS ARCHITECTS 470 CHAMBERLAIN AVENUE PATERSON, NJ 07522

LANDSCAPE ARCHITECT: ASPECT 120 LANDSCAPE ARCHITECTURE 90 NORTH BROADWAY SUITE 223 IRVINGTON, NY 10533

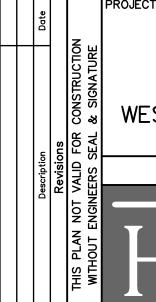

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DETAILS HUDSON

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Designed By: T.K Checked By:

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