RESIDENCES AT 11 LYMAN PLACE

D O B B S F E R R Y , N Y 1 0 5 2 2

CHRISTINAGRIFFINARCHITECT

12 Spring Street, Hastings-on-Hudson, NY 10706



GENERAL NOTES

- 1. These documents remain the exclusive property of the Architect, and may not be used for any purpose whatsoever without written consent of the Architect.
- 2. All construction shall comply fully with the 2020 Residential code of NYS, local building code, fire department regulations, and all other agencies having
- jurisdiction over project. 3. Approved stamped set of building plans must be present 14. All construction sites shall conform to the 2020 New on site for all inspections.
- 4. A current Westchester County licensed and insured contractor must be on file with current building permit until Certificate of Occupancy is issued. If contractor of record has been removed from the project, a stop work order will be issued untill a new Westchester County licensed and insured contractor is retained.
- 5. General Contractor shall carry property damage insurance, public liability insurance, workman's required by Federal, State, and Local Codes and as
- Owner requires.
- 6. Licensed electrician to file separate electrical permit. Licensed plumber to file separate plumbing permit.
- 8. All health, safety, fire, zoning and environmental regulations shall be adhered to at all times by the Owner and/or occupant.
- 9. The contractor shall become familiar with conditions of the site, and the work as shown on the construction documents, prior to submitting a bid for construction.
- 10. Contractors shall coordinate all work procedures and working hours with local authorities, neighborhood associations, and any other governing authorities.
- 11. The contractor shall be responsible for providing all labor and materials to complete the project, in accordance with the construction documents, tested and ready for owner's use.
- 12. All indicated Survey material is for general reference only. The Architect assumes no responsibility for the

- accuracy or the correctness of any of the indicated
- 13. Contractors shall be responsible for protection of all existing and new conditions and materials with and adjacent to the construction area. Any damage caused by the execution of the work indicated or implied herein
- York State Property Maintenance Code. All rubbish an onsite dumpster or removed off site immediately. Materials shall be stacked in orderly fashion as to not create a blight on the community. The village right of
- 15. General contractor shall be responsible for the removal of construction debris, rubbish and offsite disposal in a
- permits, and pay all necessary permit fees required by the local building department and all other agencies having jurisdiction over the project, such as plumbing, obtain the certificate of occupancy for the project when construction is complete.
- 17. Contractor shall keep work site free from debris and accumulated refuse, and shall have sole responsibility for protecting all dangerous areas from entry by
- 18. Drawings may be rough scaled for estimating and general purposes, but are not to be scaled for construction locations, dimensions, or any other purposes. Dimensions shown shall govern over Architect for questions regarding final dimensions and
- 19. All dimensions and conditions shown and assumed on the drawings must be verified at the site by contractor

- shall be repaired or replaced to the Owner's satisfaction.
- garbage and construction debris shall be disposed of in
- way must be kept clear and maintained at all times.
- compensation, auto insurance, and general liability as 16. The contractor shall obtain all inspections, approvals and shall be the duty of the contractor to notify the Architect. electrical & HVAC, except for the building permit, which shall be obtained by the Architect. The contractor shall
 - unauthorized parties.
 - measurements scaled from plans. Wall dimensions are given to finished surfaces. Contractor to consult with the
 - work area and other areas of the residence. In addition,

- before ordering any material or doing any work.
- 20. Contractor is to design and install adequate and code approved shoring and bracing where needed to safely sole responsibility for structural adequacy of the shoring and for any injuries, damages, cracks, or defects caused by shoring or bracing, and shall repair all such damage
- 21. The Architect is not responsible for workmanship, construction methods, or any omissions or derivations from the drawings during construction.
- 22.Materials and products indicated on drawings shall be installed in accordance with manufacturer's
- 23. The drawings and notes are intended to be complete. Should anything be omitted from the drawings necessary The builder shall visit the site and inform the Architect of any discrepancies of field conditions that may interfere with the total completion of all work included within the contract and verify all conditions prior to the ordering of
- materials and the start of construction. 24. Minor details not usually shown or specified, but necessary for proper and acceptable construction, installation or operation of any part of the work shall be included in the work the same as specified or indicated.
- 25. The contractor shall supervise and direct the work using his best skill and attention, he shall be solely responsible for all construction means, methods, sequences and procedures and for coordination of all portions of the
- connection with any item specified is intended to mean that such item be furnished and installed and connected

26. The use of the words "provide" or "provided" in

27. Contractor shall maintain a sealed enclosure between

- the contractor shall be responsible to (a) protect all interior spaces from the area of renovation, and (b)
- complete structural work. Contractor to assume full and 28. The contractor shall do all the cutting, fitting & patching that may be required to make several parts of the work come together properly, and to fit his work, and/or receive, or be received by the work of others, as shown, or as reasonably implied on the drawings.

broom sweep all areas at end of each work day.

- 29.New and existing work shall come together in a seamless fashion. All new or modified surfaces shall be finished including, but not limited to taping, spackling and
- 30. All insulation to comply with the Energy Efficiency Certificate required by 401.3 2020 Energy Conservation Construction Code of New York, prepared by the
- to the proper construction of the work herein described, it 31.If blown or sprayed insulation used, Installer of insulation to submit insulation certification to include the installed thickness of the area covered and R-value of the installed thickness shall be listed on the certificate. The insulation installer shall sign, data and post the certificate in a conspicuous location on the job site per N1101.5 of the 2020 Residential Code of New York State and submit an original signed copy for the Building
 - 32. All work shall be guaranteed for one year after final payment. The general contractor is to furnish written guarantees on his work and all subcontractors work against defects resulting from the use of inferior materials, equipment, or workmanship as determined solely by the Architect. All such defects are to be replaced or repaired, complete with labor and materials, 36.Finish materials and paint colors shall be reviewed and

Departments records.

33. Substitutions of equipment or materials other than those 37. The Architect assumes no responsibility for the accuracy 2020 Residential code of NYS. shown on the drawings or in the specifications shall be made only upon approval of the Architect or owner as noted on the drawings or in these specifications. The contractor shall submit his substitution for approval before releasing any order for fabrication and/or

shipments. The Architect reserves the right to disapprove such substitution, provided in his sole opinion, the item offered is not equal or detailed on the Amended by the NY Stretch Energy Code 2020 drawings, which requires any redesign of the structure, partitions, piping, redesign, and all new drawings and detailing required therefore shall, with the approval of the

Architect, be prepared by the contractor at his own

- 34. All work shall be installed so that all parts required are Floor readily accessible for inspection, operation, maintenance and repair. Minor deviations from the drawings may be
- made to accomplish this, but changes of magnitude shall Design Criteria: not be made without prior written approval from the
- completely cleaned and the site restored to existing condition, including but not limited to the following. Complete sweeping of all areas, and removal of all
- rubbish and debris, except that caused by the owner or others doing N.I.C. work. Removal of all labels from glass, fixtures, and equipment, etc. and spray cleaning of glass and
- c) Removal of stains, and paint from glass, hardware, finished flooring, cabinets, etc. d) Final cleaning of all chrome and aluminum metal
- e) Restoration of property by returning shrubs to original ceiling area, whichever is less. locations, filling of all ruts and raked topsoil and repairs to damaged blacktop.
- approved by the homeowner. or correctness of any material or drawings prepared by others and provided to the Architect.

Energy Notes R-Values & U-Factors 2020 Residential code of NYS

Amenaea by	The NY Stretch En	ergy Code 2020
Climate Zone	e 4A	
	Required	Proposed
Ceiling	R-49	R-49
Wall	R-21	R-21
Glazing	0.27 U value	0.27 U value
Floor	R-30	R-19

or R-19 per footnote (g)

- 5750 Degree Days
- 15% Maximum Glazing 35.Upon completion of the work, the entire project is to be R402.2.1 CEILINGS WITH ATTIC SPACES Installing R-38 over 100% of the ceiling area requiring insulation shall be deemed to satisfy the requirement for
 - R-49 insulation wherever the full height of uncompressed R-38 insulation extends over the wall top plate at eaves. R402.2.2 CEILINGS WITHOUT ATTIC SPACES Where Section R402.1.2 requires insulation R-values greater than R38 in the ceiling and the design of the roof/ceiling assembly does not allow sufficient space for the
 - required insulation, the minimum required insulation R-value for such roof/ceiling assemblies shall be R38. Insulation shall extend over the top of the wall plate to the outer edge of such plate and shall not be compressed. This reduction of insulation from the requirements of Section R402.1.2 shall be limited to 500 SF or 20% of the total insulated

I, Christina Griffin, Architect A.I.A., hereby states that I have prepared these plans and specifications to the best of my knowledge in compliance with all the requirements of the

INSULATION AND FENESTRATION REQUIREMENT BY COMPONENT TABLE R402.1.2 2020 NY ECC AMENDED BY NY STRETCH ENERGY CODE

	CLIMATE ZONE	FENESTRATION U-FACTOR ^h	SKYLIGHT U-FACTOR ^h	GLAZED FENESTRATION SHGC ^h	CEILING R-VALUE	WOOD FRAME WALL ^{b,c} R-VALUE
0	4A	0.27	0.50	0.40	49	21 or 20+5 or 13+10
		MASS WALL ^d R-VALUE	FLOOR R-VALUE	BASEMENT WALL ^e R-VALUE	SLAB ^f R-VALUE & DEPTH	CRAWL SPACE WALL ^e R-VALUE
_		15/20	30 ^g	15/19	10, 4FT (d)	15/19

- R-values are minimums. U-factors and SHGC are maximums. Where insulation is installed in a cavity that is less than the label or design thickness of the insulation, the installed R-value of the insulation shall be not less than the R-value
- Int. (intermediate framings) denotes standard framing 16 inches on center. Headers shall be insulated with a minimum of R-10 insulation.
- The first value is cavity insulation, the second value is continuous insulation. Therefore, as an example, "13+10" means R-13 cavity insulation plus R-10 continuous insulation. Mass walls shall be in accordance with Section R402.2.5. The second R-value applies when more than half the
- insulation is on the interior of the mass wall. 15/19 means R-15 continuous insulation on the interior or exterior of the home or R-19 cavity insulation at the interior of the basement wall. R-10 continuous insulation shall be provided under the full slab area of a heated slab in addition to the required slab
- edge insulation R-value for slabs as indicated in the table. The slab edge insulation for heated slabs shall not be required to extend below the slab Alternatively, insulation sufficient to fill the framing cavity and providing not less than an R-value of R-19. The fenestration U-factor column excludes skylights. The SHGC column applies to all glazed fenestration.

DESIGN REQUIREMENTS for the 2020 RESIDENTIAL CODE OF NEW YORK STATE CLIMATIC &

			G]	EOGI	RAPHI	C DES	SIGN	CRIT	ERIA			
		WIND D	DESIGN			SUBJECT	TO DAMAG	E FROM				
GROUND SNOW LOAD	SPEED	TOPO EFFECTS	WIND	WIND BORNE DEBRIS	SEISMIC DESIGN CATAGORY	WEATHERING	FROST LINE DEPTH	TERMITE	ICE SHIELD UNDERLAY REQUIRED	FLOOD HAZARDS	AIR FREEZING INDEX	MEAN ANNU TEMP

			Gl	EOGF	RAPHI	C DES	SIGN	CRIT	ERIA				
		WIND D	ESIGN			SUBJECT	TO DAMAG	E FROM					I
GROUND SNOW LOAD	SPEED	EFFECTS	WIND REGION	WIND BORNE DEBRIS ZONE	SEISMIC DESIGN CATAGORY	WEATHERING	FROST LINE DEPTH	TERMITE	ICE SHIELD UNDERLAY REQUIRED	FLOOD HAZARDS	AIR FREEZING INDEX	MEAN ANNUAL TEMP.	

DATES

BUILDING PERMIT SUBMISSION PLANNING BOARD SUBMISSION 9-14-23 PLANNING BOARD SUBMISSION PLANNING BOARD SUBMISSION 11-21-23


LIST of DRAWINGS

GENERAL NOTES,

SHEET	CLIMATIC & GEOGRAPHIC CRITERIA, DATES, LIST OF DRAWINGS
S-1	SITE PLAN, ZONING COMPLIANCE, LOCATION MAP, FLOOR AREA

- CALCULATIONS PHOTOS OF EXISTING CONDITIONS & NEIGHBORING PROPERTIES
- STREETVIEW OF PROPERTY & NEIGHBORING HOUSES
- EXTERIOR LIGHTING PLAN
- SKY EXPOSURE PLANE DIAGRAMS LANDSCAPING PLAN
- **EXTERIOR MATERIAL & COLOR SCHEME**
- N/A 2000 51.6



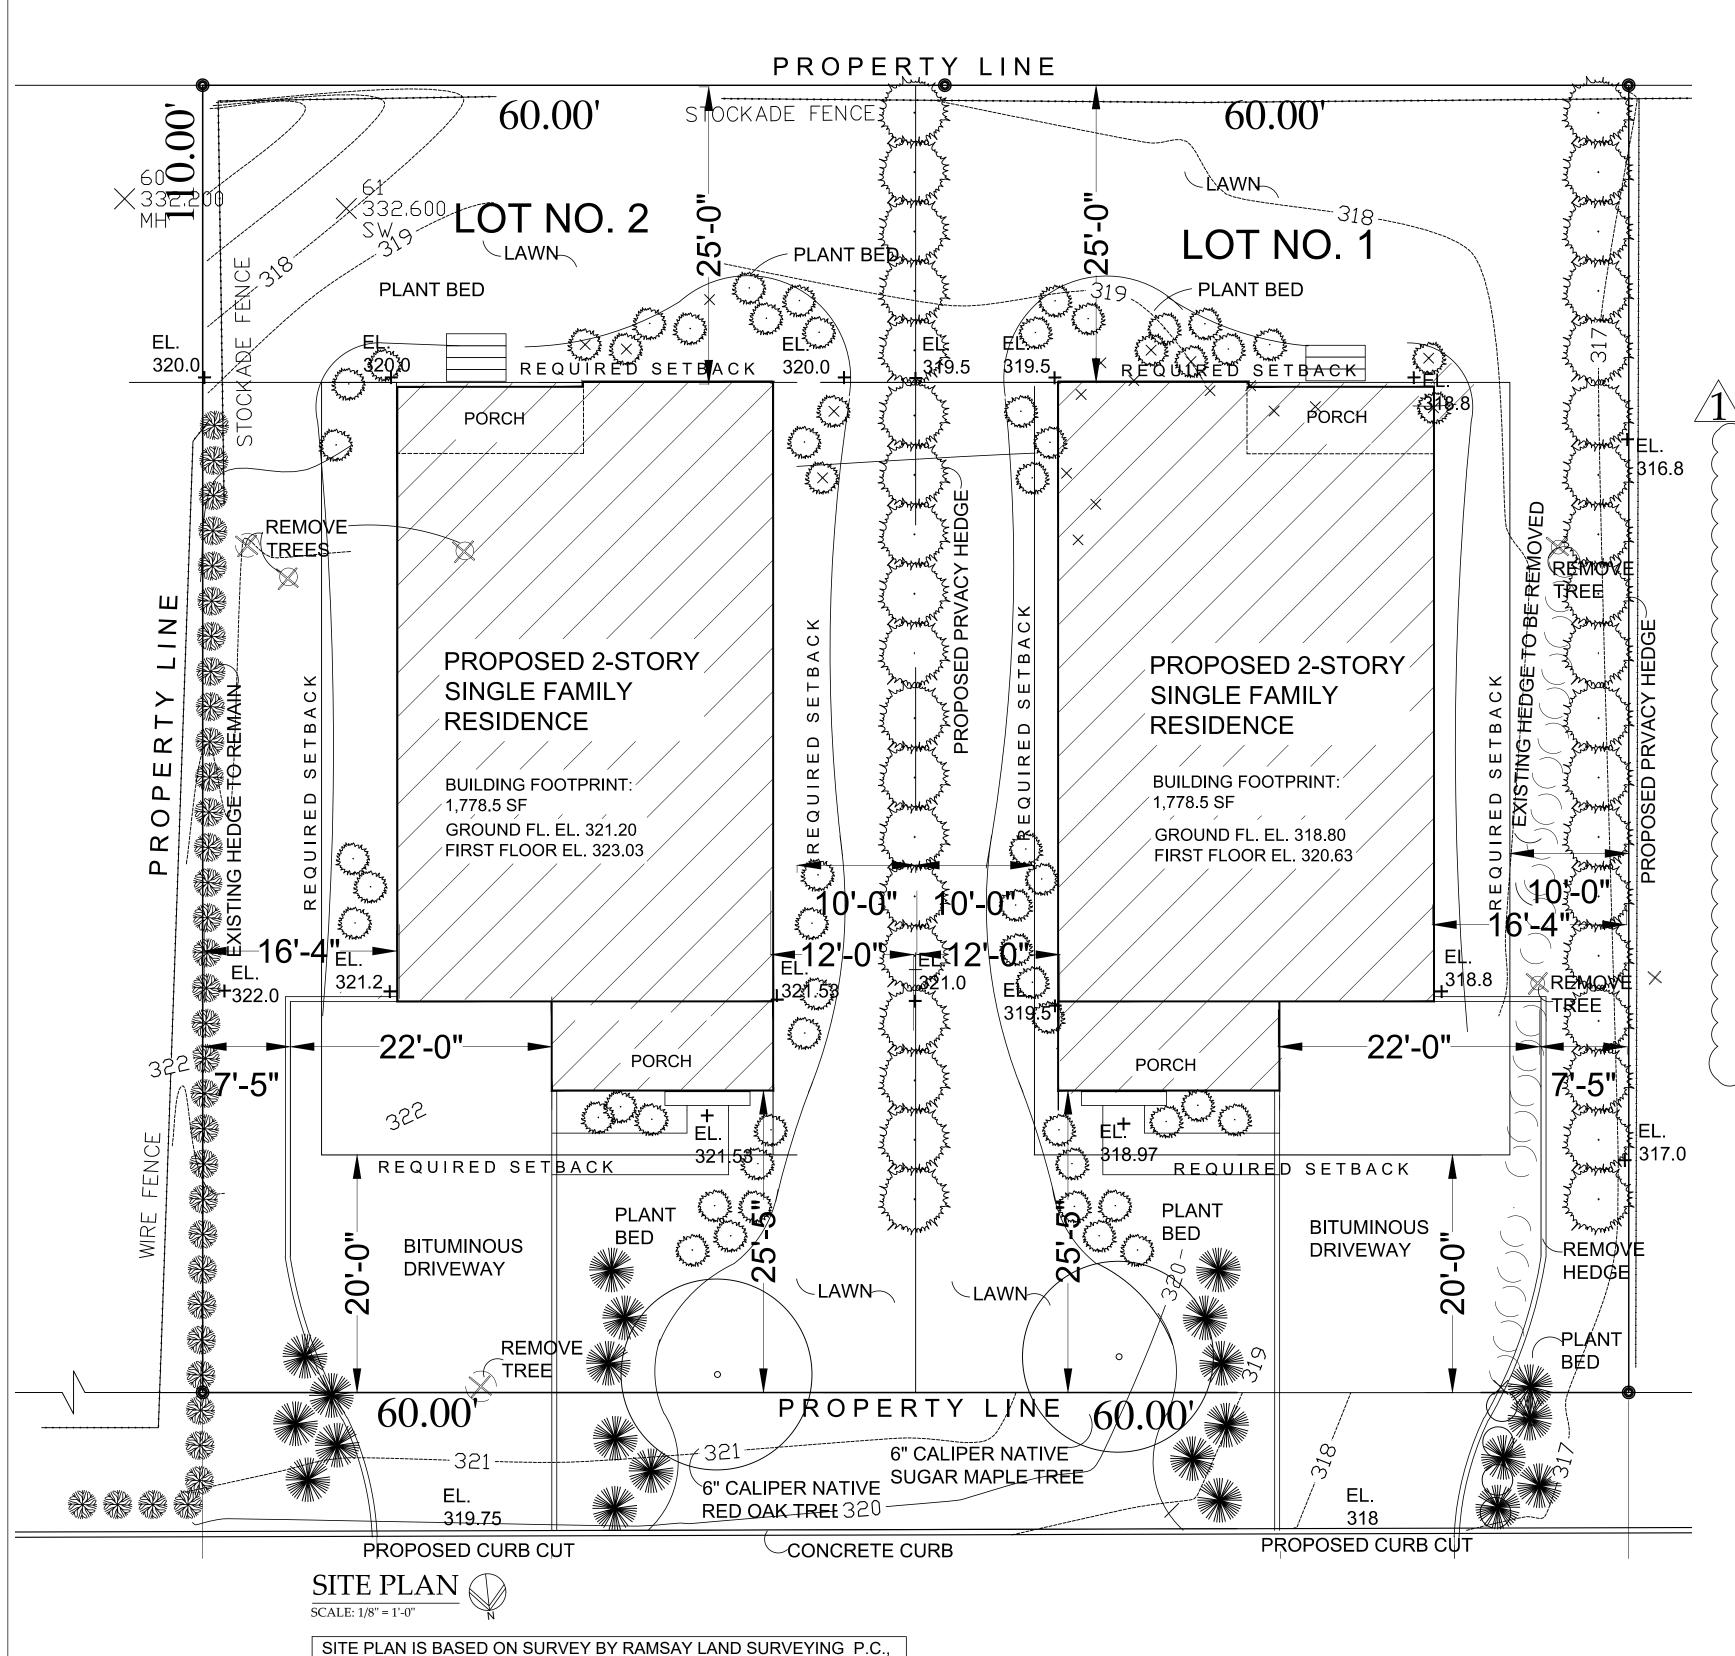

PROFESSIONAL LAND SURVEYORS - PLANNERS, MAY 21, 2021,


SEE CIVIL ENGINEERING DWGS FOR GRADING PLAN

DATA FOR ZONING COMPLIANCE

11 LYMAN PLACE, DOBBS FERF	RY, NY: TAX MAP: 3.60-22-3	& 3.60-22-4	ZC	NING DISTRICT: OF-6	
	REQUIRED	EXISTING	PROPOSED		
			LOT NO. 1	LOT NO. 2	
PRINCIPAL USE PERMITTED	ONE-FAMILY RESIDENCE	ONE-FAMILY RESIDENCE	ONE-FAMILY RESIDENCE	ONE-FAMILY RESIDENCE	
MIN. LOT SIZE	5,000 SF	6,600SF	6,600 SF	6,600 SF	
MIN. LOT WIDTH	50 FT	60 FT	60 FT	60 FT	
MIN. LOT DEPTH	100 FT	110 FT	110 FT	110 FT	
MAX. LOT COVERAGE (INCLUDES BUILDING, PORCH, GARAGE, SHED)	27% (OR 20% SLIDING SCALE) 27% x 6,600 SF = 1,782 SF		27% 1,781 SF	27% 1,781 SF	
MAX. IMPERVIOUS COVERAGE (INCL. PATIO)	54% (OR 40% SLIDING SCALE)		35%	36.5%	
MIN. FRONT YARD	20 FT		25.48 FT	25.48 FT	
MIN. REAR YARD	25 FT		25 FT	25 FT	
MIN. SIDE 1 YARD	10 FT		12 FT	12 FT	
MIN. SIDE 2 YARD	10 FT		16.3 FT	16.3 FT	
MIN. COMBINED SIDE YARDS	20 FT		28.3 FT	28.3 FT	
MAXIMUM RIDGE HEIGHT	35 FT FOR SLOPE > 0.30		33.31 FT / 0.75 ROOF SLOPE	34.187 FT / 0.75 ROOF SLOP	
MAXIMUM EAVE HEIGHT	28 FT DEFAULT		20.68 FT	21.56 FT	

FLOOR AREA C	CALCULATIONS	COVERAC	GE CALC	CULATION	ONS
LOT NO. 1	LOT NO. 2		REQUIRED	PROPO	OSED
FIRST FLOOR : 1,267 SF	FIRST FLOOR : 1,267 SF			LOT NO. 1	LOT NO. 2
SECOND FLOOR: 1,443 SF	SECOND FLOOR: 1,443 SF	LOT AREA	MIN. 5,000 SF	6,600 SF	6,600 SF
BASEMENT: UNFINISHED	BASEMENT: UNFINISHED	PRINCIPAL BUILDING	MAX. 27% X 6,600 SF= 1,782 SF	1,778.5 SF	1,778.5 SF
		FRONT PORCH	MAX. 75 SF	36 SF	36 SF
		WALKS & STONE STEPS		82.37 SF	87.37SF
		DRIVEWAY & CURBS		417.23 SF	512.32 SF
TOTAL FLOOR AREA: 2,710 SF T	OTAL FLOOR AREA: 2,710 SF	TOTAL IMPERVIOUS COVERAGE	54% OR 40% SLIDING SCALE	2,314.1 SF / 6.600 SF = 35%	2,414.19 SF / 6,600 SF = 36.5%

LOCATION MAP

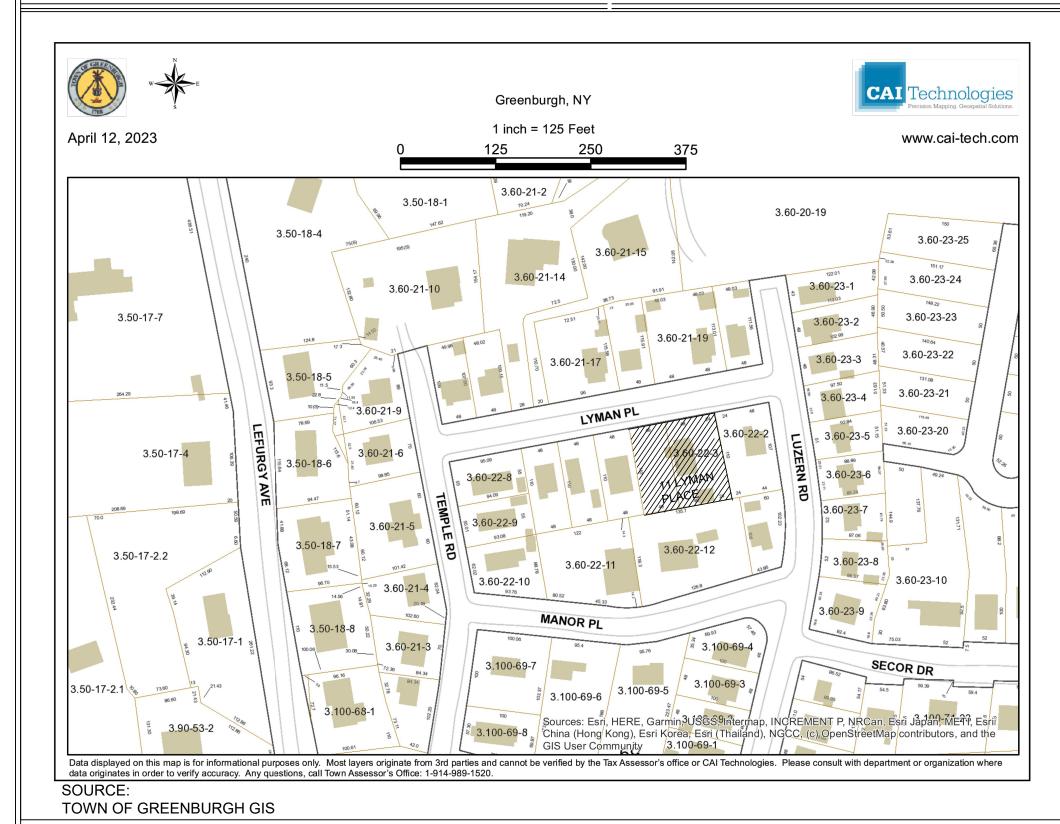



12 SPRING STREET HASTINGS.on.HUDSON N.Y. 10706 914.478.0799 cg@cgastudio.com christinagriffinarchitect.com

RESIDENCES AT 11 LYMAN PLACE DOBBS FERRY, NY 10522


Dates:

BUILDING PERMT SUBMISSION 7-7-23

BUILDING PERMT SUBMISSION 9-6-23

PLANNING BOARD SUBMISSION 9-14-23

PLANNING BOARD SUBMISSION 11-21-2

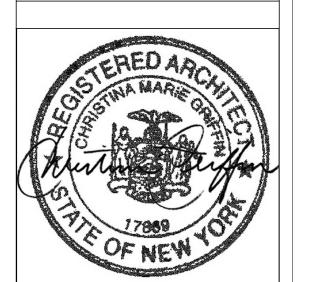


Drawing Title:
SITE PLAN
LOCATION MAP
ZONING DATA

Scale: As Shown

Sheet Number:

S-1

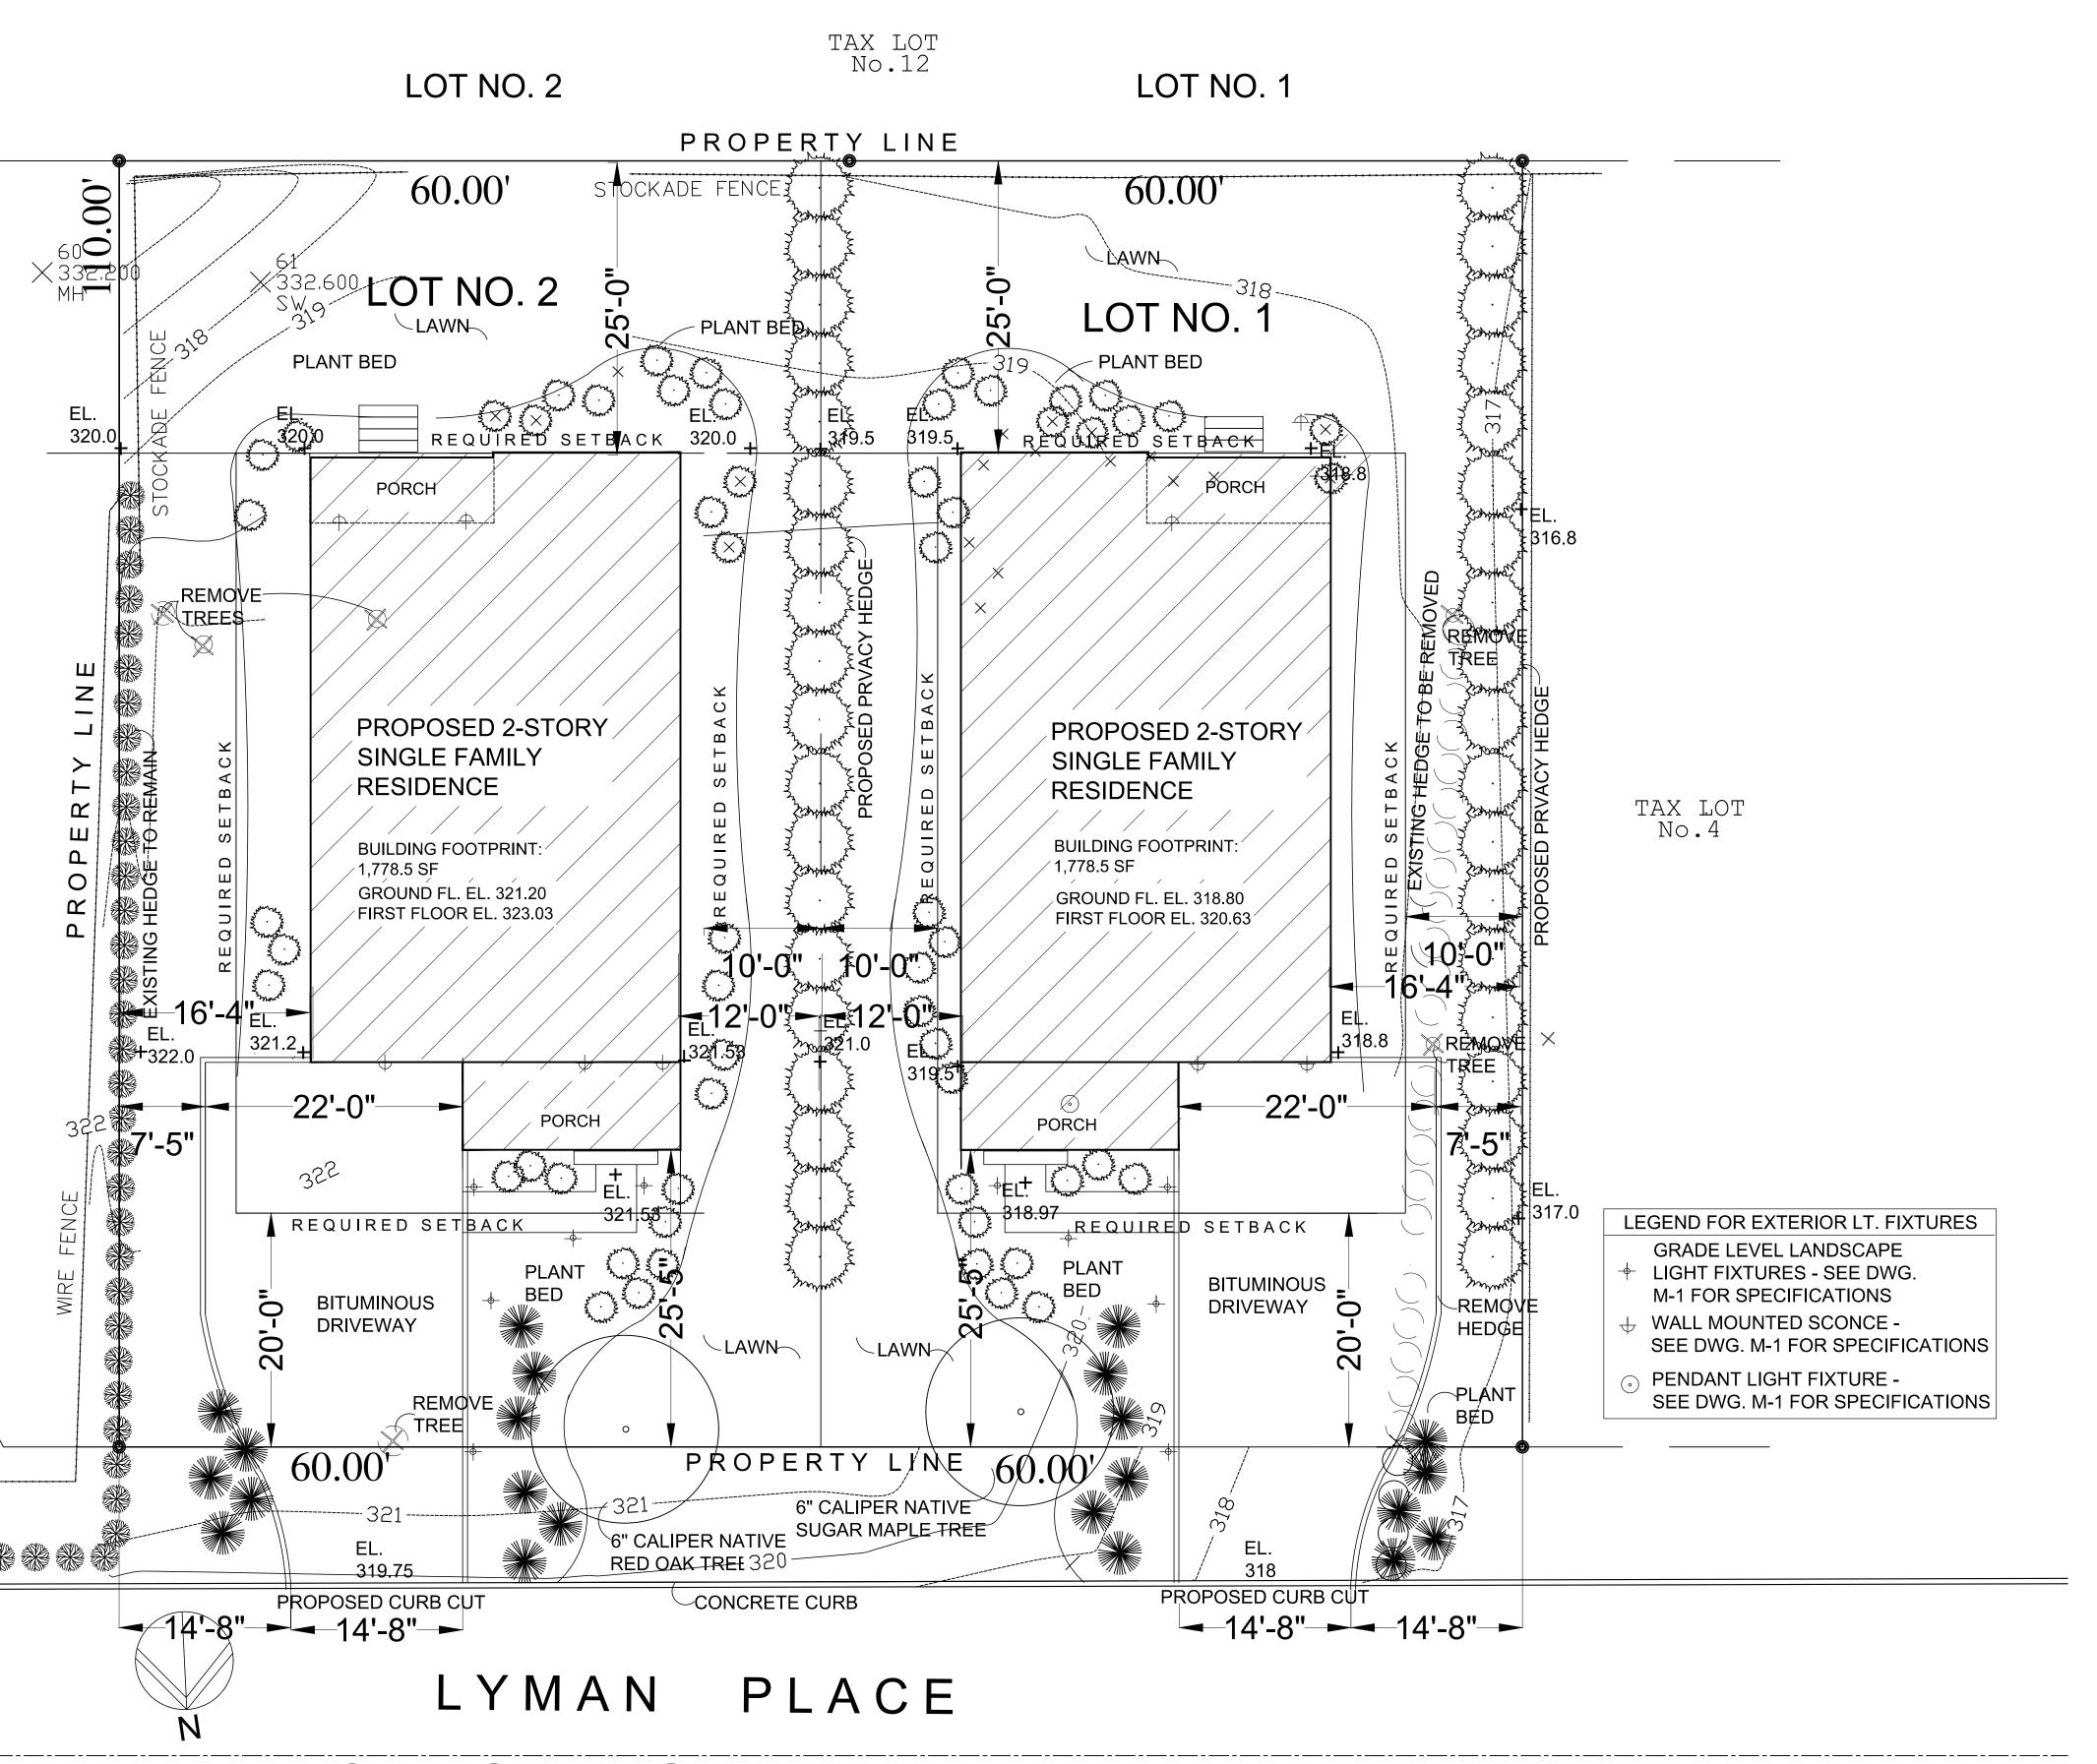

EXTERIOR LIGHTING PLAN

SCALE: 1/8" = 1'-0"

SITE PLAN IS BASED ON SURVEY BY RAMSAY LAND SURVEYING P.C., PROFESSIONAL LAND SURVEYORS - PLANNERS, MAY 21, 2021, SEE CIVIL ENGINEERING DWGS FOR GRADING PLAN



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RESIDENCES AT 1 LYMAN PLACE DOBBS FERRY, NY 10522

BUILDING PERMT SUBMISSION 7-7-23

PLANNING BOARD SUBMISSION 9-14-23
PLANNING BOARD SUBMISSION 11-21-2



Drawing Title:

EXTERIOR LIGHTING LAYOUT

Scale: As Shown

Sheet Number:

S-4





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RESIDENCES AT


11 LYMAN PLACE

DOBBS FERRY, NY 10522

Dates:

BUILDING PERMT SUBMISSION 7-7-23
BUILDING PERMT SUBMISSION 9-6-23
PLANNING BOARD SUBMISSION 9-14-23

PLANNING BOARD SUBMISSION 11-21-2:

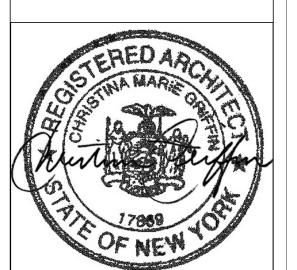


Drawing Title:
SKY EXPOSURE
PANE DIAGRAMS
ZONING DATA

Scale: As Shown

Sheet Number:

S-5

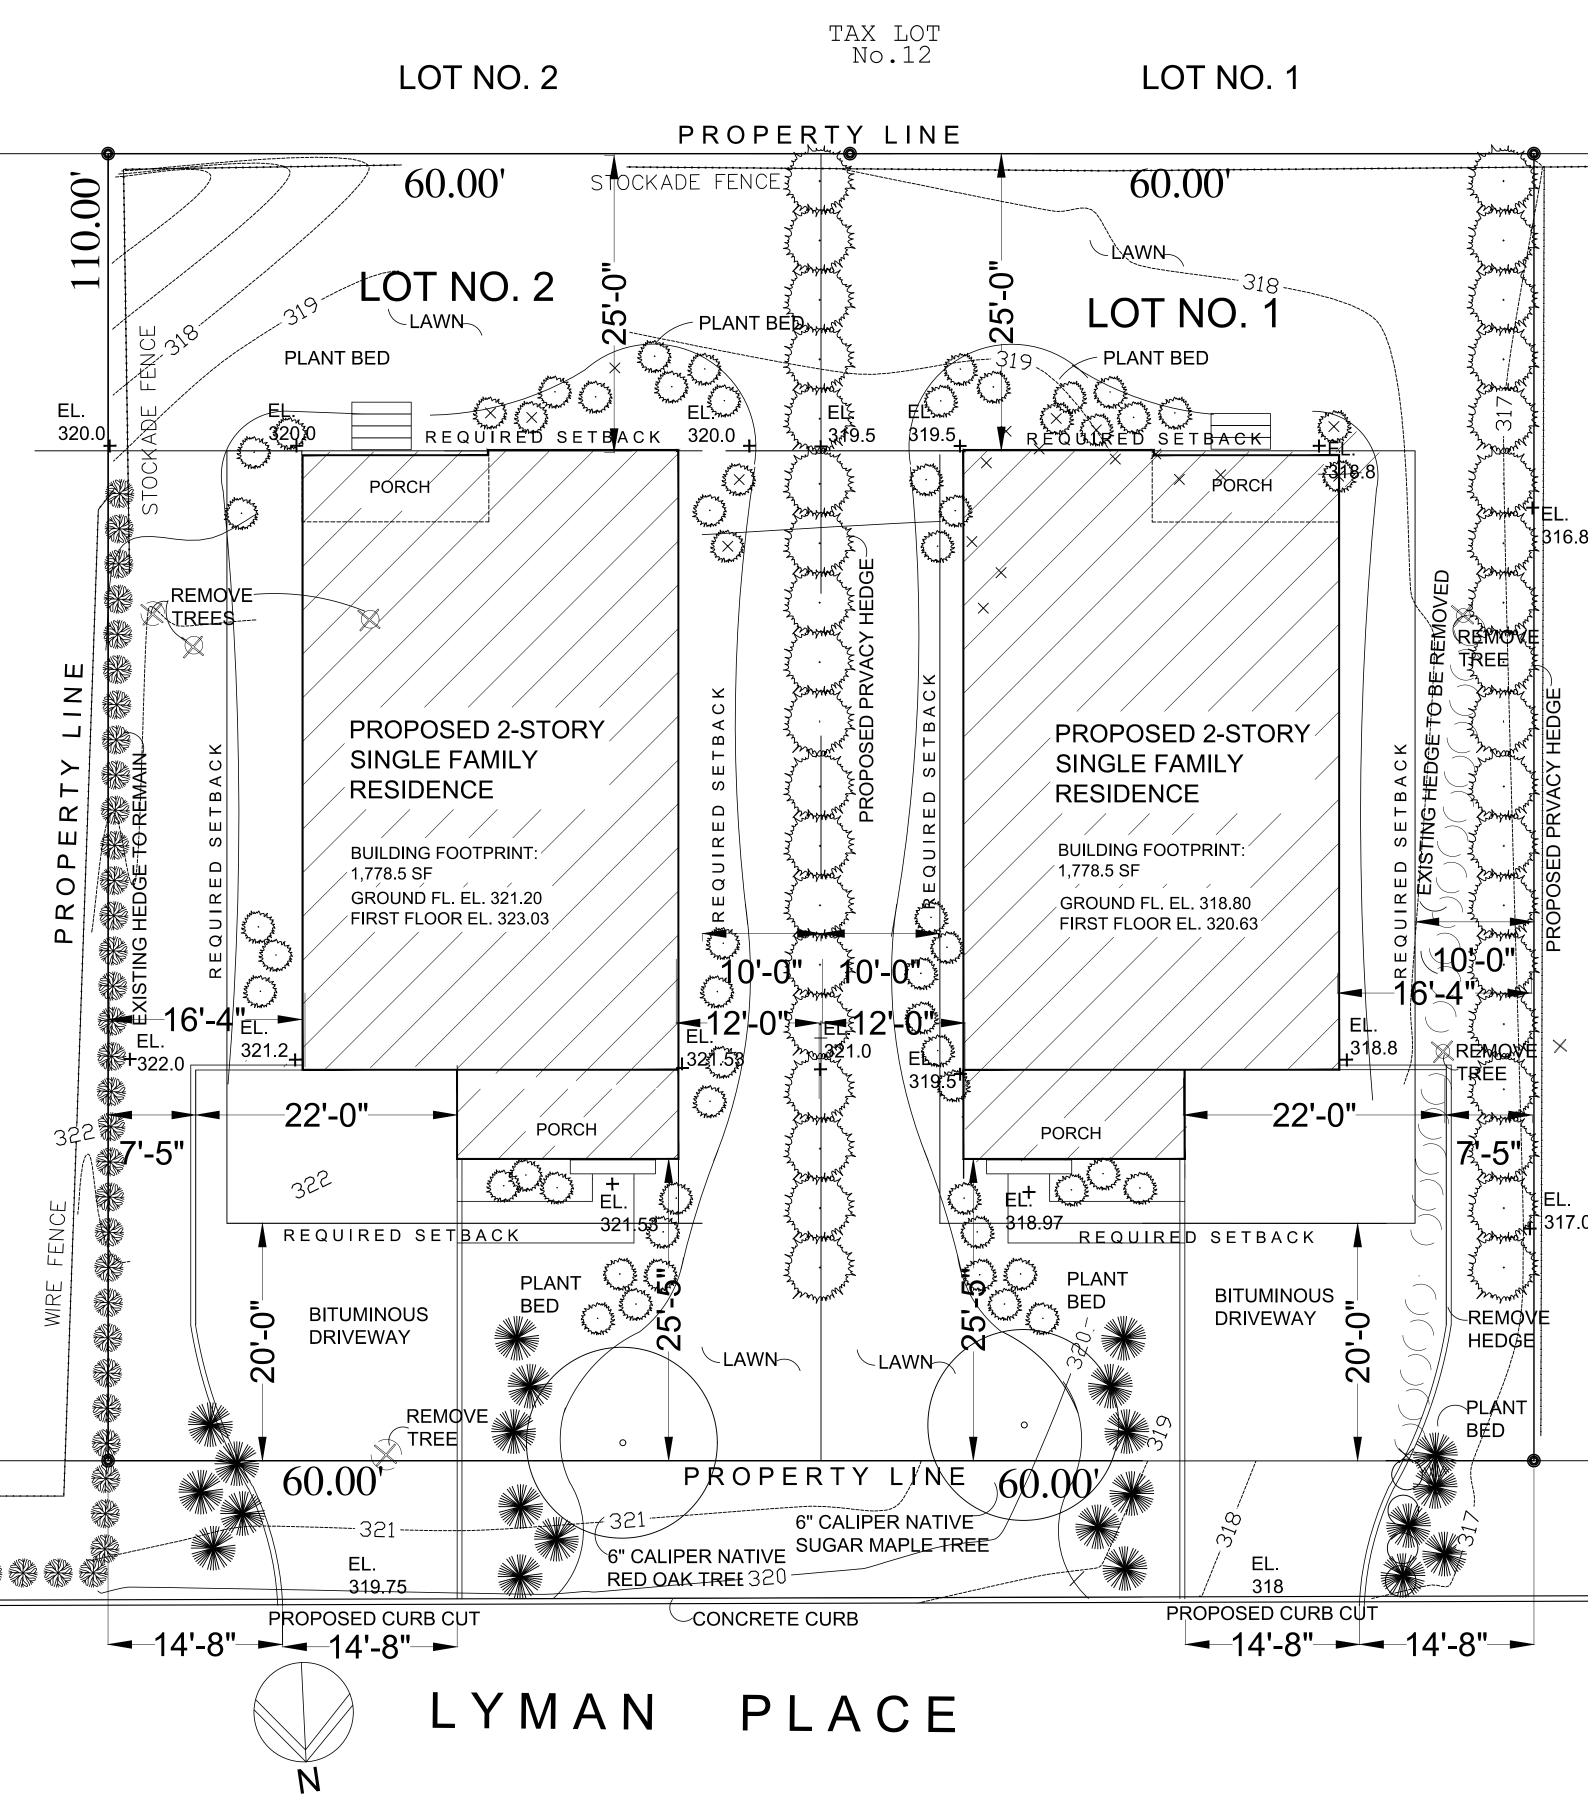


LANDSCAPING PLAN

SCALE: 1/8" = 1'-0"

SITE PLAN IS BASED ON SURVEY BY RAMSAY LAND SURVEYING P.C., PROFESSIONAL LAND SURVEYORS - PLANNERS, MAY 21, 2021, SEE CIVIL ENGINEERING DWGS FOR GRADING PLAN

ABBREVIATION	SCIENTIFIC NAME	COMMON NAME	SIZE (at planting)	QUANTIT
EVERGREEN TR	EES			
	ABIES BALSAMEA	BALSAM FIR	6'-8' HEIGHT	AS SHOV
	ILEX OPACA	AMERICAN HOLLY	6'-8' HEIGHT	AS SHOV
EVERGREEN SH	RUBS			•
	LITTLE GAINT ARBORVITAE	LITTLE GIANT	4'-0' HEIGHT	AS SHOW
	CAMELLIA JAPONICA 'KOREAN FIRE'	CAMELLIA 'KOREAN FIRE'		AS SHOW
	ILEX GLABRA	INKBERRY HOLLY		AS SHOW
	ILEX GLABRA 'COMPACTA'	COMPACT INKBERRY HOLLY		AS SHOW
	JUNIPER VIRGINIANA 'GREY OWL'	GREY OWL JUNIPER		AS SHOW
GROUNDCOVER	, FERNS, GRASSES & PERENNIALS	3		
	ADIANTUM PENDATUM	MAIDENHAIR FERN		AS SHOW
	ASARUM CANADENSE	WILD GINGER		AS SHOW
	ASTER DIVARICARTUS	WHITE WOODLAND ASTER		AS SHOW
	ATHYRIUM FILIZ-FEMINA	LADY FERN		AS SHOW
	CARAX PENSYLVANICA	PENNSYLVANIA SLEDGE		AS SHOW
ALL DISTURBED AR FESCUE AT NORMA 2. ALL PLANTS AND SI 3. ALL TREES AND SH 4. IF PLANT COUNTS I 5. ALL PLANTS TO BE	TO BE PREPARED WITH 4" MIIMUM OF SCREENED TO BE SEAS AREAS NOT TO LAWN, SHRUB BEDS TO BE SEAS AREAS NOT TO LAWN, SHRUB BEDS TO BE SEAS AREAS NOT TO LAWN, SHRUB BEDS SHALL RECEIVE 2" MINIMUM OF SHREE RUBS SHALL HAVE 12' TOPSOIL AROUND SIDES OF THE SETWEEN THE PLANT LIST AND THE PLANS TYPICAL OF THE SPECIES, HEALTHY, AND FREE OF NATIVE PLANTS TO BE REMOVED FROM THE SITE	EEDED WITH A MIX OF ANNUAL RYE AT 50 % DDED CEDAR MULCH. F ROOTS. ADD SOIL FOR DEPTH AS NECESS S,THOSE SHOWN GRAPHICALLY ON THE PLA F DISEASE AT THE TIME OF PLANTING AND	NORMAL BROADCAST RATE AND I BARY. ANS SHALL BE ASSUMED CORRECT	REDTOP

LEGEND

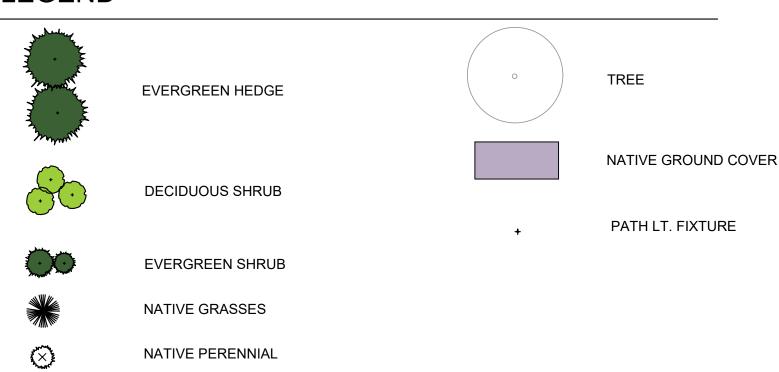

NOTES

- THE LANDSCAPE CONTRACTOR TO COORDINATE THIS WORK W/ OTHER CONTRACTORS PERFORMING WORK ON SITE. 2. THE CONTRACTOR SHALL LOCATE AND VERIFY ALL UNDERGROUND UTILITIES PRIOR TO ANY LAWN WORK OR TREE AND SHRUB PLANTING AND SHALL IMMEDIATELY REPORT ANY CONFLICTS TO THE PROJECT SITE ENGINEER.
- THE CONTRACTOR SHALL SUPPLY ALL PLANT MATERIAL IN QUANTITIES SUFFICIENT TO COMPLETE THE PLANTING SHOWN ON THE DRAWING. QUANTITIES IN PLANT SCHEDULE ARE FOR REFERENCE ONLY.
 NO PLANT OR CULTIVAR SUBSTITUTIONS WILL BE ACCEPTABLE WITHOUT APPROVAL OF THE LANDSCAPE ARCHITECT.
- OWNER'S LANDSCAPE ARCHITECT SHALL INSPECT PLANT MATERIAL FOR ACCEPTANCE PRIOR TO PLANTING. 6. LOCATION OF NEW PLANT MATERIAL SHALL BE STAKED OR SET OUT BY CONTRACTOR AND APPROVED BY OWNER'S LANDSCAPE ARCHITECT PRIOR TO PLANTING.
- REFER TO PLANTING DETAILS AND SPECIFICATIONS FOR INFORMATION RELATING TO PLANTING PIT DIMENSIONS AND
- EXTENT AND COMPOSITION OF BACKFILL MATERIAL 8. THE CONTRACTOR SHALL REMOVE ALL PLASTIC MATERIAL FROM AROUND THE ROOT BALLS OF THE PLANTS AFTER POSITIONING IN THE PLANT PITS. REMOVE BURLAP, ROPE, AND WIRE FROM AROUND THE TRUNK SUFFICIENTLY SO
- THAT NO BURLAP, ROPE OR WIRE WILL BE EXPOSED AFTER BACKFILLING. 9. CONTRACTOR SHALL EXERCISE EXTREME CARE IN WORKING IN AREA OF EXISTING TREES. EXISTING TREES TO REMAIN
- AND BE PROTECTED, WHICH ARE INJURED OR DESTROYED DURING CONSTRUCTION SHALL BE REPLACED BY CONTRACTOR WITH PLANTS OF EQUAL SIZE AND SPECIES AT NO COST TO THE OWNER.
- 10. ALL AREAS THAT HAVE BEEN DISTURBED BY PLANTING ACTIVITY SHALL BE RESTORED TO A NEAT CONDITION. AREAS WITH BARE SOIL SHALL BE TOPSOILED AND SEEDED WITH NATIVE EROSION CONTROL SEED MIX.
- 11. THE CONTRACTOR SHALL WATER TREES, SHRUBS AND GROUNDCOVER TWICE DURING THE FIRST 24 HOURS AND AS NEEDED DURING THE FIRST GROWING SEASON.
- 12. ALL NEW PLANTING SHOWN WITHIN OR NEAR THE DRIPLINE OF THE 32" SUGAR MAPLE SHALL BE LOCATED IN THE FIELD BY OWNER'S LANDSCAPE ARCHITECT OR ARBORIST AND INSTALLED UNDER THE DIRECT SUPERVISION OF OWNER'S LANDSCAPE ARCHITECT OR ARBORIST TO ENSURE PROTECTION OF EXISTING TREE ROOTS.



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BUILDING PERMT SUBMISSION 7-7-23


PLANNING BOARD SUBMISSION 9-14-23

PLANNING BOARD SUBMISSION 11-21-2

Drawing Title: LANDSCAPING PLAN

Scale: As Shown

Sheet Number:

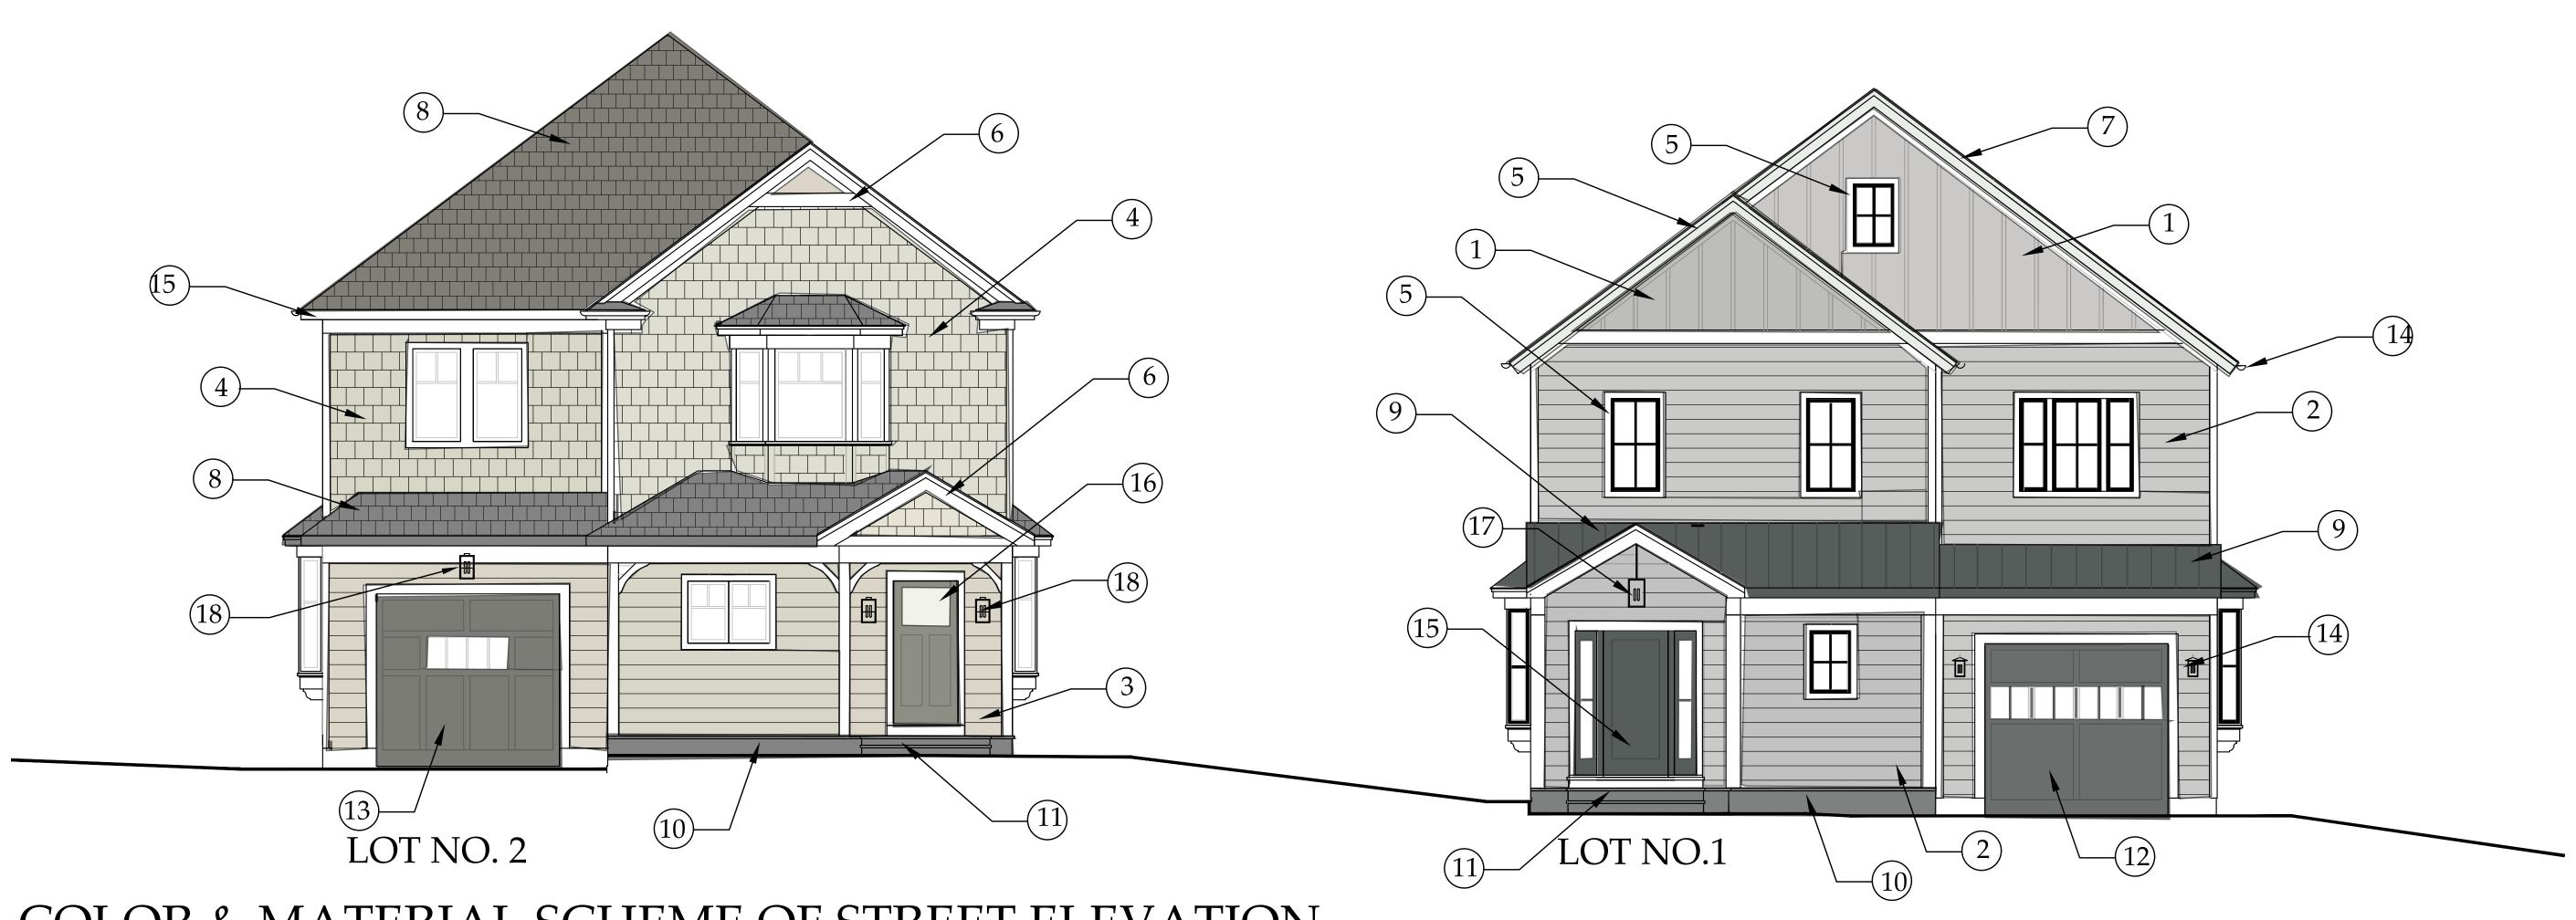


COLOR & MATERIAL SCHEME OF STREET ELEVATION

SCALE: 1/4" = 1'-0"



1.HARDIE PANEL VERTICAL CEMENTITIOUS SIDING, SMOOTH FINISH, SIDING, ARTIC WHITE AGED PEWTER

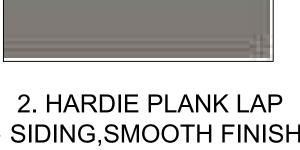

Aged

Pewter




3.HARDIE PANEL 4. HARDIE PLANK VERTICAL CEMENTITIOUS SHINGLE SIDING, SIDING, COBBLE STONE MONTEREY TAUPE

Taupe



5. AZEK TRIM PAINT FINISH, BEN. MOORE **PURE WHITE**

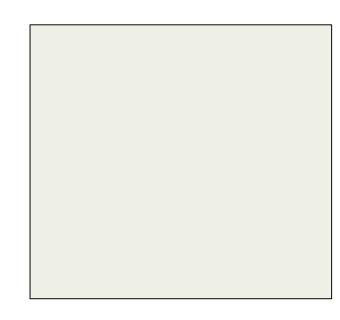


6. AZEK TRIM PAINT FINISH, BEN. MOORE **DOVE WHITE**

GUN METAL

BRICK RED

GREY

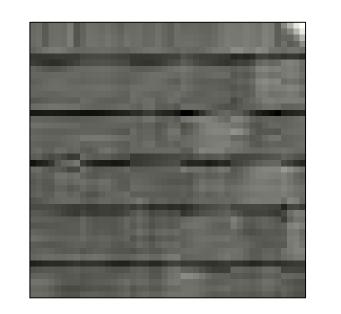

SHINGLES BY CERTANTEED, SHINGLES BY CERTANTEED, ROOFING WITH FACTORY LANDMARK SERIES, **GEORGETOWN GREY**



7. 30-YEAR ARCHITECTURAL 8. 30-YEAR ARCHITECTURAL 9. STANDING SEAM METAL LANDMARK SERIES, COLONIAL SLATE



PAINTED BLACK FINISH




10. 3-COAT CEMENT STUCCO AT STAIR RISERS, FINE FINISH, COLOR MATCH TO BEN. MOORE CHELSEA GRAY#CW-695



11. BLUESTONE AT STAIR 12.AZEK GARAGE DOOR 13.AZEK GARAGE DOOR TREADS, PORCH FLOOR PAINT FINISH. BEN. AND PATIO



MOORE DARK GREY

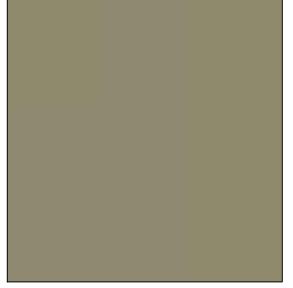

PAINT FINISH. BEN. MOORE ROUND GUTTER, **CLAY BEIGE**



14. ALUMINUM HALF-COLOR-MATCHED TO BEN. MOORE CHELSEA GRAY # CW-695



17. EXTERIOR PENDANT

PARKER FIXTURE



18. EXTERIOR WALL MTD. PARKER LT. FIXTURE




19. PATH LT. FIXTURE



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BUILDING PERMT SUBMISSION 7-7-23 PLANNING BOARD SUBMISSION 9-14-23 PLANNING BOARD SUBMISSION 9-20-23 PLANNING BOARD SUBMISSION 11-21-23

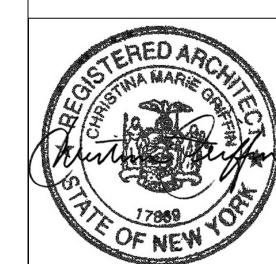

Drawing Title: **EXTERIOR** MATERIAL & COLOR SCHEME

Scale: As Shown

Sheet Number: