NEW LOT SUBDIVISION & NEW TWO-FAMILY RESIDENCE AT

107 PALISADE STEET

D O B B S F E R R Y , N Y 1 0 5 2 2

CGA STUDIO ARCHITECTS

12 SPRING STREET, HASTINGS.ON.HUDSON, NY 10706





PLANNING BOARD SUBMISSION 2-09-24

OWNER	ARCHITECT	CIVIL ENGINEER	DATES	LIST OF DRAWINGS	LIST OF DRAWINGS CONTINUED
MARIA THERESA LORENZ PROPERTY IN FAMILY OWNERSHIP SINCE 1982	CGA STUDIO CHRISTINA GRIFFIN AIA LEED AP CPHC 10 SPRING STREET HASTINGS-ON-HUDSON, NY 10706 914.478.0799 cg@cgastudio.com	HUDSON ENGINEERING & CONSULTING MICHAEL F. STEIN, P.E., PRESIDENT 45 KNOLLWOOD ROAD - SUITE 201 ELMSFORD, NEW YORK 10523 914.909.0420 michael@hudsonec.com	BUILDING DEPARTMENT SUBMISSION 06-30-23 ZONING BOARD SUBMISSION 07-19-23 PLANNING BOARD SUBMISSION 11-15-23 PLANNING BOARD PRESENTATION 12-07-23 PLANNING BOARD SUBMISSION 1-18-24 PLANNING BOARD PRESENTATION 2-01-24 PLANNING BOARD SUBMISSION 2-09-24	TITLE TITLE SHEET & LIST OF DRAWINGS S-0 AREA MAP, PHOTOS OF EXISTING CONDITIONS S-1 SITE PLAN, ZONING COMPLIANCE S-2 NEIGHBORHOOD CONTEXT A-1 FIRST FLOOR & BASEMENT PLANS A-2 SECOND, THIRD & ROOF PLANS A-3 ELEVATIONS	L-1 LANDSCAPE PLAN & EXTERIOR LIGHTING LAYOUT M-1 EXTERIOR MATERIAL & COLOR SCHEME SITE SURVEY CIVIL ENGINEERING DRAWINGS C-1 STORMWATER MANAGEMENT PLAN C-2 STORMWATER DETAILS C-2 STORMWATER DETAILS TR-1 TURNING RADIUS PLAN



- NEW EVERGREEN PLANTINGS FOR PRIVACY SCREENING PROPERTY LINE N 52°55'10" E

EXIST. WALK EXIST. PAVER PATIO 236 SF CURB AROUND 2 OUTDOOR Į PARKING SETBAÇK PARKING SPOTS EXISTING 54'-7" IE 54.6' 1-STORY EXIST. PAVER EXIST. TREES TO GARAGE PARKING SPOTS BE REMOVED. REFER TO .9-,9 PLANTING PLAN PARKING SPOTS REQUIRED BUILDING **IDENTIFYING** REPLACEMENT SETBACK PLANTINGS PARKING **BACKUP AREA** FOOTPRINT OF BUILDING IE 12.4' AT 3RD FLOOR - FOOTPRINT OF BUILDING III Z AT 2ND FLOOR EXIST. - STAIR UP TO COVERED 1-STORY DECK AT 2ND FLOOR TERRACE P E 37°(OZ DRIVEWAY PROPOSED BACKUP AREA PAVERS LOT A -58'<u>+</u>8" IE 58.7 **FOOTPRINT OF EXISTING BUILDING AT** 120.00' 2-STORY 2ND FLOOR FOOTPRINT OF BUILDING AT GROUND FLOOR/ GARAGE LEVEL RESIDENCE EXIST. TREE TO BE REMOVED. (3 x 1BR UNITS) PLANTING PLAN TO BE PROVIDED #107 PROPOSED **IDENTIFYING** REPLACEMENT LOT B **PLANTINGS** -58'-6" IE 58.5'-- NEW EGRESS LIGHTWELL FROM BASEMENT 1-STORY MECHANICAL SPACE **PROPOSED** NEW 7'-0" DEEP x EXIST. TERRACE 12'-5" 20'-0" WIDE ROOFED 3-STORY **ENTRY PORCH** TE 12.4' TWO-FAMILY 7'-0" INTO FRONT EXIST. STEPS RESIDENCE SETBACK PER EXIST. WALK **─**10'-0"**─** W/ 2-CAR GARAGE FIRST FL EL: 102 300-34.B.4.c. EXIST. PAVER WAIVER REQUIRED GARAGE EL: 100-99 FOR PORCH WIDTH DRIVEWAY 1,497 SF REQUIRED BUILDING NEW WALK EXIST. WALL -56'-1" PROPOSED LOT A WIDTH 50'-0" PROPOSED LOT B WIDTH

PALISADE STREET SITE PLAN SHOWING PROPOSED LOT SUBDIVISION SCALE: 1/8" = 1'-0"

106.05'

EXIST. WALK

EXIST. DROP

N 53°00'45" E



EXIST. WALK

NEW CURB CUT

PROPERTY LINE

ZONING CALCULATIONS

10	7 PALISADE STREET, DOBBS	FERRY NY 10522		
	ZONING DIS	STRICT:MDR-2; TAX [DESIGNATION: SECTION	N 3.80; BLOCK: 36, LOT: 17
	REQUIRED	EXISTING	PROPOSED LOT A (SOUTH)	PROPOSED LOT B (NORTH)
GROSS LOT AREA/NET LOT AREA (NO STEEP SLOPES	5,000 SF	12,735 SF	6,864 SF	(5,871 SF)
NUMBER OF DWELLING UNITS	N/A	3	3 x 1-BR UNITS	2 UNITS (2-BR & 3-BR)
MINIMUM LOT AREA PER DWELLING UNIT	800 SF	4,245 SF	2,288.3 SF	2,935 SF
PARKING REQUIREMENT	2 SPACES/DWELLING UNIT 6 SPACES FOR LOT A 4 SPACES FOR LOT B	6 4 OUTDOOR & 2 IN EXIST. GARAGE	6 4 OUTDOOR & 2 IN EXIST. GARAGE	4 2 OUTDOOR & 2 IN NEW GARAGE
OUTDOOR PARKING SETBACK TO PROPERTY LINE	10 FT MIN.	12.25 FT REAR 54.6 FT SIDE	12.25 FT REAR 6.1 FT* NORTH SIDE * VARIANCE RECEIVED 9/13/23	16.8 FT REAR 13.75 FT & 17.75 FT SIDE
BUILDING COVERAGE FOR LOTS UNDER 7,500 SF	40% [TABLE B-2 & B-3] 2,746 SF FOR LOT A 2,348 SF FOR LOT B	14% 1,807 SF	26% 1,807 SF	35% 2,060 SF
IMPERVIOUS COVERAGE FOR LOTS UNDER 7,500 SF	60% [TABLE B-2 & B-3] 4,119 SF FOR LOT A 3,522 SF FOR LOT B	41% 5,273 SF	77% * 5,255 SF *VARIANCE RECEIVED 9/13/23	59.6% 3,501 SF
MINIMUM LOT WIDTH [TABLES B-2]	50 FT [TABLE B-2]	106.05 FT	56.08 FT	50 FT
MINIMUM LOT DEPTH [TABLE B-2 & B-3]	100 FT	120 FT	120 FT	120 FT
FRONT YARD SETBACK [PREVAILING WITHIN 250 FT RADIUS - 10% OF 15FT PER TABLE B-2]	18 FT - (10% OF 15FT) = 16.5 FT	36.8 FT	36.8 FT	17.5 FT
REAR YARD SETBACK [TABLE B-2 & B-5; LOT DEPTH UNDER 125 FT]	25 FT [TABLES B-2 & B-5]	39.08 FT	39.08 FT	25 FT
SIDE SETBACK [TABLE B-4; LOT WIDTH UNDER 75 FT]	10 FT	12.4 FT	12.4 FT	10 FT
SIDE SETBACK [TABLE B-4; LOT WIDTH UNDER 75 FT]	10 FT	58.5 FT	10 FT	10 FT
TOTAL OF TWO SIDE SETBACKS [TABLE B-2 & B-4; LOT WIDTH UNDER 75 FT]	20 FT	70.9 FT	22.4 FT	20 FT
MAXIMUM STORIES (5FT SETBACK RQD @ 3RD STOR)	3 STORIES MAX.	2	2	3
MAXIMUM HEIGHT TO EAVE	N/A	EXIST.	EXIST.	
MAXIMUM BUILDING HGT TO MIDPOINT OF ROOF [TABLE B-6; 0.5 ROOF PITCH]	42 FT	EXIST.	EXIST.	33 FT 41 FT TO BULKHEAD ROOF
BULKHEAD SQUARE FOOTAGE	MAX. 20% (ROOF AREA) = (20%) X 1,900 = 380 SF	N/A	N/A	72 SF

^{*} ZONING VARIANCE RECEIVED 9/13/23

SITE PLAN BASED ON SURVEY BY SUMMIT LAND SURVEYING P.C. SURVEY DATE: 11/26/2022; REVISED 6/27/2023

COVERAGE CALCULATIONS

) I 10				
	REQUIRED	EXISTING	PROPOSED LOT A (SOUTH)	PROPOSED LOT B (NORTH)	
_OT AREA	5,000 SF	12,735 SF	6,864 SF	5,871 SF	
BUILDING & LOT A PORCHES	N/A	1,322 SF	1,322 SF	1,995 SF	
OT B FRONT PORCH 20 FT ** X 7 FT = 144 SF; 75 SF OF WHICH NOT COUNTED PER 300-34B4)				65 SF	** PLANNING BOARD WAIVER REQUESTED FOR WIDTH OF FRONT PORCH EXCEEDING ½ WIDTH OF FACADE AS LIMITED
ACCESSORY BUILDING	N/A	485 SF	485 SF	-	BY 300-34.B.4.c.2
TOTAL BUILDING COVERAGE FOR LOTS UNDER 7,500 SF	40% [TABLE B-2 & B-3] 2,746 SF FOR LOT A 2,348 SF FOR LOT B	14% 1,807 SF	26% 1,807 SF	35% 2,060 SF	
TERRACES		323 SF	323 SF	-	
NALKS & STEPS		632 SF	632 SF	157 SF	
DRIVEWAY & PAVER PATIO		2,396 SF	2,396 SF	1,262 SF	
RETAINING WALLS & WINDOW WELLS		117 SF	97 SF	22 SF	
TOTAL IMPERVIOUS COVERAGE FOR LOTS UNDER 7,500 SF	60% [TABLE B-2 & B-3] 4,119 SF FOR LOT A 3,522 SF FOR LOT B	41% 5,273 SF	77%* 5,255 SF *VARIANCE RECEIVED 9/13/23	59.6% 3,501 SF	* ZONING VARIANCE RECEIVED 9/13/23 ALL NEW DRIVEWAY ON LOT 17B TO BE PERMEABLE PAVERS

PREVAILING FRONT SETBACK

KL V AILINO I KONI SLIDACK					
ADDRESS	SETBACK (FT)				
95 PALISADE ST	4				
107-A PALISADE ST	36.8				
111 PALISADE ST	39				
119 PALISADE ST	5.5				
123 PALISADE ST	4.9				
AVERAGE	18.0				
(-)10% OF 15 FT PER TABLE B-2	-1.5				
PREVAILING SETBACK	16.5				

REFER TO AREA MAP ON SHEET S-2

AVERAGE GRADE

	AVG	FAÇADE	AVG GRADE x
	GRADE	LENGTH (FT)	FAÇADE LENGTH
SOUTH (FRONT) ELEVATION	100.6	24.5	2,463
EASTELEVATION	99.3	77.5	7,692
NORTH (REAR) ELEVATION	99.4	24.5	2,435
WESTELEVATION	99.7	77.5	7,723
TOTAL		204	20,314

99.58

AVERAGE GRADE

(AVG GRADE x FAÇADE LENGTH/TOTAL LENGTH) FIRST FLOOR - AVG GRADE = 102 - 99.58



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ESIDENC \mathcal{L} ROPC

Project Submitted BUILDING PERMIT SUB 6-30-23 ZBA SUBMISSION 7-19-23


PB/AHRB SUBMISSION 11-15-23 PB/AHRB SUBMISSION 01-18-24


PB/AHRB REV. SUBMISSION 02-22-24



As Shown Drawing Title **ZONING DATA**


Sheet Number

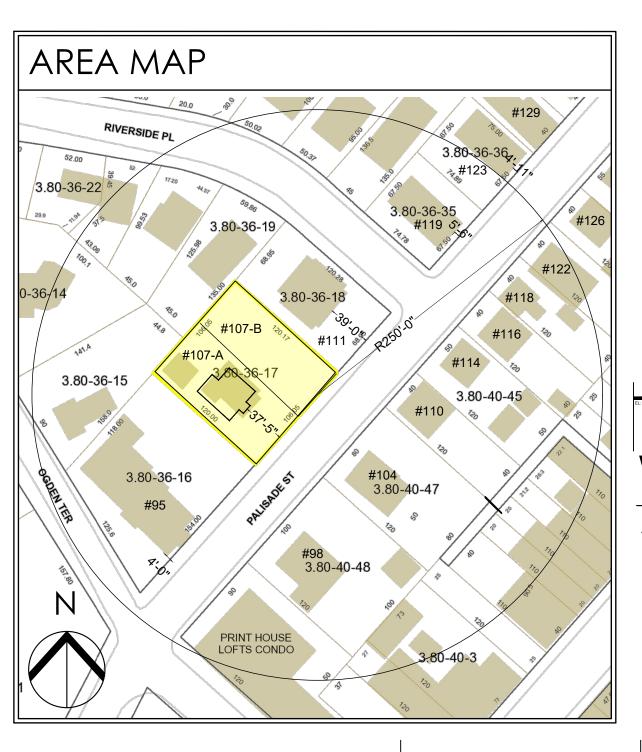

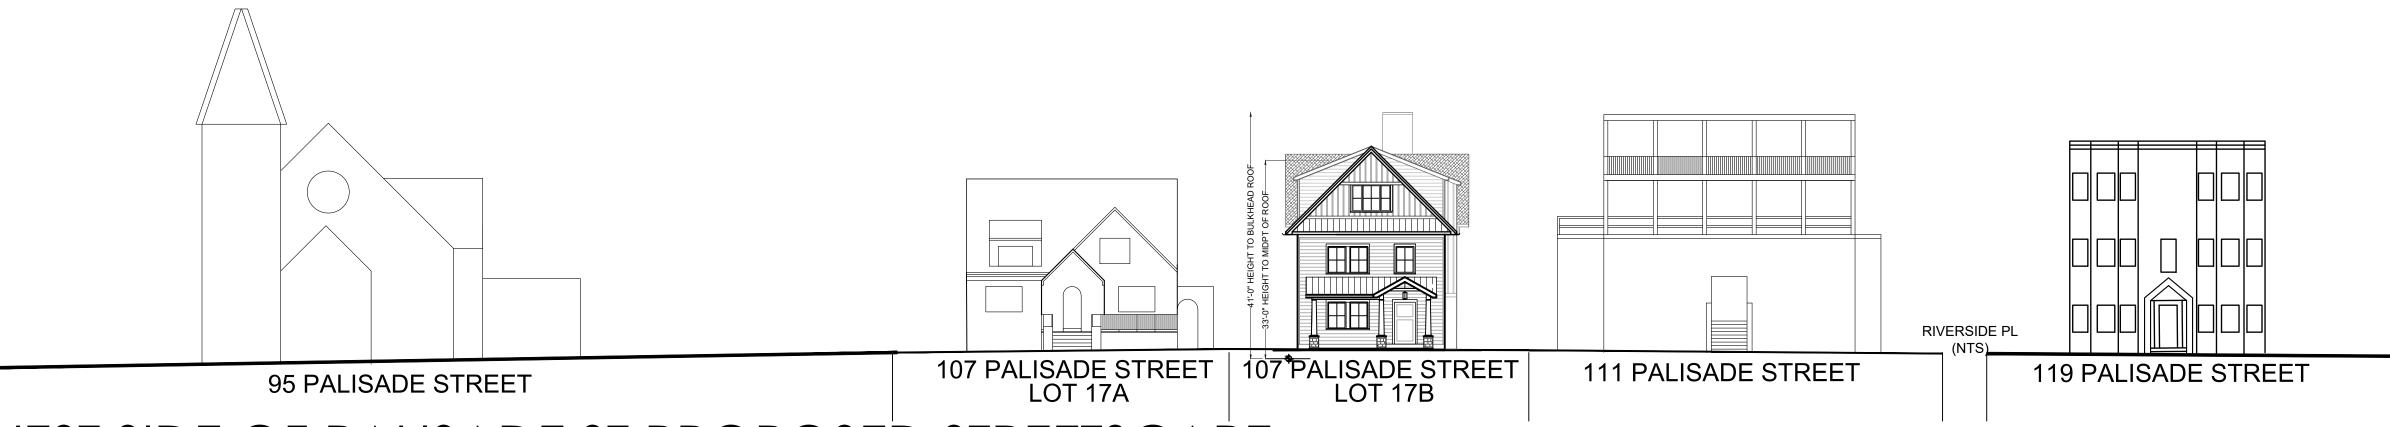


WEST SIDE OF PALISADE ST PROPOSED STREETSCAPE

SCALE: 1/16" = 1'-0"

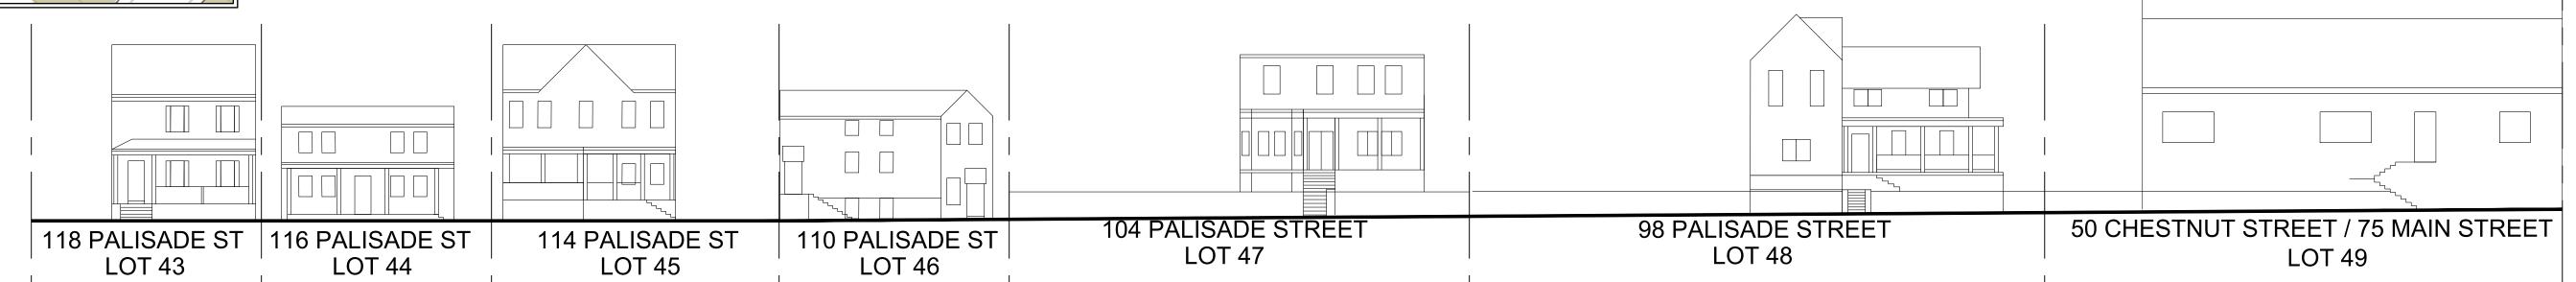

EAST SIDE OF PALISADE ST STREETSCAPE

SCALE: 1/16" = 1'-0"

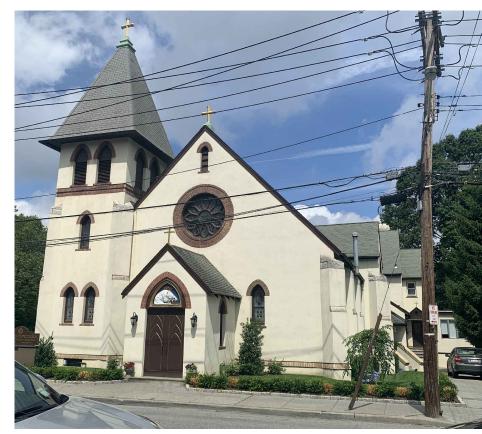









WITHIN 250 FT RADIUS

#107A WITHIN 250 FT RADIUS

#107B

WITHIN 250 FT RADIUS

WITHIN 250 FT **RADIUS**

#123

WITHIN 250 FT RADIUS

ALONG THE WEST SIDE OF PALISADE STREET











#60 CHESTNUT ST ALONG THE EAST SIDE OF PALISADE STREET NEIGHBORING PROPERTIES

WITHIN 250 FT

#104

WITHIN 250 FT

WITHIN 250 FT RADIUS

WITHIN 250 FT

RADIUS

WITHIN 250 FT

Drawing Title

NEIGHBORHOOD CONTEXT

Sheet Number


ARCHITECTS 12 SPRING STREET HASTINGS.on.HUDSON N.Y. 10706 914.478.0799 cg@cgastudio.com christinagriffinarchitect.com RESIDENCE

Project Submitted

BDIVISION

ZBA SUBMISSION 7-19-23 PB/AHRB SUBMISSION 11-15-23 PB/AHRB SUBMISSION 01-18-24

PB/AHRB SUBMISSION 02-09-24

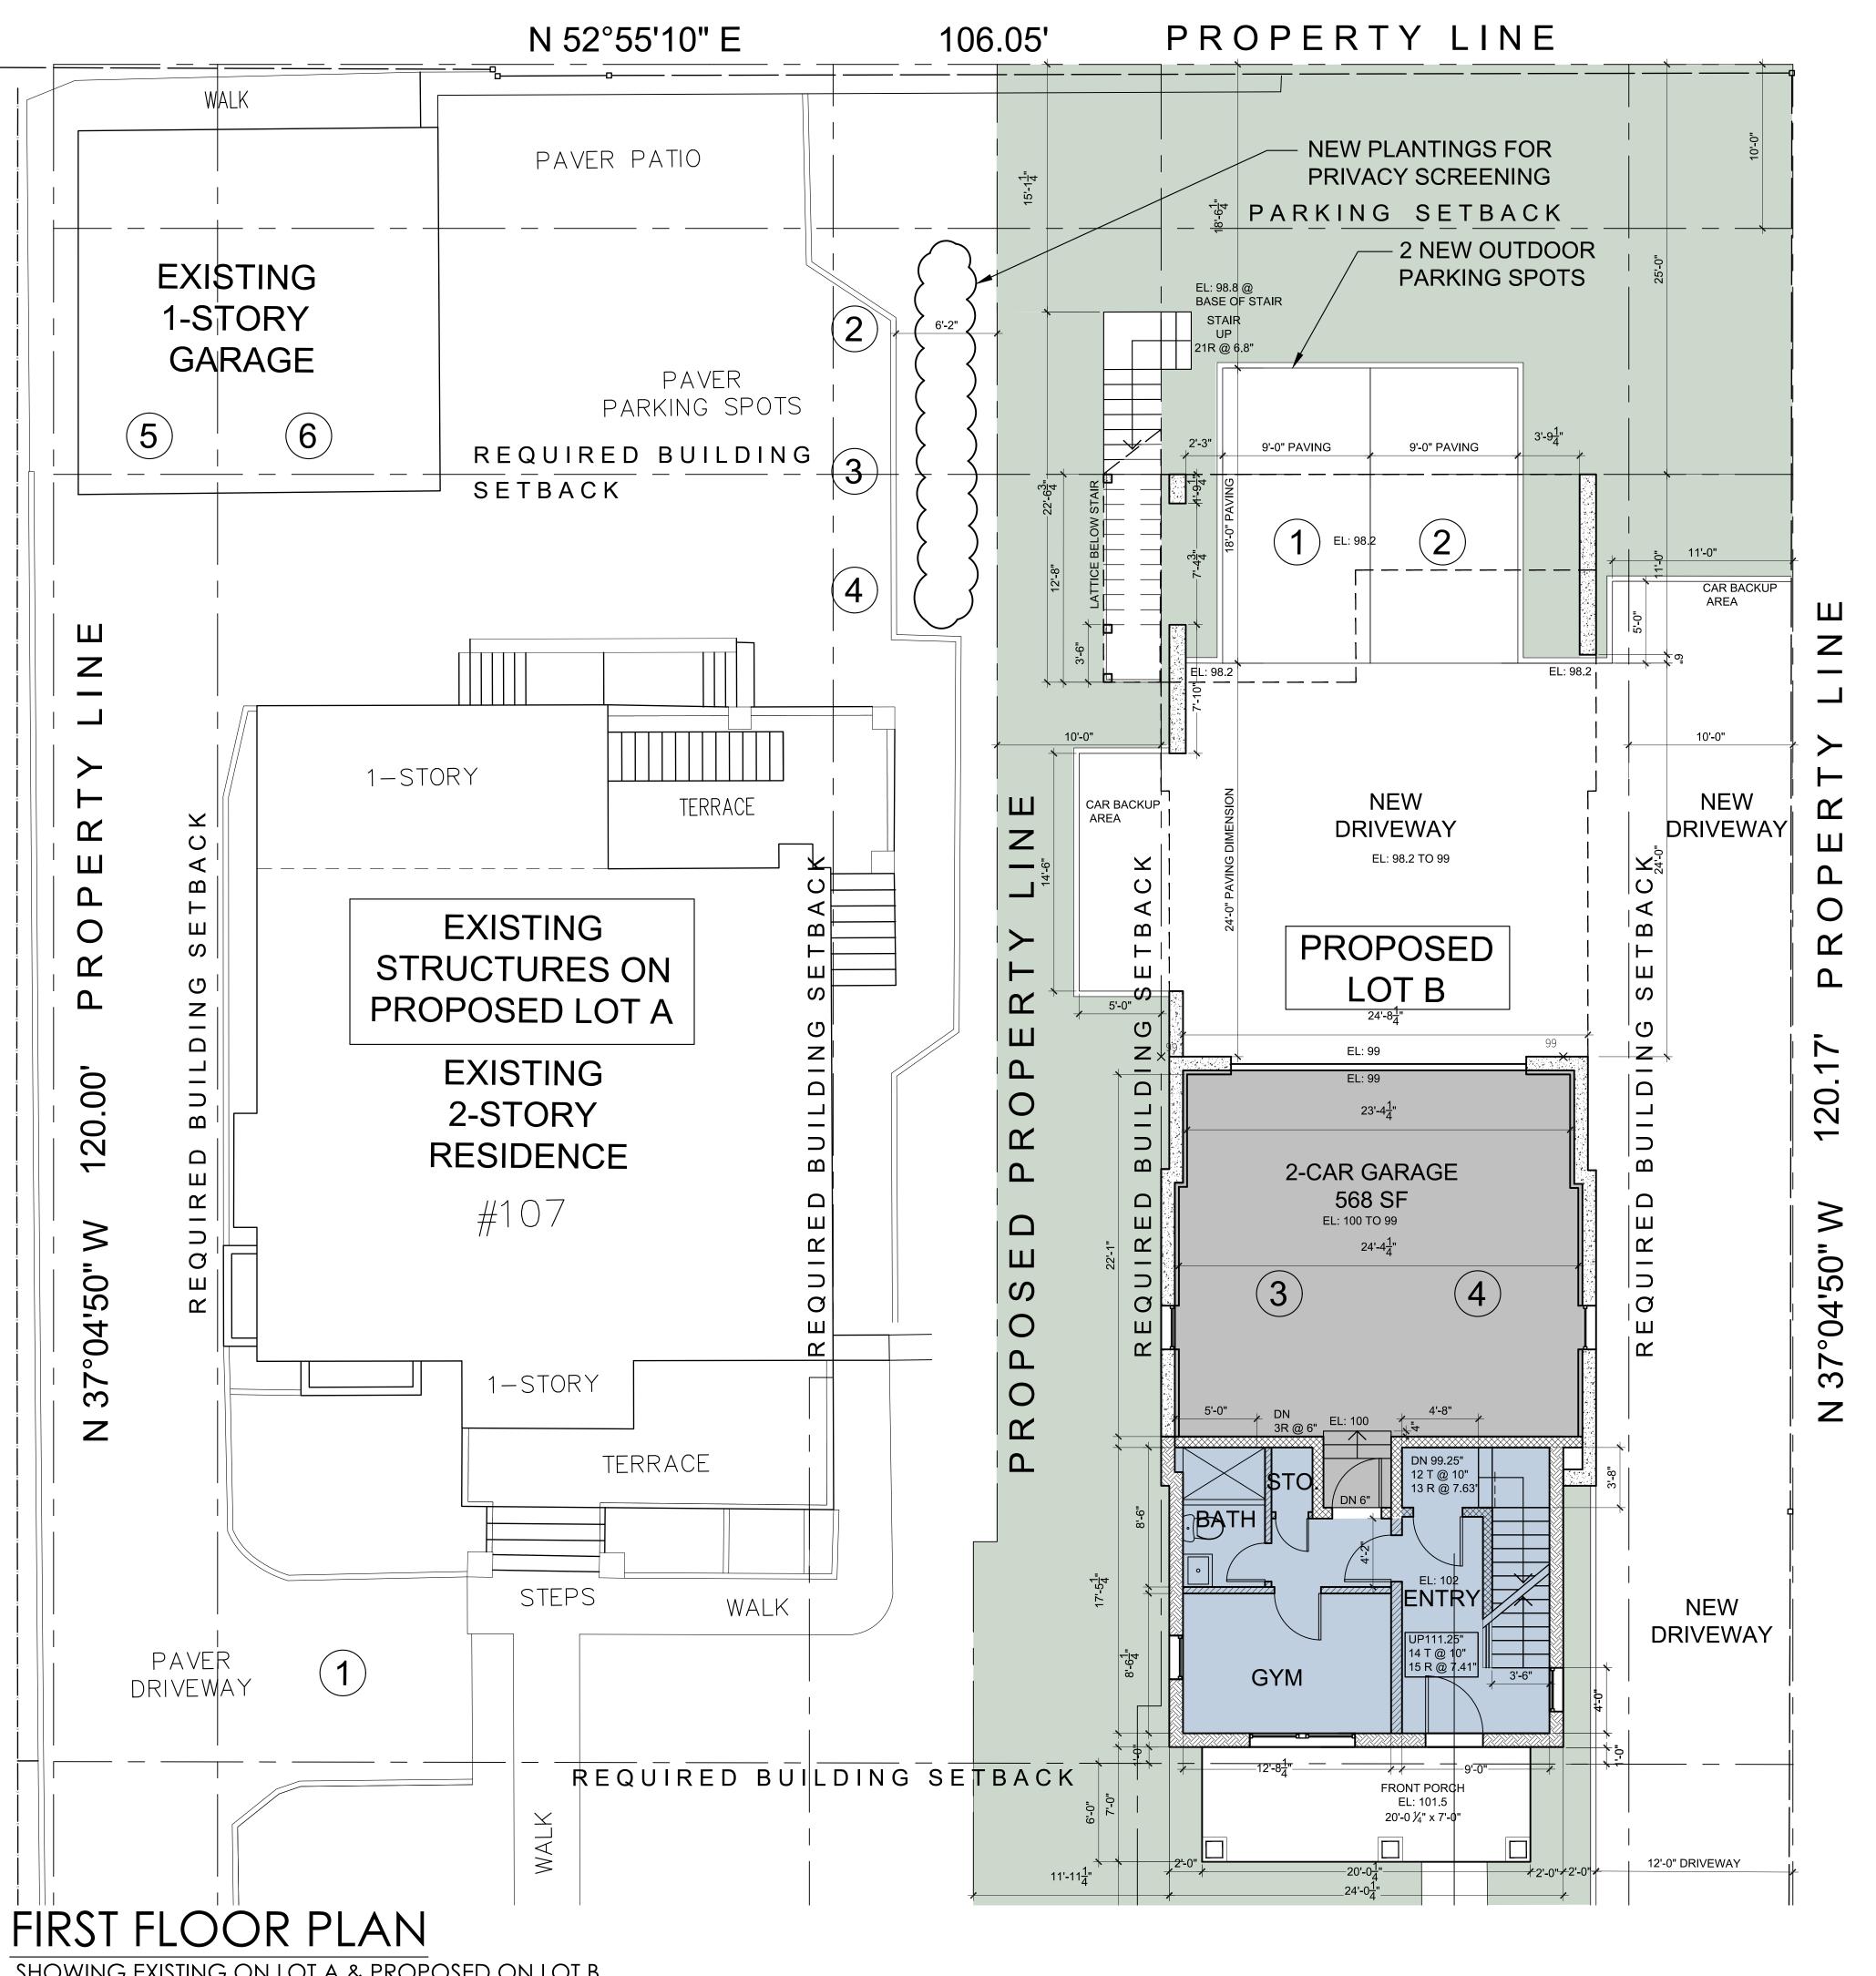


FLOOR AREA SUMMARY TOTAL BUILDING FIRST FLOOR 456 SF incl thickness of ext. wall SECOND FLOOR 1,761 SF THIRD FLOOR 1,910 SF ROOF BULKHEAD 72 SF **4,199** SF 2ND FLOOR UNIT 1 (3BR, 3.5 BATH) 997 SF 3RD FLOOR 1,217 SF incl thickness of ext. wall ROOF BULKHEAD 72 SF TOTAL 2,286 SF 2ND FLOOR PORCH 231 SF ROOF DECK 885 SF 2ND FLOOR 620 SF UNIT 2 (2BR, 2.5 BATH) 3RD FLOOR incl thickness of ext. wall 676 SF TOTAL 1,296 SF

PROPOSED EGRESS LIGHTWELL

PROPOSED ON LOT B

SCALE: 3/16" = 1'-0"

LEGEND 5/8" gypsum board ea. side of 2 x 4s @ 16" o.c. INTERIOR WALL W/ ACOUSTICAL INSULATION: 5/8" gypsum board each side of 2 x 4s @ 16" o.c., Blue Jeans acoustical insul. 1 HOUR FIRE RATED DEMISING/CORRDIOR WALL (8" THE (2) Layer 5/8" fire code gypsum board on resilient channel for sound attenuation, 2x6s @ 16" o.c. w/ acoustical insulation Stucco cladding system with cont. insulation Rvalue tbd. house wrap, 23/32 " Advantech engineered panel, 2x6 studs 16" o.c. w/ R-23 mineral wool insulation, 2x3 service cavity, 5/8" gypsum board **NEW FOUNDATION WALL:** New 10" reinforced concrete block wall w/ durawall reinforcement on continuous 12" d. x 24" w. 3,500 psi reinforced concrete footing; troweled on waterproofing below grade, 3-coat cement stucco with integral color above grade

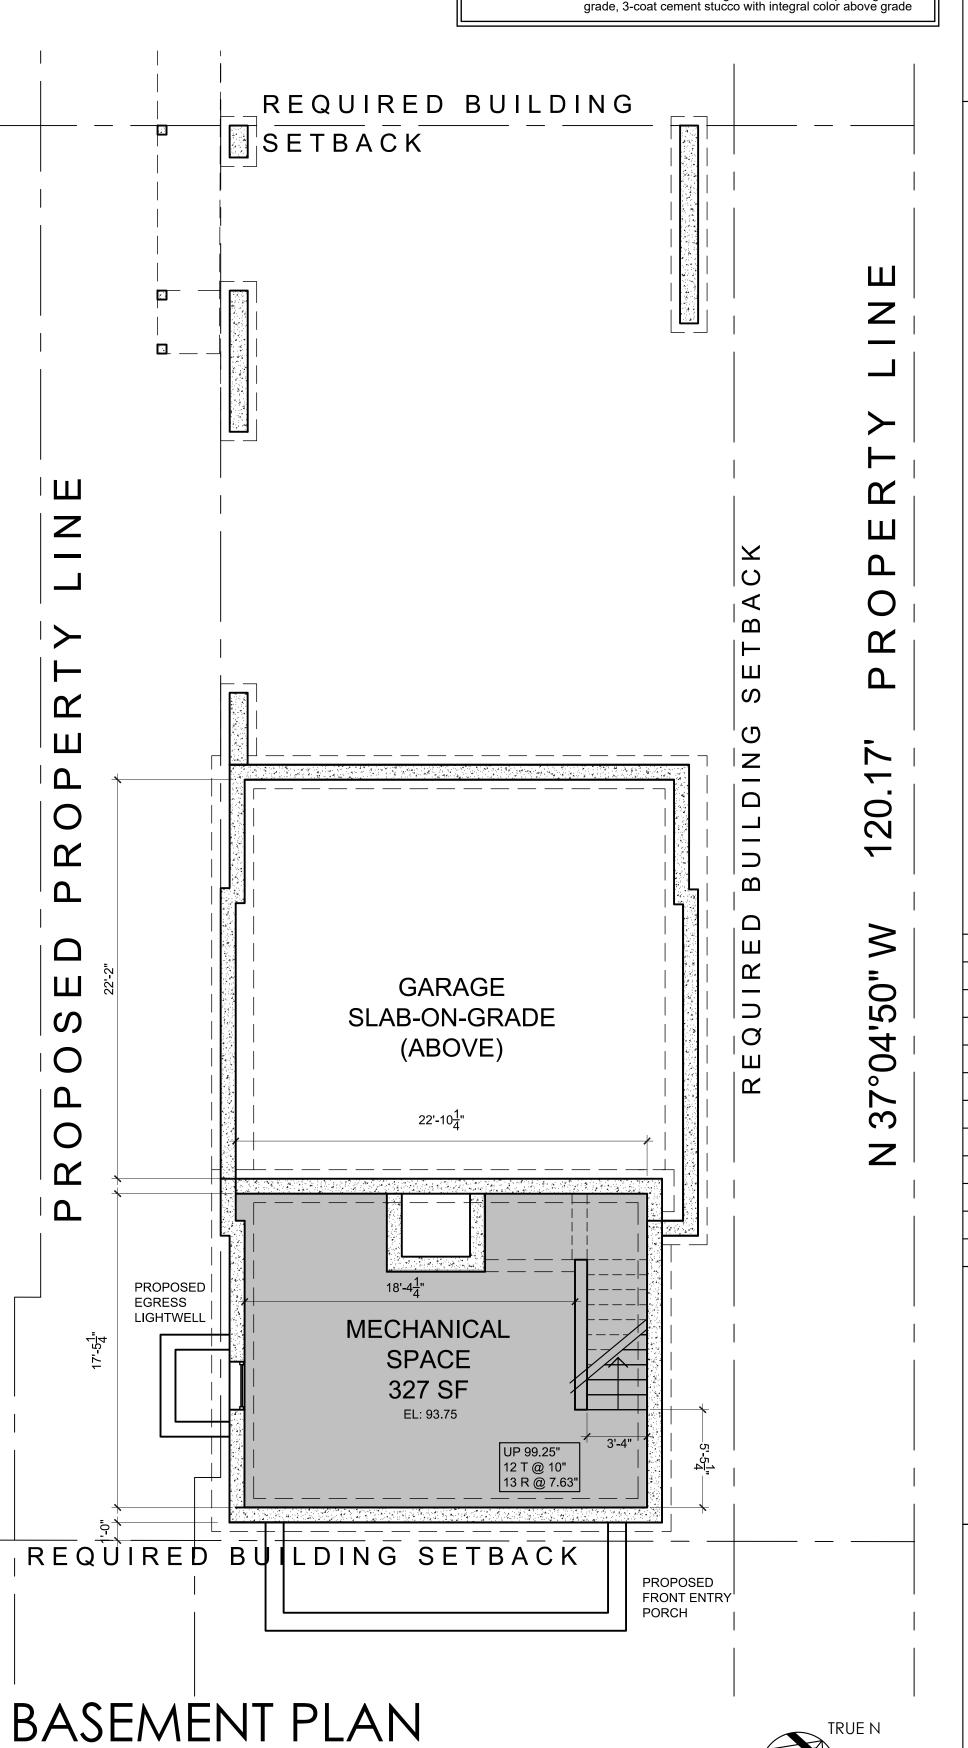



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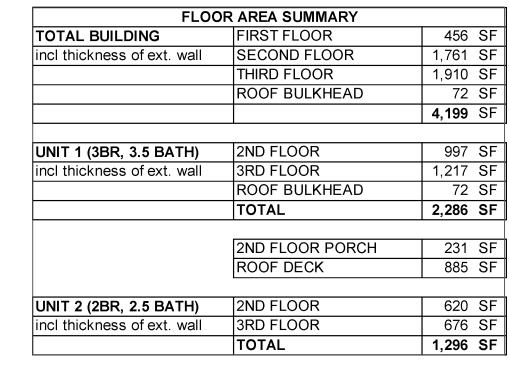
PB/AHRB SUBMISSION 02-09-24

As Shown Drawing Title FLOOR PLANS

Sheet Number


SHOWING EXISTING ON LOT A & PROPOSED ON LOT B SCALE: 3/16" = 1'-0"






PROPOSED ON LOT B

SCALE: 3/16" = 1'-0"

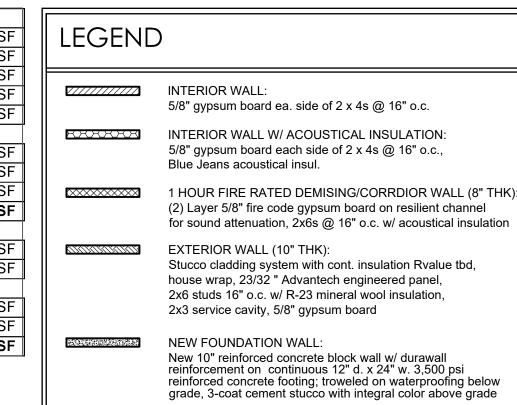

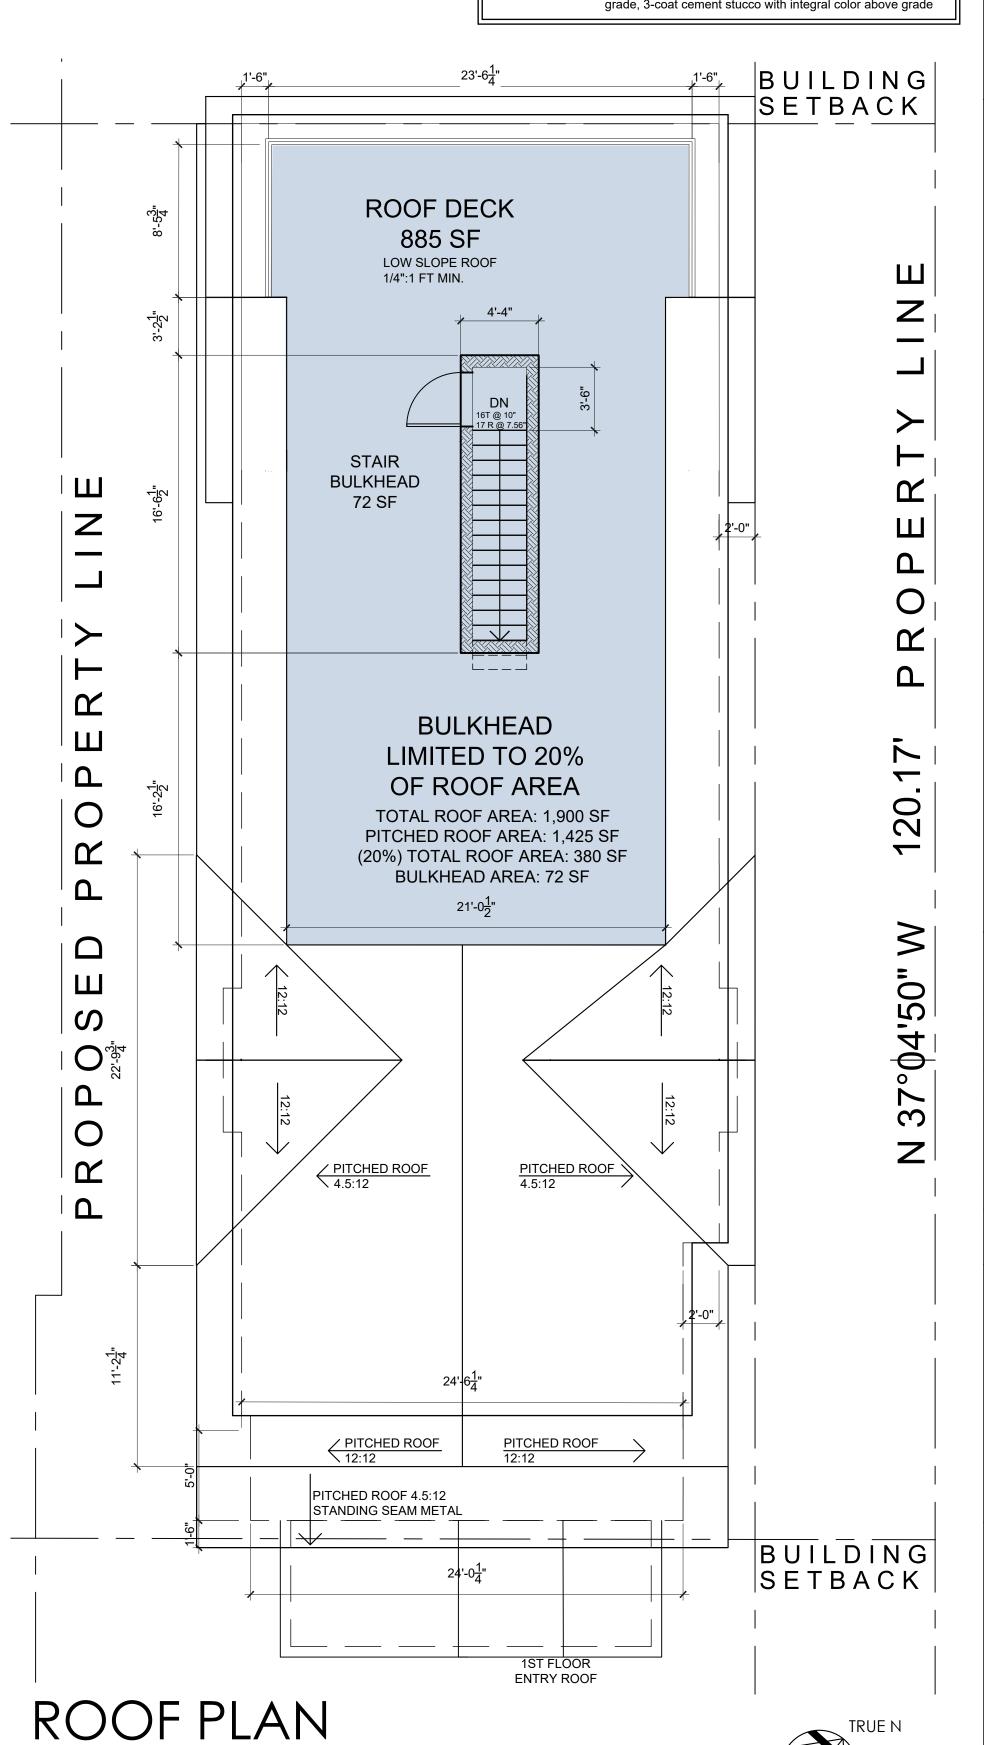




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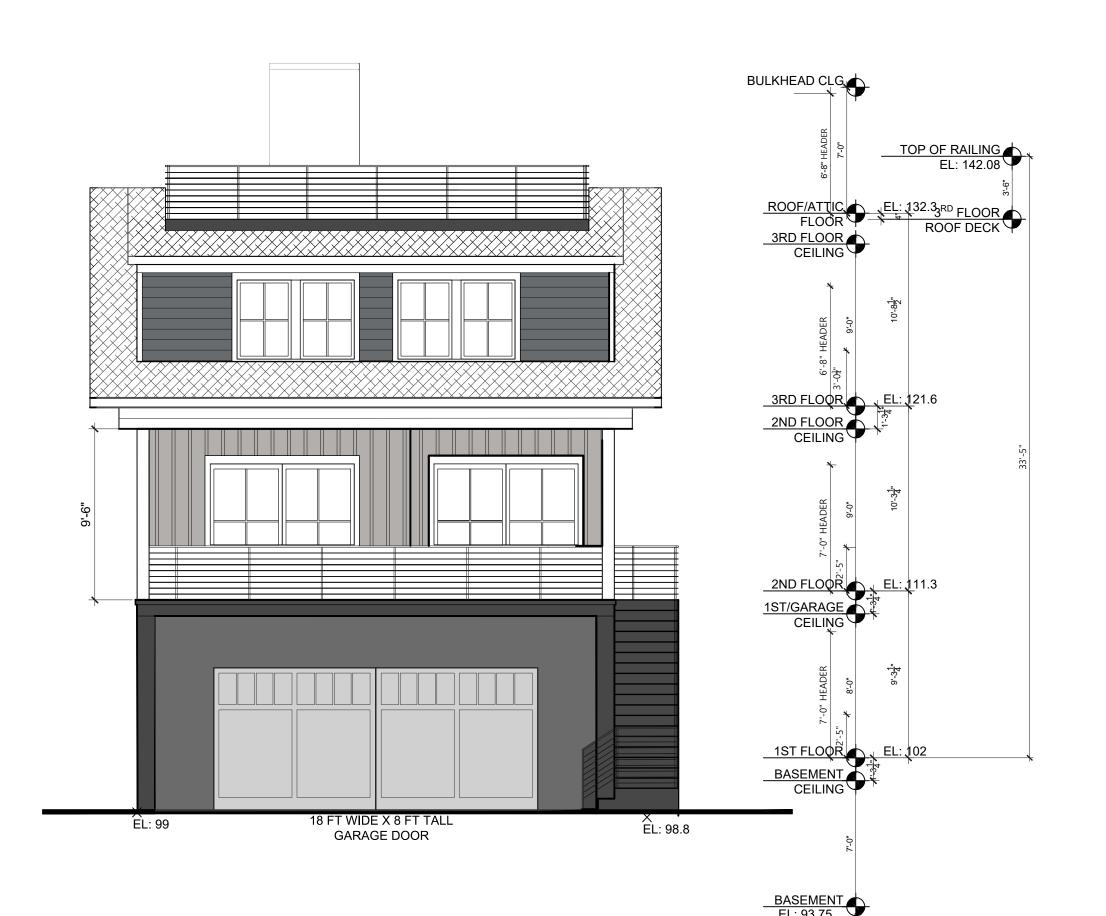
ESIDENC \mathcal{C} SU Project Submitted ZBA SUBMISSION 7-19-23 PB/AHRB SUBMISSION 11-15-23 PB/AHRB SUBMISSION 01-18-24 PB/AHRB SUBMISSION 02-09-24



As Shown Drawing Title FLOOR PLANS



EAST (PALISADE STREET) ELEVATION SCALE: 3/16" = 1'-0"

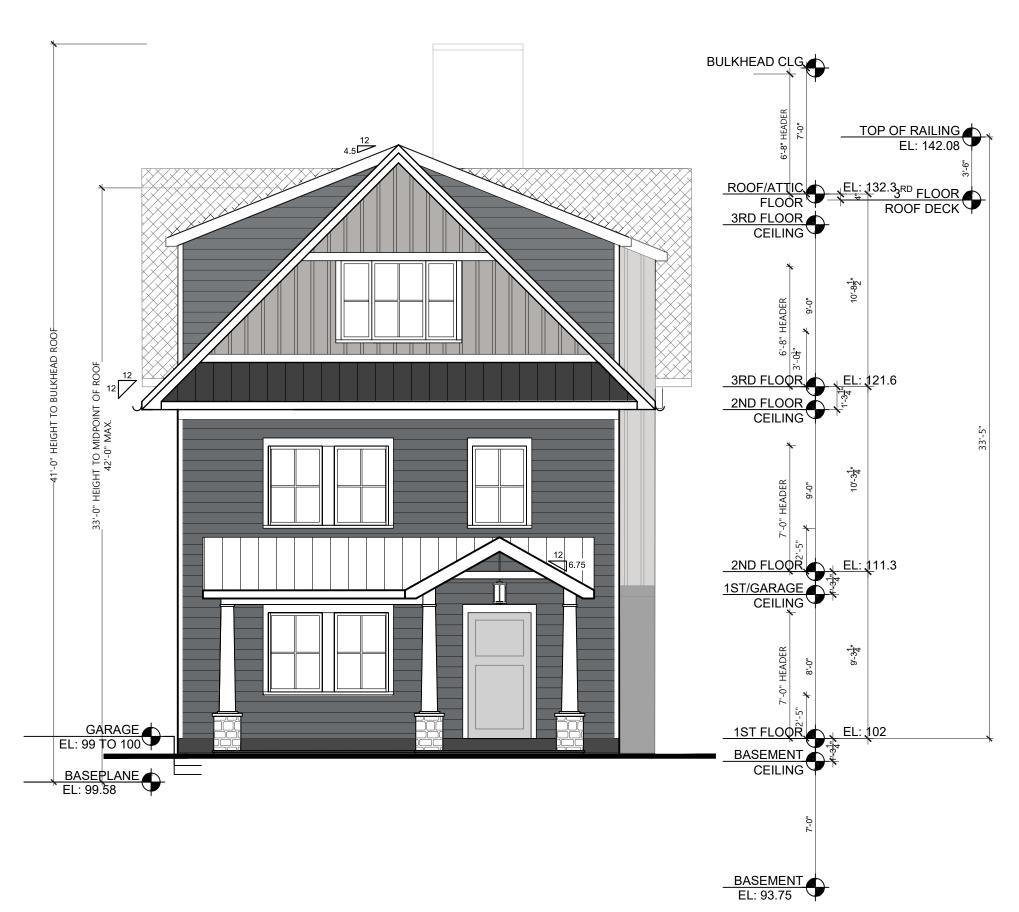

WEST ELEVATION SCALE: 3/16" = 1'-0"



NORTH ELEVATION

SCALE: 3/16" = 1'-0"



SOUTH ELEVATION


SCALE: 3/16" = 1'-0"



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RESIDENCE

Drawing Title

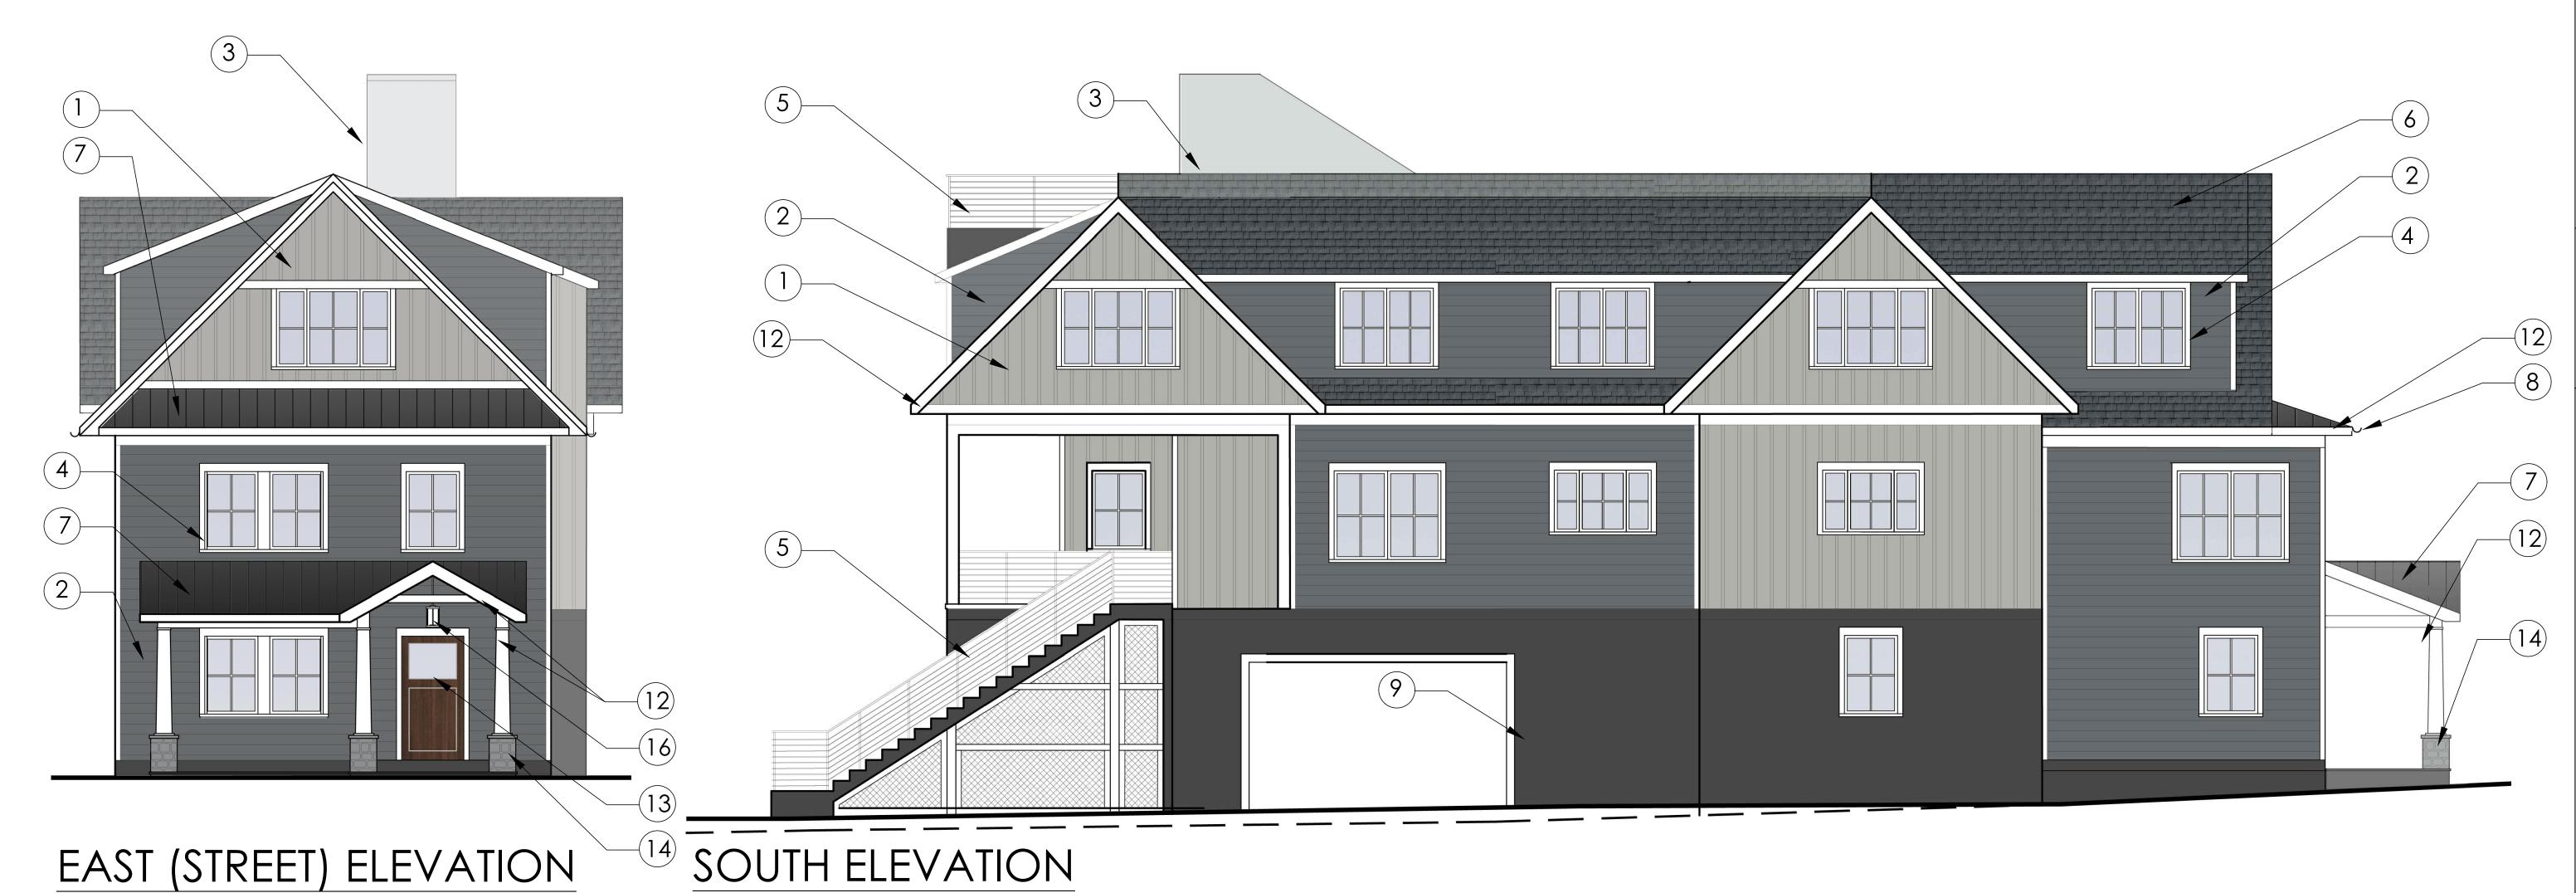

COLOR & MATERIAL SCHEME OF STREET ELEVATION

SCALE: 1/4" = 1'-0"




1.HARDIE PANEL VERTICAL CEMENTITIOUS SIDING,7" EXPOSURE, SIDING, BOARD & BATTEN SMOOTH FINISH, PAINT PAINT FINISH,




2. HARDIE PLANK LAP FINISH, NIGHT GRAY



3.HARDIE PANEL VERTICAL CEMENTITIOUS SIDING, PAINT FINISH LIGHT MIST

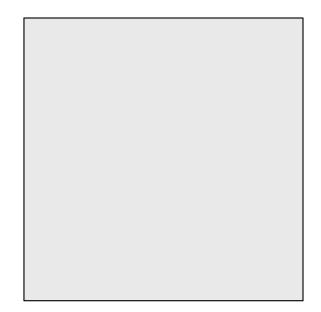

4. MARVIN ELEVATE WINDOWS ARCTIC WHITE

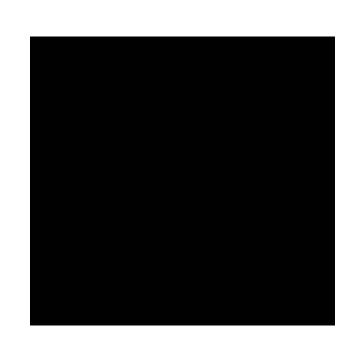


5. METAL RAILING WITH POWDERCOAT PAINT FINISH, COLOR-MATCHED TO BEN. MOORE LAMPBLACK, # CW-695




6. 30-YEAR ARCHITECTURAL SHINGLES BY CERTANTEED, METAL LANDMARK SERIES, **GEORGETOWN GREY**



7. STANDING SEAM **ROOFING WITH** FACTORY PAINTED **BLACK FINISH**

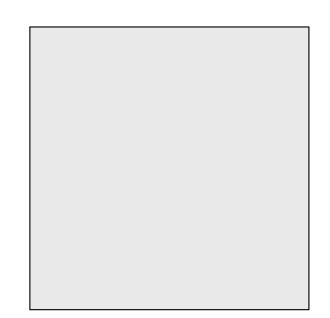

8. ALUMINUM HALF-ROUND **GUTTER, COLOR -**MATCHED TO BEN. MOORE **DOVE WHITE**

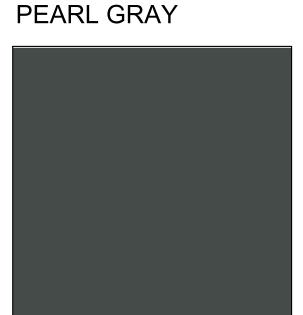


9. 3-COAT CEMENT STUCCO AT BUILDING BASE, FINE FINISH, COLOR MATCH TO MOORE CHELSEA GRAY # CW-695



10. PERVIOUS PAVERS BY UNILOCK, ECO-PRIORA, $4\frac{3}{4}$ " X $9\frac{1}{2}$ " X $3\frac{1}{8}$ " SMOOTH, GRANITE




11. BLUESTONE AT **ENTRY WALKWAY**

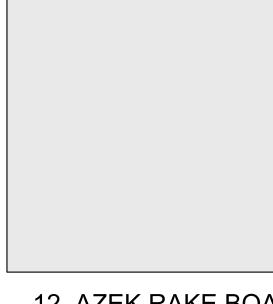

12. AZEK RAKE BOARD, SOFFIT, TRIM BOARD & COLUMNS, PAINT FINISH, WOOD FINISH BEN. MOORE DOVE WHITE



13. THERMATRU INSULATED ENTRY DOOR,

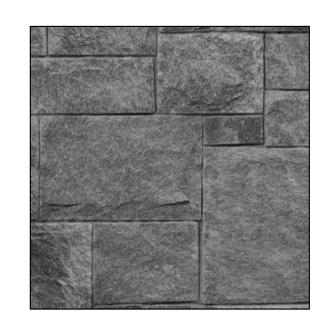

14. THINSTONE BASE AT FRONT ENTRY COLUMNS



15. EXTERIOR WALL MTD. PARKER LT. **FIXTURE**




16. EXTERIOR PENDANT PARKER LT. FIXTURE



FIXTURE

17. PATH 18. SHIELDED FIXTURE LIGHTING

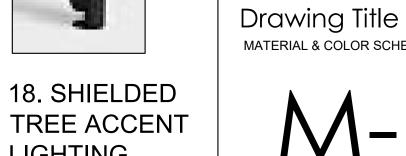

EXT. LIGHTING: ALL LIGHTING TO COMPLY WITH SECTION 300-41



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> RESIDENCE, TREET PROPC

Project Submitted PB/AHRB SUBMISSION 11-15-23 PB/AHRB SUBMISSION 01-18-24 PB/AHRB PRESENTATION 02-01-24

PB/AHRB SUBMISSION 02-09-24



As Shown

MATERIAL & COLOR SCHEME

Sheet Number

TREE REMOVAL LIST: TREE REMOVAL APPLICATION TO BE FILED WITH THE BUILDING DEPT (1)x 6-8" DBH TREE (2)x 10" DBH TREE

TREE VALUATION INFORMATION:
TOTAL DBH/NUMBER TREES TO BE REMOVED: 28" TOTAL DBH (3 TREES)
TOTAL NUMBER OF REQUIRED TREE REPLANTINGS PER CODE SECTION 300-511 (50% MINIMUM) = 14" TOTAL DBH

TOTAL PROPOSED TREES 2.5" DBH OR GREATER: (5)x 2.5" DBH TREE + (1)x 6" DBH TREE =

18.5" TOTAL DBH = 66% > 50% MINIMUM COMPLIANT

ALL LIGHTING TO COMPLY WITH SECTION 300-41 NEW EVERGREEN PLANTINGS FOR PRIVACY SCREENING PROPERTY LINE N 52°55'10" E PROPERTY LINE N 52°55'10" E EXIST. PAVER PATIO 236 SF **CURB AROUND 2** OUTDOOR PARKING SETBACK PARKING SETBACK PARKING SPOTS LIGHT FIXTURES IN STAIR RISERS EXIST. PAVER PARKING SPOTS BE REMOVED. 663 SF REFER TO PARKING SPOTS ___ PLANTING PLAN IDENTIFYING PERMEABLE REQUIRED BUILDING PAVERS > REPLACEMENT SETBACK PLANTINGS - PARKING BACKUP AREA _ _ _ _ _ _ Ш Z | Z 1-STORY EXIST. **TERRACE DRIVEWAY** 0 Z ^LPERMEABLE **PROPOSED** BACKUP AREA PAVERS -`Ш LOT A **EXISTING** 2-STORY RESIDENCE EXIST. TREE TO BE REMOVED. (3 x 1BR UNITS) PLANTING PLAN TO BE PROVIDED #107 PROPOSED UIRED **IDENTIFYING** REPLACEMENT LOT B **PLANTINGS** 20 - NEW EGRESS LIGHTWELL EXIST 0 FROM BASEMENT 1-STORY MECHANICAL SPACE 0 **PROPOSED** EXIST. TERRACE 2 3-STORY TWO-FAMILY RESIDENCE EXIST. EXIST. WALK STEPS W/ 2-CAR GARAGE⁵ FIRST FL EL: 102 GARAGE EL: 100-99 REQUIRED BUILDING SETBACK PLANT PLANT **DRIVEWAY** BED-BED -·PERMEABLE PAVERS -**NEW WALK** EXIST. WALĪ EXIST. WALK EXIST. WALK N 53°00'45" E PROPERTY LINE PROPERTY LINE

LIGHTING SITE PLAN

SCALE: 3/16" = 1'-0"

LEGEND FOR EXTERIOR LT. FIXTURES

→ WALL MOUNTED SCONCE

PENDANT FIXTURE

--- LIGHT FIXTURES IN STAIR RISERS

SEE DWG. M-1 FOR SPECIFICATIONS

SEE DWG. M-1 FOR SPECIFICATIONS

SEE DWG. M-1 FOR SPECIFICATIONS

SEE DWG. M-1 FOR SPECIFICATIONS.

SEE DWG. M-1 FOR SPECIFICATIONS

SHIELDED TREE ACCENT LIGHT FIXTURE

GRADE LEVEL LANDSCAPE LIGHT FIXTURES

PLANT LIST

ABBREVIATION

EVERGREEN TREES

ABIES BALSAMEA

BALSAM FIR

6'-8' HEIGHT

AS SHOWN

ILEX OPACA

AMERICAN HOLLY

6'-8' HEIGHT

AS SHOWN

COMMON NAME

SIZE (AT PLANTING)

QUANTITY

EVERGREEN SHRUBS

LITTLE GAINT ARBORVITAE	LITTLE GIANT	4'-0' HEIGHT	AS SHOWN
CAMELLIA JAPONICA 'KOREAN FIRE'	CAMELLIA 'KOREAN FIRE'		AS SHOWN
ILEX GLABRA	INKBERRY HOLLY		AS SHOWN
ILEX GLABRA 'COMPACTA'	COMPACT INKBERRY HOLLY		AS SHOWN
JUNIPER VIRGINIANA 'GREY OWL'	GREY OWL JUNIPER		AS SHOWN

GROUNDCOVER, FERNS, GRASSES & PERENNIALS

SCIENTIFIC NAME

ADIANTUM PENDATUM	MAIDENHAIR FERN	AS SHOWN
ASARUM CANADENSE	WILD GINGER	AS SHOWN
ASTER DIVARICARTUS	WHITE WOODLAND ASTER	AS SHOWN
ATHYRIUM FILIZ-FEMINA	LADY FERN	AS SHOWN
CARAX PENSYLVANICA	PENNSYLVANIA SLEDGE	AS SHOWN

DECIDUOUS SHRUBS

HYDRANGEA ARBORESCENS 'ANNABELLE'	ANNABELLE HYDRANGEA	AS SHOWN
HYDRANGEA QUERCIFOLIA	OAKLEAF HYDRANGEA	AS SHOWN
SYRINGA PATULA ' MISS KIM'	DWARF LILAC	AS SHOWN

PLANT NOTES:

1. ALL LAWN AREAS TO BE PREPARED W/ 4" MINIMUM OF SCREENED TOPSOIL AND SEEDED OR SODDED W/ A BLUEGRASS AND PERENNIAL RYEGRASS MIX. ALL DISTURBED AREAS NOT LAWN, IE SHRUB BEDS TO BE SEEDED W/ A MIX OF ANNUAL RYE AT 50% NORMAL BROADCAST RATE AND REDTOP FESCUE AT NORMAL RATE.

2. ALL PLANTS AND SHRUB BEDS SHALL RECEIVE 2" MINIMUM OF SHREDDED CEDAR MULCH.


3. ALL TREES AND SHRUBS SHALL HAVE 12" TOPSOIL AROUND SIDES OF ROOTS. ADD TOPSOIL FOR DEPTH AS NECESSARY.
4. IF PLANT COUNTS DIFFER BETWEEN THE PLANT LIST AND THE PLANS, THOSE SHOWN GRAPHICALLY ON THE PLANS SHALL BE ASSUMED CORRECT.

5. ALL PLANTS TO BE TYPICAL OF THE SPECIES, HEALTHY, AND FREE OF DISEASE AT THE TIME OF PLANTING AND WARRANTEED FOR ONE YEAR THEREAFTER.

6. ALL INVASIVE, NON-NATIVE PLANTS TO BE REMOVED FROM THE SITE.

7. SUBSTITUTIONS OF SIMILAR TYPE, SIZE AND NUMBER ARE PERMITTED IN THE INTEREST OF PURCHASING THE BEST QUALITY MATERIAL AVAILABLE AT THE TIME OF PLANTING.

LEGEND

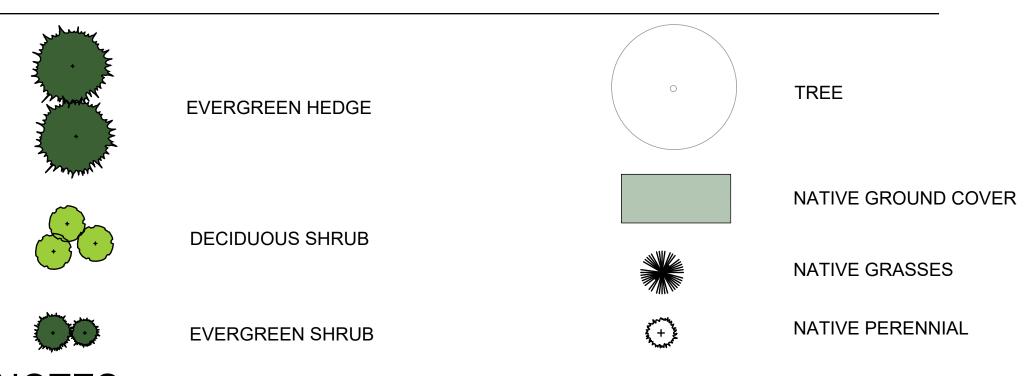

NOTES

- 1. THE LANDSCAPE CONTRACTOR TO COORDINATE THIS WORK W/ OTHER CONTRACTORS PERFORMING WORK ON SITE.

 2. THE CONTRACTOR SHALL LOCATE AND VERIFY ALL UNDERGROUND UTILITIES PRIOR TO ANY LAWN WORK OR TREE AND COURT OF THE PROJECT OF THE P
- SHRUB PLANTING AND SHALL IMMEDIATELY REPORT ANY CONFLICTS TO THE PROJECT SITE ENGINEER.

 3. THE CONTRACTOR SHALL SUPPLY ALL PLANT MATERIAL IN QUANTITIES SUFFICIENT TO COMPLETE THE PLANTING SHOWN ON THE DRAWING. QUANTITIES IN PLANT SCHEDULE ARE FOR REFERENCE ONLY.

NO PLANT OR CULTIVAR SUBSTITUTIONS WILL BE ACCEPTABLE WITHOUT APPROVAL OF THE LANDSCAPE ARCHITECT.
 OWNER'S LANDSCAPE ARCHITECT SHALL INSPECT PLANT MATERIAL FOR ACCEPTANCE PRIOR TO PLANTING.

OWNER'S LANDSCAPE ARCHITECT SHALL INSPECT PLANT MATERIAL FOR ACCEPTANCE PRIOR TO PLANTING.
 LOCATION OF NEW PLANT MATERIAL SHALL BE STAKED OR SET OUT BY CONTRACTOR AND APPROVED BY OWNER'S LANDSCAPE ARCHITECT PRIOR TO PLANTING.

7. REFER TO PLANTING DETAILS AND SPECIFICATIONS FOR INFORMATION RELATING TO PLANTING PIT DIMENSIONS AND EXTENT AND COMPOSITION OF BACKFILL MATERIAL.

8. THE CONTRACTOR SHALL REMOVE ALL PLASTIC MATERIAL FROM AROUND THE ROOT BALLS OF THE PLANTS AFTER POSITIONING IN THE PLANT PITS. REMOVE BURLAP, ROPE, AND WIRE FROM AROUND THE TRUNK SUFFICIENTLY SO THAT NO BURLAP, ROPE OR WIRE WILL BE EXPOSED AFTER BACKFILLING.

9. CONTRACTOR SHALL EXERCISE EXTREME CARE IN WORKING IN AREA OF EXISTING TREES. EXISTING TREES TO REMAIN AND BE PROTECTED, WHICH ARE INJURED OR DESTROYED DURING CONSTRUCTION SHALL BE REPLACED BY CONTRACTOR WITH PLANTS OF EQUAL SIZE AND SPECIES AT NO COST TO THE OWNER.

10. ALL AREAS THAT HAVE BEEN DISTURBED BY PLANTING ACTIVITY SHALL BE RESTORED TO A NEAT CONDITION. AREAS WITH BARE SOIL SHALL BE TOPSOILED AND SEEDED WITH NATIVE EROSION CONTROL SEED MIX.

11. THE CONTRACTOR SHALL WATER TREES, SHRUBS AND GROUNDCOVER TWICE DURING THE FIRST 24 HOURS AND AS

NEEDED DURING THE FIRST GROWING SEASON.

12. ALL NEW PLANTING SHOWN WITHIN OR NEAR THE DRIPLINE OF THE 32" SUGAR MAPLE SHALL BE LOCATED IN THE FIELD BY OWNER'S LANDSCAPE ARCHITECT OR ARBORIST AND INSTALLED UNDER THE DIRECT SUPERVISION OF OWNER'S LANDSCAPE ARCHITECT OR ARBORIST TO ENSURE PROTECTION OF EXISTING TREE ROOTS.

CGA Studio ARCHITECTS

12 SPRING STREET HASTINGS.on.HUDSON N.Y. 10706 914.478.0799 cg@cgastudio.com christinagriffinarchitect.com

ROPOSED SUBDIVISION & RESIDENCE A

OF PALISADE STREET

OBBS FERRY, NY 10522

Project Submitted

PB/AHRB SUBMISSION 11-15-23
PB/AHRB SUBMISSION 01-18-24

PB/AHRB PRESENTATION 02-01-24
PB/AHRB SUBMISSION 02-09-24



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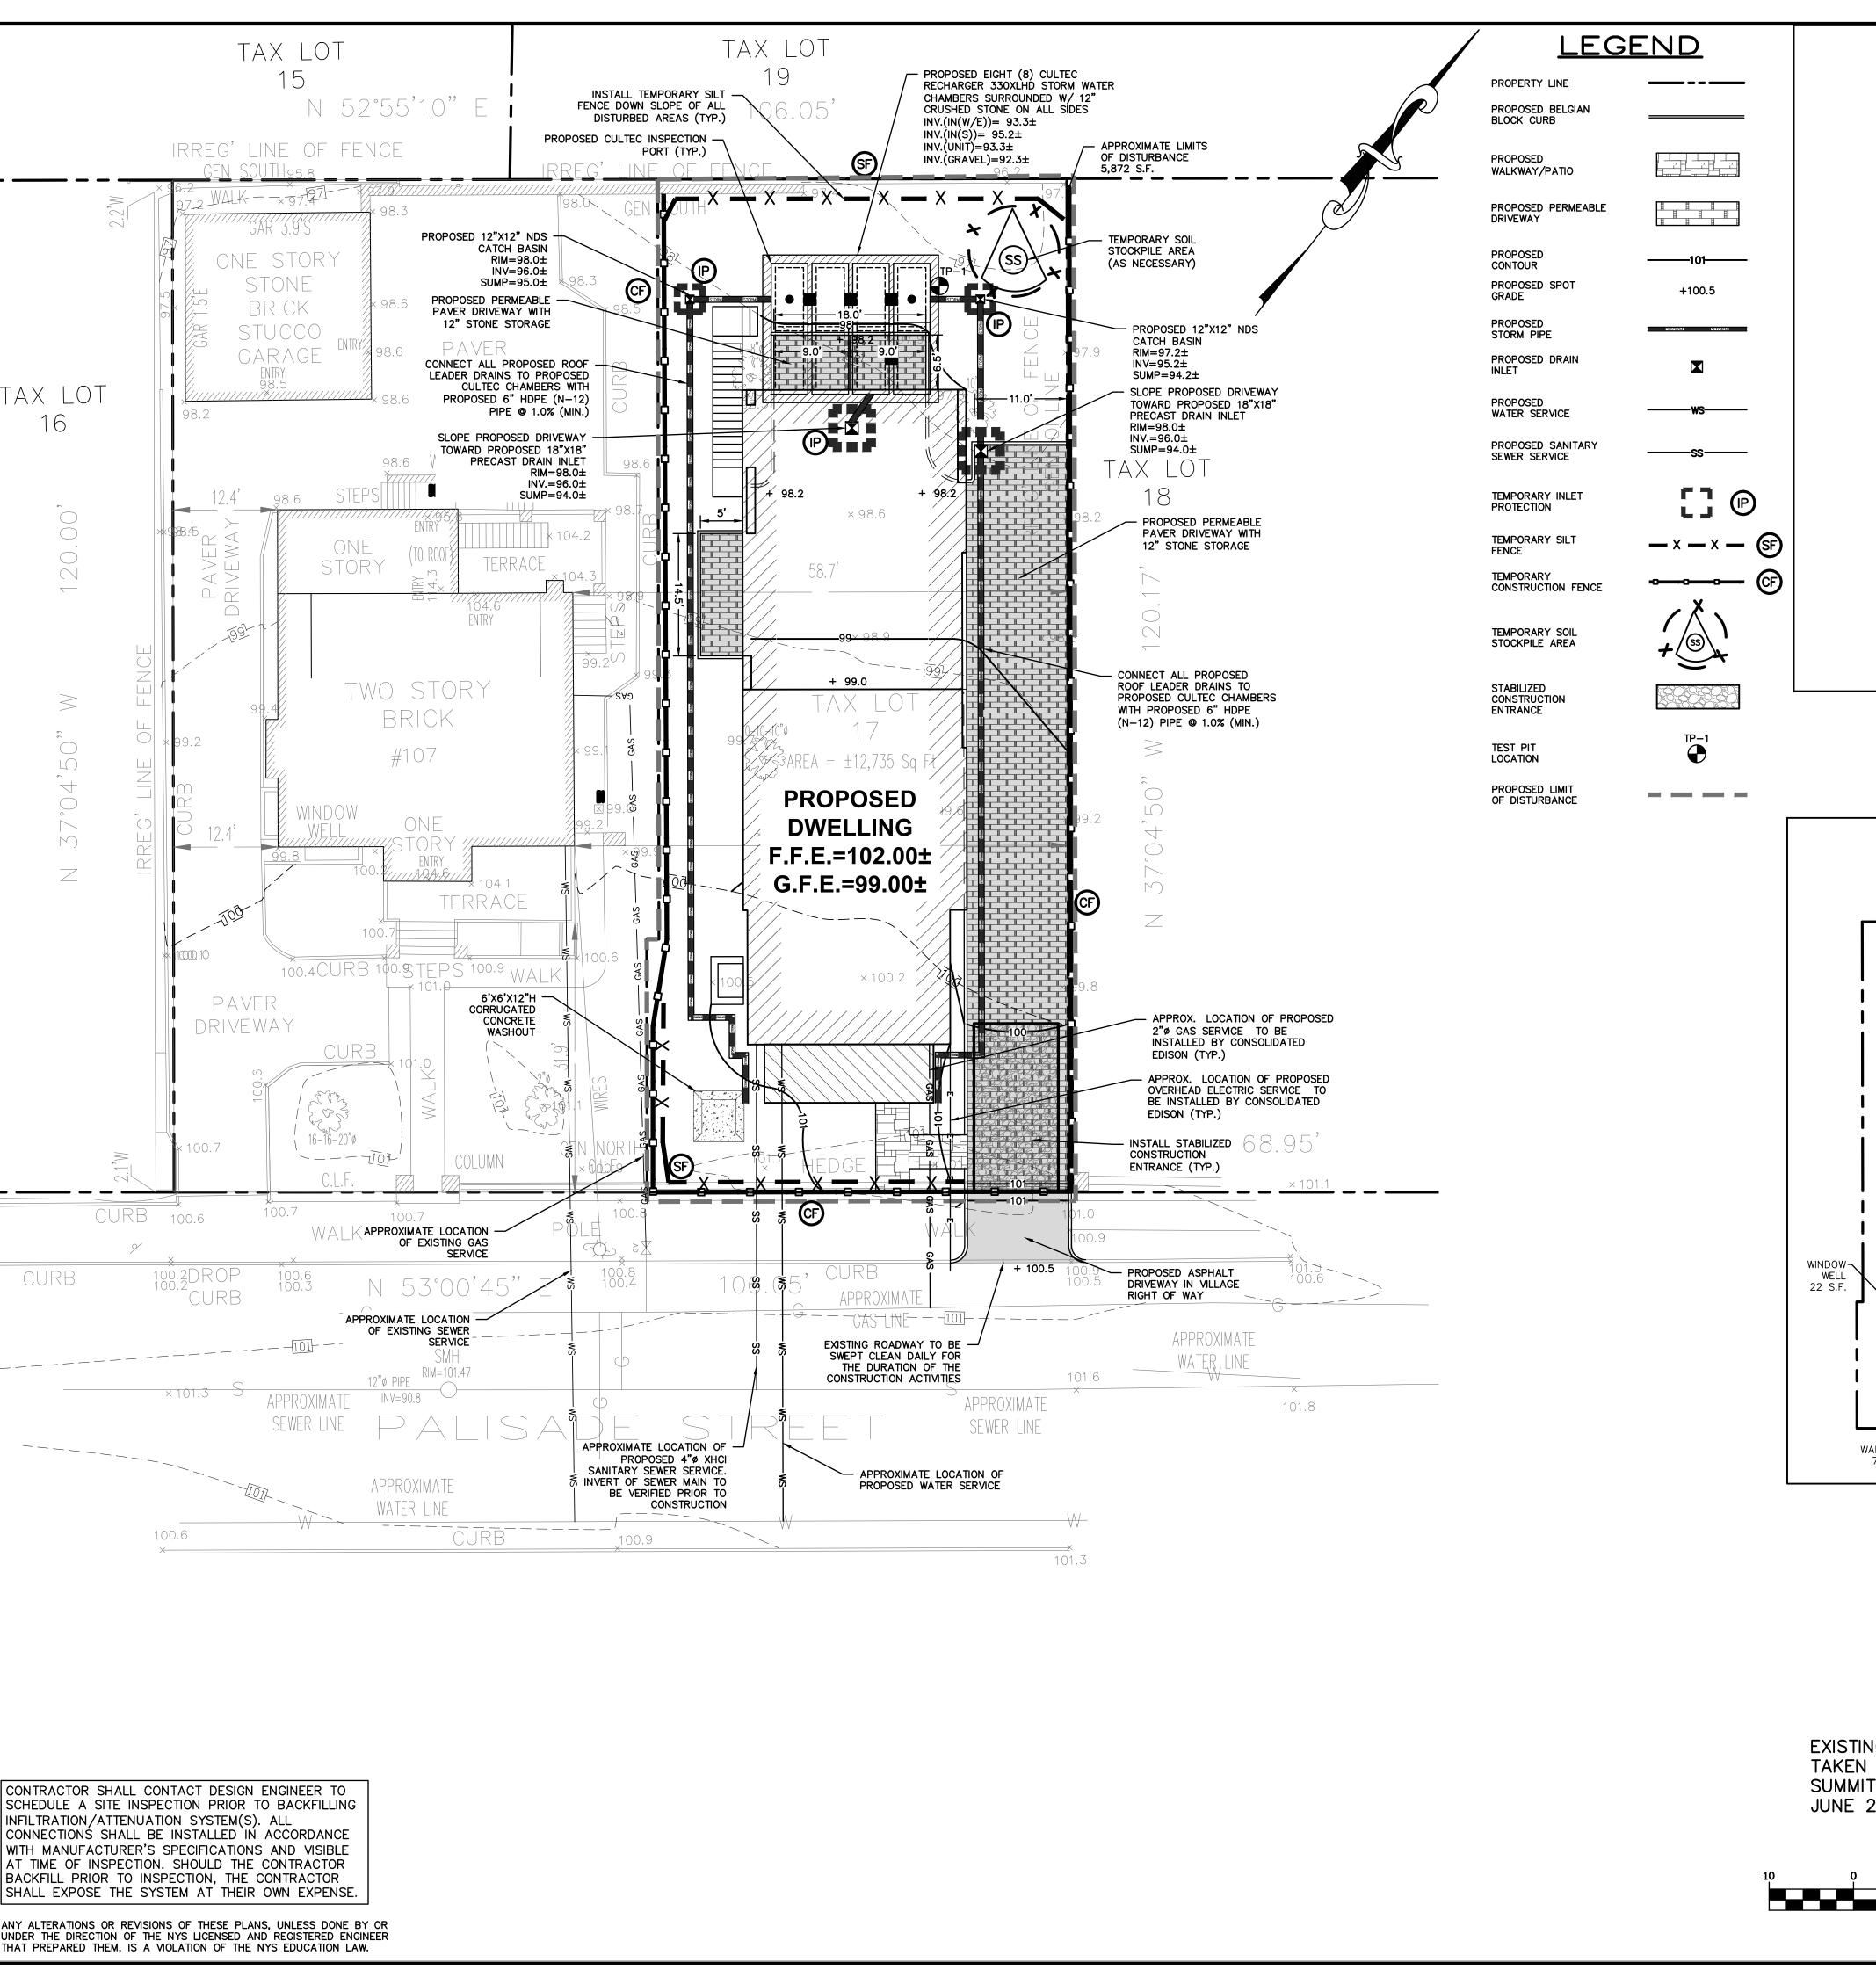
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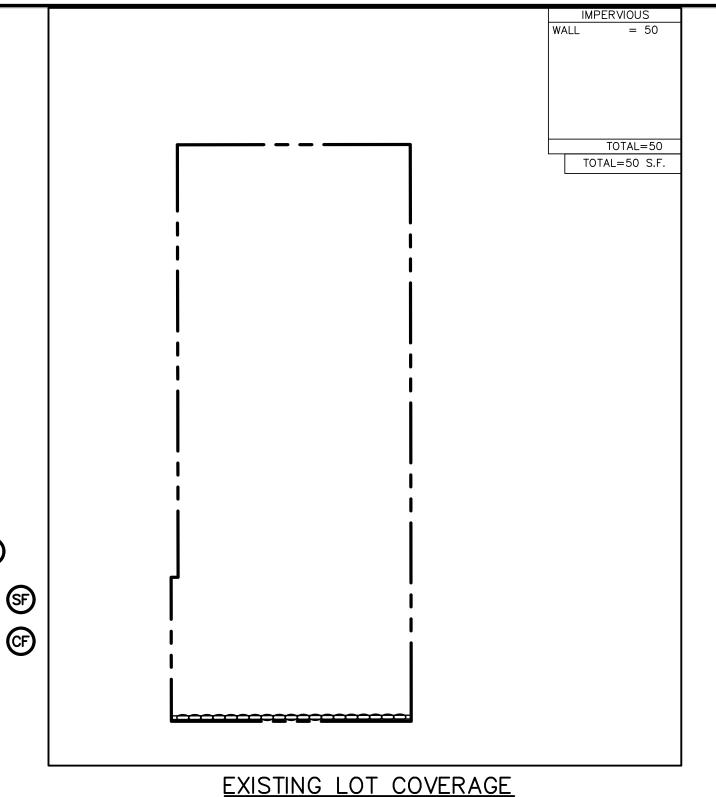
Drawing Title
LANDSCAPE & LIGHTING PLAN

L-1

Sheet Number

LANDSCAPING PLAN SCALE: 3/16" = 1'-0"





SCALE: 1"=20'

|WELLING = 2,065| |DRIVEWAY = 1,26WINDOW WELL TOTAL=2,060 TOTAL=1,441 TOTAL=3,501 S.F DRIVEWAY 1,262 S.F. 2,060 S.F. WALKWAY 72 S.F.

> PROPOSED LOT COVERAGE SCALE: 1"=20'


TEST HOLE DATA:


TEST HOLE #1 DEPTH - 96" 0-12" TOPSOIL 12-62" SANDY LOAM 62-96" CLAY

NO GROUNDWATER NO LEDGE ROCK PERC. = 28.24 INCHES/HOUR

EXISTING INFORMATION SHOWN HEREON TAKEN FROM A SURVEY PREPARED BY SUMMIT LAND SURVEYING P.C. DATED JUNE 27, 2023

GRAPHIC SCALE

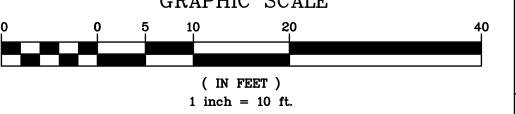

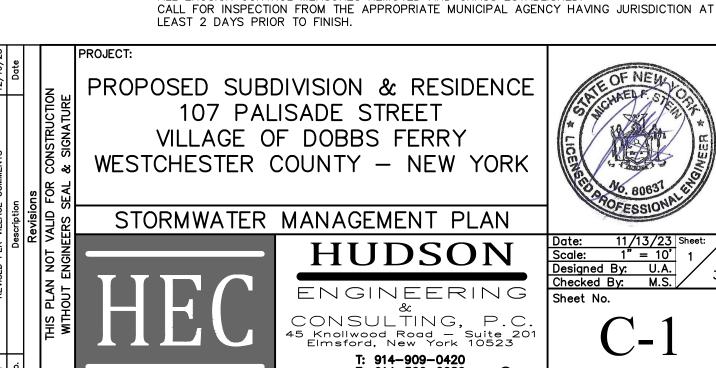

PROPOSED SUBDIVISION & RESIDENCE 107 PALISADE STREET VILLAGE OF DOBBS FERRY WESTCHESTER COUNTY - NEW YORK







HUDSON Designed By: U.A. Checked By: M.S

T: 914-909-0420 F: 914-560-2086

SITE LOCATION

1. THE ENGINEER SHALL NOT BE RESPONSIBLE FOR THE SUPERVISION OF THE

ENGINEER SHALL BE IMMEDIATELY NOTIFIED OF ANY DISCREPANCIES.

PORTIONS OF THE WORK UNDER THE CONTRACT.

PERIOD OF CONSTRUCTION.

INSURANCE CERTIFICATES.

SCALED DIMENSIONS.

EXCAVATION.

DAYS PRIOR TO FINISH.

INSPECTION BY MUNICIPALITY

MUNICIPAL AGENCY HAVING JURISDICTION.

LEAST 2 DAYS PRIOR TO FINISH.

LEAST 2 DAYS PRIOR TO FINISH.

GRASS ESTABLISHED.

INSPECTION BY MUNICIPALITY — FINAL GRADING REMOVE UNNEEDED SUBGRADE FROM SITE.

INSPECTION BY MUNICIPALITY - LANDSCAPING

JURISDICTION AT LEAST 2 DAYS PRIOR TO FINISH.

INSPECTION BY MUNICIPALITY - FINAL INSPECTION

INSPECTION BY MUNICIPALITY - FINAL LANDSCAPING

2. NO CHANGES SHALL BE MADE TO THESE PLANS EXCEPT AS PER NYS LAW CHAPTER 987

3. ALL WORK AND MATERIALS SHALL COMPLY WITH ALL APPLICABLE CODES, INCLUDING BUT NOT LIMITED TO ACI, AISC, ZONING, AND THE NEW YORK STATE BUILDING CODE.

5. ALL CHANGES MADE TO THE PLANS SHALL BE APPROVED BY THE ENGINEER AND ANY

SUCH CHANGES SHALL BE FILED AS AMENDMENTS TO THE ORIGINAL BUILDING PERMIT.

6. THE CONTRACTOR SHALL SUPERVISE AND DIRECT THE WORK USING HIS BEST SKILL AND ATTENTION. HE SHALL BE SOLELY RESPONSIBLE FOR ALL CONSTRUCTION MEANS,

METHODS, TECHNIQUES, SEQUENCES AND PROCEDURES AND FOR COORDINATING ALL

7. THE CONTRACTOR SHALL BE RESPONSIBLE TO THE OWNER FOR THE ACTS AND OMISSIONS

PERSONS PERFORMING ANY OF THE WORK UNDER A CONTACT WITH THE CONTRACTOR.

SHALL CONFORM TO ALL LOCAL, STATE AND FEDERAL AGENCIES IN EFFECT DURING THE

8. SAFETY DURING CONSTRUCTION SHALL BE THE RESPONSIBILITY OF THE CONTRACTOR AND

9. THE CONTRACTOR AND HIS SUBCONTRACTORS SHALL MAKE APPLICATION TO RECEIVE ALL NECESSARY PERMITS TO PERFORM THE WORK UNDER CONTRACT. THE CONTRACTOR AND

HIS SUBCONTRACTORS SHALL BE LICENSED TO DO ALL WORK AS REQUIRED BY THE

LOCAL, COUNTY, AND STATE AGENCIES WHICH MAY HAVE JURISDICTION OVER THOSE TRADES, AND SHALL PRESENT THE OWNER WITH COPIES OF ALL LICENSES AND

10. FINAL GRADING AROUND THE BUILDING AREA SHALL SLOPE AWAY FROM THE STRUCTURE.

11. ALL WRITTEN DIMENSIONS ON THE DRAWINGS SHALL TAKE PRECEDENCE OVER ANY

12. ADJOINING PUBLIC AND PRIVATE PROPERTY SHALL BE PROTECTED FROM DAMAGE DURING

PROVISIONS SHALL BE MADE TO CONTROL WATER RUNOFF AND EROSION DURING CONSTRUCTION OR DEMOLITION ACTIVITIES. THE PERSON MAKING OR CAUSING AN

EXCAVATION TO BE MADE SHALL PROVIDE WRITTEN NOTICE TO THE OWNERS OF

THE ADJOINING BUILDING SHOULD BE PROTECTED. SAID NOTIFICATION SHALL BE

CONSTRUCTION, REMODELING AND DEMOLITION WORK. PROTECTION MUST BE PROVIDED FOR FOOTINGS, FOUNDATIONS, PARTY WALLS, CHIMNEYS, SKYLIGHTS AND ROOFS.

ADJOINING BUILDINGS ADVISING THEM THAT THE EXCAVATION IS TO BE MADE AND THAT

DELIVERED NOT LESS THAN 10 DAYS PRIOR TO THE SCHEDULED STARTING DATE OF THE

AFFILIATES, AS ADDITIONAL INSURED ON ALL POLICIES AND HOLD HARMLESS DOCUMENTS

INSURANCE OR SELF-INSURANCE MAINTAINED BY HUDSON ENGINEERING & CONSULTING

P.C., SHALL BE EXCESS ONLY AND SHALL NOT BE CALLED UPON TO CONTRIBUTE WITH

THIS INSURANCE. ISO ADDITIONAL INSURED ENDORSEMENT FORM NUMBER CG2010 1185 UNDER GL. COPIES OF THE INSURANCE POLICIES SHALL BE SUBMITTED TO HUDSON

13. OWNER SHALL INSURE THAT THE INSURANCE PROVIDED BY THE CONTRACTOR HIRED TO PERFORM THE WORK SHALL BE ENDORSED TO NAME HUDSON ENGINEERING &

CONSULTING, P.C., AND ANY DIRECTORS, OFFICERS, EMPLOYEES, SUBSIDIARIES, AND

AND SHALL STIPULATE THAT THIS INSURANCE IS PRIMARY, AND THAT ANY OTHER

ENGINEERING & CONSULTING, P.C., FOR APPROVAL PRIOR TO THE SIGNING OF THE

INSTALLATION & MAINTENANCE OF EROSION CONTROL:

MAINTENANCE (TO BE PERFORMED DURING ALL PHASES OF CONSTRUCTION)

SPREAD TOPSOIL EVENLY OVER AREAS TO BE SEEDED. HAND RAKE LEVEL.

ALL EROSION CONTROL MEASURES REMOVED AND GRASS ESTABLISHED.

14. INDUSTRIAL CODE RULE 753: THE CONTRACTOR SHALL NOTIFY ALL UTILITY COMPANIES 72 HOURS PRIOR TO THE START OF HIS OPERATIONS AND SHALL COMPLY WITH ALL THE LATEST INDUSTRIAL CODE RULE 753 REGULATIONS.

NOTIFY APPROPRIATE MUNICIPAL AGENCY HAVING JURISDICTION AT LEAST 5 DAYS PRIOR TO

INSTALL ALL EROSION CONTROL MEASURES PRIOR TO START OF CONSTRUCTION. CALL FOR

INSPECTION FROM THE APPROPRIATE MUNICIPAL AGENCY HAVING JURISDICTION AT LEAST 2

AFTER ANY RAIN CAUSING RUNOFF, CONTRACTOR TO INSPECT HAYBALES, ETC. AND REMOVE

CALL FOR INSPECTION FROM THE APPROPRIATE MUNICIPAL AGENCY HAVING JURISDICTION AT

BROADCAST 1.25 LB. BAG OF JONATHAN GREEN "FASTGROW" MIX OR EQUAL OVER AREA TO

CALL FOR INSPECTION FROM THE APPROPRIATE MUNICIPAL AGENCY HAVING JURISDICTION AT

TOPSOILING. CALL FOR INSPECTION FROM THE APPROPRIATE MUNICIPAL AGENCY HAVING

BE SEEDED. APPLY STRAW MULCH AND WATER WITHIN 2 DAYS OF COMPLETION OF

ANY EXCESSIVE SEDIMENT AND INSPECT STOCKPILES AND CORRECT ANY PROBLEMS WITH

INSPECTIONS SHALL BE DOCUMENTED IN WRITING AND SUBMITTED TO THE APPROPRIATE


OF HIS EMPLOYEES, SUBCONTRACTORS AND THEIR AGENTS AND EMPLOYEES, AND OTHER


4. ALL CONDITIONS, LOCATIONS AND DIMENSIONS SHALL BE FIELD VERIFIED AND THE


GENERAL NOTES:

OCATION MAP


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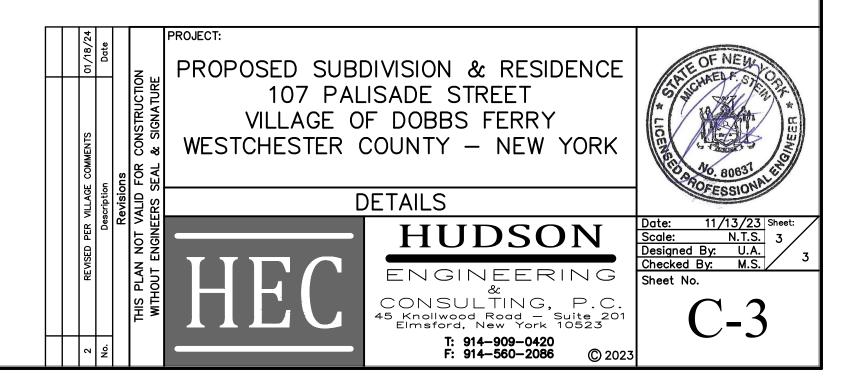


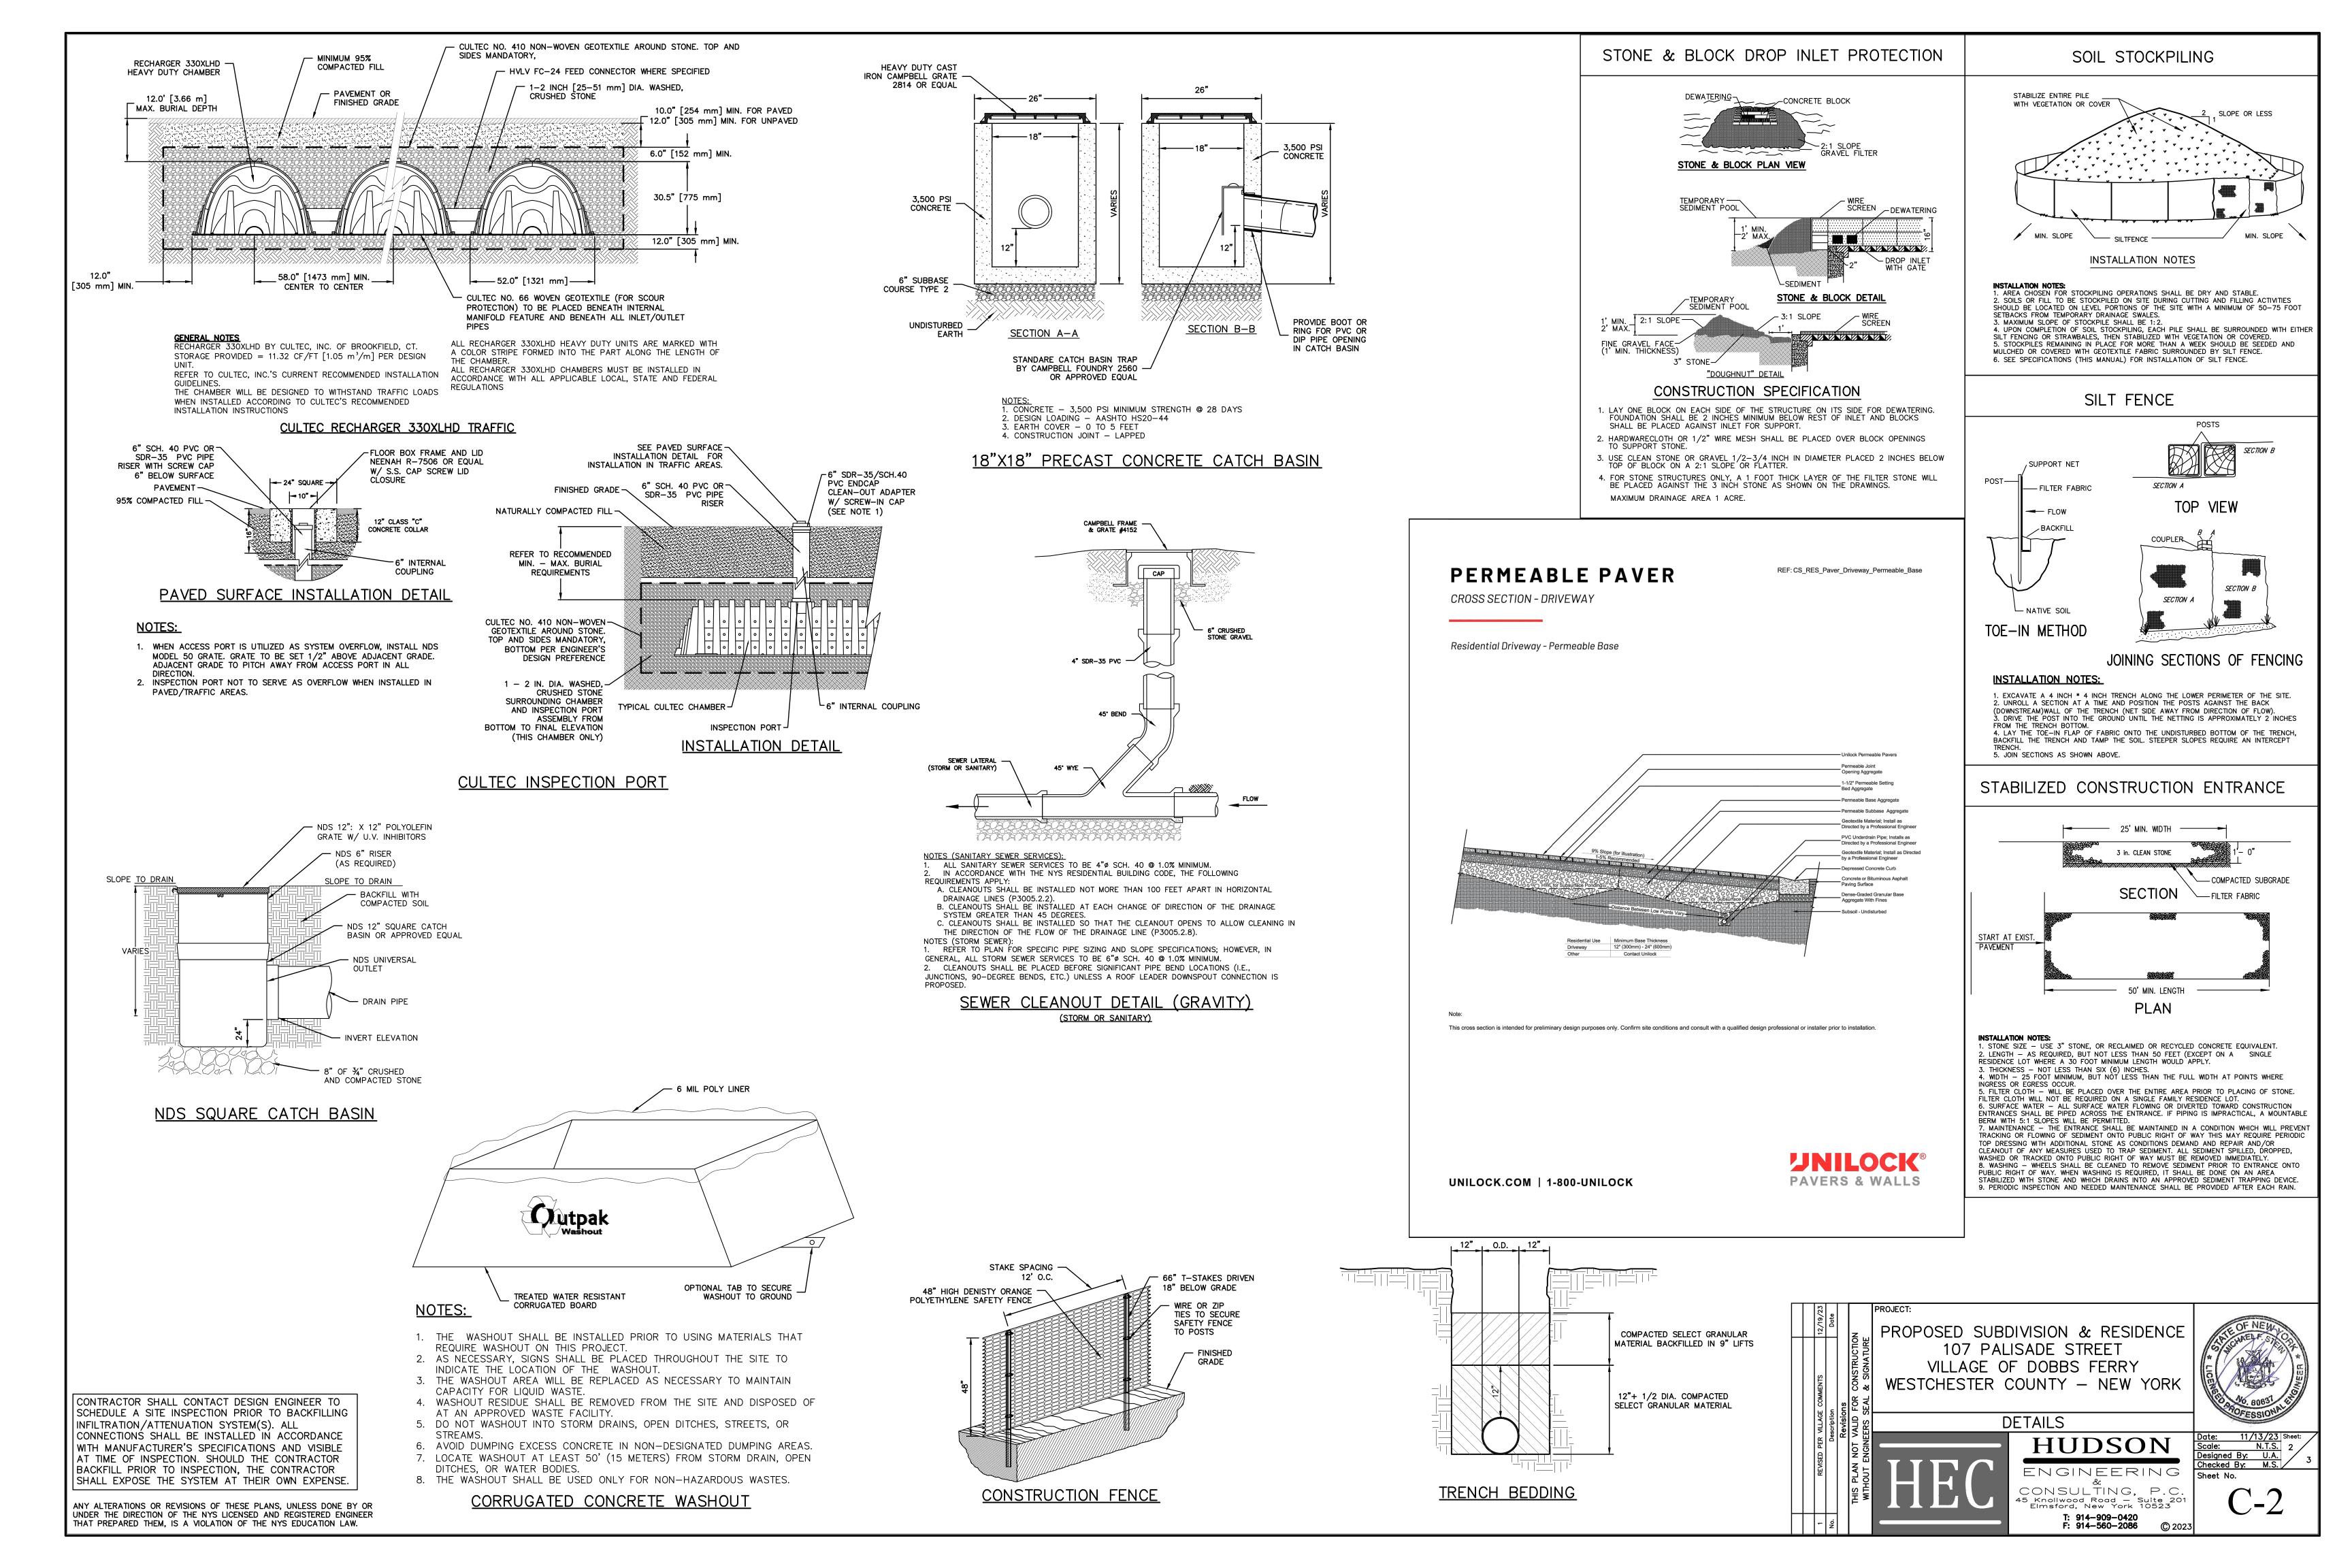


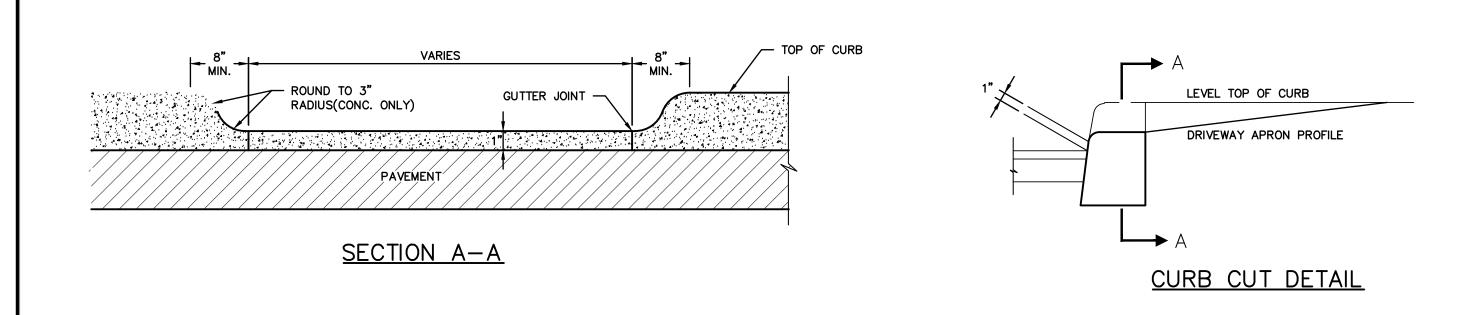

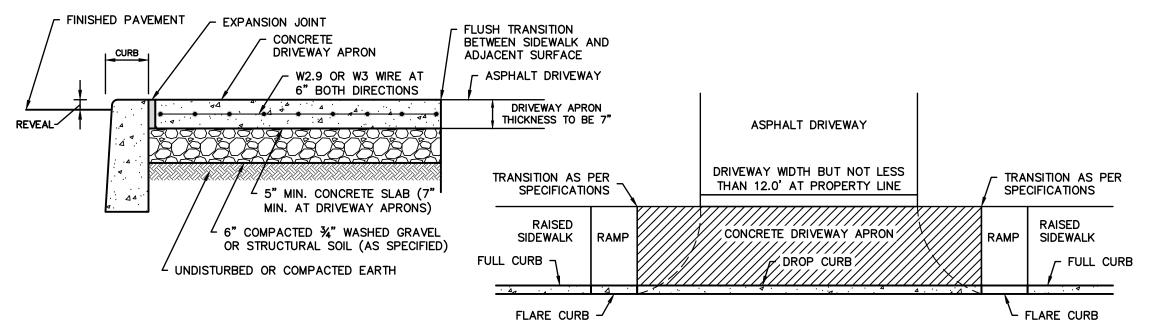CONCRETE DRIVEWAY APRON/DROP SIDEWALK



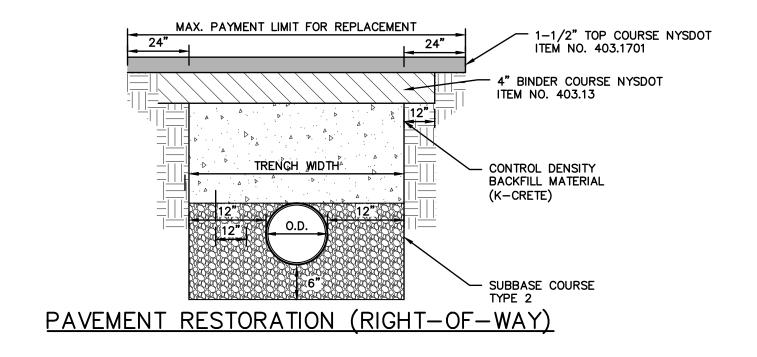

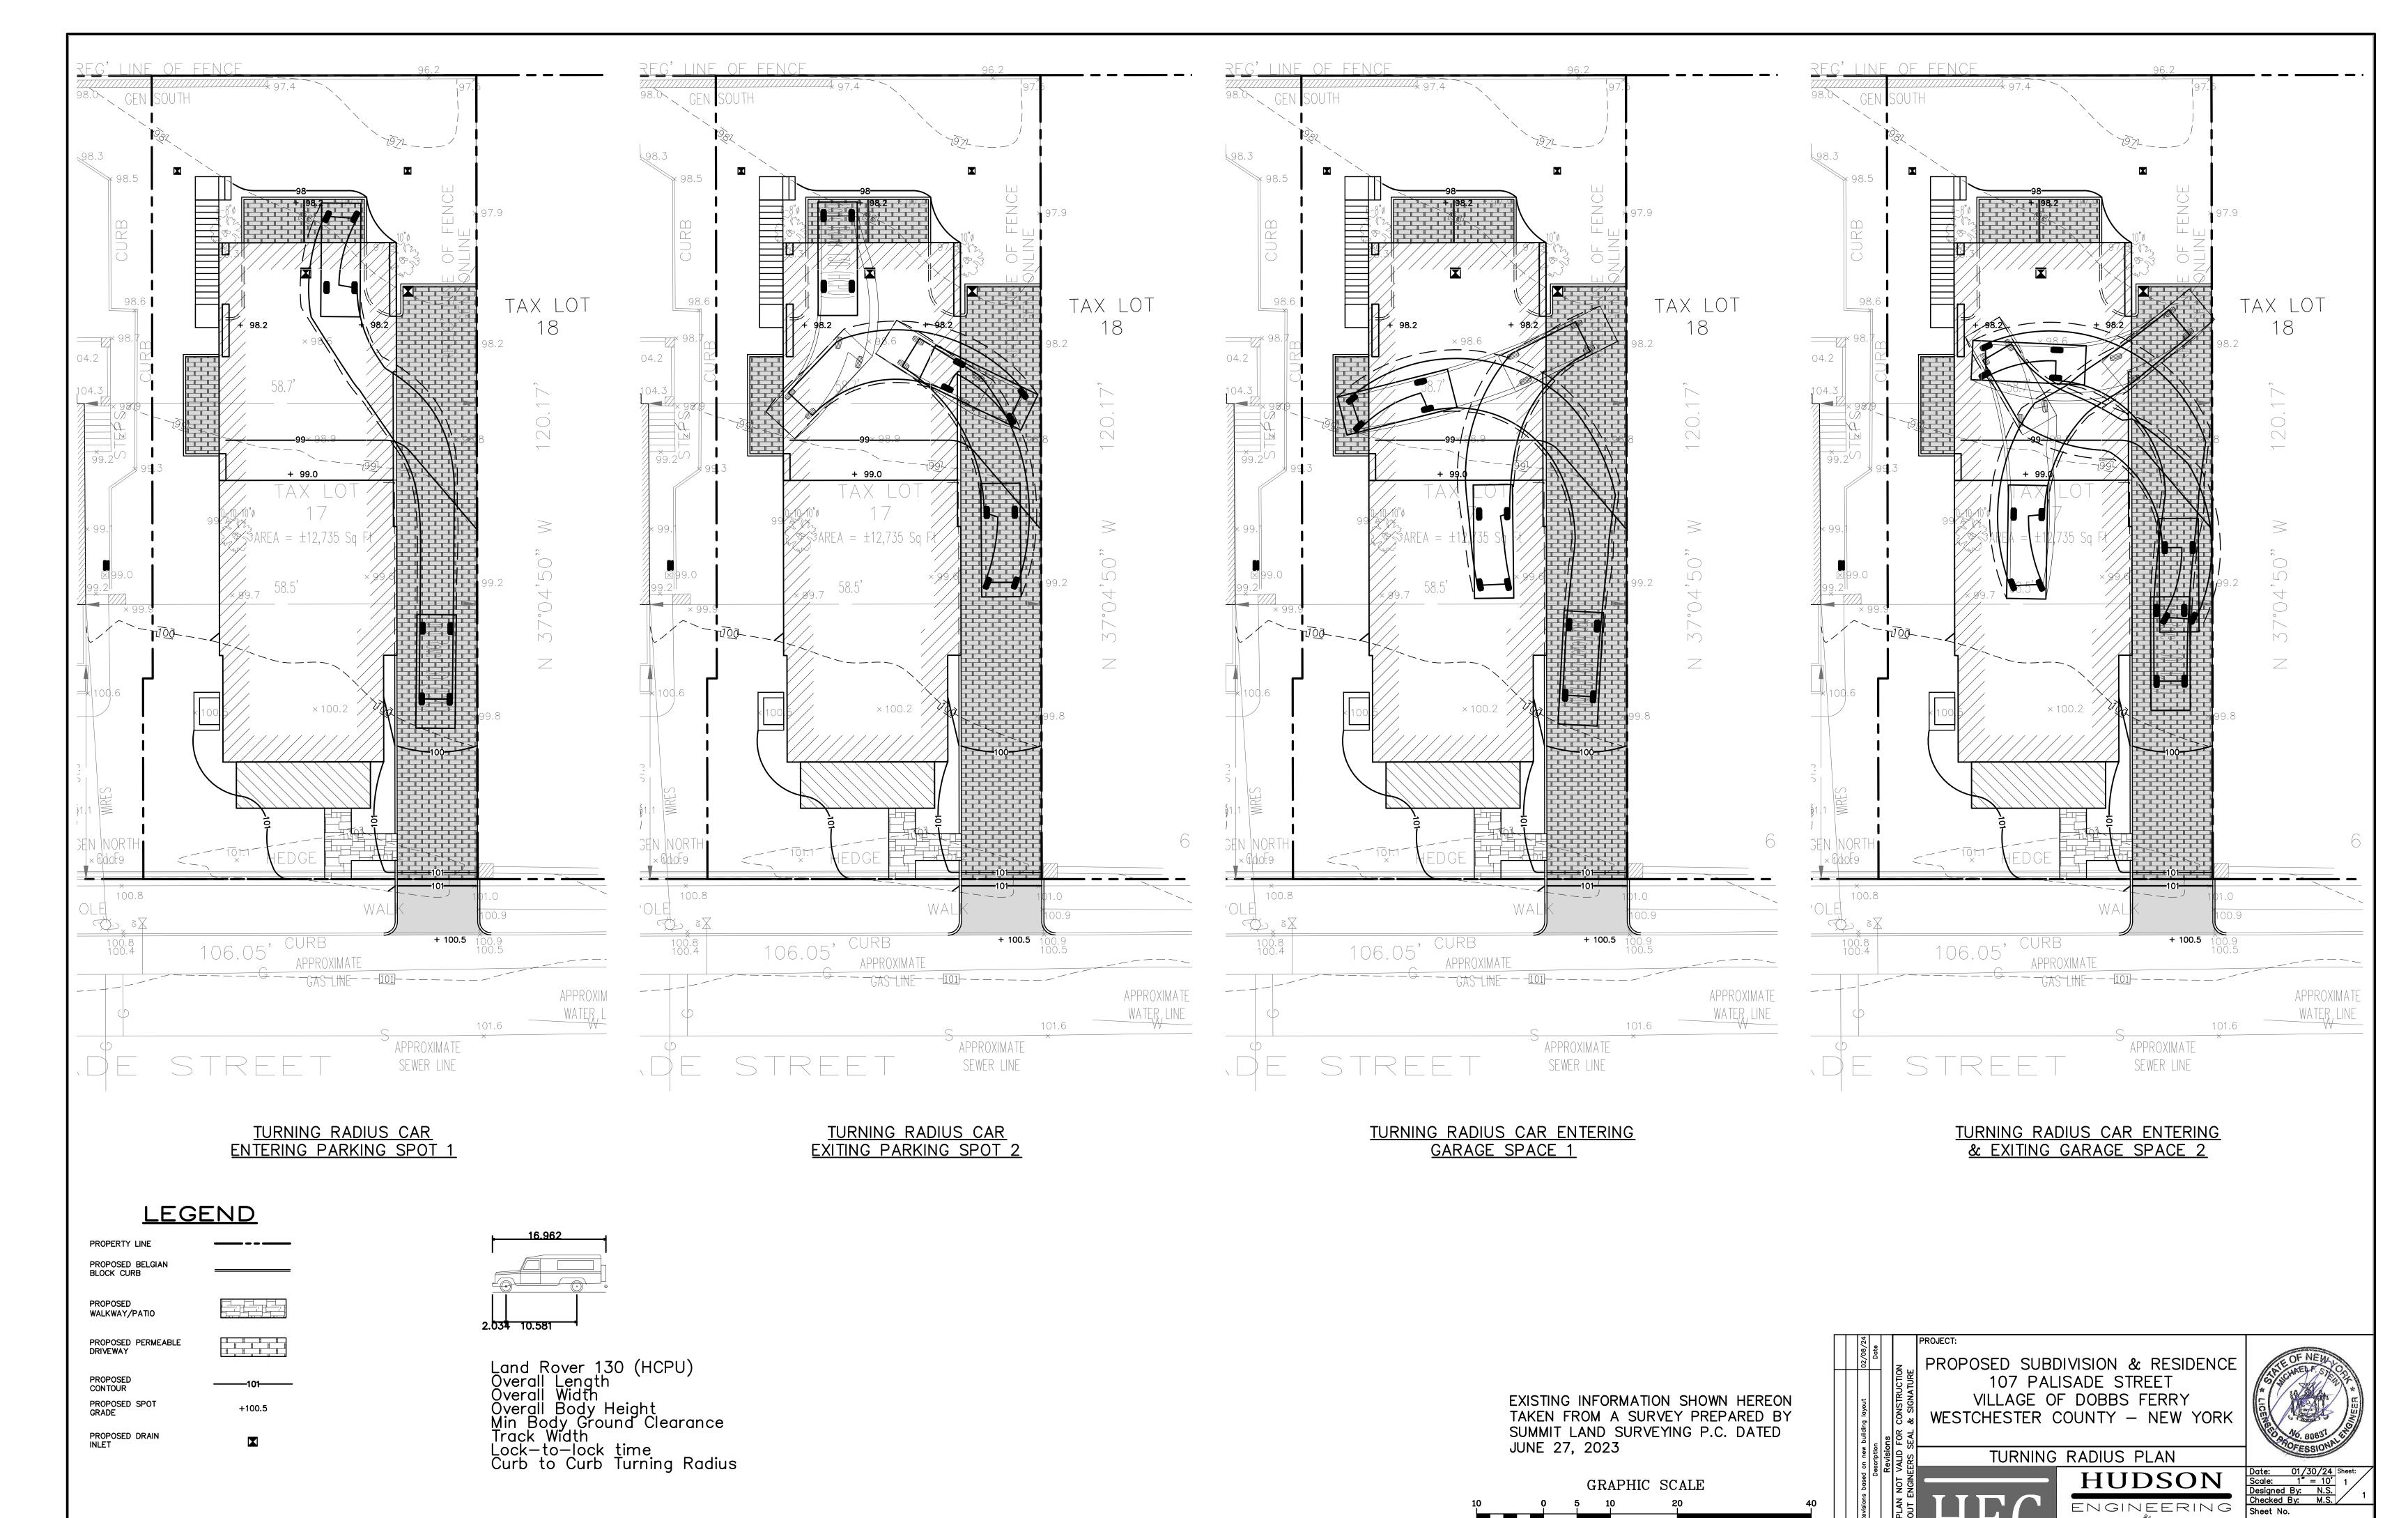

& CONSULTING, P.C. 45 Knollwood Road — Suite 201 Elmsford, New York 10523

T: 914-909-0420 F: 914-560-2086

(IN FEET)

1 inch = 10 ft.

TR-1

ANY ALTERATIONS OR REVISIONS OF THESE PLANS, UNLESS DONE BY OR UNDER THE DIRECTION OF THE NYS LICENSED AND REGISTERED ENGINEER THAT PREPARED THEM, IS A VIOLATION OF THE NYS EDUCATION LAW.