# RESIDENCES AT 11 LYMAN PLACE D O B B S F E R R Y , N Y 1 0 5 2 2 C H R I S T I N A G R I F F I N A R C H I T E C T 12 Spring Street, Hastings-on-Hudson, NY 10706



## GENERAL NOTES

- 1. These documents remain the exclusive property of the Architect, and may not be used for any purpose whatsoever without written consent of the Architect.
- 2. All construction shall comply fully with the 2020 Residential code of NYS, local building code, fire department regulations, and all other agencies having jurisdiction over project.
- 3. Approved stamped set of building plans must be present 14. All construction sites shall conform to the 2020 New on site for all inspections.
- 4. A current Westchester County licensed and insured contractor must be on file with current building permit until Certificate of Occupancy is issued. If contractor of record has been removed from the project, a stop work order will be issued untill a new Westchester County licensed and insured contractor is retained.
- 5. General Contractor shall carry property damage insurance, public liability insurance, workman's compensation, auto insurance, and general liability as required by Federal, State, and Local Codes and as Owner requires.
- 6. Licensed electrician to file separate electrical permit.
- 7. Licensed plumber to file separate plumbing permit. 8. All health, safety, fire, zoning and environmental
- regulations shall be adhered to at all times by the Owner and/or occupant.
- 9. The contractor shall become familiar with conditions of the site, and the work as shown on the construction documents, prior to submitting a bid for construction.
- 10. Contractors shall coordinate all work procedures and working hours with local authorities, neighborhood associations, and any other governing authorities.
- 11. The contractor shall be responsible for providing all labor and materials to complete the project, in accordance with the construction documents, tested and ready for owner's use.
- 12. All indicated Survey material is for general reference only. The Architect assumes no responsibility for the

accuracy or the correctness of any of the indicated material.

- 13. Contractors shall be responsible for protection of all existing and new conditions and materials with and adjacent to the construction area. Any damage caused by the execution of the work indicated or implied herein shall be repaired or replaced to the Owner's satisfaction.
- York State Property Maintenance Code. All rubbish garbage and construction debris shall be disposed of in an onsite dumpster or removed off site immediately. Materials shall be stacked in orderly fashion as to not create a blight on the community. The village right of way must be kept clear and maintained at all times.
- 15. General contractor shall be responsible for the removal of construction debris, rubbish and offsite disposal in a responsible manner.
- permits, and pay all necessary permit fees required by the local building department and all other agencies having jurisdiction over the project, such as plumbing, electrical & HVAC, except for the building permit, which shall be obtained by the Architect. The contractor shall obtain the certificate of occupancy for the project when construction is complete.
- 17. Contractor shall keep work site free from debris and accumulated refuse, and shall have sole responsibility for protecting all dangerous areas from entry by unauthorized parties.
- 18. Drawings may be rough scaled for estimating and general purposes, but are not to be scaled for construction locations, dimensions, or any other purposes. Dimensions shown shall govern over measurements scaled from plans. Wall dimensions are given to finished surfaces. Contractor to consult with the Architect for questions regarding final dimensions and locations.
- 19. All dimensions and conditions shown and assumed on the drawings must be verified at the site by contractor

- before ordering any material or doing any work.
- 20.Contractor is to design and install adequate and code approved shoring and bracing where needed to safely complete structural work. Contractor to assume full and 28. The contractor shall do all the cutting, fitting & patching sole responsibility for structural adequacy of the shoring that may be required to make several parts of the work and for any injuries, damages, cracks, or defects caused come together properly, and to fit his work, and/or by shoring or bracing, and shall repair all such damage receive, or be received by the work of others, as shown, at his sole expense. or as reasonably implied on the drawings.
- 21. The Architect is not responsible for workmanship, construction methods, or any omissions or derivations from the drawings during construction.
- 22.Materials and products indicated on drawings shall be installed in accordance with manufacturer's requirements
- 23. The drawings and notes are intended to be complete. Architect. Should anything be omitted from the drawings necessary to the proper construction of the work herein described, it 31.If blown or sprayed insulation used, Installer of insulation 16. The contractor shall obtain all inspections, approvals and shall be the duty of the contractor to notify the Architect. to submit insulation certification to include the installed The builder shall visit the site and inform the Architect of thickness of the area covered and R-value of the any discrepancies of field conditions that may interfere installed thickness shall be listed on the certificate. The insulation installer shall sign, data and post the certificate b) Removal of all labels from glass, fixtures, and with the total completion of all work included within the contract and verify all conditions prior to the ordering of in a conspicuous location on the job site per N1101.5 of the 2020 Residential Code of New York State and materials and the start of construction. submit an original signed copy for the Building Departments records.
  - 24.Minor details not usually shown or specified, but necessary for proper and acceptable construction,
  - installation or operation of any part of the work shall be 32. All work shall be guaranteed for one year after final included in the work the same as specified or indicated. payment. The general contractor is to furnish written guarantees on his work and all subcontractors work 25. The contractor shall supervise and direct the work using against defects resulting from the use of inferior his best skill and attention, he shall be solely responsible materials, equipment, or workmanship as determined for all construction means, methods, sequences and solely by the Architect. All such defects are to be procedures and for coordination of all portions of the replaced or repaired, complete with labor and materials, 36. Finish materials and paint colors shall be reviewed and work at no cost to owner.
  - 26. The use of the words "provide" or "provided" in where required.
  - 33. Substitutions of equipment or materials other than those 37. The Architect assumes no responsibility for the accurac connection with any item specified is intended to mean shown on the drawings or in the specifications shall be or correctness of any material or drawings prepared by that such item be furnished and installed and connected made only upon approval of the Architect or owner as others and provided to the Architect. noted on the drawings or in these specifications. The 27.Contractor shall maintain a sealed enclosure between contractor shall submit his substitution for approval work area and other areas of the residence. In addition, before releasing any order for fabrication and/or

| the contractor shall be responsible to (a) protect all |
|--|
| interior spaces from the area of renovation, and (b)   |
| broom sweep all areas at end of each work day.         |


- 29.New and existing work shall come together in a
- seamless fashion.All new or modified surfaces shall be finished including, but not limited to taping, spackling and priming.
- 30. All insulation to comply with the Energy Efficiency Certificate required by 401.3 2020 Energy Conservation Construction Code of New York, prepared by the

shipments. The Architect reserves the right to disapprove such substitution, provided in his sole opinion, the item offered is not equal or detailed on the drawings, which requires any redesign of the structure, partitions, piping, redesign, and all new drawings and detailing required therefore shall, with the approval of the Architect, be prepared by the contractor at his own expense

- 34.All work shall be installed so that all parts required are readily accessible for inspection, operation, maintenanc and repair. Minor deviations from the drawings may be made to accomplish this, but changes of magnitude sha not be made without prior written approval from the Architect
- 35.Upon completion of the work, the entire project is to be completely cleaned and the site restored to existing condition, including but not limited to the following.
- Complete sweeping of all areas, and removal of all rubbish and debris, except that caused by the owner or others doing N.I.C. work.
- equipment, etc. and spray cleaning of glass and mirrors.
- c) Removal of stains, and paint from glass, hardware, finished flooring, cabinets, etc.
- d) Final cleaning of all chrome and aluminum metal work.
- e) Restoration of property by returning shrubs to origina locations, filling of all ruts and raked topsoil and repairs to damaged blacktop.
- approved by the homeowner.

|    |  | TAB  | LE R4   | 02.1.2                                      |  |  |  |
|----|--|--|---|---|--|--|--|
|    | Energy Notes R-Values & U-Factors<br>2020 Residential code of NYS  | CLIMAT<br>ZONE   |   | IESTRATIO                                   |  |  |  |
|    | Amended by the NY Stretch Energy Code 2020   | 4A   |   | 0.27  |  |  |  |
|    | Climate Zone 4A  |  | М   | ASS WALI                                    |  |  |  |
| סר | Required Proposed  |  |   | R-VALUE                                     |  |  |  |
| IC | Ceiling R-49 R-49  |  |   |   |  |  |  |
|    | Wall R-21 R-21   |  |   | 15/20                                       |  |  |  |
|    | Glazing 0.27 U value 0.27 U value  |  | •   |   |  |  |  |
| ce | Floor R-30 R-19  |  |   | are minimu                                  |  |  |  |
| r  | or R-19 per footnote (g)<br>Design Criteria:<br>5750 Degree Days<br>15% Maximum Glazing<br><u>R402.2.1 CEILINGS WITH ATTIC SPACES</u><br>* Installing R-38 over 100% of the ceiling area requiring<br>insulation shall be deemed to satisfy the requirement for<br>R-49 insulation wherever the full height of uncompressed<br>R-38 insulation extends over the wall top plate at eaves.<br><u>R402.2.2 CEILINGS WITHOUT ATTIC SPACES</u><br>Where Section R402.1.2 requires insulation R-values<br>greater than R38 in the ceiling and the design of the<br>roof/ceiling assembly does not allow sufficient space for the<br>required insulation, the minimum required insulation R-value<br>for such roof/ceiling assemblies shall be R38. Insulation<br>shall extend over the top of the wall plate to the outer edge | b. Ir<br>b. Ir<br>c. T<br>d. M<br>ir<br>e. 1<br>f. F<br>f. F<br>g. A | ne label o<br>pecified i<br>nt. (interm<br>f R-10 in:<br>f R-10 in:<br>f R-10 conti<br>Aass wall:<br>nsulation<br>5/19 mea<br>ne basem<br>c-10 conti<br>age insul<br>equired to<br>Nternative | or design th<br>n the table<br>nediate frar |  |  |  |
| -  | of such plate and shall not be compressed. This reduction<br>of insulation from the requirements of Section R402.1.2<br>shall be limited to 500 SF or 20% of the total insulated<br>ceiling area, whichever is less.   |  |   |   |  |  |  |
| aı | <u>Certification</u><br>I, Christina Griffin, Architect A.I.A., hereby states that I have<br>prepared these plans and specifications to the best of my   |  |   | WIND D                                      |  |  |  |
| сy | knowledge in compliance with all the requirements of the 2020 Residential code of NYS.   | GROUND<br>SNOW<br>LOAD   | SPEED<br>(MPH)  | TOPO<br>EFFECTS                             |  |  |  |


| INSU   | INSULATION AND FENESTRATION REQUIREMENT BY COMPONENT                          |                                 |                                   |                               |                             |                        |                         |                                    | NT   |   | DATES                   |                               |   |
|--|---|---------------------------------|-----------------------------------|-------------------------------|-----------------------------|------------------------|-------------------------|------------------------------------|--|---|-------------------------|-------------------------------|---|
|  | TABLE R402.1.2 2020 NY ECC AMENDED BY NY STRETCH ENERGY CODE                  |                                 |                                   |                               |                             |                        |                         |                                    |  |   | PLANN                   | NING BOARD SUBMISSION 9-14-23 |   |
| CLIMATE FENESTRATION SKYLIGHT GLAZED CEILING WOOD FRAME<br>ZONE U-FACTOR <sup>h</sup> U-FACTOR <sup>h</sup> GLAZED CEILING WOOD FRAME<br>FENESTRATION R-VALUE WALL <sup>b,c</sup><br>SHGC <sup>h</sup> R-VALUE |   |                                 |                                   |                               |                             |                        |                         |                                    | PLANN  | NING BOARD SUBMISSION10-20-23NING BOARD SUBMISSION1-18-24NING BOARD SUBMISSION3-21-24 |                         |                               |   |
| 4A   | 0.27  |                                 | 0.50                              |                               | 0.40                        |                        | 49                      | Э                                  | 21 <sup>int</sup> .<br>21 <sup>or</sup> 20+5 |   |                         |                               |   |
|  | MASS W  | ALId                            | FLOOF                             |                               | BASEME                      | NT                     | SLAB <sup>f</sup> R     |                                    |  | AWL SPA   |                         | LIS                           | Γ of DRAWINGS   |
|  | R-VAL   |                                 | R-VALU                            |                               | WALL <sup>®</sup><br>R-VALU |                        | & DE                    |                                    |  | WALL <sup>®</sup><br>R-VALUE  |                         | TITLE                         | GENERAL NOTES,  |
|  | 15/20   |                                 | 30 <sup>g</sup>                   | 1                             | 15/19                       |                        | 10, 4FT                 | ( d)                               |  | 15/19   |                         | SHEET                         | CLIMATIC & GEOGRAPHIC   |
|  | /alues are mini   |                                 |                                   |                               |                             |                        |                         |                                    |  |   |                         |                               | CRITERIA, DATES, LIST OF<br>DRAWINGS                                      |
| spe<br>b. Int.<br>of F   | e label or desig<br>ecified in the ta<br>(intermediate<br>R-10 insulation     | ble.<br>framings) de            | enotes stan                       | dard framinç                  | g 16 inches o               | on center              | . Headers               | shall be ins                       | sulated with                                 | h a minim   | um                      | S-1                           | SITE PLAN, ZONING COMPLIANCE,<br>LOCATION MAP, FLOOR AREA<br>CALCULATIONS |
| R-1<br>d. Ma   | e first value is<br>13 cavity insula<br>iss walls shall I<br>ulation is on th | tion plus R-<br>e in accorda    | 10 continuo<br>ance with S        | us insulation<br>ection R402  | n.                          |                        |                         |                                    |  |   | eans                    | S-2                           | PHOTOS OF EXISTING CONDITIONS<br>& NEIGHBORING PROPERTIES                 |
| the<br>f. R-1  | the basement wall. S-3 STREETVIEW OF PROPERTY                                 |                                 |                                   |                               |                             |                        |                         |                                    |  |   |                         |                               |   |
| req<br>g. Alte   | uired to extend<br>ernatively, inst   | l below the s<br>lation suffici | slab.<br>ent to fill th           | e framing ca                  | avity and pro               | viding no              | t less than             | an R-value                         | e of R-19.                                   |   |                         | S-4                           | EXTERIOR LIGHTING PLAN  |
| h. The   | e fenestration  | J-factor colu                   | ımn exclude                       | es skylights.                 | The SHGC                    | column a               | applies to a            | ll glazed fe                       | enestration                                  |   |                         | S-5                           | SKY EXPOSURE PLANE DIAGRAMS   |
|  | DES   | ICN R                           | EOLIII                            | SEME                          | NTS fo                      | r tho                  | 2020                    | RESIL                              | DENIT  | ΤΔΤ   |                         | L-1                           | LANDSCAPING PLAN  |
|  |   |                                 | -                                 |                               | ORK S                       |                        |                         |                                    |  | IAL   |                         | M-1-M-3                       | EXTERIOR MATERIAL & COLOR   |
|  |   |                                 |                                   |                               |                             |                        |                         |                                    |  |   |                         |                               | SCHEME 3D VIEW & AERIAL VIEW  |
|  |   | G                               | EUGľ                              | KAPHI                         | IC DES                      | NGN                    | CKII                    | EKIA                               |  |   |                         | A-1. A-2                      | EXTERIOR ELEVATIONS   |
|  | WIN   | D DESIGN                        |                                   |                               | SUBJECT -                   | TO DAMAG               | GE FROM                 |                                    |  |   |                         |                               | DEDA  |
|  | SPEED TOPO<br>(MPH) EFFEC   |                                 | - WIND<br>BORNE<br>DEBRIS<br>ZONE | SEISMIC<br>DESIGN<br>CATAGORY | WEATHERING                  | FROST<br>LINE<br>DEPTH | TERMITE                 | ICE SHIELD<br>UNDERLAY<br>REQUIRED | FLOOD<br>HAZARDS                             | AIR<br>FREEZING<br>INDEX  | MEAN<br>ANNUAL<br>TEMP. |                               | STEHED ARCH   |
|  | 120- NO<br>130<br>MPH   | YES                             | NO                                | В                             | SEVERE                      | 42"                    | MODERATE<br>TO<br>HEAVY | YES                                | N/A  | 2000  | 51.6                    |                               | TVIL 17869<br>OF NEW  |
|  |   |                                 |                                   |                               |                             |                        |                         |                                    |  |   |                         |                               |   |

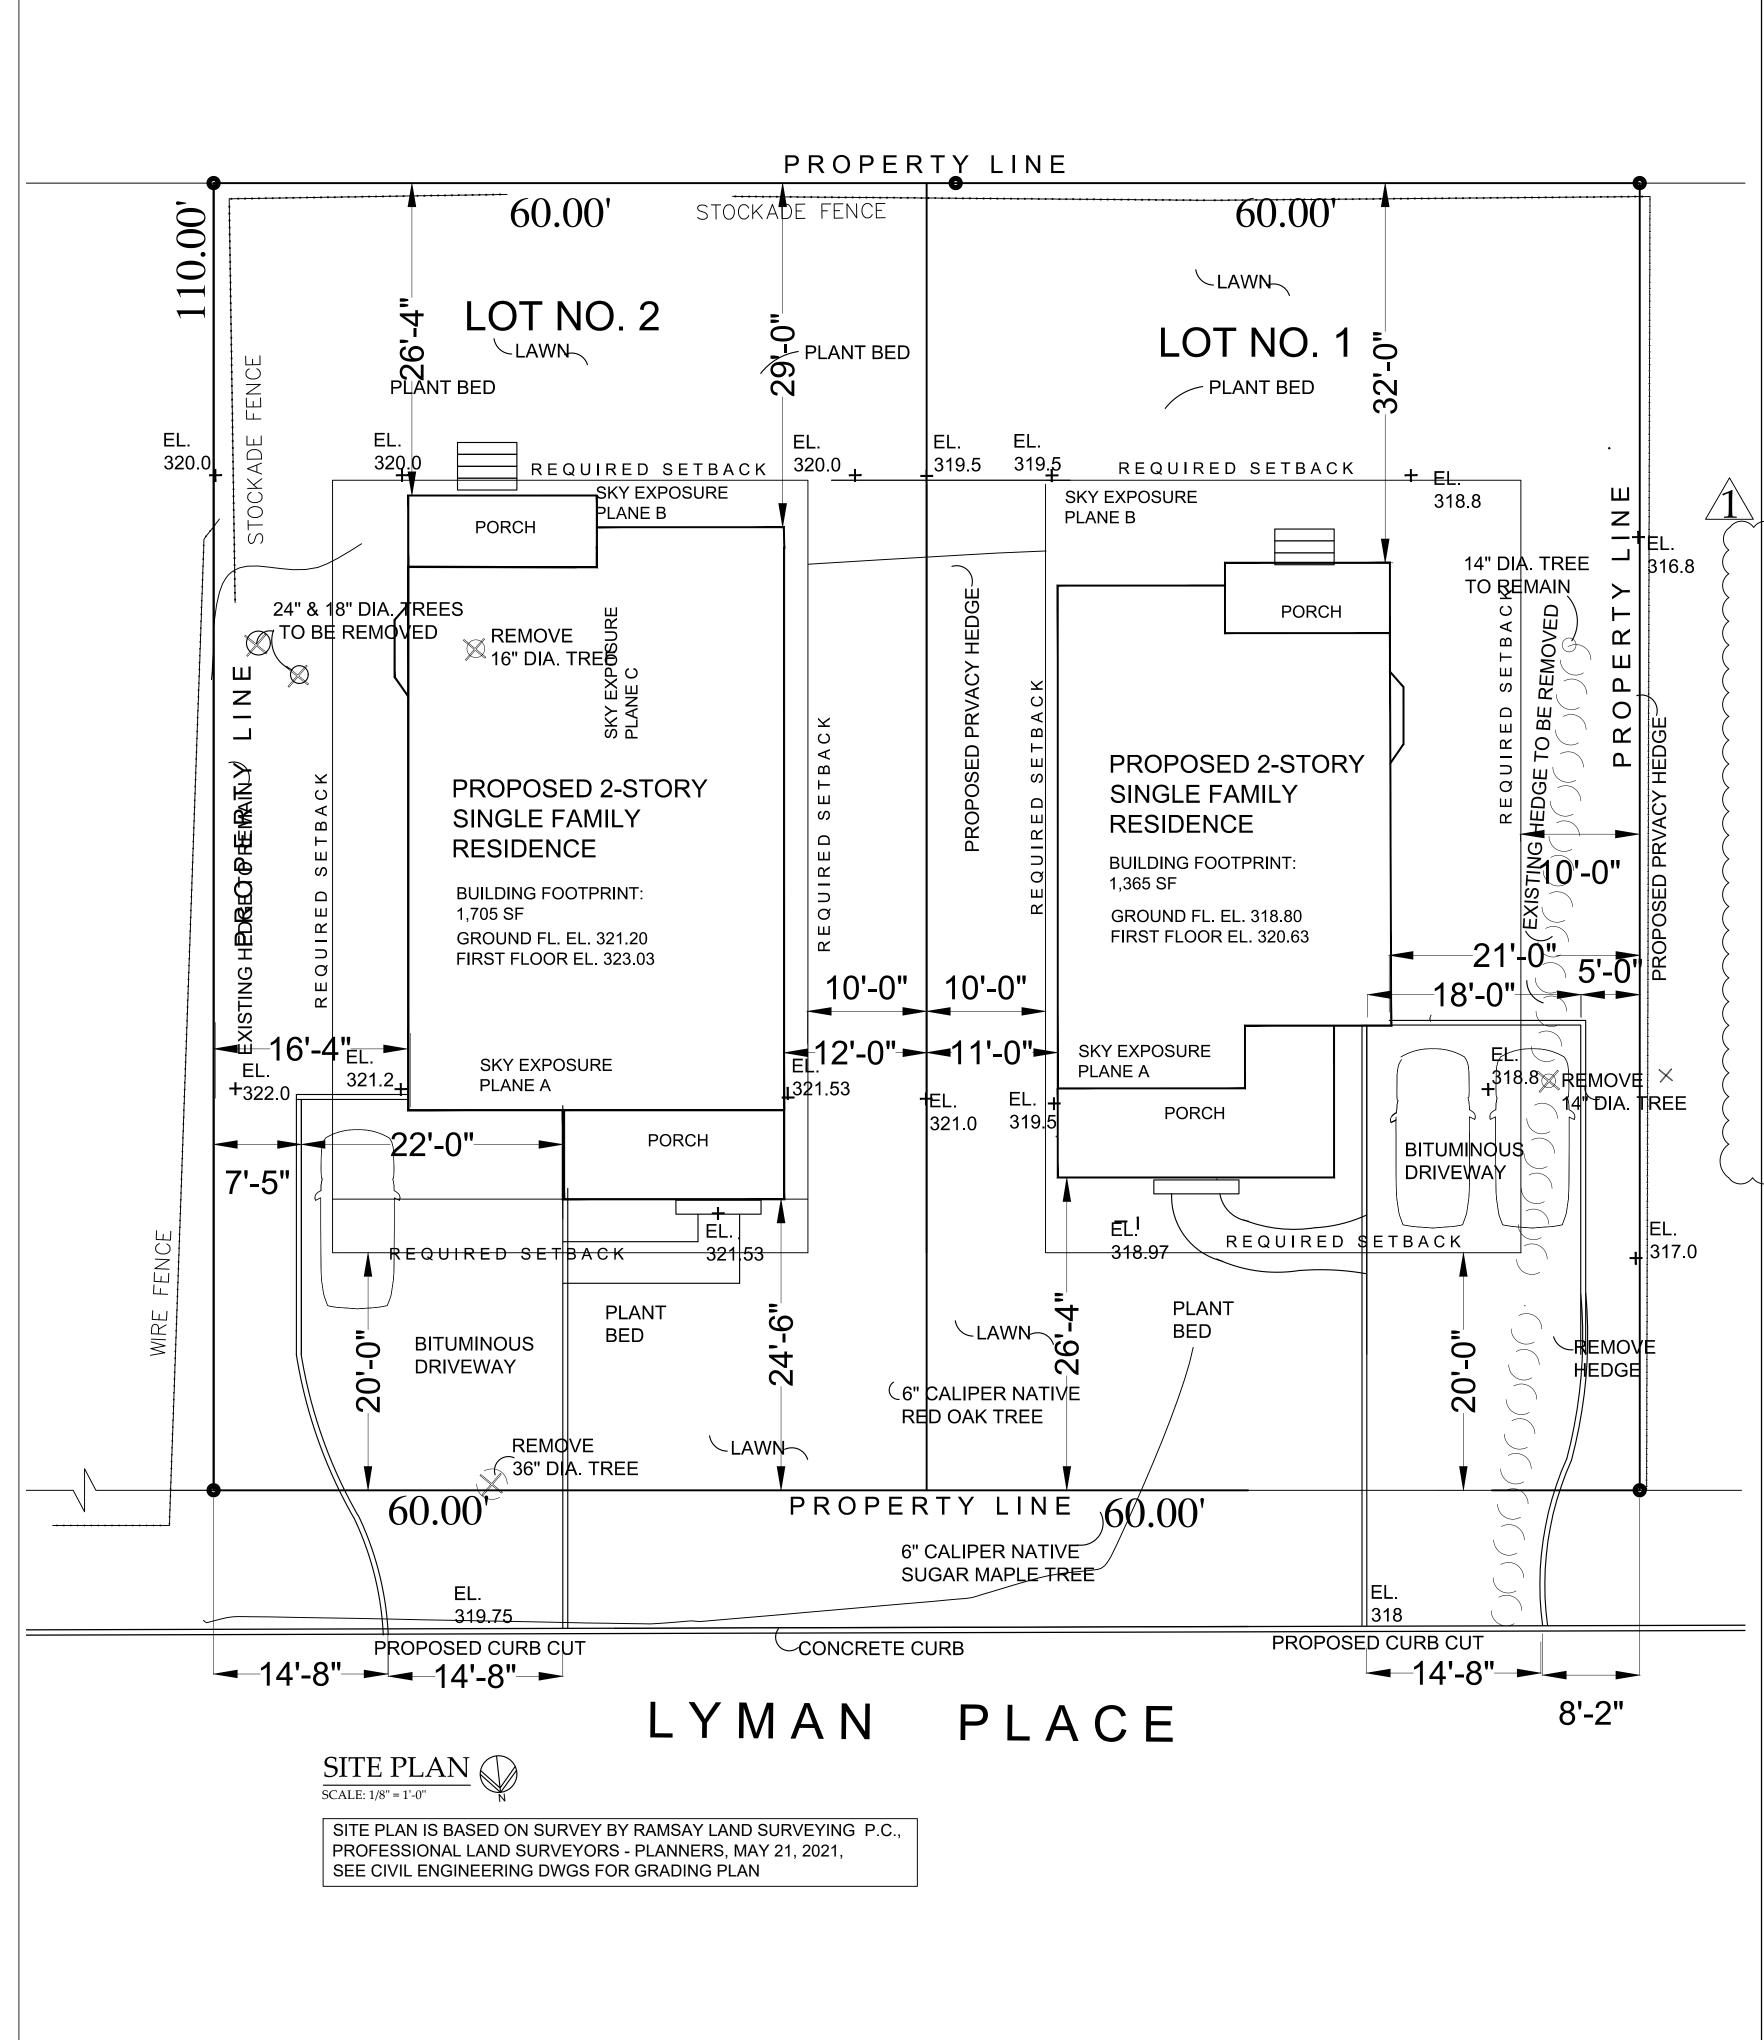

| DATA FOR ZONING COMPLIANCE  |   |                      |                      |                      |  |  |
|---|---|----------------------|----------------------|----------------------|--|--|
| 11 LYMAN PLACE, DOBBS FERRY, NY: TAX MAP: 3.60-22-3 & 3.60-22-4 ZONING DISTRICT: OF-6 |   |                      |                      |                      |  |  |
|   | REQUIRED  | EXISTING             | PROF                 | POSED                |  |  |
|   |   |                      | LOT NO. 1            | LOT NO. 2            |  |  |
| PRINCIPAL USE PERMITTED   | ONE-FAMILY RESIDENCE                                    | ONE-FAMILY RESIDENCE | ONE-FAMILY RESIDENCE | ONE-FAMILY RESIDENCE |  |  |
| MIN. LOT SIZE   | 5,000 SF  | 6,600SF              | 6,600 SF             | 6,600 SF             |  |  |
| MIN. LOT WIDTH  | 50 FT   | 60 FT                | 60 FT                | 60 FT                |  |  |
| MIN. LOT DEPTH  | 100 FT  | 110 FT               | 110 FT               | 110 FT               |  |  |
| MAX. LOT COVERAGE<br>(INCLUDES BUILDING, PORCH,<br>GARAGE, SHED)                      | 27% (OR 20% SLIDING SCALE)<br>27% x 6,600 SF = 1,782 SF |                      | 19.4%<br>1,286SF     | 25.1%<br>1,659 SF    |  |  |
| MAX. IMPERVIOUS COVERAGE<br>(INCL. PATIO)   | 54% (OR 40% SLIDING SCALE)                              |                      | 35.8%                | 41.4%                |  |  |
| MIN. FRONT YARD   | 20 FT   |                      | 26.3 FT              | 24.5 FT              |  |  |
| MIN. REAR YARD  | 25 FT   |                      | 32 FT                | 26.3 FT              |  |  |
| MIN. SIDE 1 YARD  | 10 FT   |                      | 11 FT                | 12 FT                |  |  |
| MIN. SIDE 2 YARD  | 10 FT   |                      | 21 FT                | 16.3 FT              |  |  |
| MIN. COMBINED SIDE YARDS  | 20 FT   |                      | 32 FT                | 28.3 FT              |  |  |
| MAXIMUM RIDGE HEIGHT  | 35 FT FOR SLOPE > 0.30                                  |                      | 33.31 FT             | 34.187 FT            |  |  |
| MAXIMUM EAVE HEIGHT   | 28 FT DEFAULT   |                      | 20.68 FT             | 21.56 FT             |  |  |

| FLOOR AREA C               | ALCULATIONS                | COVERAC                      | GE CALC                             | CULATI  | ONS  |  |
|----------------------------|----------------------------|------------------------------|-------------------------------------|---|--|--|
| LOT NO. 1                  | LOT NO. 2                  |                              | REQUIRED                            | PROPO   | DSED   |  |
| FIRST FLOOR : 1,064SF      | FIRST FLOOR : 1,216 SF     |                              |                                     | LOT NO. 1   | LOT NO. 2  |  |
| SECOND FLOOR: 1,146 SF     | SECOND FLOOR: 1,470 SF     |                              | MIN. 5,000 SF                       | 6,600 SF  | 6,600 SF   |  |
| BASEMENT: UNFINISHED       |                            |                              | MAX. 27% X<br>6,600 SF=<br>1,782 SF | 1,286 SF<br>(INCL. 139SF<br>PORCH> 75SF,<br>+ REAR PORCH) | 1,659 SF<br>(INCL. 65SF<br>PORCH> 75SF<br>+REAR PORCH) |  |
|                            |                            | FRONT PORCH                  | MAX. 75 SF                          | 75 SF<br>(214 ACTUAL)                                     | 75 SF<br>(140 ACTUAL)                                  |  |
|                            |                            | WALKS & STONE STEPS          |                                     | 82.37 SF  | 92 SF  |  |
|                            |                            | DRIVEWAY & CURBS             |                                     | 924 SF  | 911SF  |  |
| TOTAL FLOOR AREA: 2,210 SF | TOTAL FLOOR AREA: 2,686 SF | TOTAL IMPERVIOUS<br>COVERAGE | 54%<br>OR 40%<br>SLIDING SCALE      | 2,367.37 SF /<br>6.600 SF =<br>35.8%                      | 2,737 SF /<br>6,600 SF =<br>41.4 %                     |  |
|                            |                            |                              |                                     |   |  |  |


## LOCATION MAP

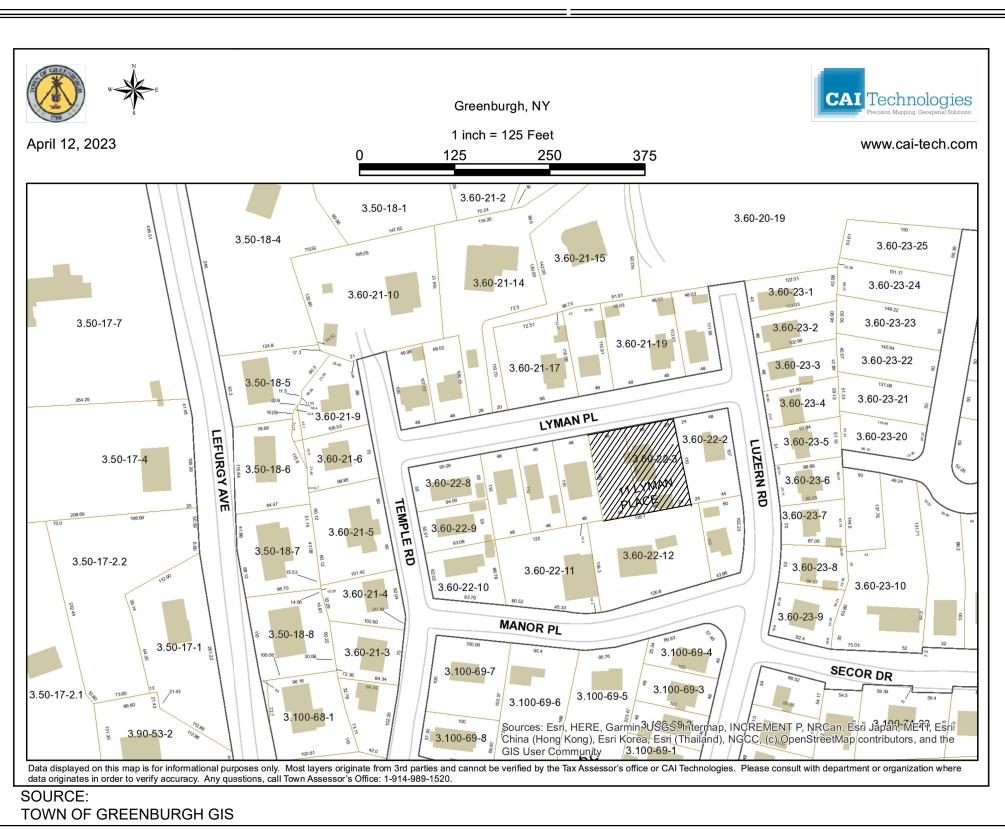



12 SPRING STREET HASTINGS.on.HUDSON N.Y. 10706 914.478.0799 cg@cgastudio.com christinagriffinarchitect.com

10522 S Z Ш K R K Y, U Z RESIDEN **1** OBBS  $\square$ Dates BUILDING PERMT SUBMISSION 7-7-23 BUILDING PERMT SUBMISSION 9-6-23 PLANNING BOARD SUBMISSION 9-14-23 PLANNING BD SUBMISSION 11-21-2 PLANNING BD SUBMISSION 12-6-23 PLANNING BD SUBMISSION 1-18-24 PLANNING BD SUBMISSION3-21-24 REDA Drawing Title: SITE PLAN LOCATION MAP ZONING DATA Scale: As Shown Sheet Number: **S**-

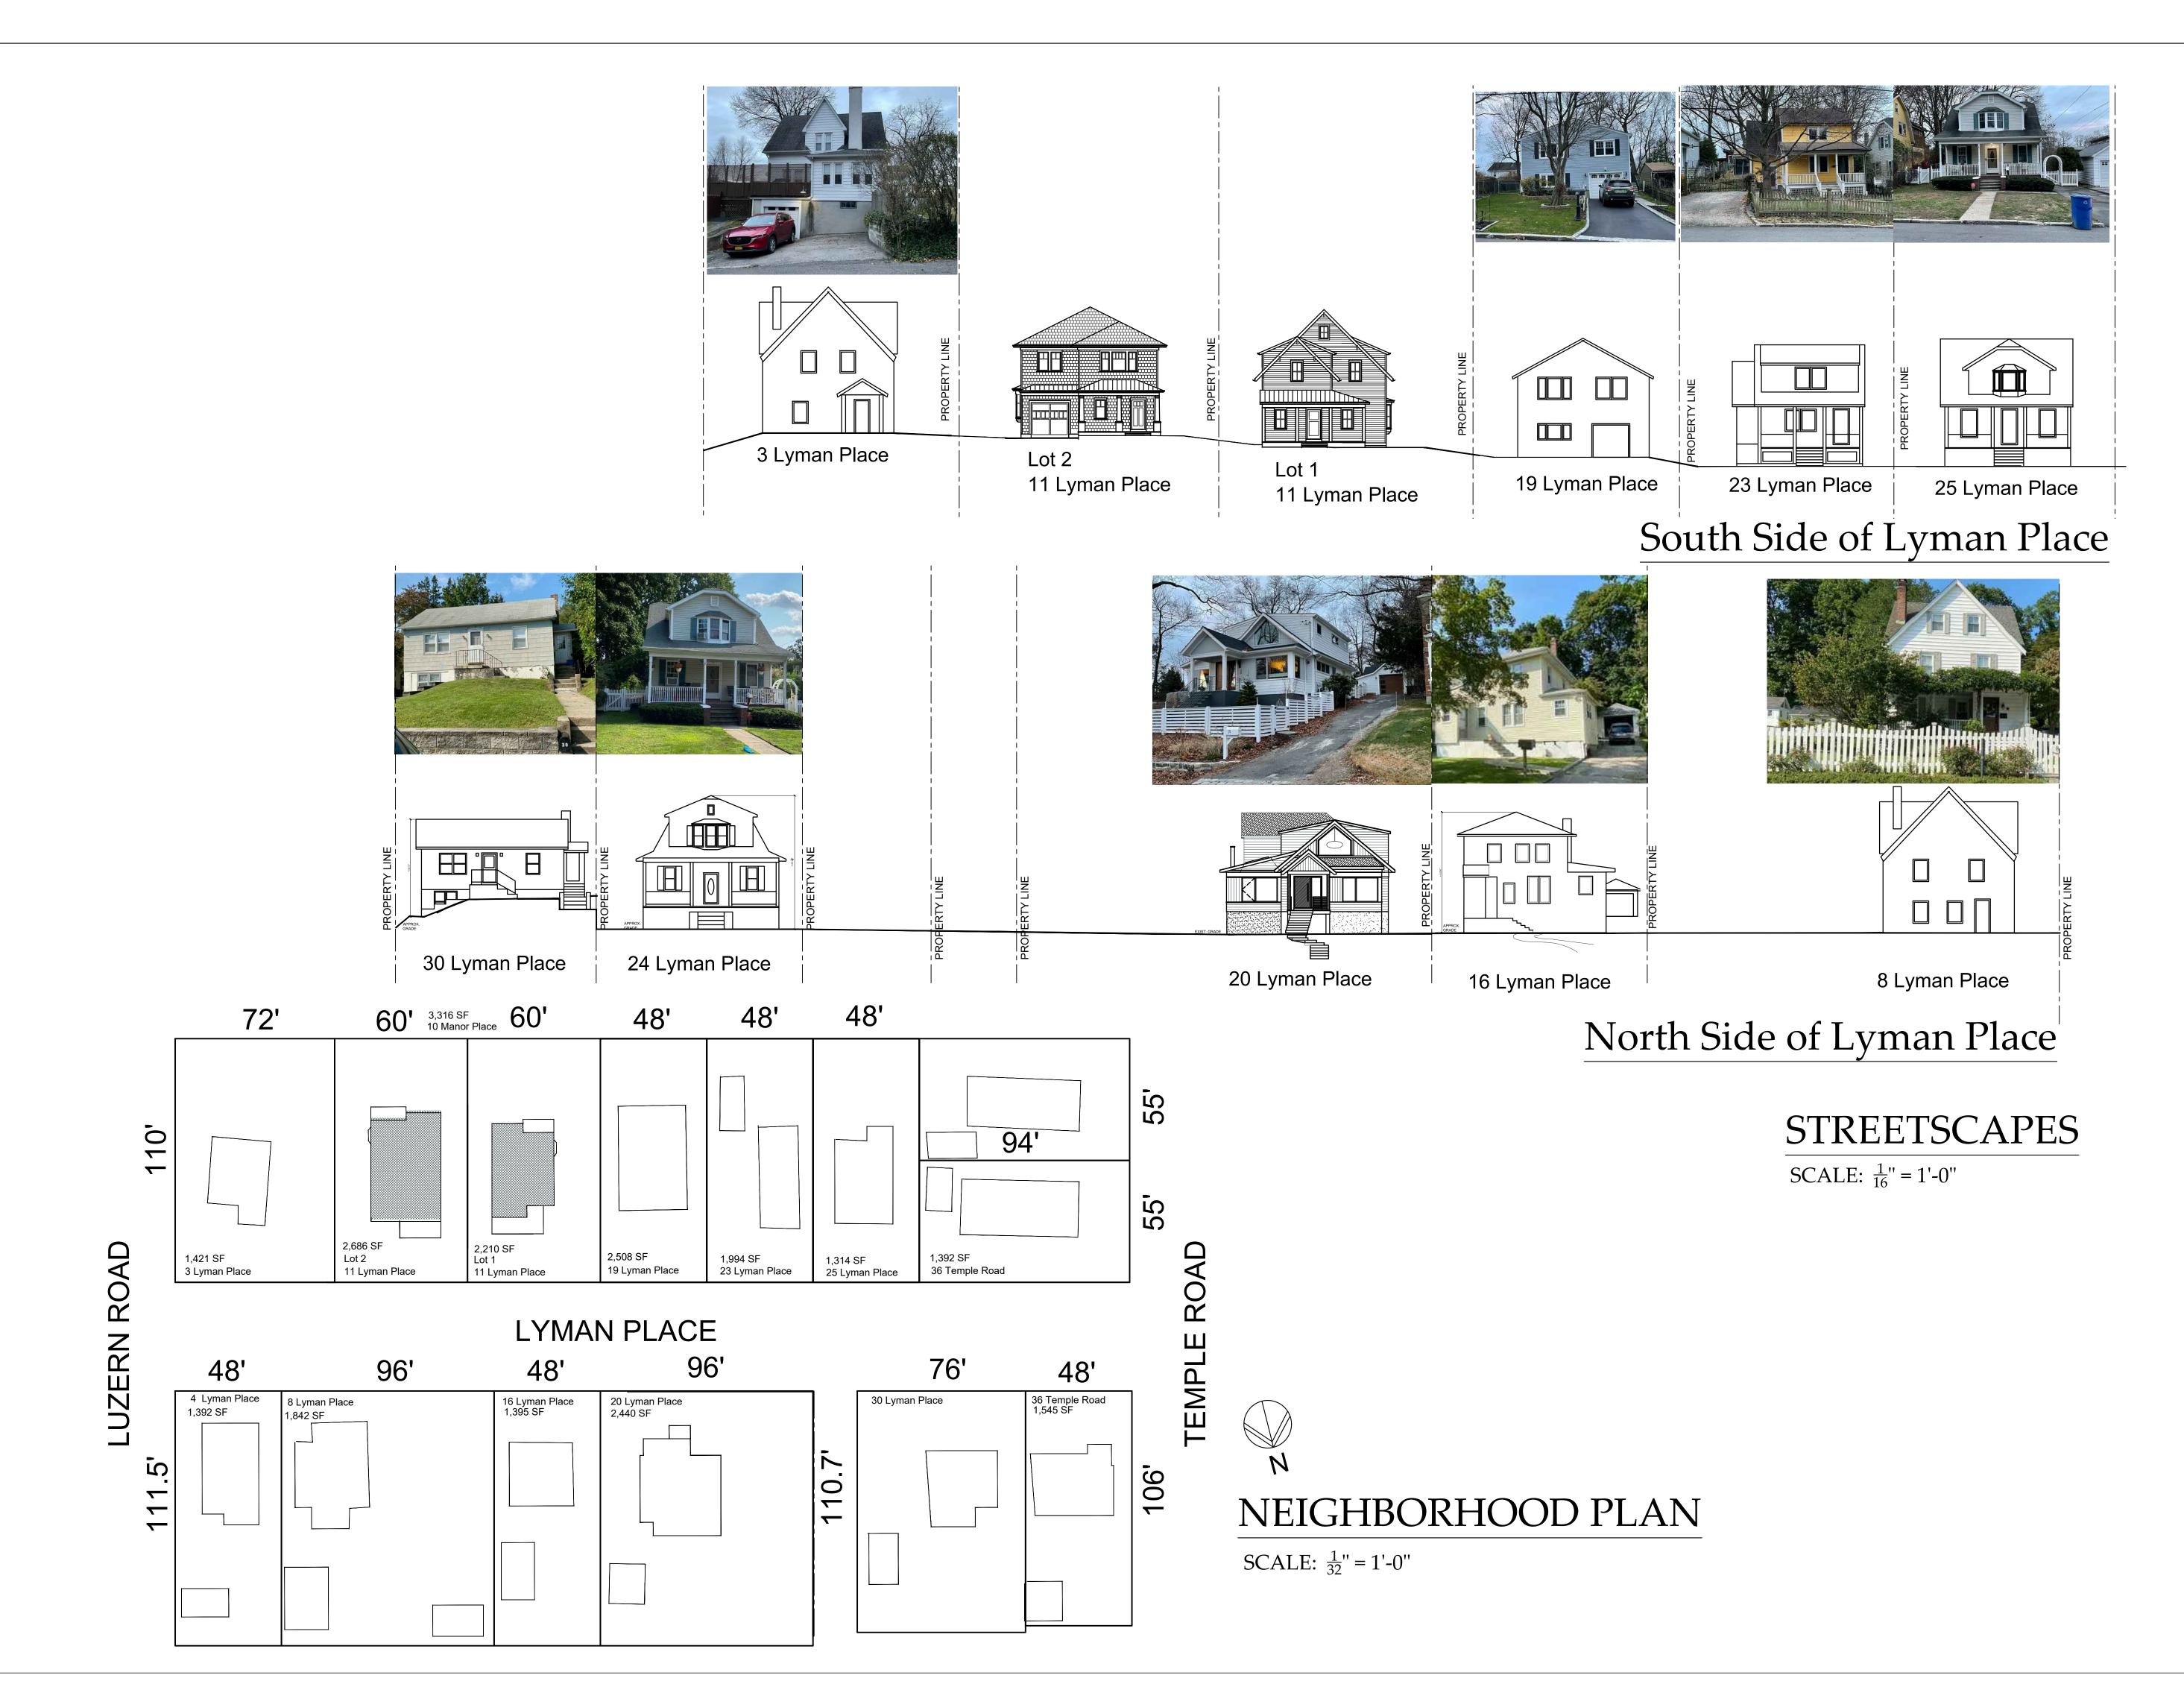






Drawing Title: STREETVIEW OF PROPERTY & NEIGHBORING HOUSES Scale: As Shown

Sheet Number:




LOT NO. 2

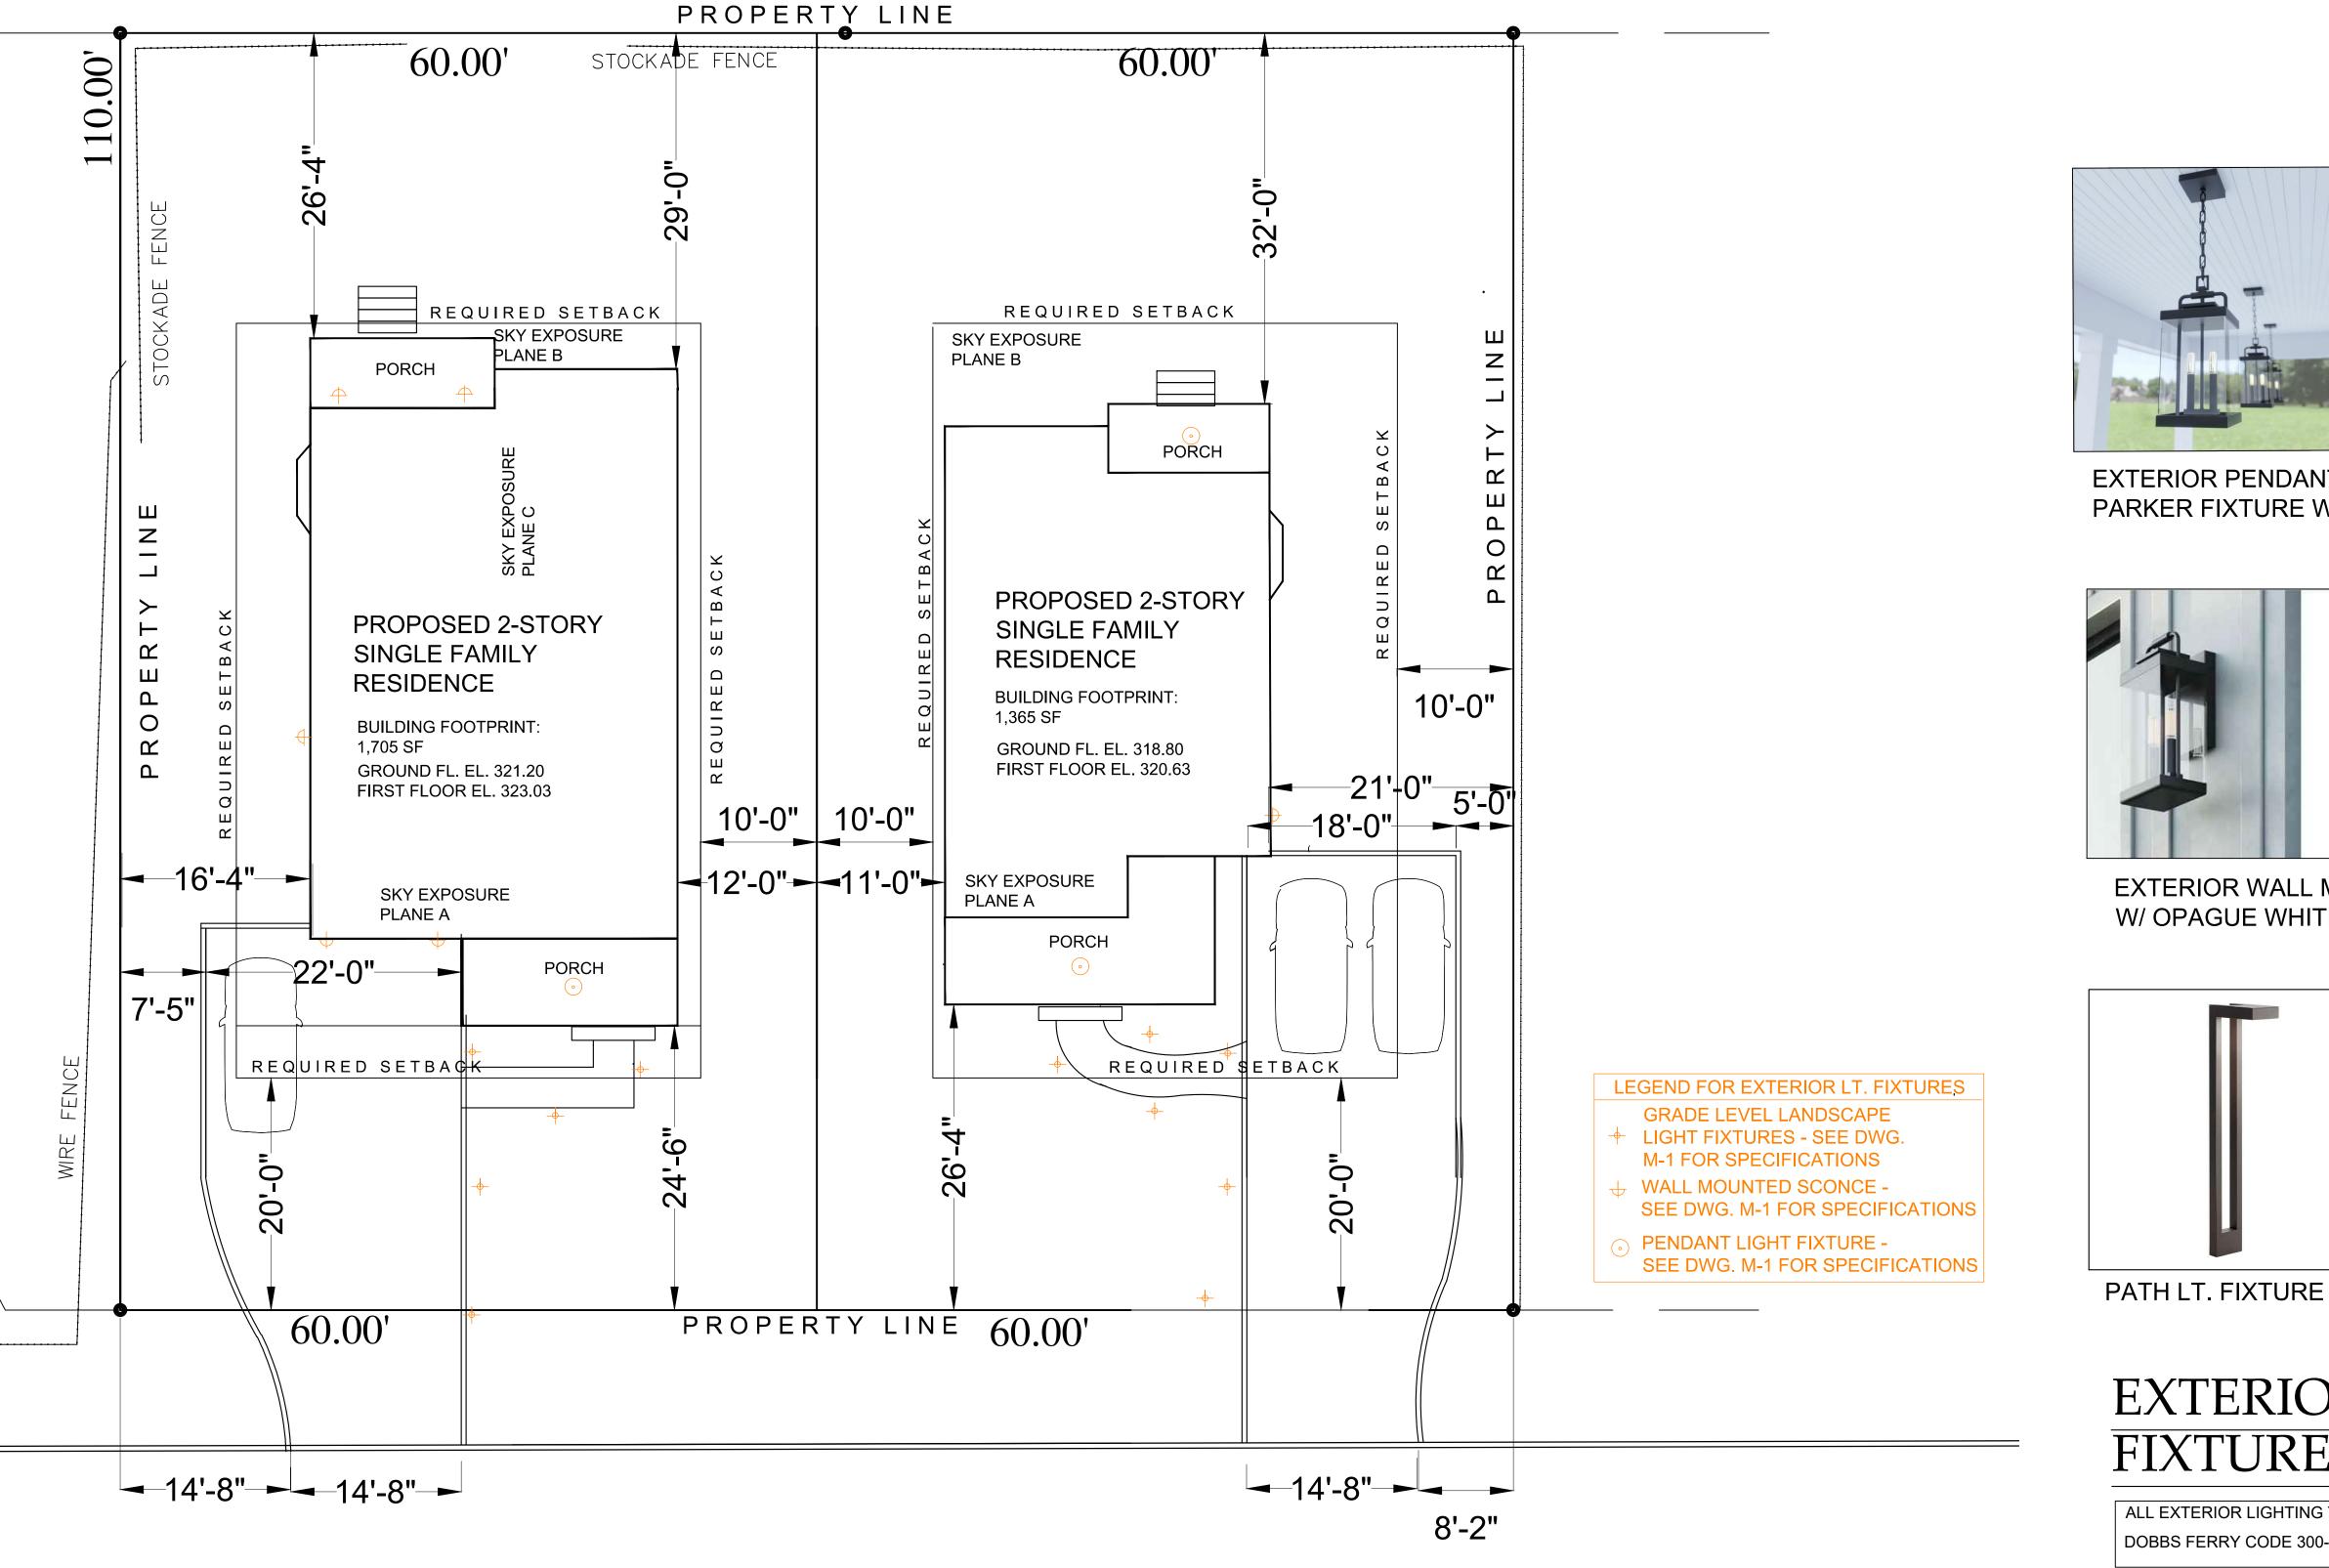

# EXTERIOR LIGHTING PLAN

SCALE: 1/8" = 1'-0"

SITE PLAN IS BASED ON SURVEY BY RAMSAY LAND SURVEYING P.C., PROFESSIONAL LAND SURVEYORS - PLANNERS, MAY 21, 2021, SEE CIVIL ENGINEERING DWGS FOR GRADING PLAN

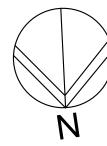

TAX LOT No.12

## LOT NO. 1



EXTERIOR PENDANT LIGHT PARKER FIXTURE W/ OPAQUE WHITE GLASS





EXTERIOR WALL MOUNTED LIGHT FIXTURE W/ OPAGUE WHITE GLASS BY PARKER LTG.



# EXTERIOR LIGHTING FIXTURE TYPES

ALL EXTERIOR LIGHTING TO BE IN COMPLIACE WITH VILLAGE OF DOBBS FERRY CODE 300-41.



12 SPRING STREET HASTINGS.on.HUDSON N.Y. 10706 914.478.0799 c g @ c g a s t u d i o . c o m christinagriffinarchitect.com

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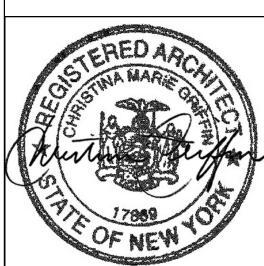


BUILDING PERMT SUBMISSION 7-7-23

PLANNING BOARD SUBMISSION 9-14-23 PLANNING BOARD SUBMISSION 11-21-23

PLANNING BOARD SUBMISSION 3-21-24

Dates:




Drawing Title:

LAYOUT


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Sheet Number:

EXTERIOR LIGHTING

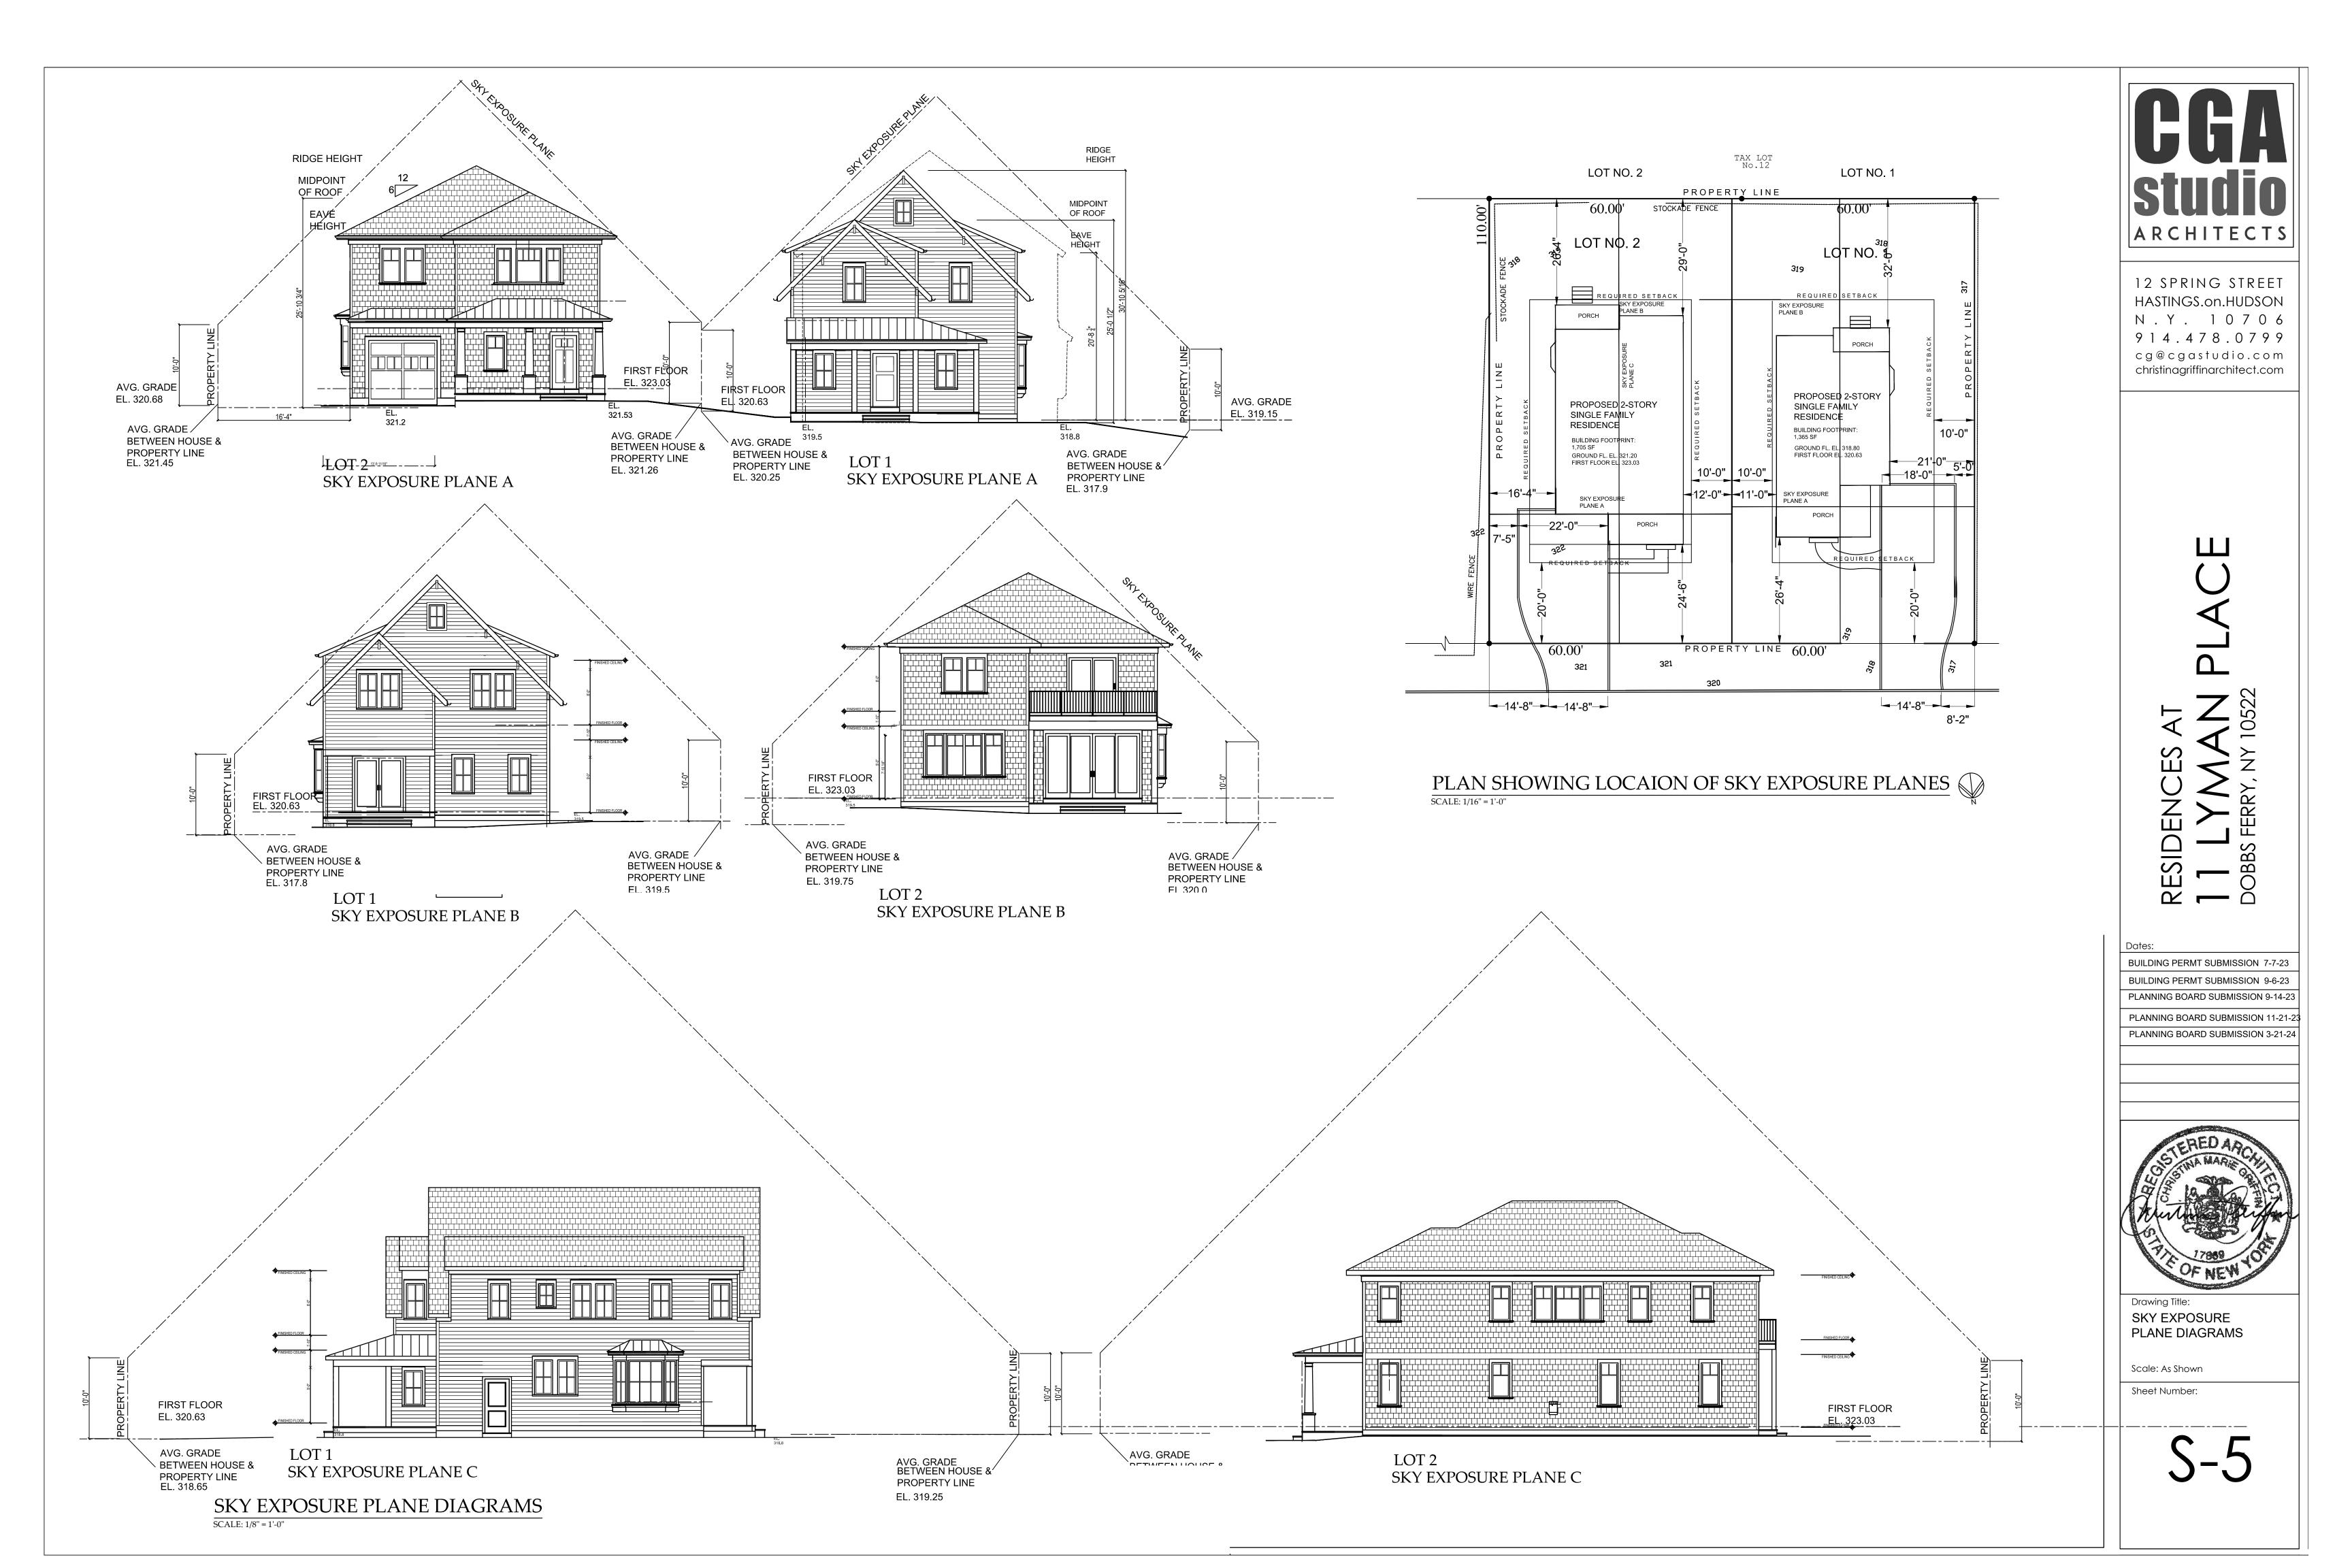

LOT NO. 2

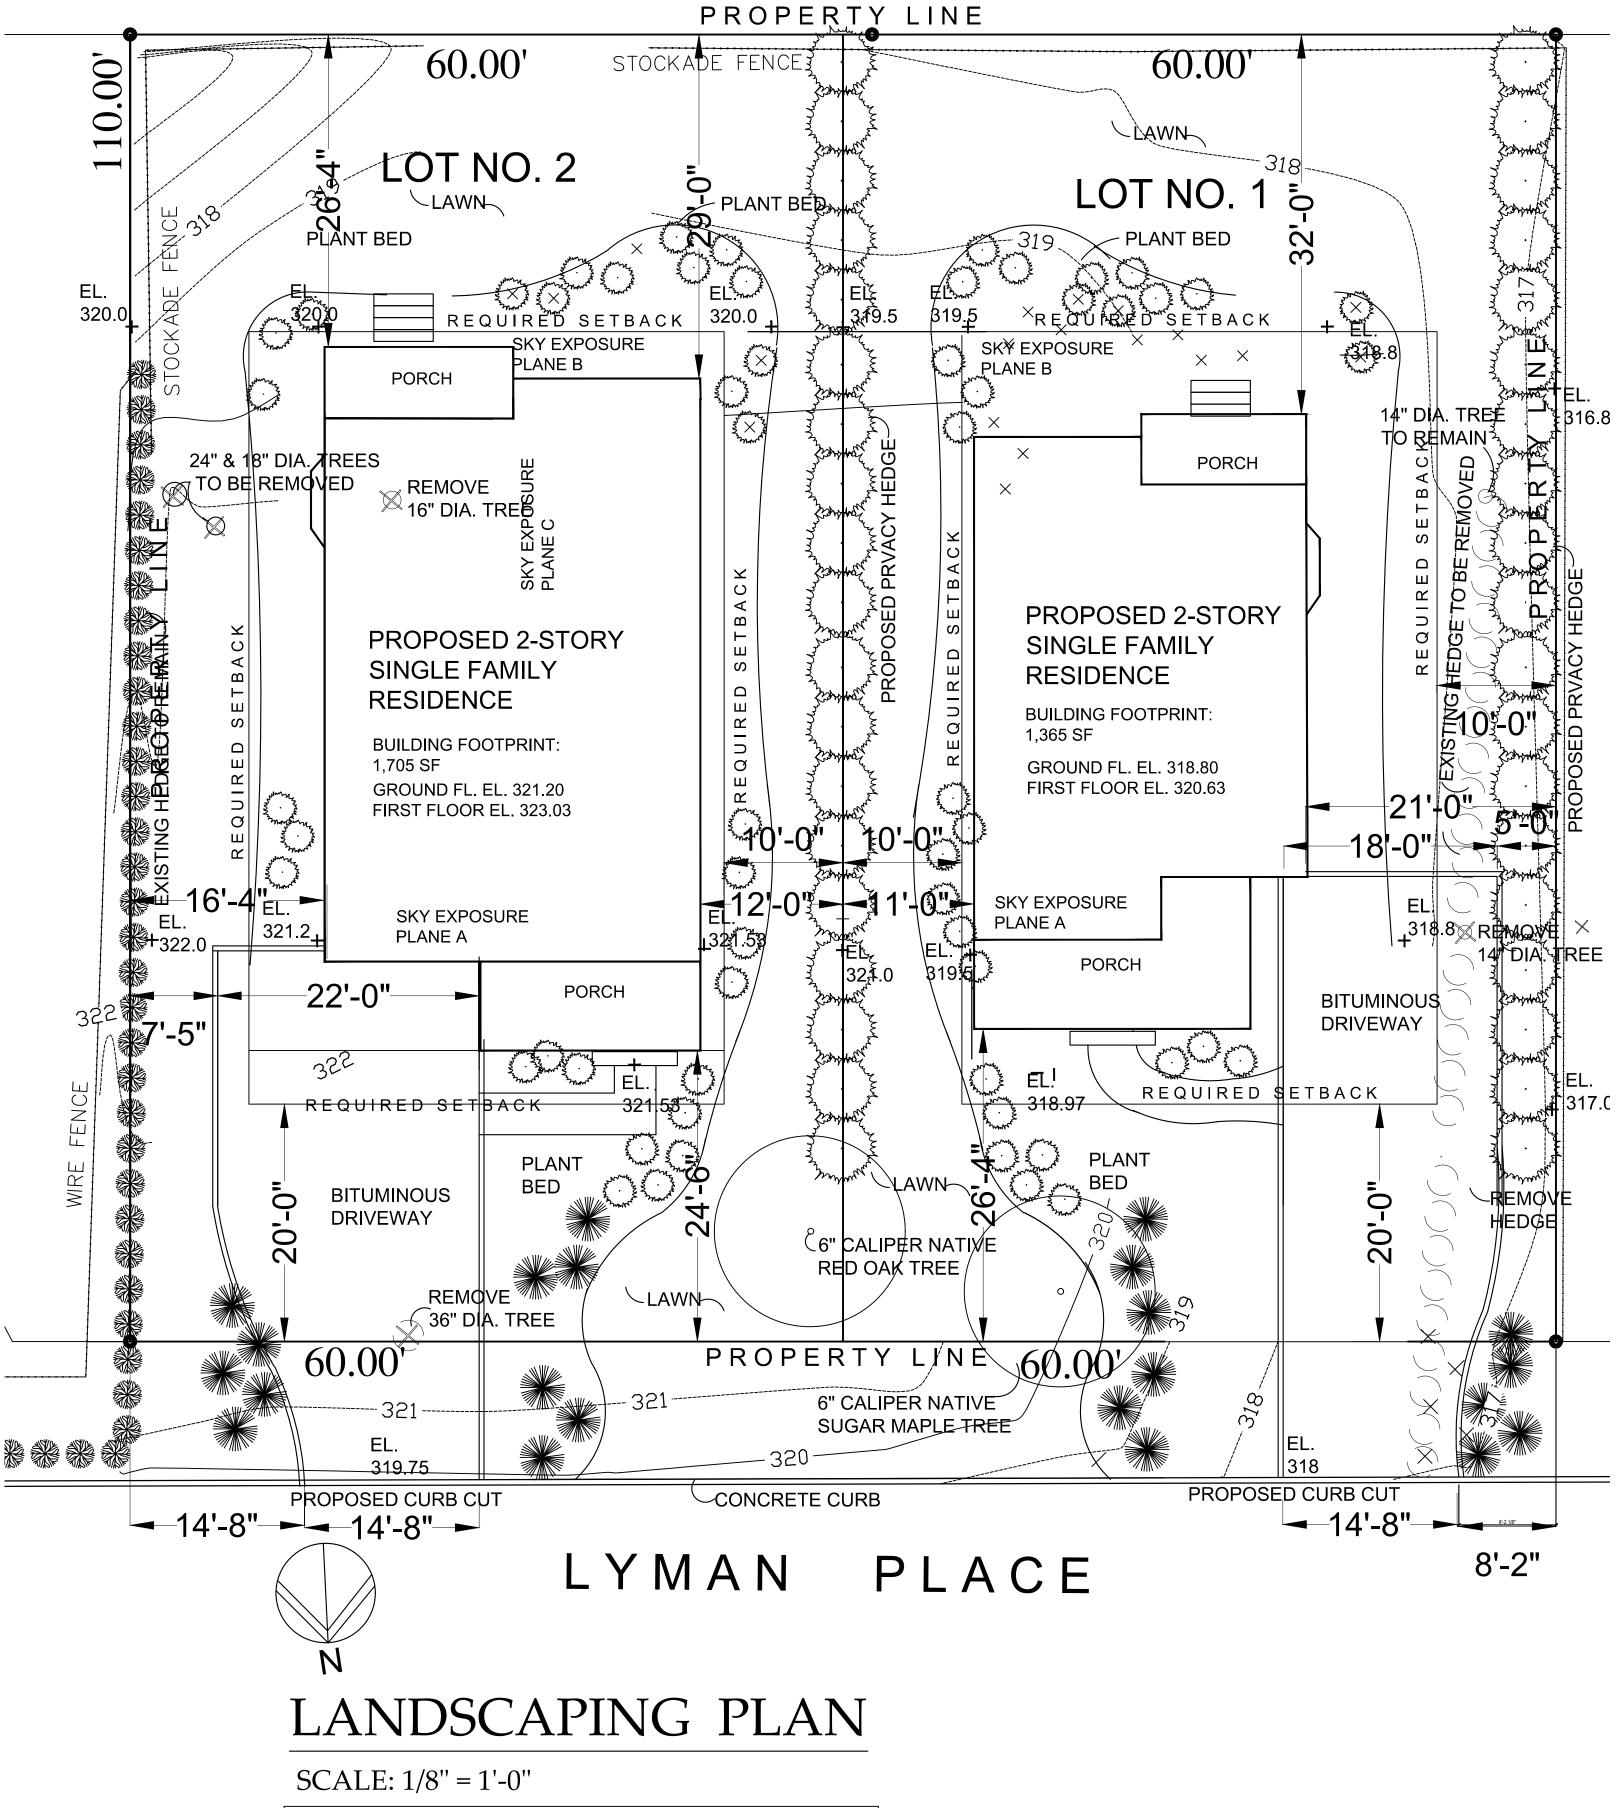

SITE PLAN IS BASED ON SURVEY BY RAMSAY LAND SURVEYING P.C., PROFESSIONAL LAND SURVEYORS - PLANNERS, MAY 21, 2021, SEE CIVIL ENGINEERING DWGS FOR GRADING PLAN


## LOT NO. 1

| ABBREVIATION | SCIENTIFIC NAME                 | COMMON NAME            | <b>SIZE</b> (at planting) | QUANTITY |
|--------------|---------------------------------|------------------------|---------------------------|----------|
| EVERGREEN TR | EES                             |                        |                           |          |
|              | ABIES BALSAMEA                  | BALSAM FIR             | 6'-8' HEIGHT              | AS SHOWN |
|              | ILEX OPACA                      | AMERICAN HOLLY         | 6'-8' HEIGHT              | AS SHOWN |
| EVERGREEN SH | IRUBS                           |                        |                           | ·        |
|              | LITTLE GAINT ARBORVITAE         | LITTLE GIANT           | 4'-0' HEIGHT              | AS SHOWN |
|              | CAMELLIA JAPONICA 'KOREAN FIRE' | CAMELLIA 'KOREAN FIRE' |                           | AS SHOWN |
|              | ILEX GLABRA                     | INKBERRY HOLLY         |                           | AS SHOWN |
|              | ILEX GLABRA 'COMPACTA'          | COMPACT INKBERRY HOLLY |                           | AS SHOWN |
|              | JUNIPER VIRGINIANA 'GREY OWL'   | GREY OWL JUNIPER       |                           | AS SHOWN |
| GROUNDCOVER  | , FERNS, GRASSES & PERENNIALS   |                        |                           |          |
|              | ADIANTUM PENDATUM               | MAIDENHAIR FERN        |                           | AS SHOWN |
|              | ASARUM CANADENSE                | WILD GINGER            |                           | AS SHOWN |
|              | ASTER DIVARICARTUS              | WHITE WOODLAND ASTER   |                           | AS SHOWN |
|              | ATHYRIUM FILIZ-FEMINA           | LADY FERN              |                           | AS SHOWN |
|              | CARAX PENSYLVANICA              | PENNSYLVANIA SLEDGE    |                           | AS SHOWN |

### PLANT NOTES:

- 1. ALL LAWN AREAS TO BE PREPARED WITH 4" MIIMUM OF SCREENED TOPSOIL AND SEEDED OR SODDED WITH A BLUEGRASS AND PERENNIAL RYEGRASS MIX. ALL DISTURBED AREAS AREAS NOT TO LAWN, SHRUB BEDS TO BE SEEDED WITH A MIX OF ANNUAL RYE AT 50 % NORMAL BROADCAST RATE AND REDTOR FESCUE AT NORMAL RATE
- 2. ALL PLANTS AND SHRUB BEDS SHALL RECEIVE 2" MINIMUM OF SHREDDED CEDAR MULCH
- SHRUBS SHALL HAVE 12' TOPSOIL AROUND SIDES OF ROOTS. ADD SOIL FOR DEPTH AS NECESSARY
- 4, IF PLANT COUNTS DIFFER BETWEEN THE PLANT LIST AND THE PLANS, THOSE SHOWN GRAPHICALLY ON THE PLANS SHALL BE ASSUMED CORRECT
- 5. ALL PLANTS TO BE TYPICAL OF THE SPECIES, HEALTHY, AND FREE OF DISEASE AT THE
- 6. ALL INVASIVE, NON NATIVE PLANTS TO BE REMOVED FROM THE SITE.
- TIME OF PLANTING

## LEGEND

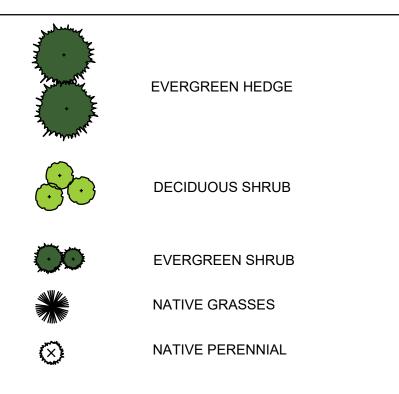

## NOTES

- 1. THE LANDSCAPE CONTRACTOR TO COORDINATE THIS WORK W/ OTHER CONTRACTORS PERFORMING WORK ON SITE.


- OWNER'S LANDSCAPE ARCHITECT SHALL INSPECT PLANT MATERIAL FOR ACCEPTANCE PRIOR TO PLANTING.
- LANDSCAPE ARCHITECT PRIOR TO PLANTING
- EXTENT AND COMPOSITION OF BACKFILL MATERIAL. 8. THE CONTRACTOR SHALL REMOVE ALL PLASTIC MATERIAL FROM AROUND THE ROOT BALLS OF THE PLANTS AFTER

- NEEDED DURING THE FIRST GROWING SEASON.
- 12. ALL NEW PLANTING SHOWN WITHIN OR NEAR THE DRIPLINE OF THE 32" SUGAR MAPLE SHALL BE LOCATED IN THE FIELD BY OWNER'S LANDSCAPE ARCHITECT OR ARBORIST AND INSTALLED UNDER THE DIRECT SUPERVISION OF OWNER'S LANDSCAPE ARCHITECT OR ARBORIST TO ENSURE PROTECTION OF EXISTING TREE ROOTS.

## △ COMPLIANCE WITH VILLAGE CODE 300-51 (I) TREE VALUATION

TOTAL AGGREGATE DIAMETER OF TREES TO BE REMOVED: 36" + 24" + 18" + 16" + 14" + 28 EVERGREEN TREES @ 2" = 164" TOTAL REQUIREMENT FOR MIN. AGGREGATE AREA OF TREES TO BE REPLACED 50% X 164" = 82" TOTAL AGGREGATE DIMENISON OF PROPOSED TO BE PLANTED: (2) DECIDUOUS TRESS @ 6" + 38 EVERGREEN TREES @ 2<sup>1</sup>/<sub>2</sub>" = 107" TOTAL

7. SUBSTITUTIONS OF SIMILIAR TYPE SIZE AND NUMBER ARE PERMITTED IN THE INTERESTS OF PURCHASING THE BEST QUALITY MATERIAL AVAILABLE AT THE

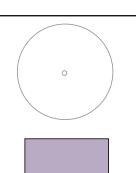

TREE

NATIVE GROUND COVER

PATH LT. FIXTURE

2. THE CONTRACTOR SHALL LOCATE AND VERIFY ALL UNDERGROUND UTILITIES PRIOR TO ANY LAWN WORK OR TREE AND SHRUB PLANTING AND SHALL IMMEDIATELY REPORT ANY CONFLICTS TO THE PROJECT SITE ENGINEER. THE CONTRACTOR SHALL SUPPLY ALL PLANT MATERIAL IN QUANTITIES SUFFICIENT TO COMPLETE THE PLANTING SHOWN ON THE DRAWING. QUANTITIES IN PLANT SCHEDULE ARE FOR REFERENCE ONLY. NO PLANT OR CULTIVAR SUBSTITUTIONS WILL BE ACCEPTABLE WITHOUT APPROVAL OF THE LANDSCAPE ARCHITECT.

6. LOCATION OF NEW PLANT MATERIAL SHALL BE STAKED OR SET OUT BY CONTRACTOR AND APPROVED BY OWNER'S REFER TO PLANTING DETAILS AND SPECIFICATIONS FOR INFORMATION RELATING TO PLANTING PIT DIMENSIONS AND

 POSITIONING IN THE PLANT PITS. REMOVE BURLAP, ROPE, AND WIRE FROM AROUND THE TRUNK SUFFICIENTLY SO THAT NO BURLAP, ROPE OR WIRE WILL BE EXPOSED AFTER BACKFILLING.
CONTRACTOR SHALL EXERCISE EXTREME CARE IN WORKING IN AREA OF EXISTING TREES. EXISTING TREES TO REMAIN AND BE PROTECTED, WHICH ARE INJURED OR DESTROYED DURING CONSTRUCTION SHALL BE REPLACED BY CONTRACTOR WITH PLANTS OF EQUAL SIZE AND SPECIES AT NO COST TO THE OWNER. 10. ALL AREAS THAT HAVE BEEN DISTURBED BY PLANTING ACTIVITY SHALL BE RESTORED TO A NEAT CONDITION. AREAS


WITH BARE SOIL SHALL BE TOPSOILED AND SEEDED WITH NATIVE EROSION CONTROL SEED MIX. 11. THE CONTRACTOR SHALL WATER TREES, SHRUBS AND GROUNDCOVER TWICE DURING THE FIRST 24 HOURS AND AS



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BUILDING PERMT SUBMISSION 7-7-23 PLANNING BOARD SUBMISSION 9-14-23 PLANNING BOARD SUBMISSION 11-21-23 PLANNING BD SUBMISSION 12-6-23 PLANNING BD SUBMISSION 3-21-24



Drawing Title: LANDSCAPING PLAN

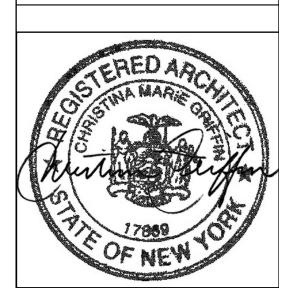Scale: As Shown


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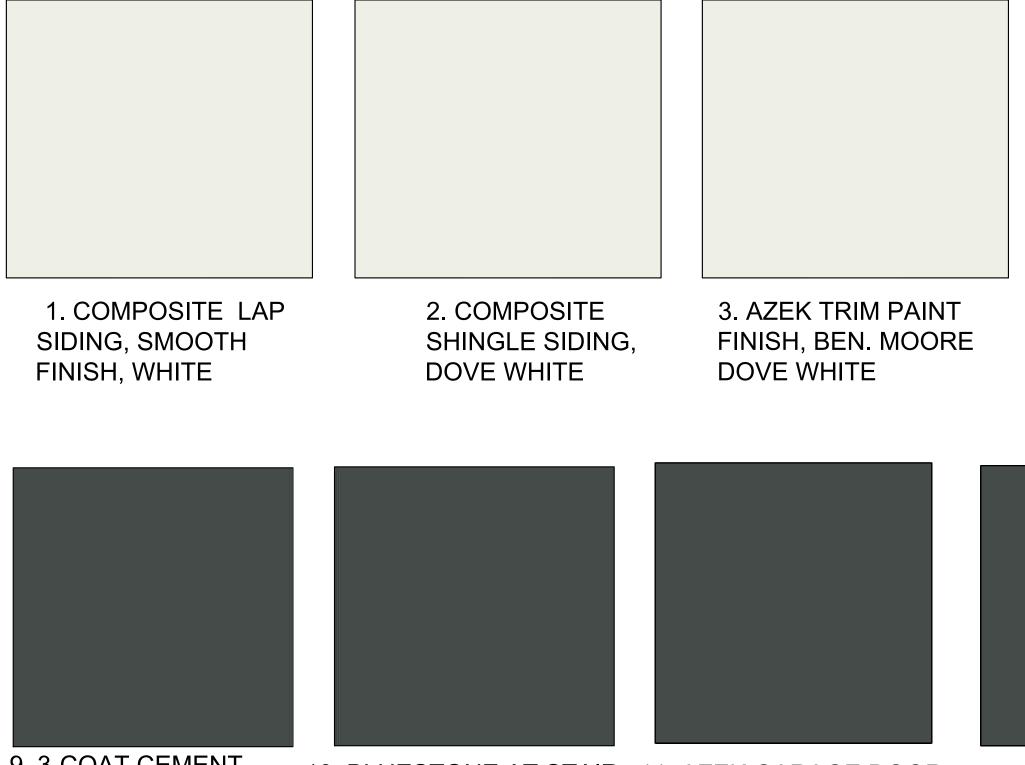


# ELEVATIONS OF LOT #1 RESIDENCE

A-





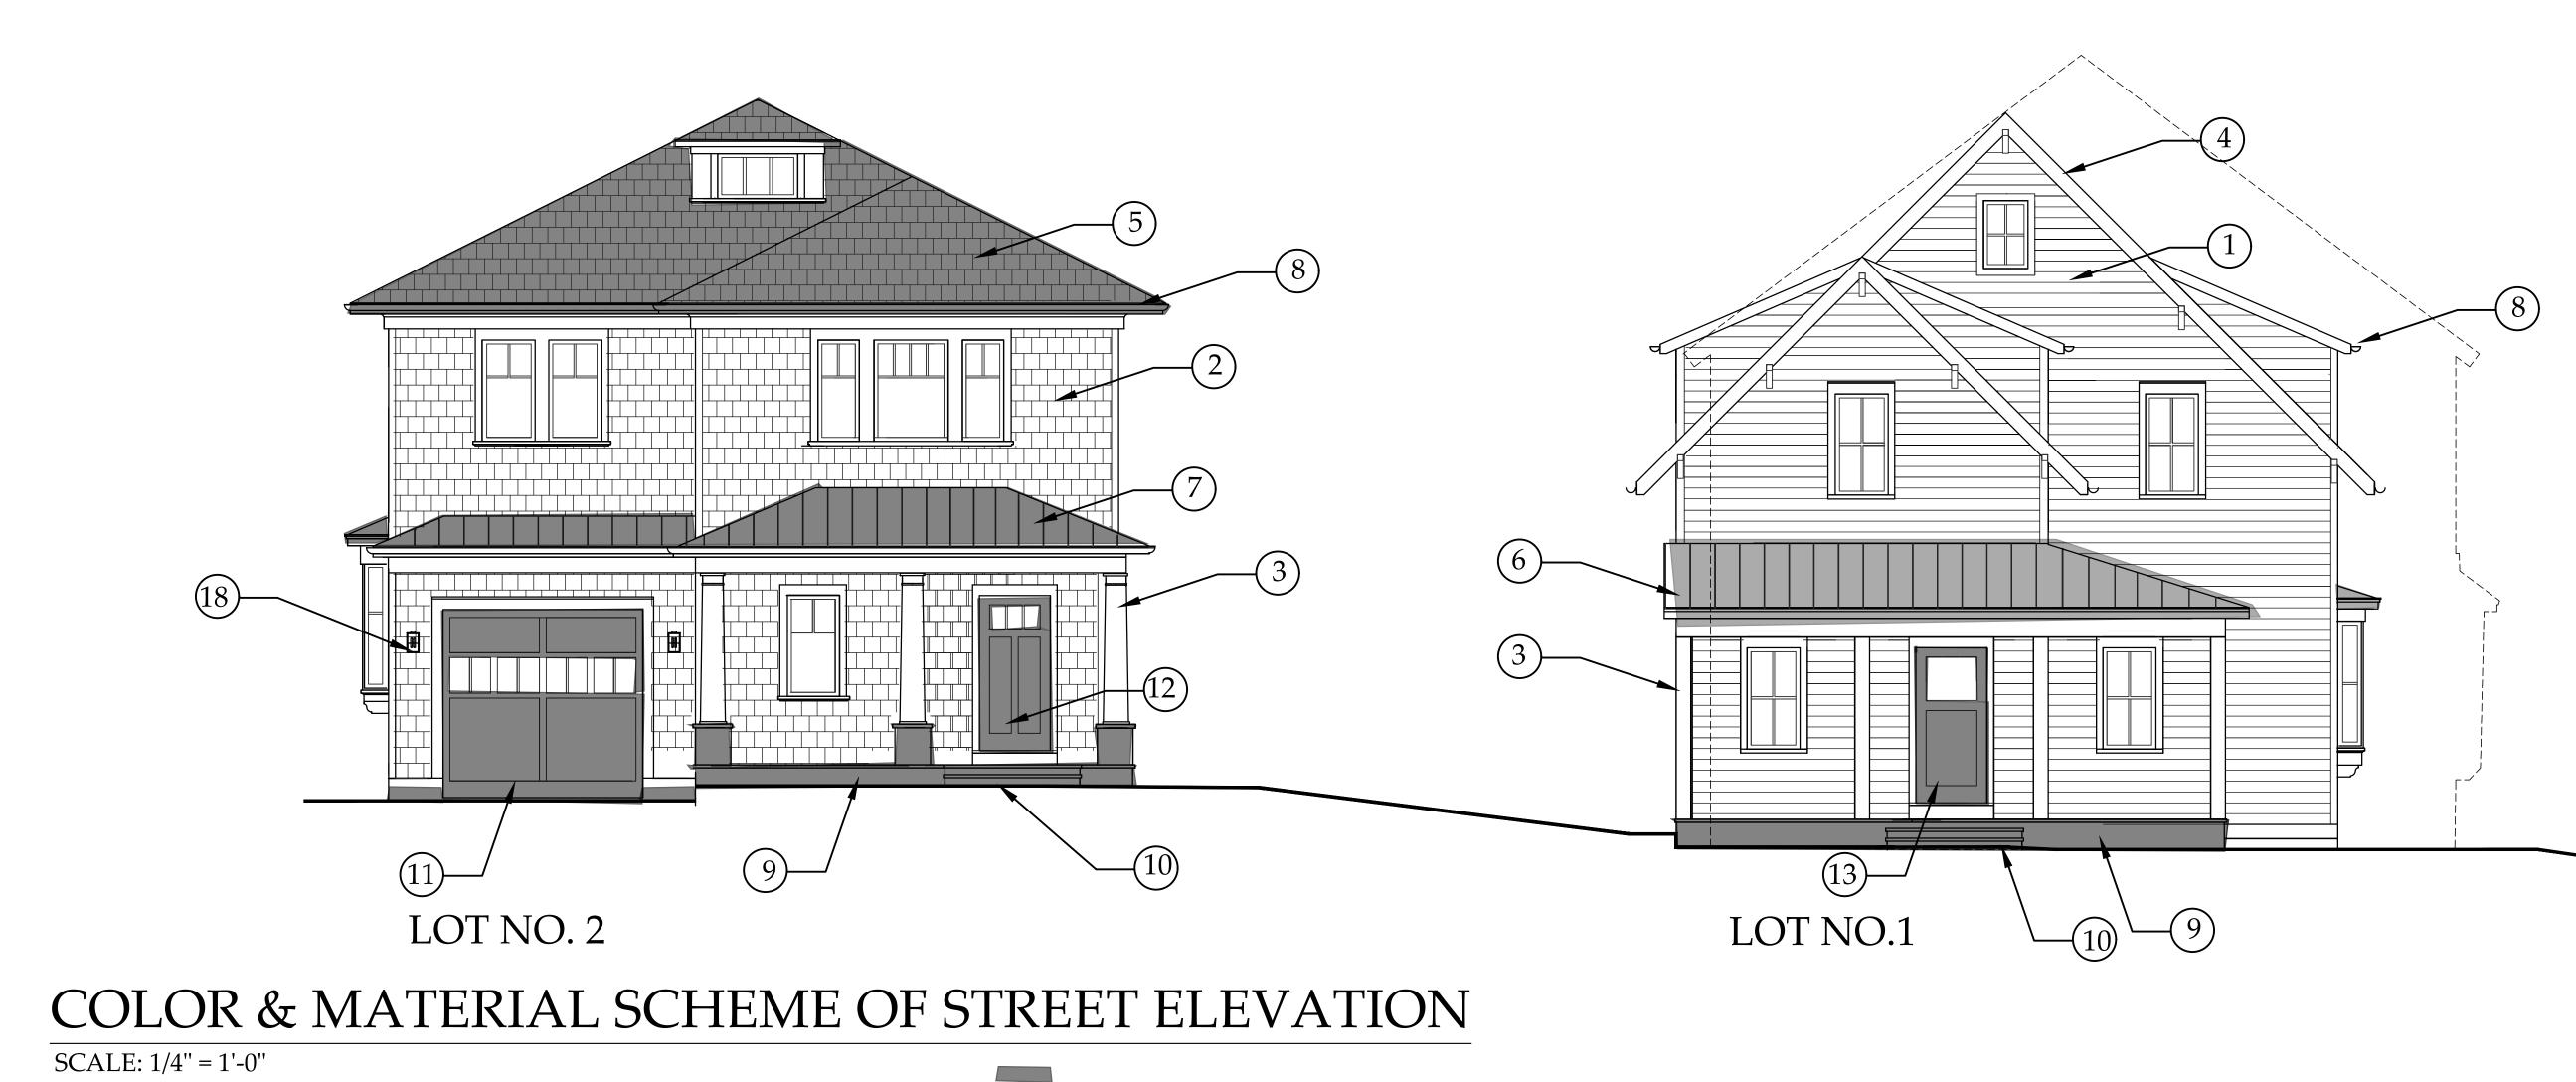


9. 3-COAT CEMENT STUCCO, FINE FINISH, COLOR MATCH TO BEN. MOORE CHELSEA GRAY#CW-695

10. BLUESTONE AT STAIR 11. AZEK GARAGE DOOR 12. FRONT DOOR TREADS, PORCH FLOOR PAINT FINISH. BEN. AND PATIO

MOORE DARK GREY




PAINT FINISH. BEN. MOORE DARK GREY

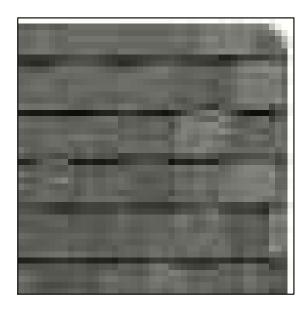


4. ARCHITECTURAL SHINGLES 30 YR. BY CERTANTEED, LANDMARK SERIES, PEWTER GREY



5. ARCHITECTURAL SHINGLES 30 YR. BY CERTANTEED, LANDMARK SERIES, COLONIAL SLATE

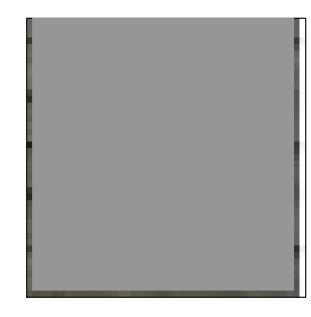

6. STANDING SEAM METAL 7. STANDING SEAM METAL 8. ALUMINUM HALF-ROOFING WITH FACTORY ROOFING WITH FACTORY ROUND GUTTER, PAINTED LIGHT GREY FINISH

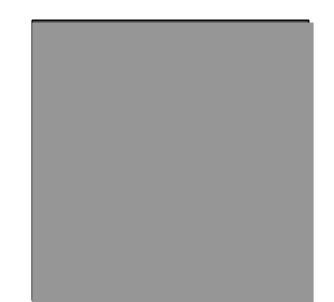

13. FRONT DOOR PAINT FINISH. BEN. MOORE SILVER GREY



14. ANDERSEN WINDOWS SIMULATED DIVIDED LITE, BLACK CLADDING



FINISH



**18. EXTERIOR WALL** MTD.PARKER LT. FIXTURE





PAINTED WARM GREY


COLOR-MATCHED TO BEN. MOORE CHELSEA GRAY # CW-695



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**BUILDING PERMT SUBMISSION 7-7-23** PLANNING BOARD SUBMISSION 9-14-23 PLANNING BOARD SUBMISSION 9-20-23 PLANNING BOARD SUBMISSION 1-4-24 PLANNING BOARD SUBMISSION 1-18-24 PLANNING BOARD SUBMISSION 3-21-24



Drawing Title: EXTERIOR MATERIAL & COLOR SCHEME

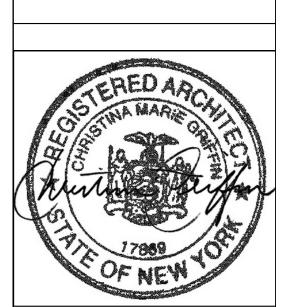Scale: As Shown Sheet Number:






# 3D VIEW OF LOT 1 & 2 HOUSES AS SEEN FROM LYMAN PL



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# AERIAL VIEW OF LOT 1 & 2 HOUSES

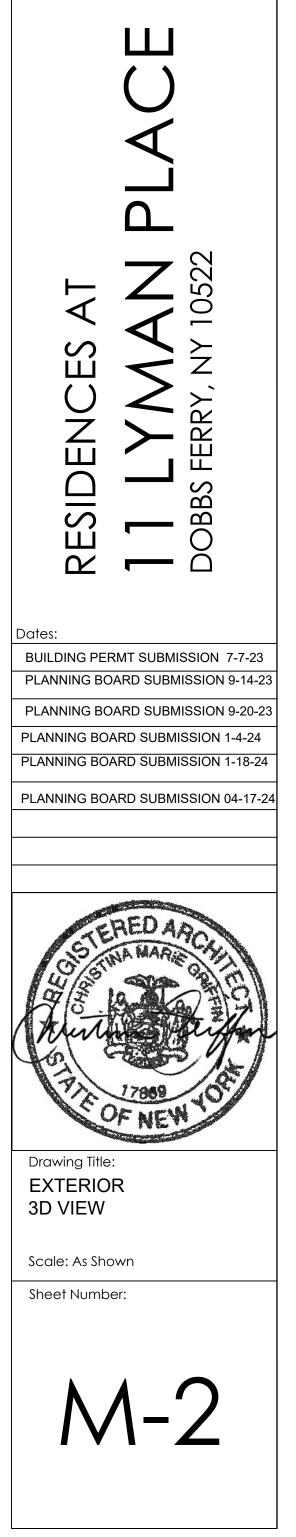

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> RESIDENCES AT **1 1 LYMAN PLACE** DOBBS FERRY, NY 10522

### Date

BUILDING PERMT SUBMISSION 7-7-23 PLANNING BOARD SUBMISSION 9-14-23 PLANNING BOARD SUBMISSION 1-4-24 PLANNING BOARD SUBMISSION 1-4-24 PLANNING BOARD SUBMISSION 04-17-24 UNITED AND SUBMISSION 04-17-24 Drawing Title: EXTERIOR AERIAL VIEW Scale: As Shown Sheet Number:

M-3

# STREET VIEW OF LOT 1 & 2 HOUSES






12 SPRING STREET HASTINGS.on.HUDSON N.Y. 10706 914.478.0799 cg@cgastudio.com christinagriffinarchitect.com

> RESIDENCES AT **11 LYMAN PLAC** DOBBS FERRY, NY 10522

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### Dates

BUILDING PERMT SUBMISSION 7-7-23 PLANNING BOARD SUBMISSION 9-14-23 PLANNING BOARD SUBMISSION 9-20-23 PLANNING BOARD SUBMISSION 1-4-24 PLANNING BOARD SUBMISSION 1-18-24

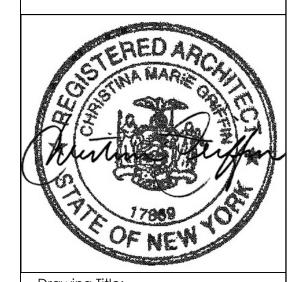

Drawing Title: EXTERIOR STREET VIEW

Scale: As Shown Sheet Number:





CONNECTIONS SHALL BE INSTALLED IN ACCORDANCE WITH MANUFACTURER'S SPECIFICATIONS AND VISIBLE AT TIME OF INSPECTION. SHOULD THE CONTRACTOR BACKFILL PRIOR TO INSPECTION, THE CONTRACTOR SHALL EXPOSE THE SYSTEM AT THEIR OWN EXPENSE

CONTRACTOR SHALL CONTACT DESIGN ENGINEER TO SCHEDULE A SITE INSPECTION PRIOR TO BACKFILLING


INFILTRATION/ATTENUATION SYSTEM(S). ALL

ANY ALTERATIONS OR REVISIONS OF THESE PLANS, UNLESS DONE BY OR UNDER THE DIRECTION OF THE NYS LICENSED AND REGISTERED ENGINEER THAT PREPARED THEM, IS A VIOLATION OF THE NYS EDUCATION LAW.

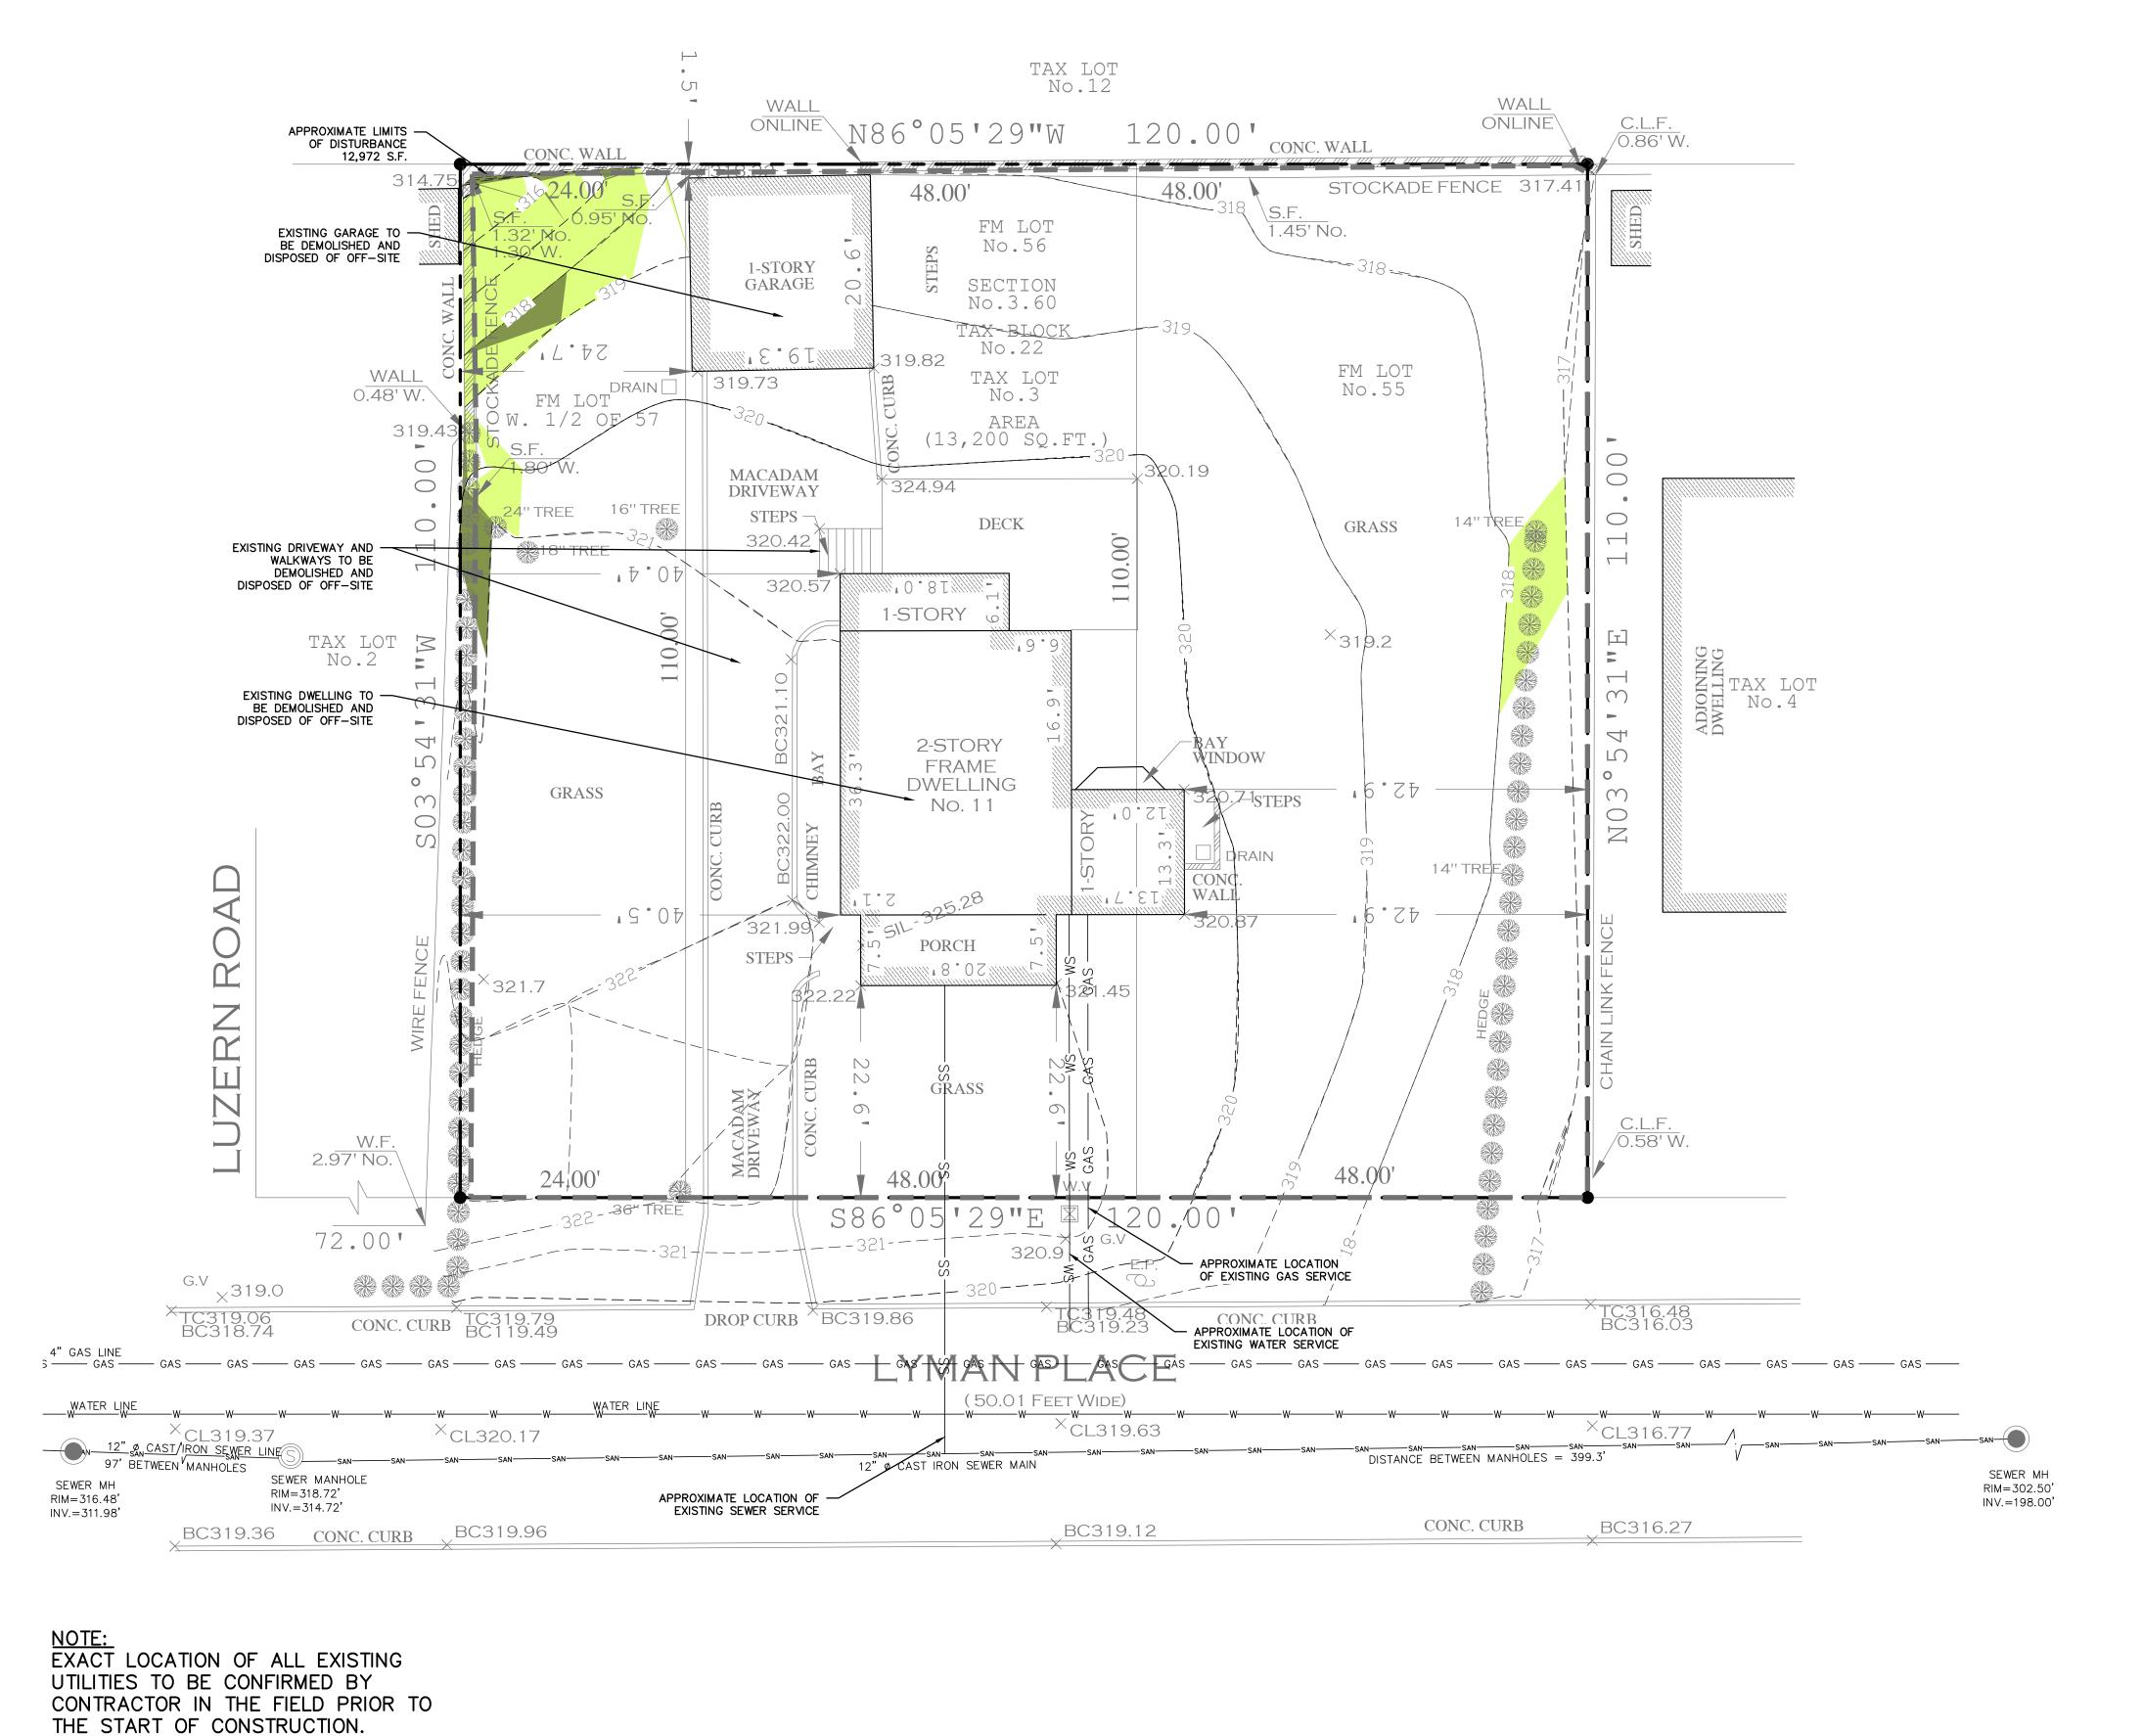

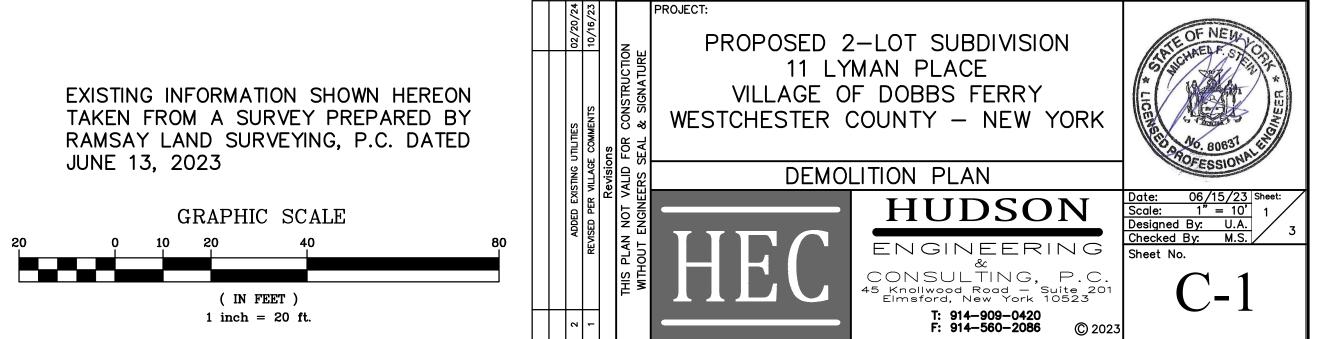




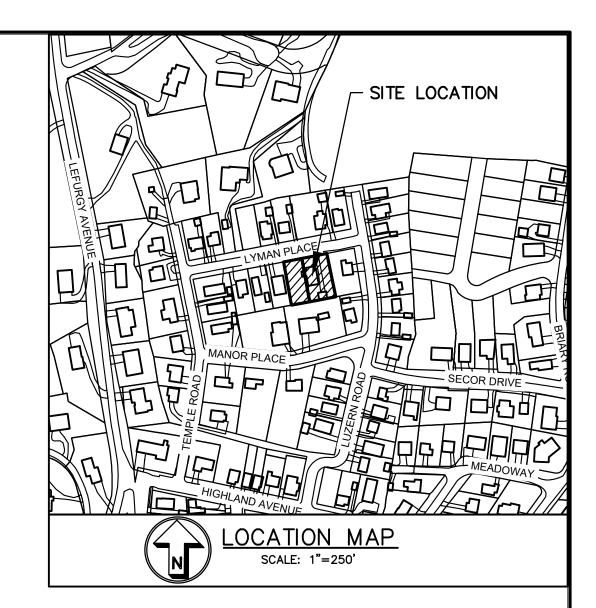


| SLOPE ANALYSIS (LOT 1) |            |            |      |       |  |  |
|------------------------|------------|------------|------|-------|--|--|
| NO.                    | MIN. SLOPE | MAX. SLOPE | AREA | COLOR |  |  |
| 1                      | 0%         | 15%        | 6196 |       |  |  |
| 2                      | 15%        | 25%        | 329  |       |  |  |
| 3                      | 25%        | Vertical   | 75   |       |  |  |

|     | SLOPE ANALYSIS (LOT 2 |            |      |       |  |  |  |
|-----|-----------------------|------------|------|-------|--|--|--|
| NO. | MIN. SLOPE            | MAX. SLOPE | AREA | COLOR |  |  |  |
| 1   | 0%                    | 15%        | 6504 |       |  |  |  |
| 2   | 15%                   | 25%        | 96   |       |  |  |  |
| 3   | 25%                   | Vertical   | 0    |       |  |  |  |

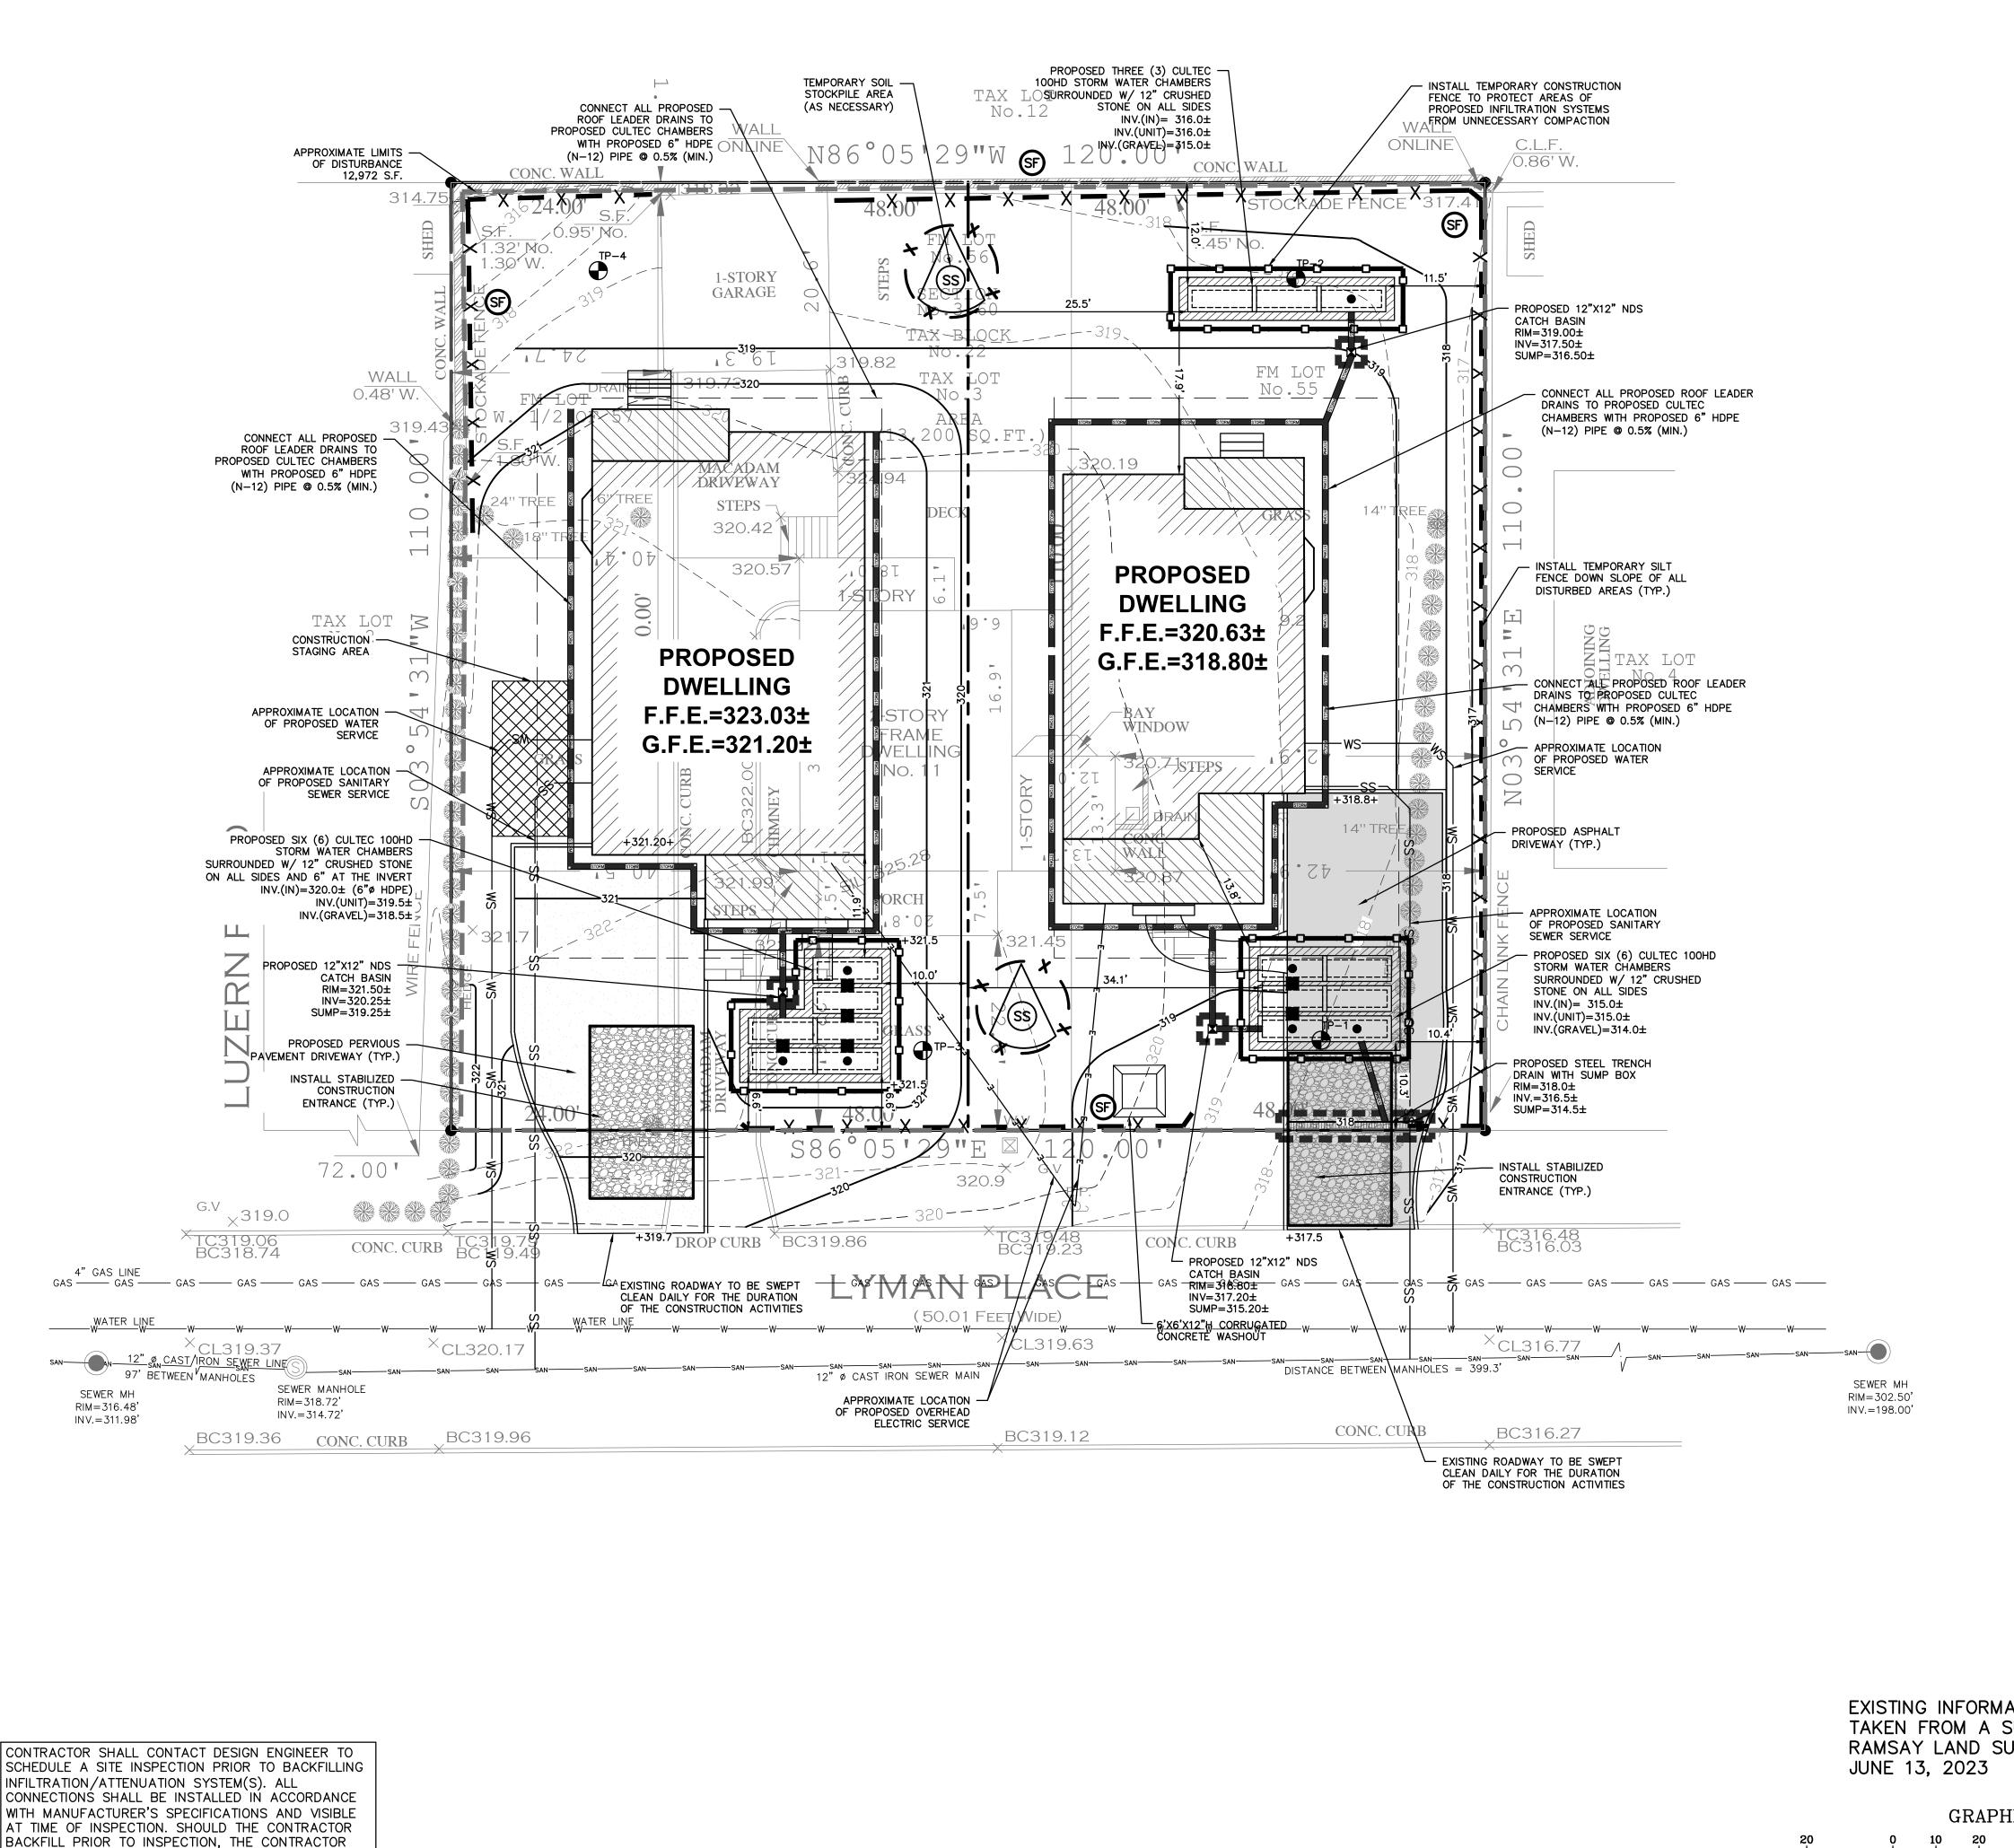

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SHALL EXPOSE THE SYSTEM AT THEIR OWN EXPENSE

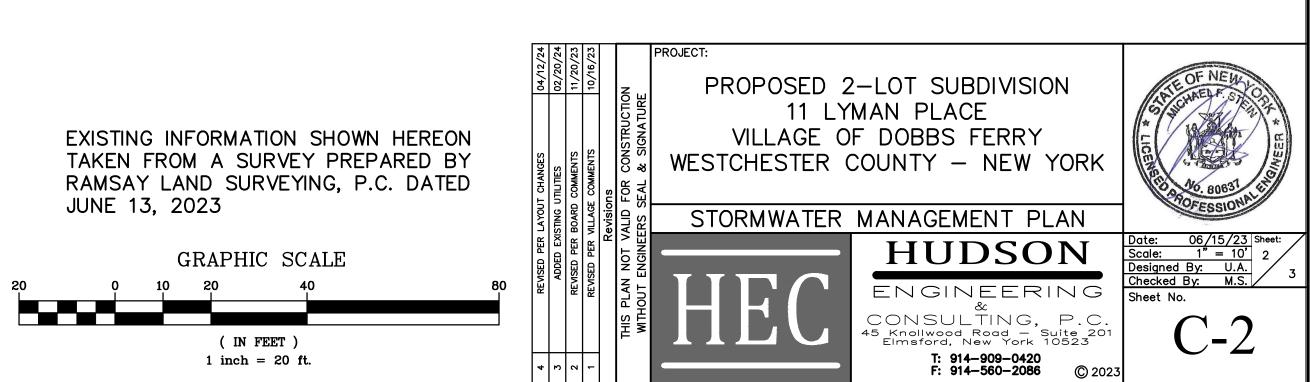

## LEGEND

| ROPERTY LINE                        |                        |
|-------------------------------------|------------------------|
| ROPOSED BELGIAN<br>LOCK CURB        |                        |
| ROPOSED ASPHALT<br>RIVEWAY          |                        |
| ROPOSED<br>ALKWAY/PATIO             |                        |
| ROPOSED<br>ONTOUR                   |                        |
| ROPOSED SPOT<br>RADE                | +317.5                 |
| ROPOSED<br>TORM PIPE                | <b>ISTORYI ISTORYI</b> |
| ROPOSED DRAIN<br>ILET               |                        |
| ROPOSED<br>RENCH DRAIN              |                        |
| ROPOSED<br>ATER SERVICE             | ws                     |
| ROPOSED SANITARY<br>EWER SERVICE    | SS                     |
| EMPORARY INLET<br>ROTECTION         | <b>[]</b> (P)          |
| EMPORARY SILT<br>ENCE               | — × — × — (            |
| EMPORARY<br>ONSTRUCTION FENCE       | (                      |
| EMPORARY SOIL<br>TOCKPILE AREA      | +                      |
| TABILIZED<br>ONSTRUCTION<br>NTRANCE |                        |
| EST PIT<br>OCATION                  | TP-1                   |
|                                     |                        |

PROPOSED LIMIT

OF DISTURBANCE

## **GENERAL NOTES:**

1. THE ENGINEER SHALL NOT BE RESPONSIBLE FOR THE SUPERVISION OF THE CONSTRUCTION

- . NO CHANGES SHALL BE MADE TO THESE PLANS EXCEPT AS PER NYS LAW CHAPTER 987 3. ALL WORK AND MATERIALS SHALL COMPLY WITH ALL APPLICABLE CODES, INCLUDING BUT NOT LIMITED TO ACI, AISC. ZONING, AND THE NEW YORK STATE BUILDING CODE.
- 4. ALL CONDITIONS. LOCATIONS AND DIMENSIONS SHALL BE FIELD VERIFIED AND THE ENGINEER SHALL BE IMMEDIATELY NOTIFIED OF ANY DISCREPANCIES.
- 5. ALL CHANGES MADE TO THE PLANS SHALL BE APPROVED BY THE ENGINEER AND ANY SUCH CHANGES SHALL BE FILED AS AMENDMENTS TO THE ORIGINAL BUILDING PERMIT. 6. THE CONTRACTOR SHALL SUPERVISE AND DIRECT THE WORK USING HIS BEST SKILL AND ATTENTION. HE SHALL BE SOLELY RESPONSIBLE FOR ALL CONSTRUCTION MEANS.
- METHODS, TECHNIQUES, SEQUENCES AND PROCEDURES AND FOR COORDINATING ALL PORTIONS OF THE WORK UNDER THE CONTRACT. 7. THE CONTRACTOR SHALL BE RESPONSIBLE TO THE OWNER FOR THE ACTS AND OMISSION
- OF HIS EMPLOYEES, SUBCONTRACTORS AND THEIR AGENTS AND EMPLOYEES, AND OTHER PERSONS PERFORMING ANY OF THE WORK UNDER A CONTACT WITH THE CONTRACTOR. 8. SAFETY DURING CONSTRUCTION SHALL BE THE RESPONSIBILITY OF THE CONTRACTOR AND
- SHALL CONFORM TO ALL LOCAL, STATE AND FEDERAL AGENCIES IN EFFECT DURING THE PERIOD OF CONSTRUCTION. 9. THE CONTRACTOR AND HIS SUBCONTRACTORS SHALL MAKE APPLICATION TO RECEIVE AL NECESSARY PERMITS TO PERFORM THE WORK UNDER CONTRACT. THE CONTRACTOR AND HIS SUBCONTRACTORS SHALL BE LICENSED TO DO ALL WORK AS REQUIRED BY THE
- LOCAL, COUNTY, AND STATE AGENCIES WHICH MAY HAVE JURISDICTION OVER THOSE TRADES, AND SHALL PRESENT THE OWNER WITH COPIES OF ALL LICENSES AND INSURANCE CERTIFICATES. 10. FINAL GRADING AROUND THE BUILDING AREA SHALL SLOPE AWAY FROM THE STRUCTURE. 11. ALL WRITTEN DIMENSIONS ON THE DRAWINGS SHALL TAKE PRECEDENCE OVER ANY
- SCALED DIMENSIONS. 12. ADJOINING PUBLIC AND PRIVATE PROPERTY SHALL BE PROTECTED FROM DAMAGE DURING CONSTRUCTION, REMODELING AND DEMOLITION WORK. PROTECTION MUST BE PROVIDED FOR FOOTINGS, FOUNDATIONS, PARTY WALLS, CHIMNEYS, SKYLIGHTS AND ROOFS. PROVISIONS SHALL BE MADE TO CONTROL WATER RUNOFF AND EROSION DURING CONSTRUCTION OR DEMOLITION ACTIVITIES. THE PERSON MAKING OR CAUSING AN EXCAVATION TO BE MADE SHALL PROVIDE WRITTEN NOTICE TO THE OWNERS OF ADJOINING BUILDINGS ADVISING THEM THAT THE EXCAVATION IS TO BE MADE AND THAT THE ADJOINING BUILDING SHOULD BE PROTECTED. SAID NOTIFICATION SHALL BE DELIVERED NOT LESS THAN 10 DAYS PRIOR TO THE SCHEDULED STARTING DATE OF THE
- EXCAVATION. 13. OWNER SHALL INSURE THAT THE INSURANCE PROVIDED BY THE CONTRACTOR HIRED TO PERFORM THE WORK SHALL BE ENDORSED TO NAME HUDSON ENGINEERING & CONSULTING, P.C., AND ANY DIRECTORS, OFFICERS, EMPLOYEES, SUBSIDIARIES, AND AFFILIATES, AS ADDITIONAL INSURED ON ALL POLICIES AND HOLD HARMLESS DOCUMENTS, AND SHALL STIPULATE THAT THIS INSURANCE IS PRIMARY, AND THAT ANY OTHER INSURANCE OR SELF-INSURANCE MAINTAINED BY HUDSON ENGINEERING & CONSULTING, P.C., SHALL BE EXCESS ONLY AND SHALL NOT BE CALLED UPON TO CONTRIBUTE WITH THIS INSURANCE. ISO ADDITIONAL INSURED ENDORSEMENT FORM NUMBER CG2010 1185 UNDER GL. COPIES OF THE INSURANCE POLICIES SHALL BE SUBMITTED TO HUDSON
- ENGINEERING & CONSULTING, P.C., FOR APPROVAL PRIOR TO THE SIGNING OF THE CONTRACT. 14. INDUSTRIAL CODE RULE 753: THE CONTRACTOR SHALL NOTIFY ALL UTILITY COMPANIES 72 HOURS PRIOR TO THE START OF HIS OPERATIONS AND SHALL COMPLY WITH ALL THE LATEST INDUSTRIAL CODE RULE 753 REGULATIONS.

## INSTALLATION & MAINTENANCE OF EROSION CONTROL:

CONSTRUCTION SCHEDULE NOTIFY APPROPRIATE MUNICIPAL AGENCY HAVING JURISDICTION AT LEAST 5 DAYS PRIOR TO START.

EROSION CONTROL MEASURES INSTALL ALL EROSION CONTROL MEASURES PRIOR TO START OF CONSTRUCTION. CALL FOR INSPECTION FROM THE APPROPRIATE MUNICIPAL AGENCY HAVING JURISDICTION AT LEAST 2 DAYS PRIOR TO FINISH.

### INSPECTION BY MUNICIPALITY MAINTENANCE (TO BE PERFORMED DURING ALL PHASES OF CONSTRUCTION)

AFTER ANY RAIN CAUSING RUNOFF, CONTRACTOR TO INSPECT HAYBALES, ETC. AND REMOVE ANY EXCESSIVE SEDIMENT AND INSPECT STOCKPILES AND CORRECT ANY PROBLEMS WITH SEED ESTABLISHMENT. INSPECTIONS SHALL BE DOCUMENTED IN WRITING AND SUBMITTED TO THE APPROPRIATE MUNICIPAL AGENCY HAVING JURISDICTION.

## INSPECTION BY MUNICIPALITY - FINAL GRADING REMOVE UNNEEDED SUBGRADE FROM SITE.

CALL FOR INSPECTION FROM THE APPROPRIATE MUNICIPAL AGENCY HAVING JURISDICTION AT LEAST 2 DAYS PRIOR TO FINISH.

INSPECTION BY MUNICIPALITY - LANDSCAPING

SPREAD TOPSOIL EVENLY OVER AREAS TO BE SEEDED. HAND RAKE LEVEL. BROADCAST 1.25 LB. BAG OF JONATHAN GREEN "FASTGROW" MIX OR EQUAL OVER AREA TO BE SEEDED. APPLY STRAW MULCH AND WATER WITHIN 2 DAYS OF COMPLETION OF TOPSOILING. CALL FOR INSPECTION FROM THE APPROPRIATE MUNICIPAL AGENCY HAVING JURISDICTION AT LEAST 2 DAYS PRIOR TO FINISH.

INSPECTION BY MUNICIPALITY - FINAL LANDSCAPING

GRASS ESTABLISHED. CALL FOR INSPECTION FROM THE APPROPRIATE MUNICIPAL AGENCY HAVING JURISDICTION AT LEAST 2 DAYS PRIOR TO FINISH.

INSPECTION BY MUNICIPALITY - FINAL INSPECTION

ALL EROSION CONTROL MEASURES REMOVED AND GRASS ESTABLISHED. CALL FOR INSPECTION FROM THE APPROPRIATE MUNICIPAL AGENCY HAVING JURISDICTION AT LEAST 2 DAYS PRIOR TO FINISH.

### TEST HOLE DATA;

- TEST HOLE #1 DEPTH – 72" 0-12" TOPSOIL 12-72" SILTY LOAM NO GROUNDWATER LEDGE ROCK @ 72" PERC. = 53.3 INCHES/HOUR TEST HOLE #2 DEPTH – 60" 0-12" TOPSOIL
- 12-60" SILTY LOAM W/ ROCKS NO GROUNDWATER LEDGE @ 60" PERC. = 21 INCHES/HOUR

### TEST HOLE #3 DEPTH - 72" 0-12" TOPSOIL

12-72" FILL WITH SILTY LOAM NO GROUNDWATER LEDGE @ 72" PERC. = 45.1 INCHES/HOUR

- TEST HOLE #4
- DEPTH 396" 0-12" TOPSOIL
- 12-36" SILTY LOAM NO GROUNDWATER LEDGE @ 36"

