C H R I S T I N A G R I F F I N A R C H I T E C T

GENERAL NOTES

- 1. These documents remain the exclusive property of the Architect, and may not be used for any purpose whatsoever without written consent of the Architect.
- 2. All construction shall comply fully with the 2020 Residential code of NYS, local building code, fire department regulations, and all other agencies having jurisdiction over project.
- 3. Approved stamped set of building plans must be present 14. All construction sites shall conform to the 2020 New on site for all inspections.
- 4. A current Westchester County licensed and insured contractor must be on file with current building permit until Certificate of Occupancy is issued. If contractor of record has been removed from the project, a stop work order will be issued untill a new Westchester County licensed and insured contractor is retained.
- 5. General Contractor shall carry property damage insurance, public liability insurance, workman's compensation, auto insurance, and general liability as required by Federal, State, and Local Codes and as Owner requires.
- 6. Licensed electrician to file separate electrical permit.
- 7. Licensed plumber to file separate plumbing permit. 8. All health, safety, fire, zoning and environmental regulations shall be adhered to at all times by the Owner and/or occupant.
- 9. The contractor shall become familiar with conditions of the site, and the work as shown on the construction documents, prior to submitting a bid for construction.
- 10. Contractors shall coordinate all work procedures and working hours with local authorities, neighborhood associations, and any other governing authorities.
- 11. The contractor shall be responsible for providing all labor and materials to complete the project, in accordance with the construction documents, tested and ready for owner's use.
- 12. All indicated Survey material is for general reference only. The Architect assumes no responsibility for the

accuracy or the correctness of any of the indicated material.

- 13. Contractors shall be responsible for protection of all existing and new conditions and materials with and adjacent to the construction area. Any damage caused by the execution of the work indicated or implied herein shall be repaired or replaced to the Owner's satisfaction.
- York State Property Maintenance Code. All rubbish garbage and construction debris shall be disposed of in an onsite dumpster or removed off site immediately. Materials shall be stacked in orderly fashion as to not create a blight on the community. The village right of way must be kept clear and maintained at all times.
- 15. General contractor shall be responsible for the removal 23. The drawings and notes are intended to be complete. of construction debris, rubbish and offsite disposal in a responsible manner.
- 16. The contractor shall obtain all inspections, approvals and permits, and pay all necessary permit fees required by the local building department and all other agencies having jurisdiction over the project, such as plumbing, electrical & HVAC, except for the building permit, which shall be obtained by the Architect. The contractor shall obtain the certificate of occupancy for the project when construction is complete.
- 17. Contractor shall keep work site free from debris and accumulated refuse, and shall have sole responsibility for protecting all dangerous areas from entry by unauthorized parties.
- 18. Drawings may be rough scaled for estimating and general purposes, but are not to be scaled for construction locations, dimensions, or any other purposes. Dimensions shown shall govern over measurements scaled from plans. Wall dimensions are given to finished surfaces. Contractor to consult with the Architect for questions regarding final dimensions and locations.
- 19. All dimensions and conditions shown and assumed on the drawings must be verified at the site by contractor

- before ordering any material or doing any work.
- 20.Contractor is to design and install adequate and code approved shoring and bracing where needed to safely complete structural work. Contractor to assume full and 28. The co sole responsibility for structural adequacy of the shoring that m and for any injuries, damages, cracks, or defects caused come by shoring or bracing, and shall repair all such damage at his sole expense.
- 21. The Architect is not responsible for workmanship, construction methods, or any omissions or derivations from the drawings during construction.
- 22.Materials and products indicated on drawings shall be installed in accordance with manufacturer's requirements.
- Should anything be omitted from the drawings necessary to the proper construction of the work herein described, it 31.If blow shall be the duty of the contractor to notify the Architect. The builder shall visit the site and inform the Architect of any discrepancies of field conditions that may interfere with the total completion of all work included within the contract and verify all conditions prior to the ordering of materials and the start of construction.
- 24.Minor details not usually shown or specified, but necessary for proper and acceptable construction, installation or operation of any part of the work shall be 32. All wo included in the work the same as specified or indicated.
- 25. The contractor shall supervise and direct the work using his best skill and attention, he shall be solely responsible for all construction means, methods, sequences and procedures and for coordination of all portions of the work.
- 26. The use of the words "provide" or "provided" in connection with any item specified is intended to mean 33. Substit that such item be furnished and installed and connected where required.
- 27.Contractor shall maintain a sealed enclosure between work area and other areas of the residence. In addition,

- or as r 29.New a seaml finishe
- primin 30.All ins Certifi
- Const Archite
- to sub thickn installe
- insulati in a co the 202
- submi Depar
- payme guara agains
- materi solely replac at no o
- showr made noted
- contra before

RENOVATIONS AND EXTENSIONS TO THE

JACOB RESIDENCE

110 BUENA VISTA DRIVE, DOBBS FERRY, NY 10522

10 Spring Street, Hastings-on-Hudson, NY 10706



				INSULATION AND FENESTRATION REQUIREMENT BY COMPONENT												
1 () 1		Energy Notes R-Values & U-Factors 2020 Residential code of NYS - Climate Zone	44	CLIM. ZON	NE	FENESTF U-FAC	TOR	U-F	YLIGHT _b ACTOR	FENES	AZED STRATION HGC ^{b,e}		CEILING R-VALUE	V	VOOD FF VALL R-V	ALUE
broom sweep all areas at end of each work day. 28. The contractor shall do all the cutting, fitting & patching	opinion, the item offered is not equal or detailed on the drawings, which requires any redesign of the structure,	RequiredProposedCeilingR-49R-49	Required Proposed	4/	4	0.3 MASS V	WALL	FI	0.55 _ OOR	BAS	0.40 EMENT°		49 ∖Bª R-VAL	JE C	20 or 1 RAWL S	PACE
that may be required to make several parts of the work come together properly, and to fit his work, and/or	detailing required therefore shall, with the approval of the	5	e		_	R-VAL 8/13(R-\	VALUE 19		R-VALUE /13(c)		& DEPTH D, 2FT(d)		VALL R-V 	
detailing required therefore shall with the approval of the	rement for ompressed at eaves. es that I have best of my	 a. R-values are minimums. U-factors and SHGC are maximums. Where insulation is installed in a cavity that is less than the label or design thickness of the insulation, the installed R-value of the insulation shall be not less than the R-value specified in the table. b. The fenestration U-factor column excludes skylights. The SHGC column applies to all glazed fenestration. c. d. "10/13" means R-10 continuous insulation on the interior or exterior of the home or R-13 cavity insulation on the interior of the basement wall. "15/19" means R-15 continuous insulation on the interior or exterior of the home or R-19 cavity insulation at the interior of the basement wall. Alternatively, compliance with "15/19" shall be R-13 cavity insulation on the interior of the basement wall plus R-5 continuous insulation on the interior of the home. e. R-5 insulation shall be provided under the full slab area of a heated slab in addition to the required slab edge insulation R-value for 								or for vity						
at no cost to owner.	repairs to damaged blacktop. Finish materials and paint colors shall be reviewed and approved by the homeowner.			GROUND	SPEED	WIND DE		/IND	SEISMIC	SUBJECT T	FROST			ELOOD	AIR	MEAN
- · ·	The Architect assumes no responsibility for the accuracy or correctness of any material or drawings prepared by others and provided to the Architect.			SNOW LOAD 30 PSF	(MPH)	EFFECTS V	WIND B REGION D		DESIGN CATAGORY B	WEATHERING	42" M	IODERATE TO HEAVY	YES	FLOOD HAZARDS	FREEZING INDEX	ANNUAL TEMP.







ZONING BOARD SUBMISSION 10-18-2020


DATES

BUILDING PERMIT SUBMISSION PRE-BID DRAWINGS ZONING BOARD SUBMISSION

08-21-20 08-24-20 11-18-20


LIST of DRAWINGS

TITLE SHEET	GENERAL NOTES, ZONING DATA,							
	, , ,							
	CLIMATIC & GEOGRAPHIC CRITERIA,							
	LIST OF DRAWINGS, DATES							
S-1	SITE PLAN, ZONING DATA, AERIAL VIEW							
D-1	EXISTING FLOOR PLANS							
A-1	PROPOSED FLOOR PLANS							
A-2	EXTERIOR ELEVATIONS							
A-3	SKY EXPOSURE PLANE DIAGRAMS							
A-4	BUILDING SECTIONS							

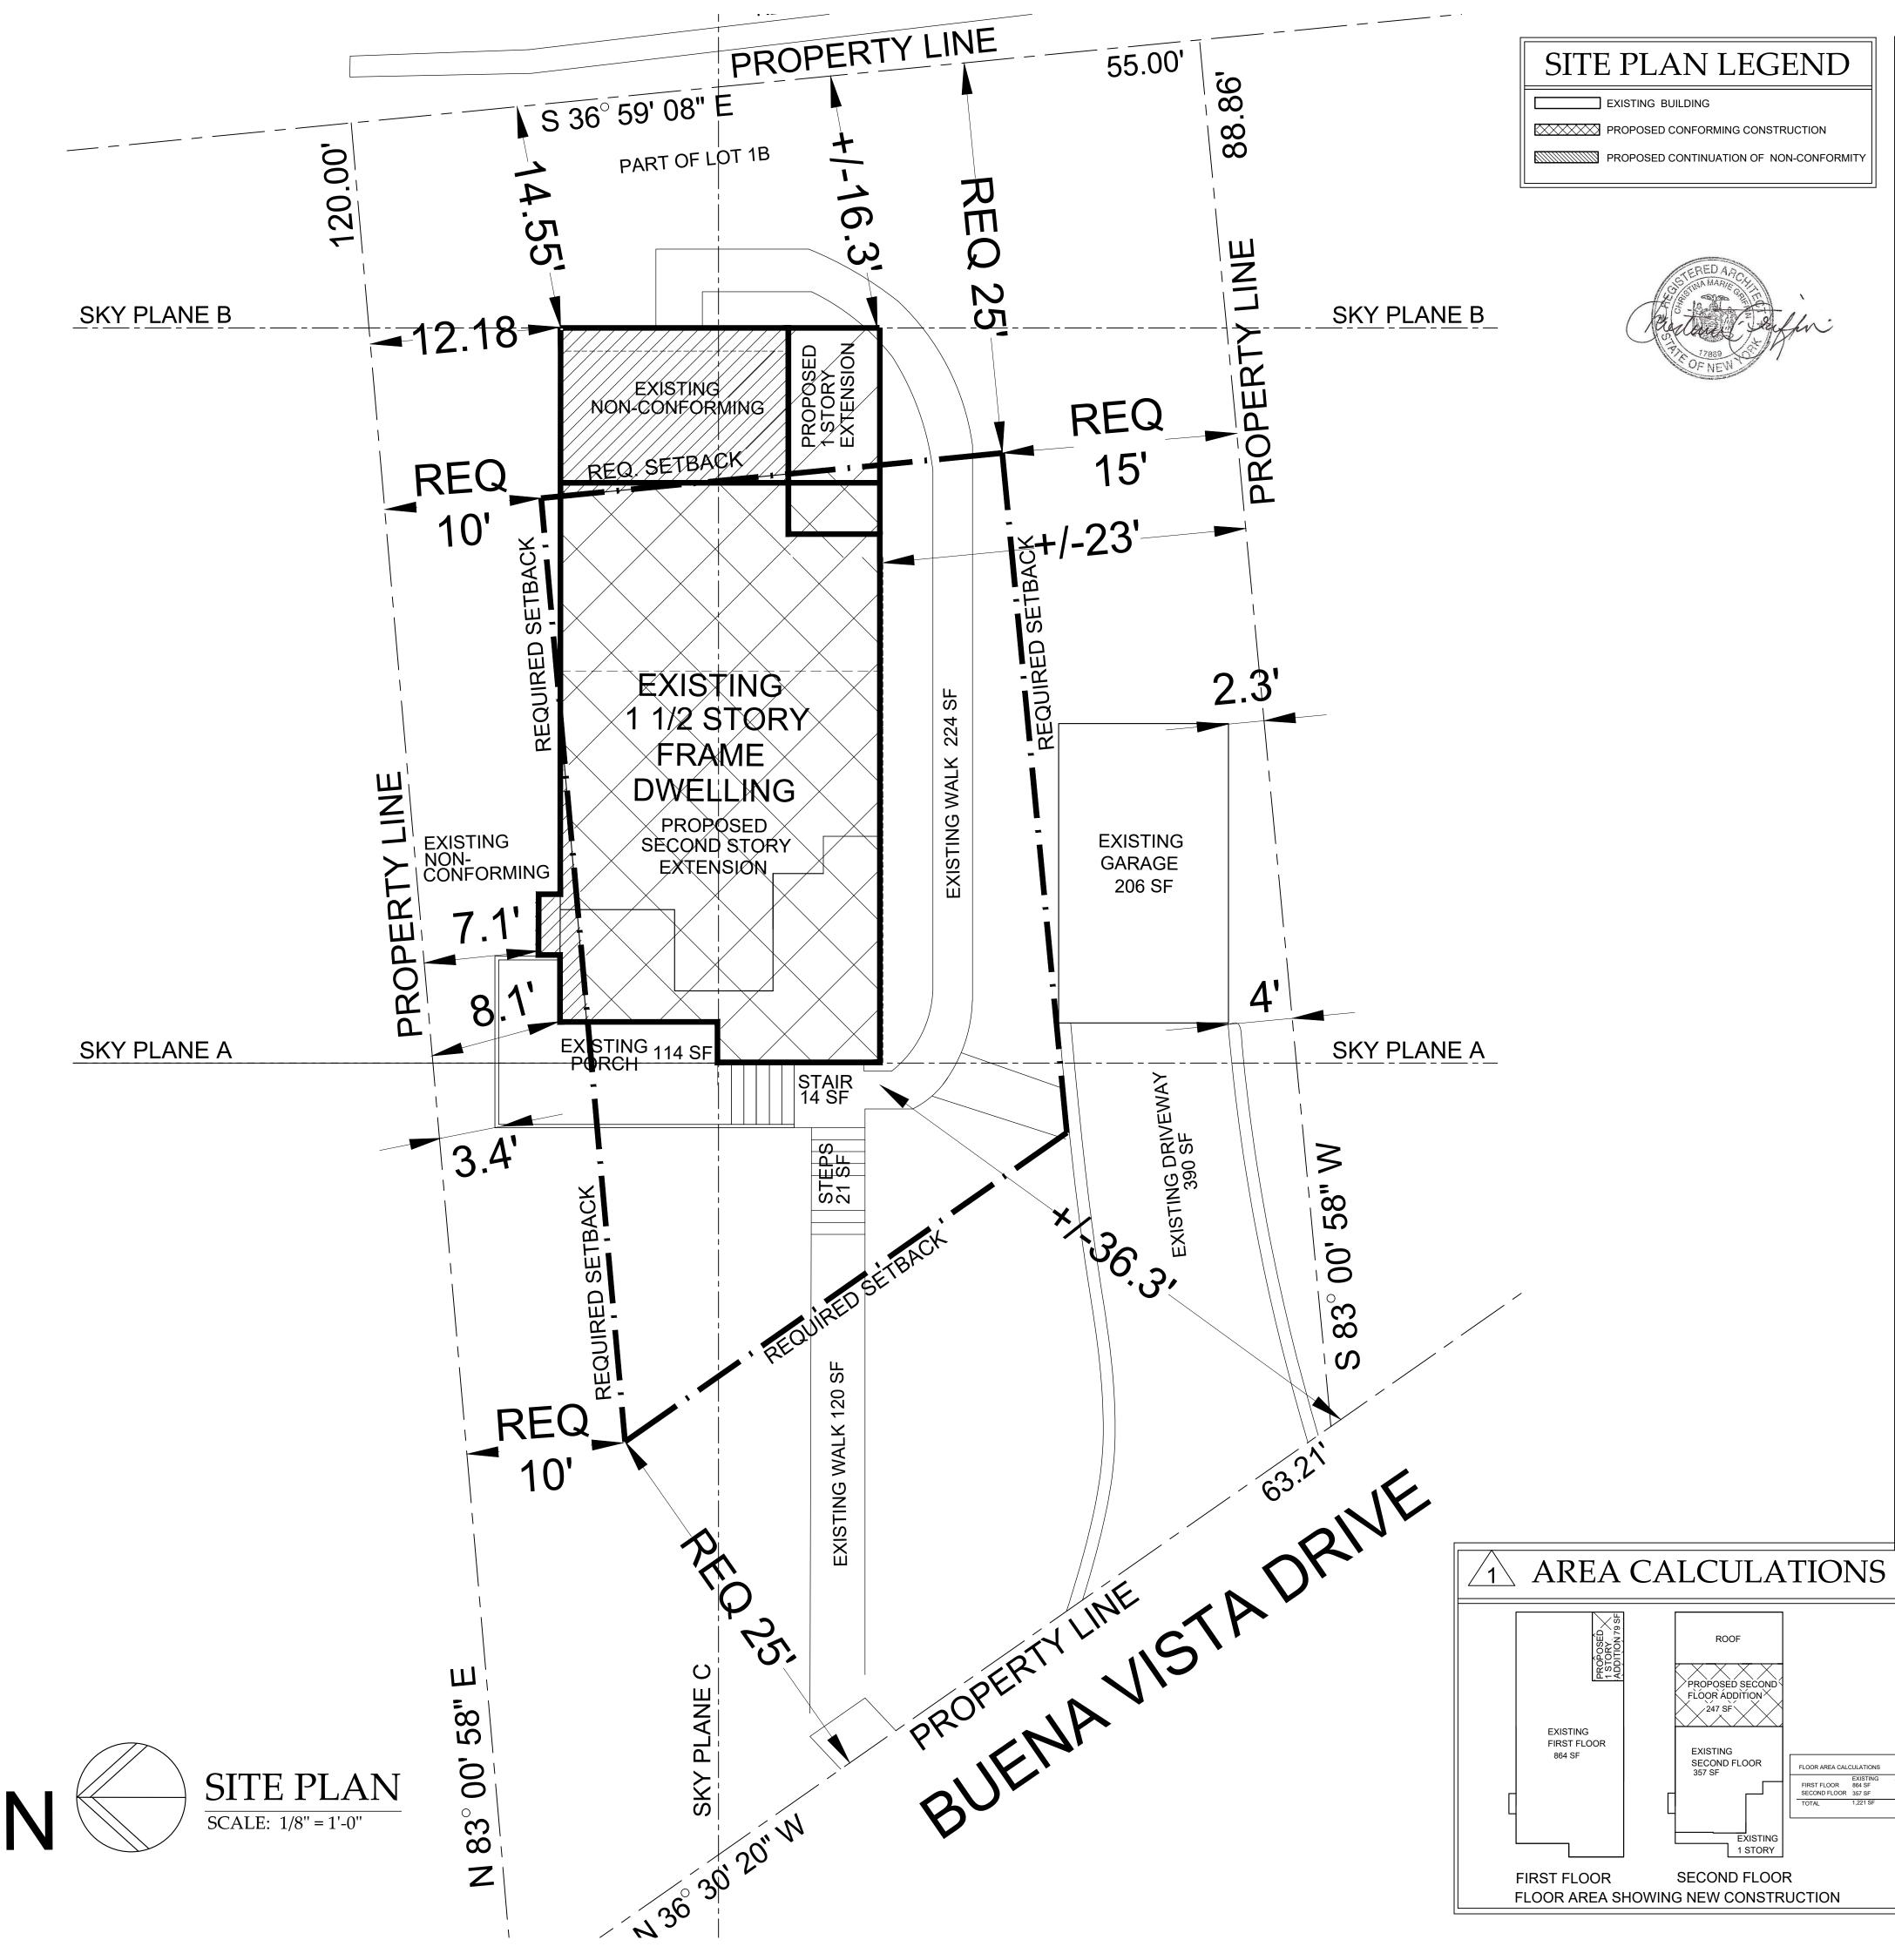

OWNERS: CHRISTINE JACOB ZONING DISTRICT: OF-5 PRESENTLY CONFORMING: NO	<u>SHEET</u> : 3.16 <u>BLOCK</u> : 142 <u>LOT</u> : 25	2 ENGINEERING & LAN SURVEY DATE: MA	ID SURVEYING, PLLC		
	REQUIRED	EXISTING	PROPOSE		E 10522
OT AREA	7,500 SF	+/- 5713 SF	+/- 5713 SF		10 E
	25% X 5,713	978 SF / 17%	1058 SF	/ 18.5%	
OVERAGE LL IMPERVIOUS URFACES ICLUDING BUILDING, ORCHES, WALKS, ONCRETE PADS, TEPS, PATIO & WALLS	= 1,428 SF MAX 44% X 5,713 = 2513 SF MAX	incl. garage 1184 SF / 21% STRUCTURES 1184 SF PATIOS 0 SF PORCH 114 SF WALKS 344 SF OTHER 35 SF	 incl. garage1264 STRUCTURES PATIOS PORCH WALKS OTHER 		on to E Ferry,
,		TOTAL 1677 SF / 29 %	TOTAL 1757 \$	SF / 31 %	INSIC NC OBBS
RIVEWAY		390 SF	390 SF		S S S S S S S S S S S S S S S S S S S
NIMUM LOT WIDTH	75 FT	55 FT*	55*		
NIMUM LOT DEPTH	100 FT	120 FT	120 FT		EXT DE VE, D
TBACK DIMENSIONS	25 FT				
IE SIDE YARD	25 F I 10 FT	+/- 36.3 FT 7.1 FT*	+/- 36.3 F 7.1. FT **	•	DR DR
OTH SIDE YARD (Min)	25 FT	30.1 FT	30.1 FT		A L A A
AR YARD	25 FT	14.55 FT*	14.55 FT*	*	
					NON VIST
					A V B
SITE KEY					
	ية. م				
	PLANE B12.18	учи <u>V</u> LINE <u>7</u> LINE <u>7</u> LINE <u>8</u> 88 88 00 <u>10</u> <u>10</u> <u>1</u>			RENC JAC 110 BU
	REQ 10'	REQ 15' tt/-23'			·
<u>-90</u>	PLANE A CONTROL OF CON	PROFERENCE BUEFNA VISTA DRIVE			GRIFFIN ARCHITECT PC reet Hudson, New York 10706 9 tel 914.478.0806 fax agriffinarchitect.com
AERIAL VIE	EW				IRISTINA Spring Str stings-on- 4.478.079 ww.christin
					Date BUILDING PERMIT SUBMISSION 8-21-20 PRE-BID DRAWINGS 8-25-20 PLANNING BOARD SUBMISSION 10-15-20
ARE	NOVATED A 2 SF ISTING 2ST FLOOR TAL 864 SF RENOVATED	ROOF PROPOSED SECOND FLOOR ADDITION 247 SF RENOVATED AREA 317 SF	EA CALCULATIONS		Drawing Title SITE PLAN ZONING DATA ZONING DATA Scale: AS SHOWN




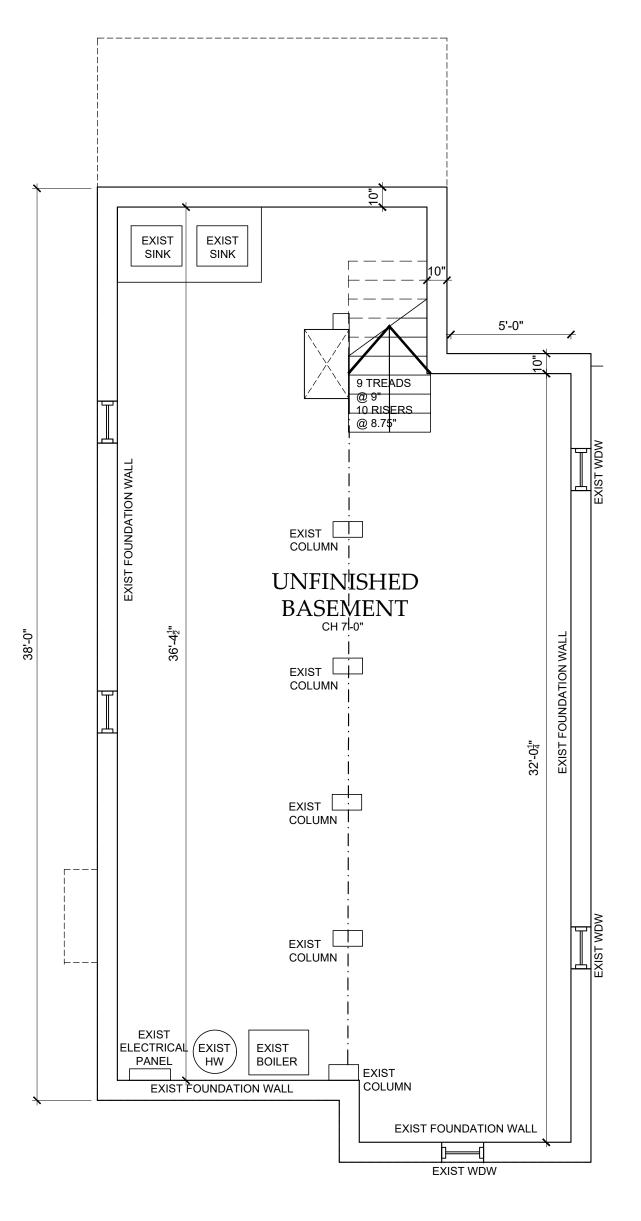





FIRST FLOOR PLAN SCALE: 1/4" = 1'-0"


EXISTING

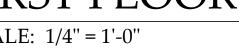


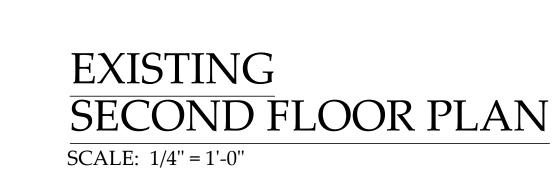

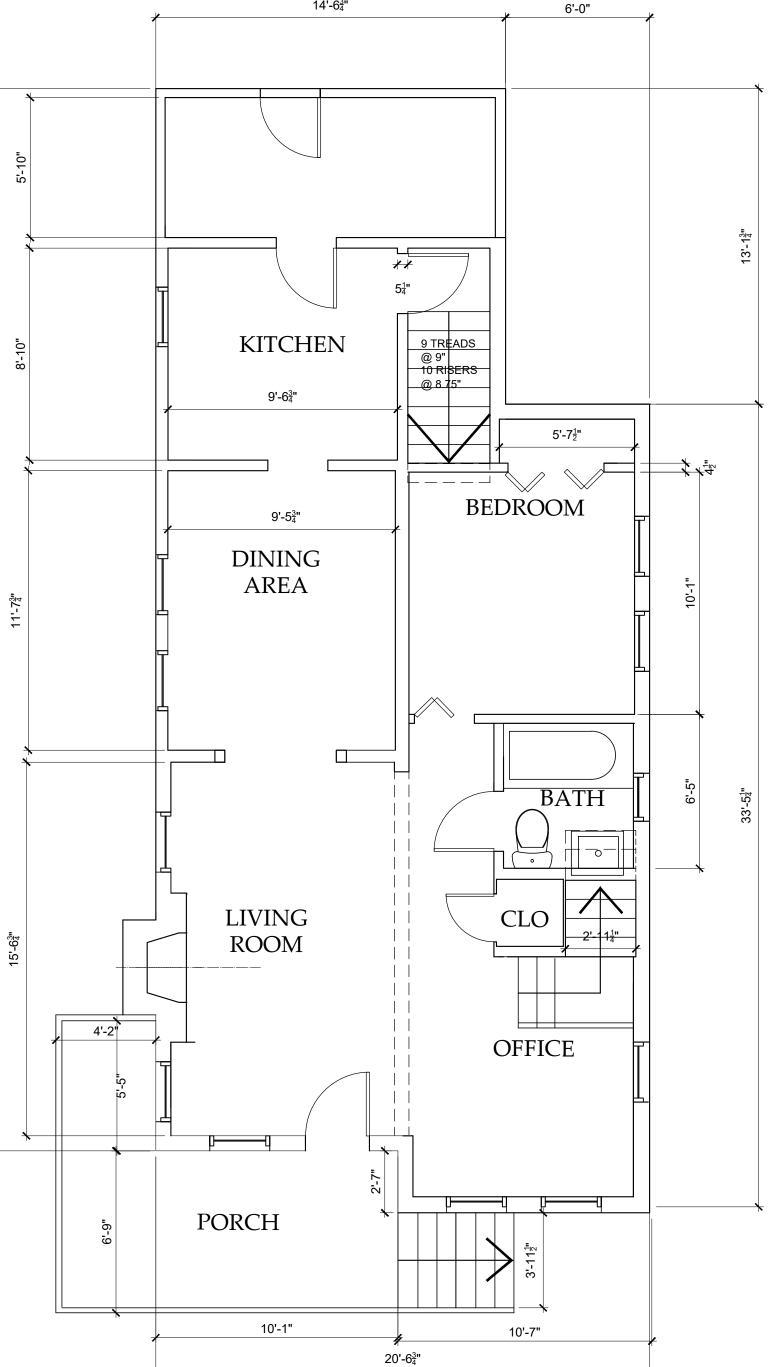

14'-6<u>3</u>"

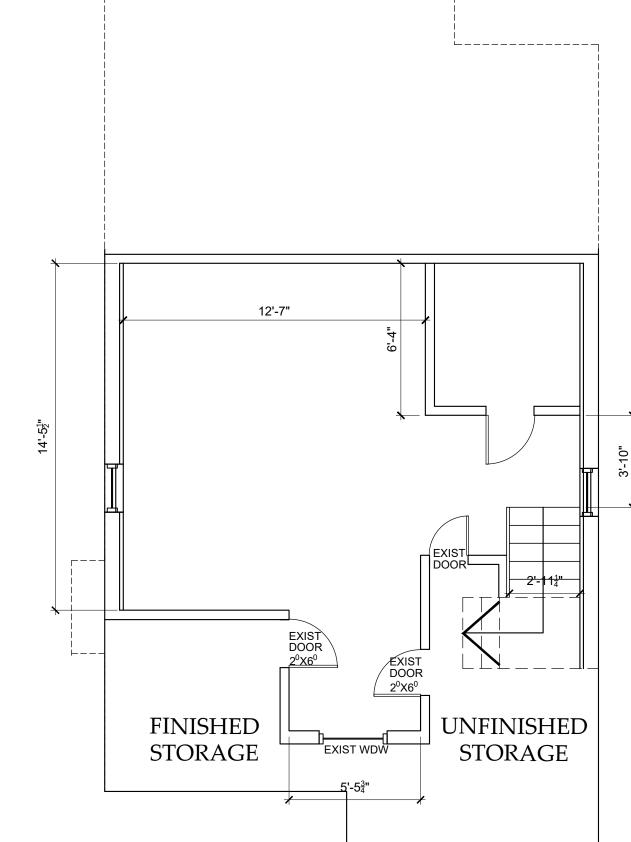

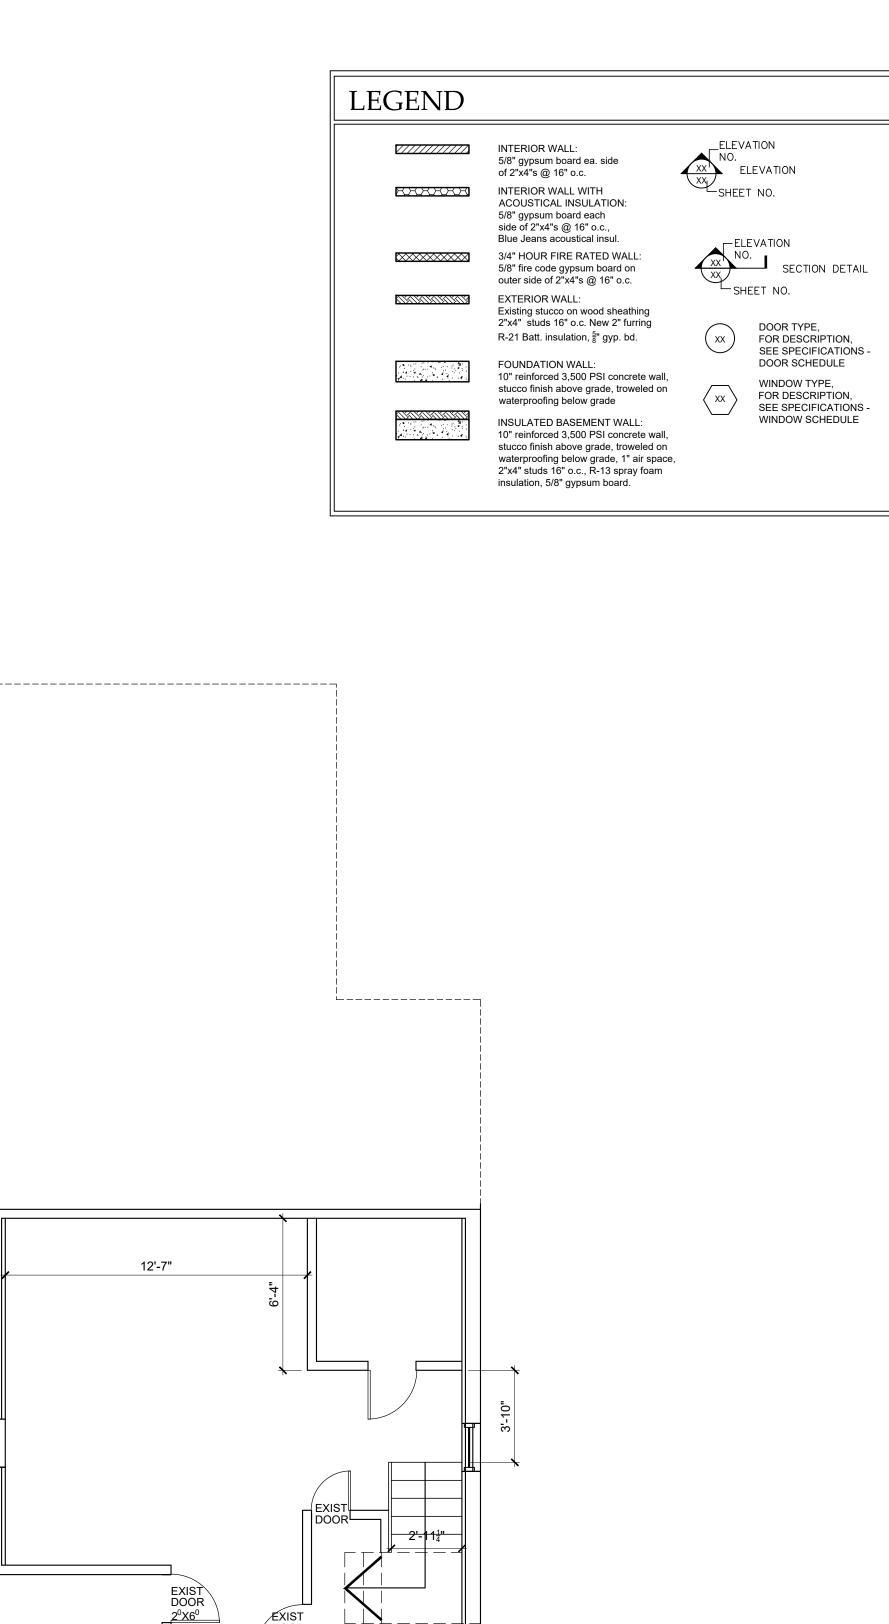

FERRY, \bigcirc [-Ζ I SIO OBBS TEN \square Гт \times Щ \frown ΓŢ Π DRI \square S. Ζ A $[\mathbf{I}]$ TION \mathbf{N} S \mathbf{m} A E \geq O B $\mathbf{E}\mathbf{N}$ 10 \mathbf{N} $\overline{}$ PC 0706 ax ECT

10522

ΝΥ


Ц

Η

Ξ

 CHRISTINA GRIFFIN ARCHITE CHRISTINA GRIFFIN ARCHITE TO Spring Street Hastings-on-Hudson, New York 10 914.478.0799 tel 914.478.0806 fax www.christinagriffinarchitect.com
Date BUILDING PERMIT SUBMISSION 8-21-20 PRE-BID DRAWINGS 8-25-20 PLANNING BOARD SUBMISSION 10-15-20 ZONING BOARD SUBMISSION 11-18-20
Drawing Title EXISTING FLOOR PLANS Scale: AS SHOWN
D-1



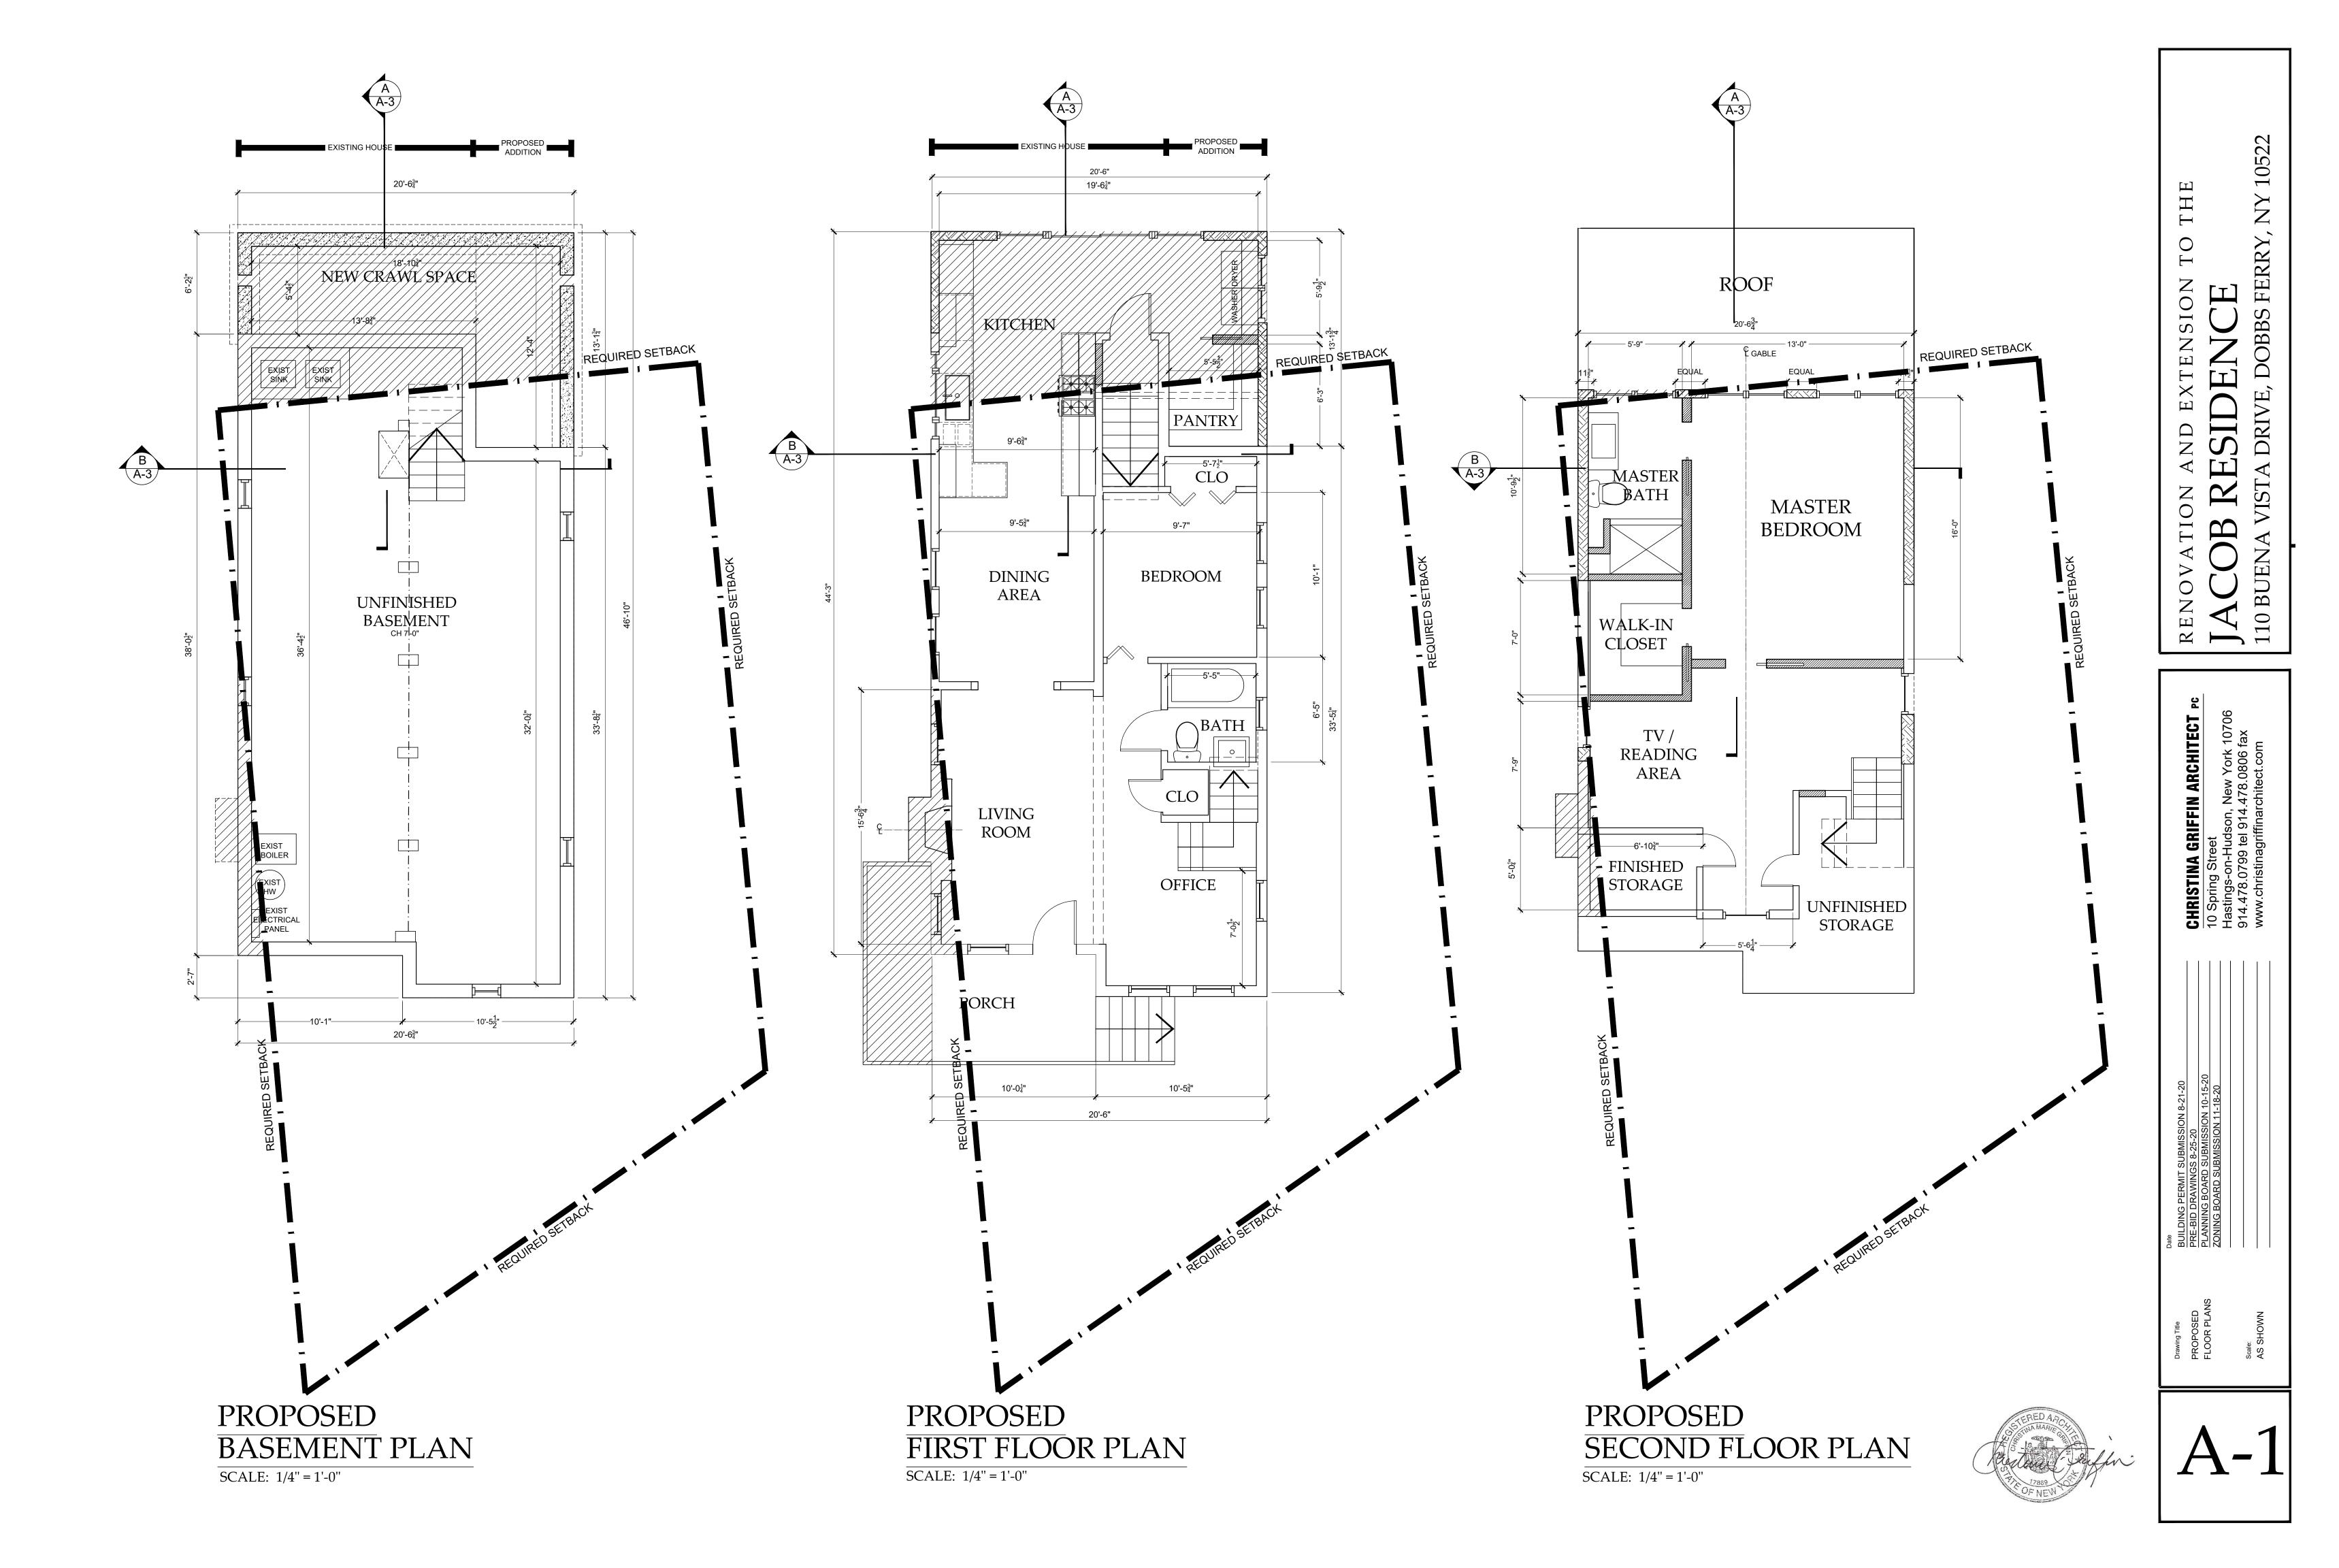



13-0 ¹ /2-	
	EXIST WDW

NORTH ELEVATION

SCALE: 1/4" = 1'-0"




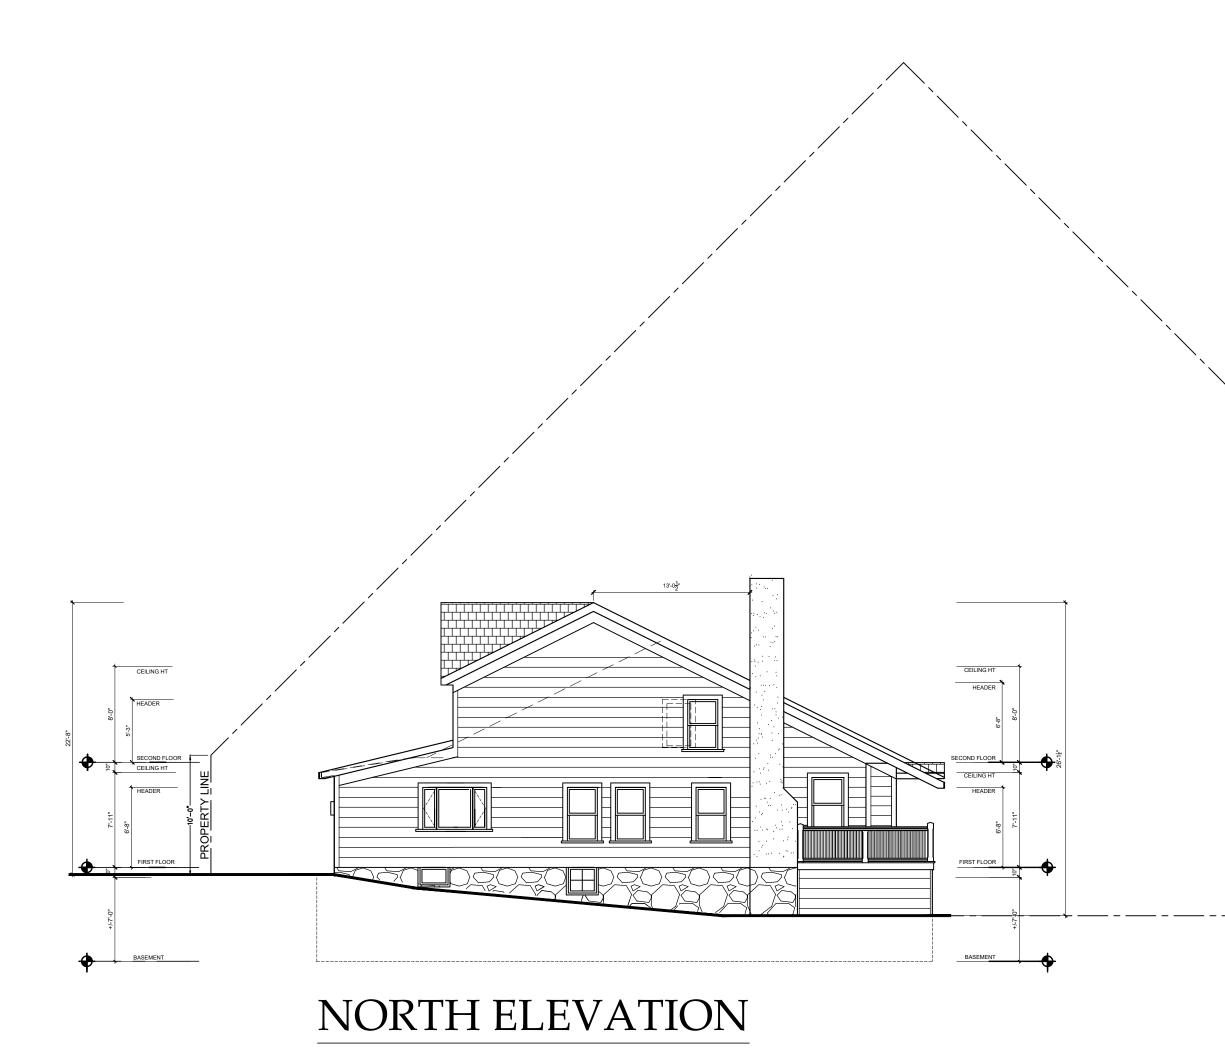


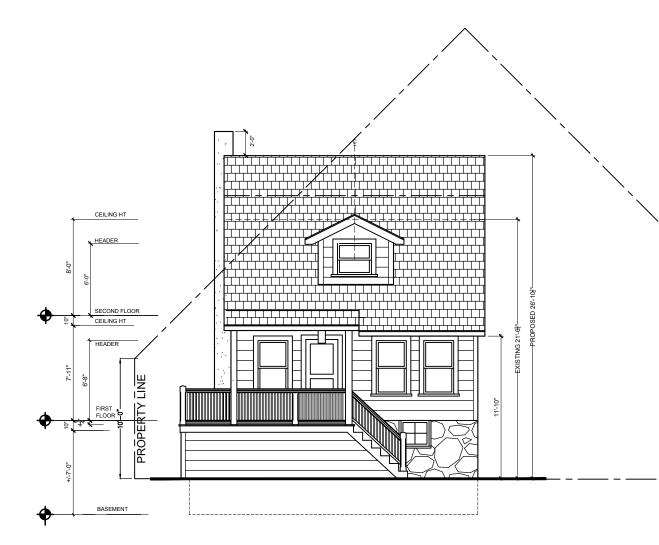


WEST ELEVATION

SKY EXPOSURE PLANE DIAGRAMS SCALE: 1/8" = 1'-0"

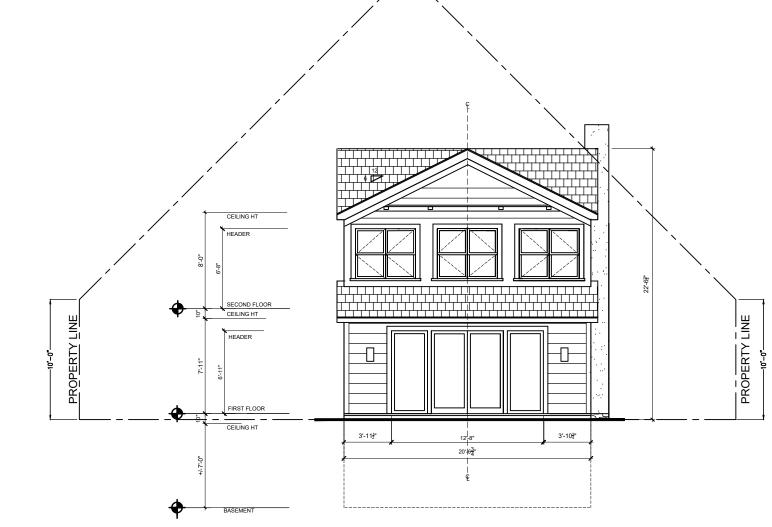

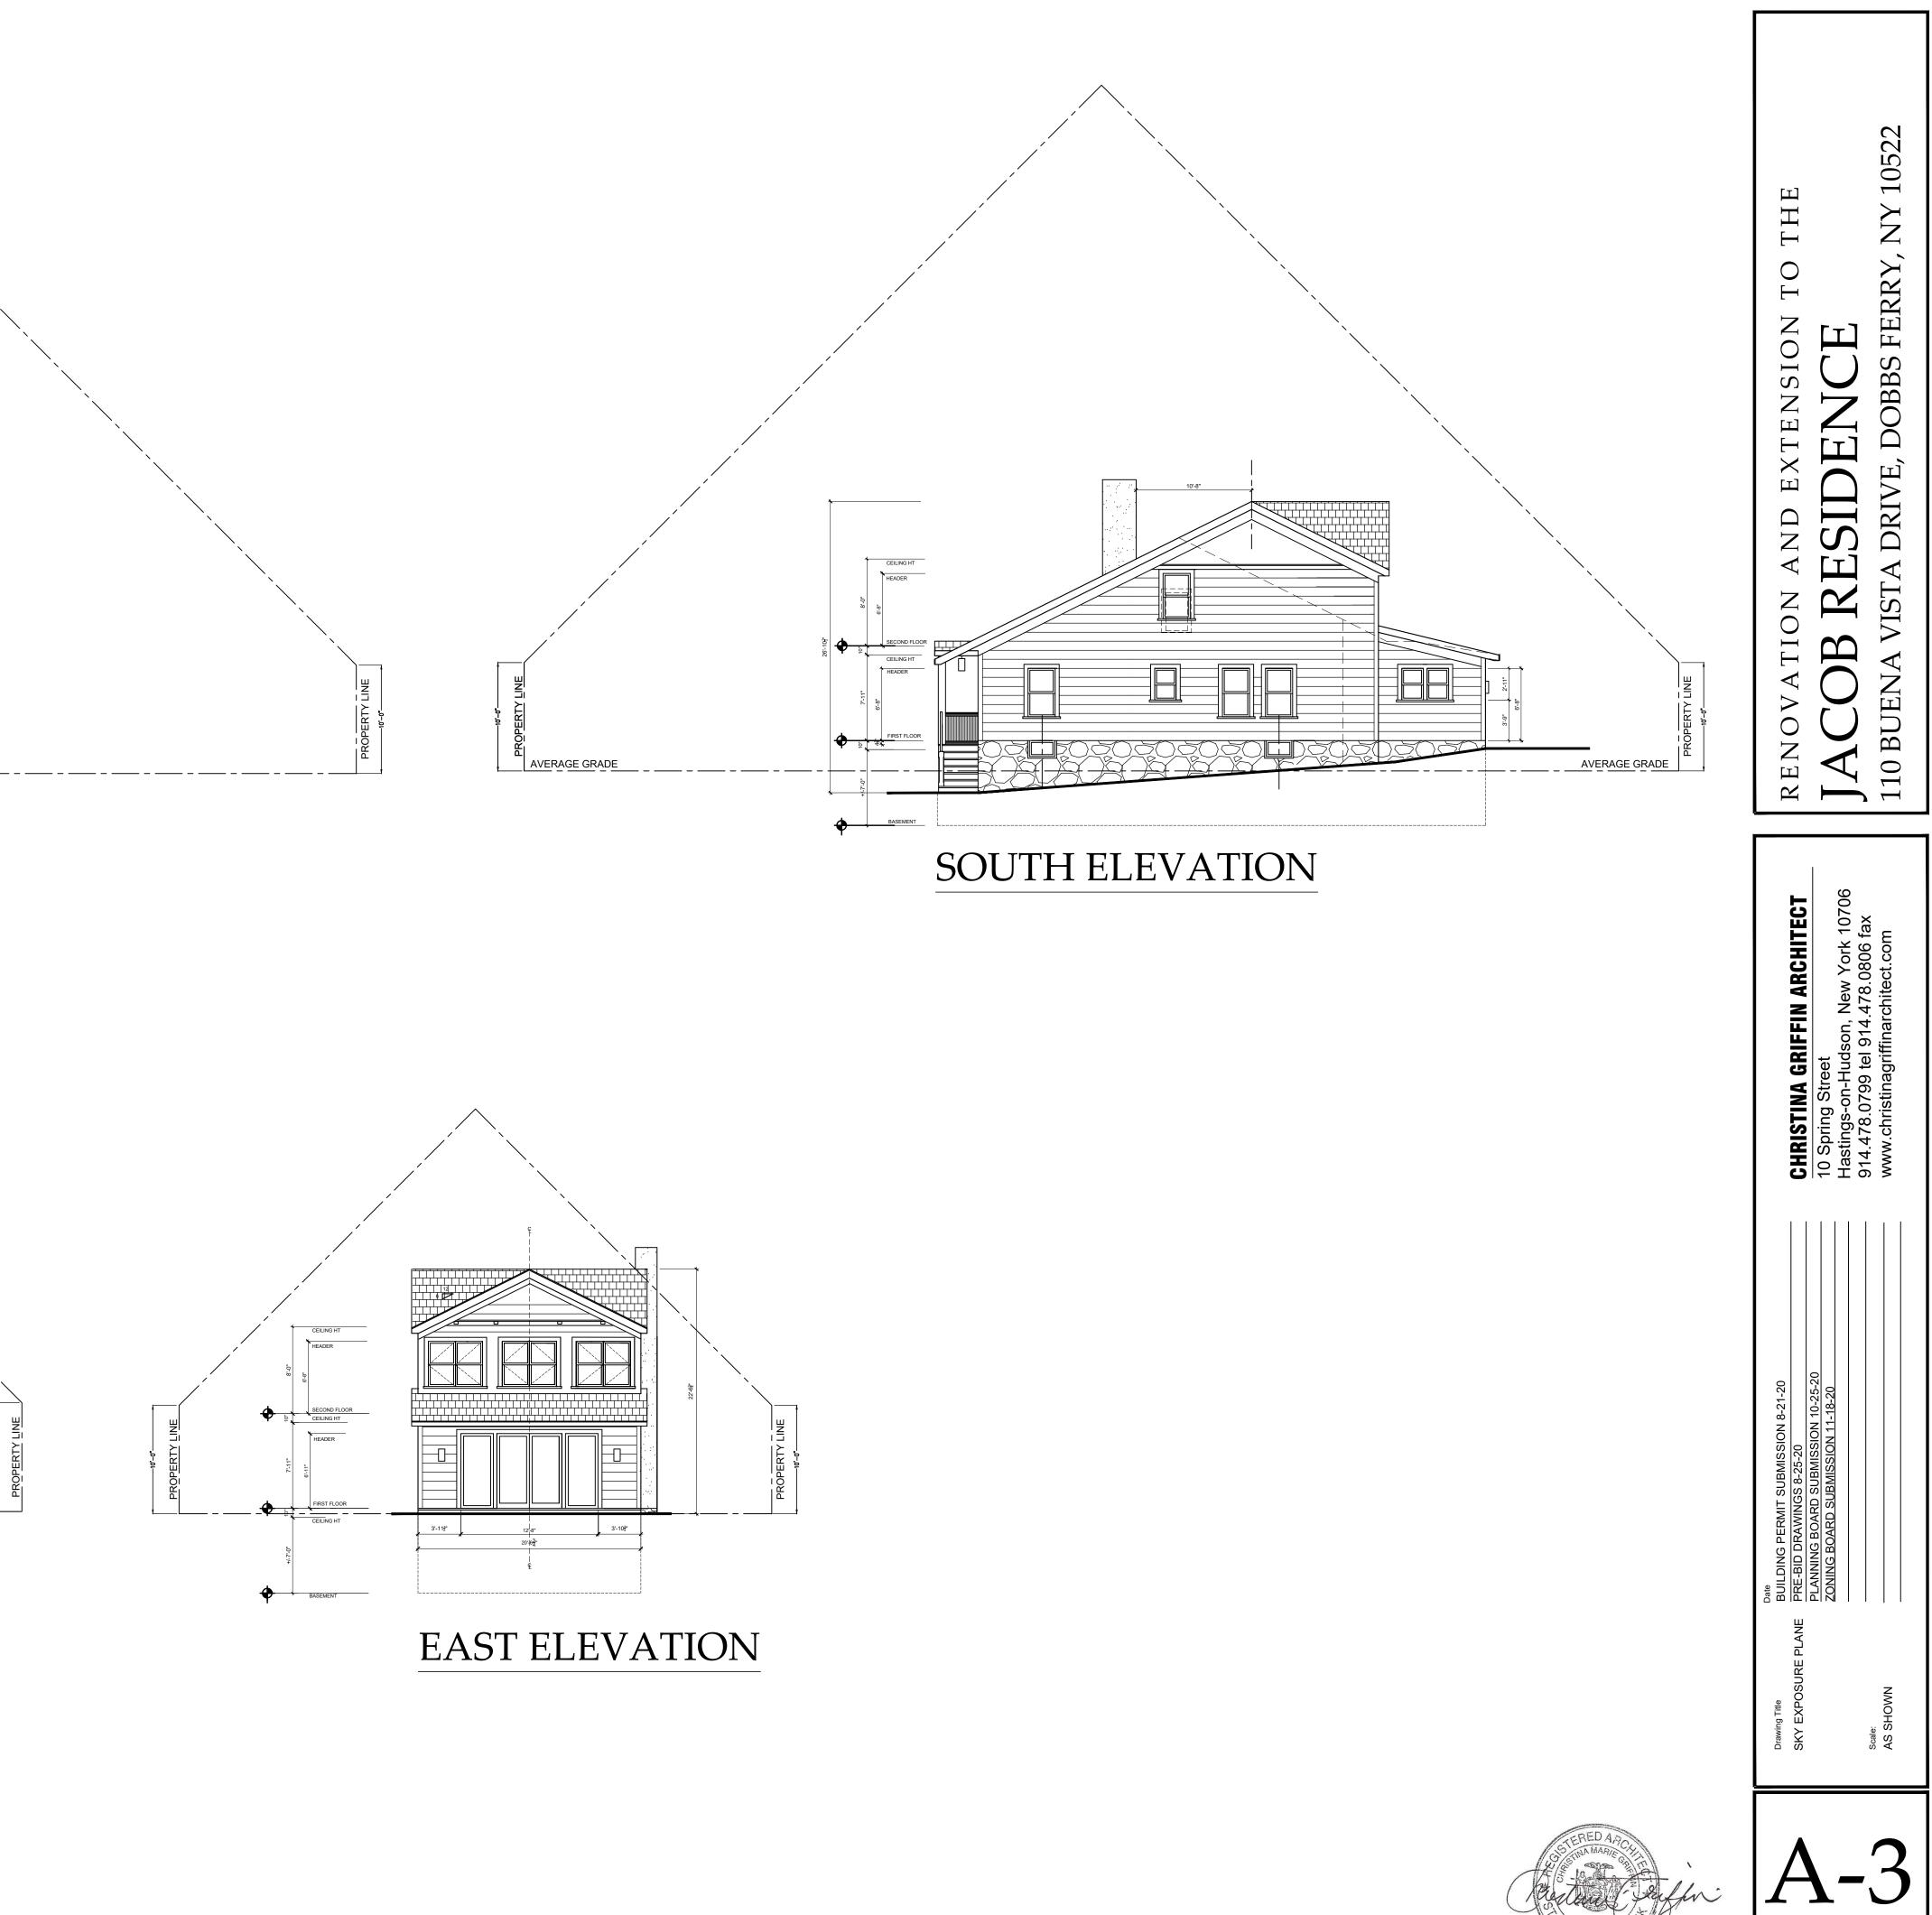

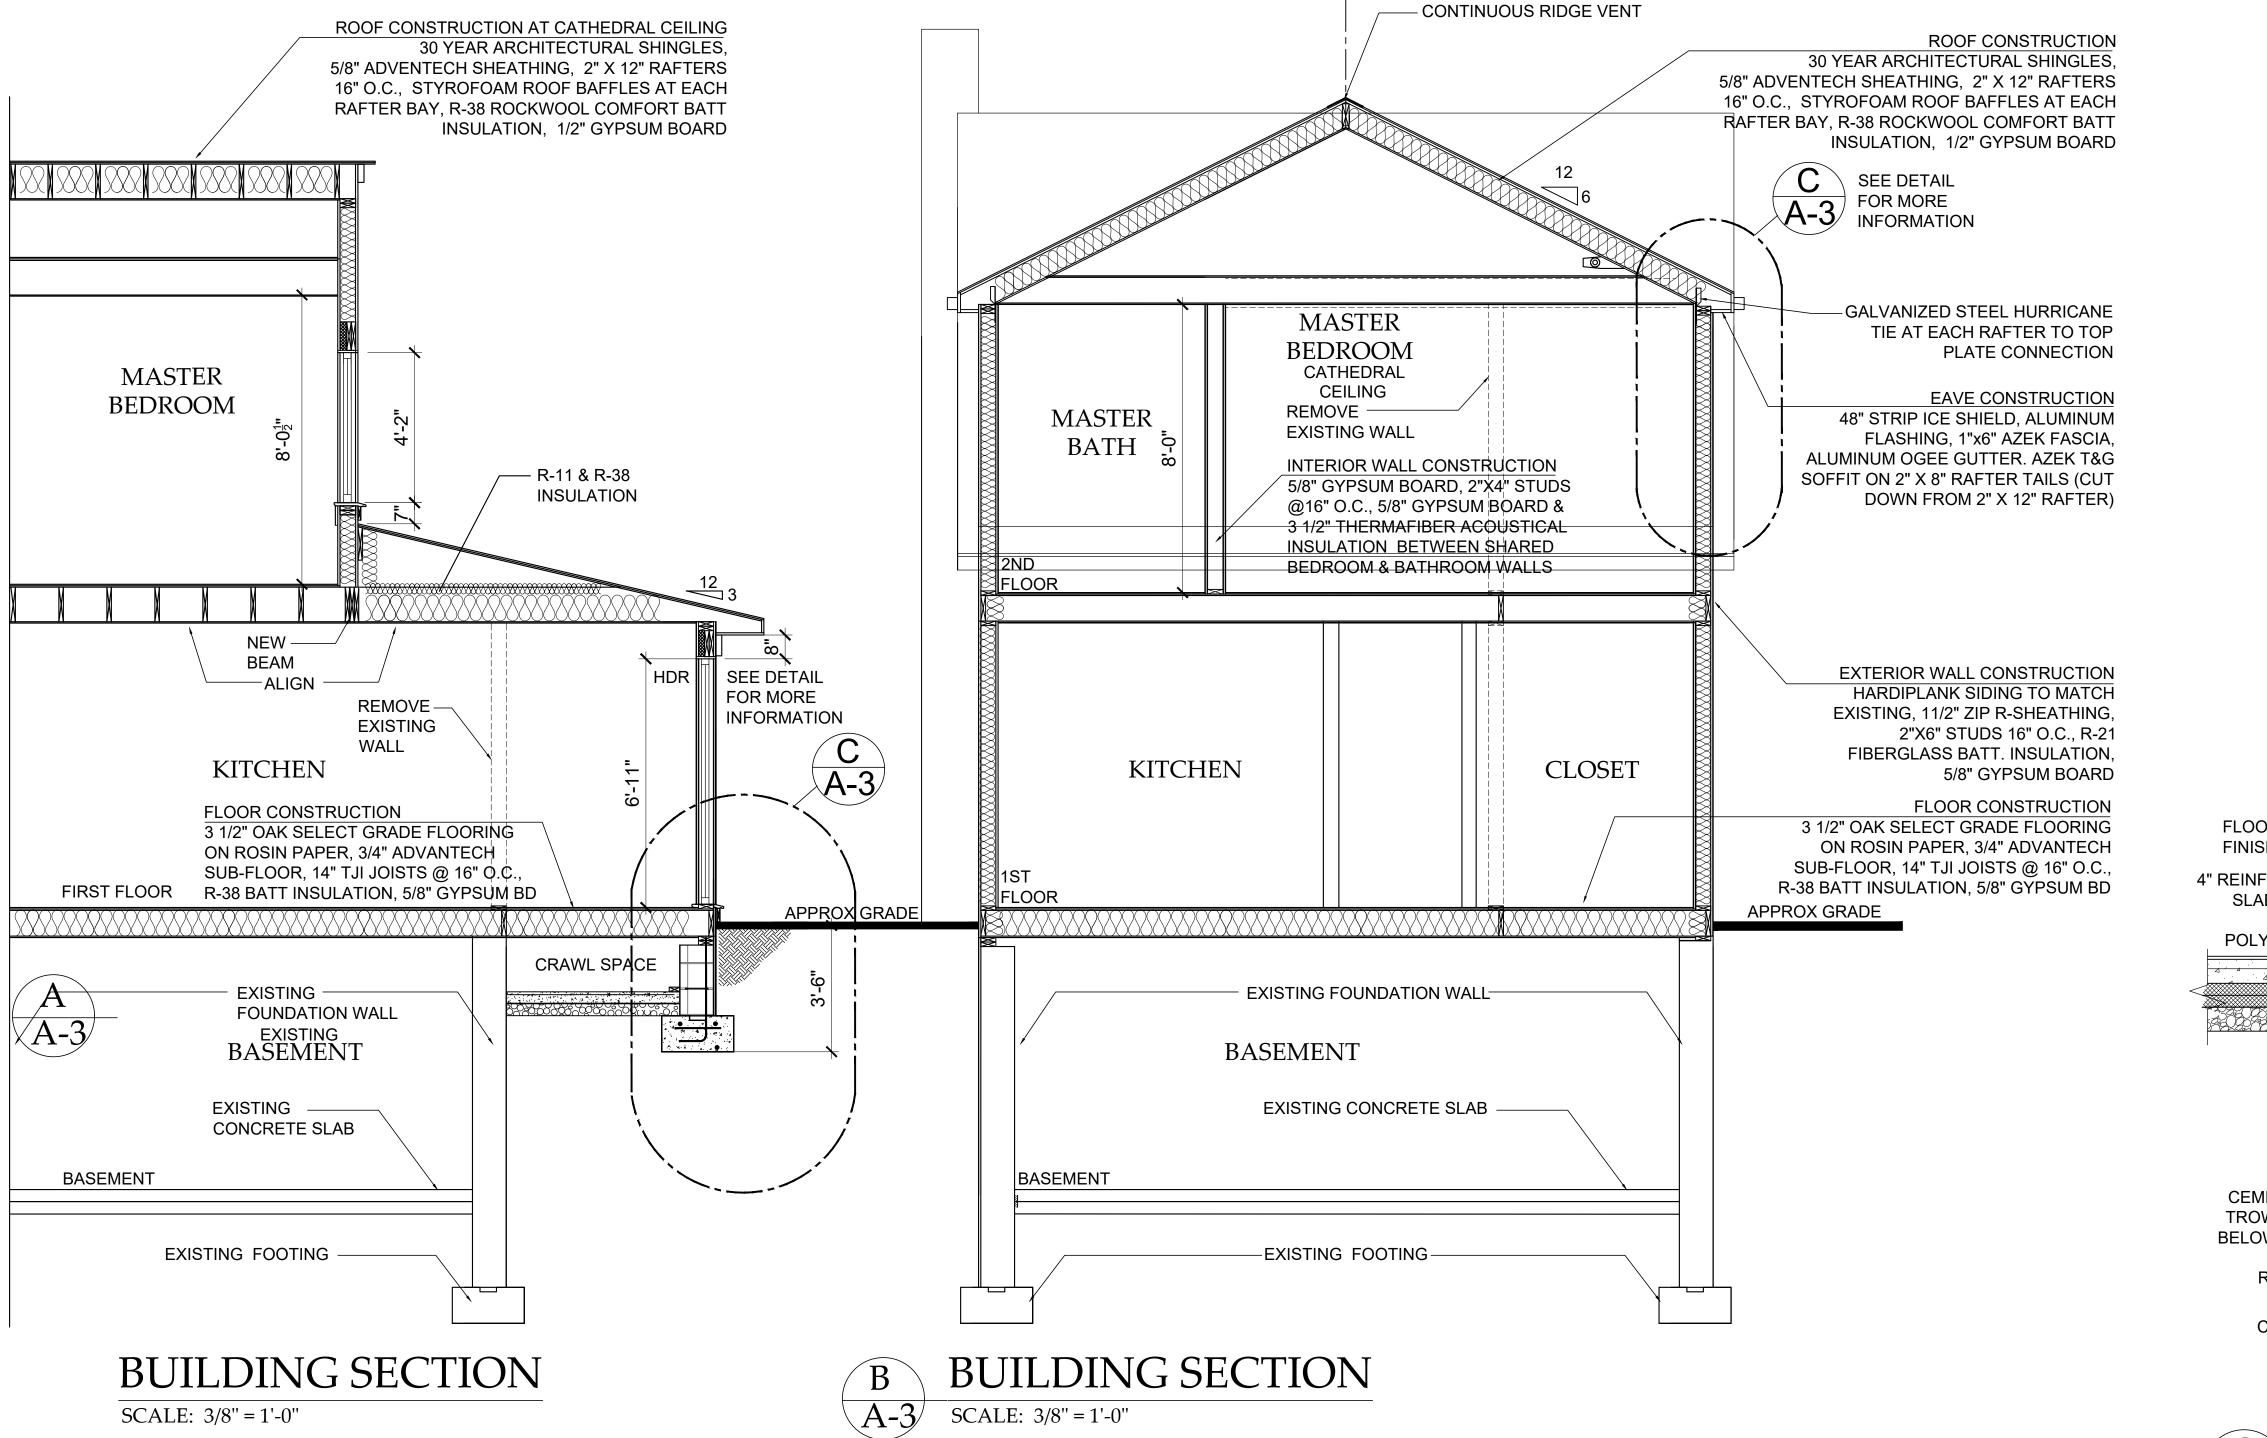

C A-3/

