NEW LOT SUBDIVISION & NEW TWO-FAMILY RESIDENCE AT

107 PALISADE STEET

D O B B S F E R R Y , N Y 1 0 5 2 2

CGA STUDIO ARCHITECTS

12 SPRING STREET, HASTINGS.ON.HUDSON, NY 10706





EXISTING CONDITIONS OF PROPOSED LOT A





EXISTING CONDITIONS OF PROPOSED LOT B

ZBA SUBMISSION 7-19-23

GENERAL NOTES

- 1. These documents remain the exclusive property of the Architect, and may not be used for any purpose
- whatsoever without written consent of the Architect. 2. All construction shall comply fully with the 2020 Residential code of NYS, NY Stretch Energy Code, local 15. General contractor shall be responsible for the removal building code, fire department regulations, and all other
- agencies having jurisdiction over project. on site for all inspections.
- 4. A current Westchester County licensed and insured contractor must be on file with current building permit until Certificate of Occupancy is issued. If contractor of record has been removed from the project, a stop work order will be issued until a new Westchester County licensed and insured contractor is retained
- 5. General Contractor shall carry property damage insurance, public liability insurance, workman's compensation, auto insurance, and general liability as required by Federal, State, and Local Codes and as
- Owner requires.
- 6. Licensed electrician to file separate electrical permit. 7. Licensed plumber to file separate plumbing permit.
- 8. All health, safety, fire, zoning and environmental regulations shall be adhered to at all times by the Owner and/or occupant.
- 9. The contractor shall become familiar with conditions of the site, and the work as shown on the construction documents, prior to submitting a bid for construction.
- 10. Contractors shall coordinate all work procedures and working hours with local authorities, neighborhood associations, and any other governing authorities.
- 11. The contractor shall be responsible for providing all labor and materials to complete the project, in accordance with the construction documents, tested and ready for Owner's use.
- 12. All indicated Survey material is for general reference only. The Architect assumes no responsibility for the accuracy or the correctness of the indicated material.
- 13. Contractors shall be responsible for protection of all existing and new conditions and materials with and adjacent to the construction area. Any damage caused by 23. The drawings and notes are intended to be complete. the execution of the work indicated or implied herein shall

be repaired or replaced to the Owner's satisfaction.

14. All construction sites shall conform to the 2020 New York State Property Maintenance Code. All rubbish garbage and construction debris shall be disposed of in an

- onsite dumpster or removed off site immediately. Materials shall be stacked in orderly fashion as to not create a blight on the community. The village right of way 24.Minor details not usually shown or specified, but must be kept clear and maintained at all times.
- of construction debris, rubbish and offsite disposal in a
- 3. Approved stamped set of building plans must be present 16. The contractor shall obtain all inspections, approvals and his best skill and attention, he shall be solely responsible local building department and all other agencies having jurisdiction over the project, such as plumbing, electrical & HVAC, except for the building permit, which shall be obtained by the Architect. The contractor shall obtain the
 - certificate of occupancy for the project when construction 17. Contractor shall keep work site free from debris and accumulated refuse, and shall have sole responsibility for protecting all dangerous areas from entry by

unauthorized parties.

- 18. Drawings may be rough scaled for estimating & general purposes, but are not to be scaled for construction locations, dimensions, or any other purposes. Dimensions shown shall govern over measurements scaled from plans. Wall dimensions are given to finished surfaces. Contractor to consult with the Architect for questions
- 19. All dimensions and conditions shown and assumed on the drawings must be verified at the site by contractor before ordering any material or doing any work.

regarding final dimensions and locations.

- 20.Contractor is to design and install adequate and code approved shoring and bracing where needed to safely complete structural work. Contractor to assume full and sole responsibility for structural adequacy of the shoring 31.lf blown or sprayed insulation used, Installer of insulation and for any injuries, damages, cracks, or defects caused by shoring or bracing, and shall repair all such damage at his sole expense.
- 21. The Architect is not responsible for workmanship, construction methods, or any omissions or derivations from the drawings during construction.
- 22.Materials and products indicated on drawings shall be installed in accordance with manufacturer's requirements
- Should anything be omitted from the drawings necessary to the proper construction of the work herein described, it shall be the duty of the contractor to notify the Architect. The builder shall visit the site and inform the Architect of any discrepancies of field conditions that may interfere with the total completion of all work included within the

- materials and the start of construction.
- necessary for proper and acceptable construction, installation or operation of any part of the work shall be included in the work the same as specified or indicated.
- 25. The contractor shall supervise and direct the work using permits, and pay all necessary permit fees required by the for all construction means, methods, sequences and procedures and for coordination of all portions of the work.
 - with any item specified is intended to mean that such item the contractor at his own expense. 27. Contractor shall maintain a sealed enclosure between
 - work area and other areas of the residence. In addition. the contractor shall be responsible to (a) protect all interior to accomplish this, but changes of magnitude shall not be all areas at end of each work day.
 - 28. The contractor shall do all the cutting, fitting & patching that may be required to make several parts of the work or be received by the work of others, as shown, or as reasonably implied on the drawings.
 - 29. New & existing work shall come together in a seamless fashion.All new or modified surfaces shall be finished including, but not limited to taping, spackling & priming.
 - 30. All insulation to comply with the Energy Efficiency Certificate required by 401.3 2020 Energy Conservation Construction Code of New York, prepared by Architect and to comply with NY Stretch Energy Code and

Hastings-on-Hudson Green Building Code.

to submit insulation certification to include the installed 36.Finish materials and paint colors shall be reviewed and thickness of the area covered and R-value of the installed approved by the homeowner thickness shall be listed on the certificate. The insulation 37. The Architect assumes no responsibility for the accuracy installer shall sign, data and post the certificate in a conspicuous location on the job site per N1101.5 of the 2020 Residential Code of New York State and submit an

original signed copy for the Building Departments records.

32. All work shall be guaranteed for one year after final payment. The general contractor is to furnish written guarantees on his work and all subcontractors work against defects resulting from the use of inferior materials, equipment, or workmanship as determined solely by the Architect. All such defects are to be replaced or repaired, complete with labor and materials,

- contract and verify all conditions prior to the ordering of 33. Substitutions of equipment or materials other than those shown on the drawings or in the specifications shall be made only upon approval of the Architect or owner as noted on the drawings or in these specifications. The contractor shall submit his substitution for approval before *At rooms with ceilings, R-38 insulation extends over releasing any order for fabrication and / or shipments. The
 - Architect reserves the right to disapprove such substitution, provided in his sole opinion, the item offered is not equal or detailed on the drawings, which requires any redesign of the structure, partitions, piping, redesign, and all new drawings and detailing required therefore
- 26. The use of the words "provide" or "provided" in connection shall, with the approval of the Architect, be prepared by be furnished and installed and connected where required. 34.All work shall be installed so all parts required are readily accessible for inspection, operation, maintenance and repair. Minor deviations from the drawings may be made
- spaces from the area of renovation, and (b) broom sweep made without prior written approval from the Architect. 35. Upon completion of the work, the entire project is to be completely cleaned and the site restored to existing
- condition, including but not limited to the following. come together properly, and to fit his work, and/or receive, a) Complete sweeping of all areas, and removal of all rubbish and debris, except that caused by the owner or others doing N.I.C. work.
 - b) Removal of all labels from glass, fixtures, and equipment, etc. and spray cleaning of glass and mirrors. c) Removal of stains, and paint from glass, hardware, finished flooring, cabinets, etc.
 - d) Final cleaning of all chrome and aluminum metal work. e) Restoration of property by returning shrubs to original locations, filling of all ruts and raked topsoil and repairs to damaged blacktop.

 - or correctness of any material or drawings prepared by others and provided to the Architect.

Energy Notes R-Values & U-Factors 2020 ECC AMENDED BY NY STRETCH ENERGY CODE Climate Zone 4A Proposed Required

R-21/20+5/13+10 R-21 min.

R-49

R-49*

0.27 U value 0.27 U value

wall plate at eaves to comply with R402.2.1, at cathedral

at roof rafters to comply with R402.2.2 Amended by

Where Section R402.1.2 requires R-49 insulation in

the ceiling, installing R-38 over 100% of the ceiling

requirement for R-49 insulation wherever the full

height of uncompressed R-38 insulation extends

Where Section R402.1.2 requires insulation greater

assembly does not allow sufficient space, the min.

outer edge of the top plate shall not be compressed

Christina Griffin, Architect A.I.A., hereby states that

I have prepared these plans and specifications to

the best of my knowledge in compliance with all the

requirements of the 2020 Residential code of NYS.

This reduction of insulation shall be limited to 500

square feet, or 20% of the total insulated ceiling

R-value shall be R-38. Insulation over and to the

R-10, 4 ft depth R-10, 4 ft depth

R-30

ceilings, R-38 insulation will be installed

R402.2.1 CEILINGS WITH ATTIC SPACES

area requiring insulation shall satisfy the

R402.2.2 CEILINGS WITHOUT ATTIC SPACES

than R-38 in the ceiling, and the roof / ceiling

AMENDED BY STRETCH CODE R402.2.2

over the wall top plate at eaves.

Design Criteria:

5750 Degree Days

15% Maximum Glazing

area, whichever is less.

INSULATION & FENESTRATION

CLIMATE ZONE	FENESTRATION U-FACTOR ^h	SKYLIGHT ^h U-FACTOR	GLAZED FENESTRATION SHGC ^h	CEILING R-VALUE	WOOD FRAME WALL ^{b,c} R-VALUE
4A	0.27	0.50	0.40	49 see R402.2.1/402.2.2	21 ^{int.} or 20+5 ^{cont.} or 13+10 ^{cont.}
	MASS WALL ^d R-VALUE	FLOOR R-VALUE	BASEMENT WALL ^e R-VALUE	SLAB ^f R-VALUE & DEPTH	CRAWL SPACE WALL ^e R-VALUE
	15/20	30 ^g	15/19	10, 4FT (d)	15/19

- a. R-VALUES ARE MINIMUMS. U-FACTORS AND SHGC ARE MAXIMUMS. WHERE INSULATION IS INSTALLED IN A CAVITY THAT IS LESS THAN THE LABEL OR DESIGN THICKNESS OF THE INSULATION, THE INSTALLED R-VALUE OF THE INSULATION SHALL BE NOT LESS THAN THE R-VALUE SPECIFIED IN THE TABLE.
- b. INT. (INTERMEDIATE FRAMINGS) DENOTES STANDARD FRAMING 16 INCHES ON CENTER. HEADERS SHALL BE INSULATED WITH A MINIMUM OF R-10 INSULATION. c. THE FIRST VALUE IS CAVITY INSULATION, THE SECOND VALUE IS CONTINUOUS INSULATION. THEREFORE, AS AN EXAMPLE, "13+10" MEANS R-13 CAVITY INSULATION PLUS R-10 CONTINUOUS INSULATION.
- d. MASS WALLS SHALL BE IN ACCORDANCE WITH SECTION R402.2.5. THE SECOND R-VALUE APPLIES WHEN MORE THAN HALF THE INSULATION IS ON THE INTERIOR OF THE MASS WALL. e. 15/19 MEANS R-15 CONTINUOUS INSULATION ON THE INTERIOR OR EXTERIOR OF THE HOME OR R-19 CAVITY
- INSULATION AT THE INTERIOR OF THE BASEMENT WALL. f. R-10 CONTINUOUS INSULATION SHALL BE PROVIDED UNDER THE FULL SLAB AREA OF A HEATED SLAB IN ADDITION TO THE REQUIRED SLAB EDGE INSULATION R-VALUE FOR SLABS AS INDICATED IN THE TABLE. THE SLAB EDGE INSULATION FOR HEATED SLABS SHALL NOT BE REQUIRED TO EXTEND BELOW THE SLAB. g. ALTERNATIVELY, INSULATION SUFFICIENT TO FILL THE FRAMING CAVITY AND PROVIDING NOT LESS THAN AN
- R-VALUE OF R-19. h. THE FENESTRATION U-FACTOR COLUMN EXCLUDES SKYLIGHTS. THE SHGC COLUMN APPLIES TO ALL GLAZED

DESIGN REQUIREMENTS

		WIND DES	SIGN			SUBJECT	TO DAMA	GE FROM				
GROUND SNOW LOAD	SPEED (MPH)	TOPO EFFECTS	SPECIAL WIND REGION	WIND BORNE DEBRIS ZONE	SEISMIC DESIGN CATEGORY	WEATHERING	FROST LINE DEPTH	TERMITE	ICE SHIELD UNDERLAY REQUIRED	FLOOD HAZARDS	AIR FREEZING INDEX	MEAN ANNUAL TEMP
30 PSF	115- 125 MPH	NO	YES	NO	В	SEVERE	42"	MODERATE TO HEAVY	YES	N/A	2000	51.6

DATES

BUILDING PERMIT SUBMISSION ZBA SUBMISSION

6-30-23 7-19-23

LIST of DRAWINGS

- GENERAL NOTES, LIST OF DRAWINGS, CLIMATIC DATA, PHOTOS OF EXISTING CONDITIONS SITE PLAN, ZONING COMPLIANCE, AREA MAP
- NEIGHBORHOOD CONTEXT
- FIRST FLOOR & BASEMENT PLANS
- SECOND, THIRD & ROOF PLANS SITE SURVEY



- NEW PLANTINGS FOR PRIVACY SCREENING PROPERTY LINE N 52°55'10" E EXIST. PAVER PATIO 236 SF PARKING SETBACK 2 NEW OUTDOOR EXISTING PARKING SPOTS -54'-7" IE 54.6'-1-STORY EXIST. PAVER EXIST. TREES TO GARAGE PARKING SPOTS BE REMOVED. PLANTING PLAN TO BE PROVIDED REQUIRED BUILDING (3) IDENTIFYING REPLACEMENT SETBACK **PLANTINGS** IE 12.4' FOOTPRINT OF BUILDING AT 3RD FLOOR DRIVEWAY/ - FOOTPRINT OF BUILDING EXIST. AT 2ND FLOOR 1-STORY TERRACE - STAIR UP TO COVERED P E 37°(DECK AT 2ND FLOOR OZ - FOOTPRINT OF BUILDING AT GROUND FLOOR/ PROPOSED **GARAGE LEVEL** LOT A 58'-8" IE 58.7' **EXISTING** 2-STORY EXIST. TREE TO BE REMOVED. RESIDENCE PLANTING PLAN (3 x 1BR UNITS) TO BE PROVIDED **IDENTIFYING** #107 PROPOSED REPLACEMENT **PLANTINGS** LOT B -58'-6" IE 58.5'-- NEW EGRESS LIGHTWELL EXIST. 1-STORY FROM BASEMENT MECHANICAL SPACE EXIST. TERRACE **FOOTPRINT OF** PROPOSED **BUILDING AT** 1E 12.4' 3-STORY 2ND FLOOR TWO-FAMILY EXIST. STEPS NEW ROOF OVER EXIST. WALK 10'-0" RESIDENCE **ENTRY PROJECTING** EXIST. PAVER DRIVEWAY 1,497 SF INTO FRONT W/ 2-CAR GARAGE SETBACK PER 300-34.B (4) b. & c. FIRST FL EL: 102 REQUIRED BUILDING 11'-5" -24'-6"--NEW WALK

SITE PLAN SHOWING PROPOSED LOT SUBDIVISION SCALE: 1/8" = 1'-0"

PALISADE STREET

106.05'

56'-1" PROPOSED LOT A WIDTH

N 53°00'45" E

EXIST. WALK

EXIST. DROP

CURB



EXIST. WALL

50'-0" PROPOSED LOT B WIDTH

PROPERTY LINE

EXIST. WALK

NEW CURB CUT

ZONING CALCULATIONS

107 F	PALISADE STREET, DOBBS	FERRY NY 10522					
ZONING DISTRICT:MDR-2; TAX DESIGNATION: SECTION 3.80; BLOCK: 36, LOT: 17							
	REQUIRED	EXISTING	PROPOSED LOT A (SOUTH)	PROPOSED LOT B (NORTH)			
GROSS LOT AREA/NET LOT AREA (NO STEEP SLOPES)	5,000 SF	12,735 SF	6,745 SF	5,945 SF			
NUMBER OF DWELLING UNITS	N/A	3	3 x 1-BR UNITS	2 UNITS (2-BR & 3-BR)			
MINIMUM LOT AREA PER DWELLING UNIT	800 SF	4,245 SF	2,288.3 SF	2,935 SF			
PARKING REQUIREMENT	2 SPACES/DWELLING UNIT 6 SPACES FOR LOT A 4 SPACES FOR LOT B	6 4 OUTDOOR & 2 IN EXIST. GARAGE	6 4 OUTDOOR & 2 IN EXIST. GARAGE	4 2 OUTDOOR & 2 IN NEW GARAGE			
OUTDOOR PARKING SETBACK TO PROPERTY LINE	10 FT MIN.	12.25 FT REAR 54.6 FT SIDE	12.25 FT REAR 6.1 FT* NORTH SIDE * VARIANCE RQD	16.8 FT REAR 13.75 FT & 17.75 FT SIDE			
BUILDING COVERAGE FOR LOTS UNDER 7,500 SF	40% [TABLE B-2 & B-3] 2,746 SF FOR LOT A 2,348 SF FOR LOT B	14% 1,807 SF	26% 1,807 SF	36% 2,099 SF			
IMPERVIOUS COVERAGE FOR LOTS UNDER 7,500 SF	60% [TABLE B-2 & B-3] 4,119 SF FOR LOT A 3,522 SF FOR LOT B	41% 5,273 SF	77%* 5,255 SF *VARIANCE RQD	57% 3,344 SF			
MINIMUM LOT WIDTH [TABLES B-2]	50 FT [TABLE B-2]	106.05 FT	56.08 FT	50 FT			
MINIMUM LOT DEPTH [TABLE B-2 & B-3]	100 FT	120 FT	120 FT	120 FT			
FRONT YARD SETBACK [PREVAILING WITHIN 250 FT RADIUS - 10% OF 15FT PER TABLE B-2]	18 FT - (10% OF 15FT) = 16.5 FT	36.8 FT	36.8 FT	17.5 FT			
REAR YARD SETBACK [TABLE B-2 & B-5; LOT DEPTH UNDER 125 FT]	25 FT [TABLES B-2 & B-5]	39.08 FT	39.08 FT	25 FT			
SIDE SETBACK [TABLE B-4; LOT WIDTH UNDER 75 FT]	10 FT	12.4 FT	12.4 FT	10 FT			
SIDE SETBACK [TABLE B-4; LOT WIDTH UNDER 75 FT]	10 FT	58.5 FT	10 FT	10 FT			
TOTAL OF TWO SIDE SETBACKS [TABLE B-2 & B-4; LOT WIDTH UNDER 75 FT]	20 FT	70.9 FT	22.4 FT	20 FT			
MAXIMUM STORIES (5FT SETBACK RQD @ 3RD STORY)	3 STORIES MAX.	2	2	3			
MAXIMUM HEIGHT TO EAVE	N/A	EXIST.	EXIST.				
MAXIMUM BUILDING HGT TO MIDPOINT OF ROOF [TABLE B-6; 0.5 PITCH]	42 FT	EXIST.	EXIST.	40 FT			
BULKHEAD SQUARE FOOTAGE	MAX. 20% (ROOF AREA) = (20%) X 2,122 = 424 SF	N/A	N/A	420 SF			

* ZONING VARIANCE REQUIRED

SITE PLAN BASED ON SURVEY BY SUMMIT LAND SURVEYING P.C. SURVEY DATE: 11/26/2022; REVISED 6/27/2023

COVERAGE CALCULATIONS

	BEOLUBED	EVICTING	PROPOSED	PROPOSED	
	REQUIRED	EXISTING	LOT A (SOUTH)	LOT B (NORTH)	
LOT AREA	5,000 SF	12,735 SF	6,865 SF	5,870 SF	
BUILDING & PORCHES	N/A	1,322 SF	1,322 SF	2,083 SF	
REAR BALCONY (>75 SF NOT COUNTED)					
ACCESSORY BUILDING	N/A	485 SF	485 SF	-	
TOTAL BUILDING COVERAGE FOR LOTS UNDER 7,500 SF	40% [TABLE B-2 & B-3] 2,746 SF FOR LOT A 2,348 SF FOR LOT B	14% 1,807 SF	26% 1,807 SF	36% 2,099 SF	
TERRACES		323 SF	323 SF	54 SF	
WALKS & STEPS		632 SF	632 SF	82 SF	
DRIVEWAY & PAVER PATIO		2,396 SF	2,396 SF	1,067 SF	
RETAINING WALLS & WINDOW WELLS		117 SF	97 SF	42 SF	
TOTAL IMPERVIOUS COVERAGE FOR LOTS UNDER 7,500 SF	60% [TABLE B-2 & B-3] 4,119 SF FOR LOT A 3,522 SF FOR LOT B	41% 5,273 SF	77%* 5,255 SF *VARIANCE RQD	57% 3,344 SF	

PREVAILING FRONT SETBACK

KLYAILINO I KONI SLIDACK					
ADDRESS	SETBACK (FT)				
95 PALISADE ST	4				
107-A PALISADE ST	36.8				
111 PALISADE ST	39				
119 PALISADE ST	5.5				
123 PALISADE ST	4.9				
AVERAGE	18.0				
(-)10% OF 15 FT PER TABLE B-2	-1.5				
PREVAILING SETBACK	16.5				

REFER TO AREA MAP ON SHEET S-2

AVERAGE GRADE

	AVG	FAÇADE	AVG GRADE x	
	GRADE	LENGTH (FT)	FAÇADE LENGTH	
EAST (FRONT) ELEVATION	100.6	24.5	2,463	
NORTH ELEVATION	99.8	42.08	4,200	
WEST (REAR) ELEVATION	99.2	24.5	2,429	
SOUTH ELEVATION	99.9	42.08	4,204	
TOTAL		133.16	13,296	

* ZONING VARIANCE

AVERAGE GRADE 99.85 (AVG GRADE x FAÇADE LENGTH/TOTAL LENGTH) FIRST FLOOR - AVG GRADE = 102 - 99.85



12 SPRING STREET HASTINGS.on.HUDSON N.Y. 10706 914.478.0799 cg@cgastudio.com christinagriffinarchitect.com

> **ESIDENC** \mathcal{C}

Project Submitted


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55	ERED ARCH	
A CONTRACTOR	S. S	
A. L.	OF NEW	

As Shown Drawing Title ZONING DATA

AREA MAP 3.80-36-30 3.80-36-32 81129 3.80-36-32 8129 3.80-36-32 8129 3.80-36-32 8129 3.80-36-32 8129 3.80-36-32 8129 3.80-36-32 8129 3.80-36-32 8129 3.80-36-32 8129 3.80-36-32 8129 3.80-36-32 8129 3.80-36-32 8120 8

AERIAL VIEW OF NEIGHBORING PROPERTIES



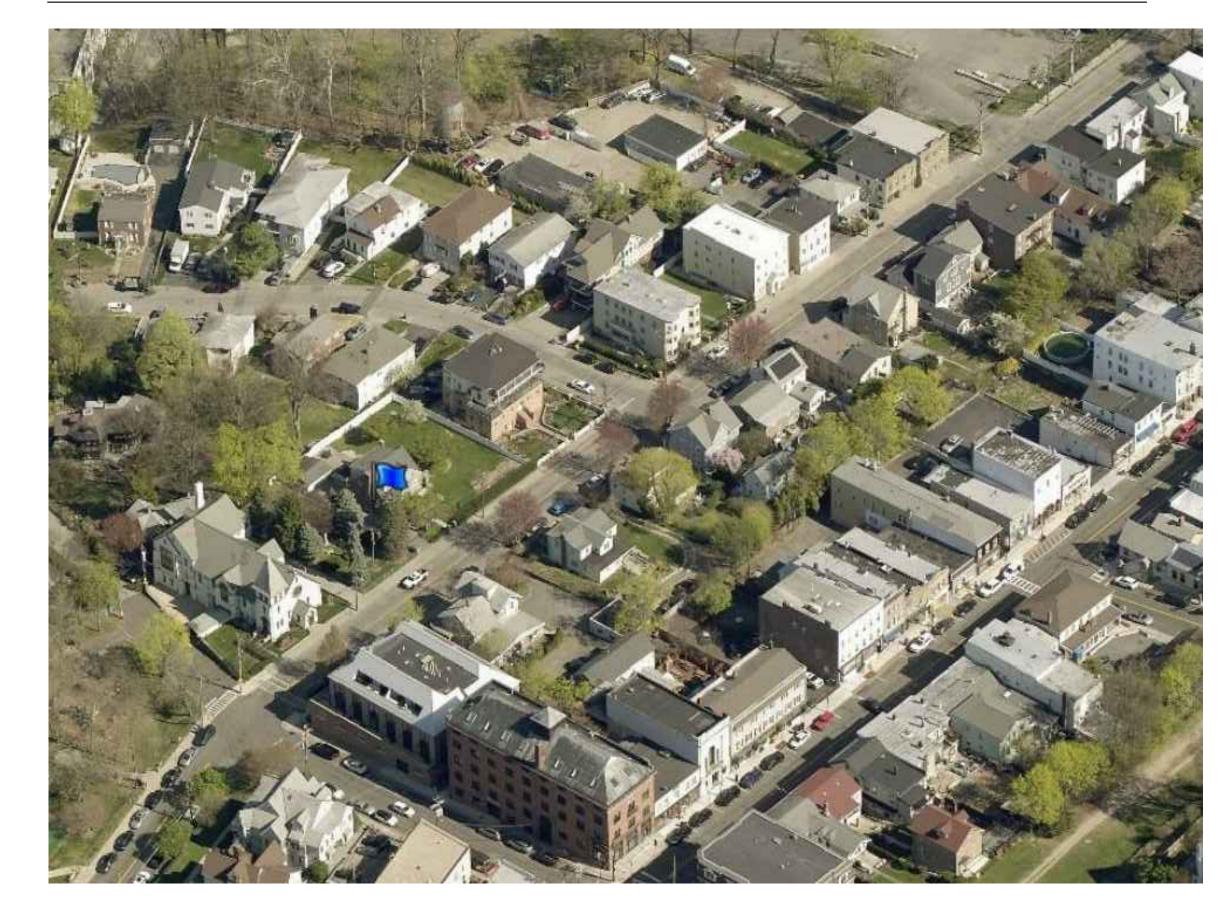

#1

WITHIN 250 FT

RADIUS



#122 WITHIN 250 FT RADIUS

NEIGHBORING PROPERTIES

ALONG THE EAST SIDE OF PALISADE STREET



#60 CHESTNUT ST



WITHIN 250 FT RADIUS



#104 WITHIN 250 FT RADIUS

#107B



110 WITHIN 250 FT RADIUS




14 WITHIN 250 FT RADIUS



#116 WITHIN 250 FT RADIUS

ALONG THE WEST SIDE OF PALISADE STREET

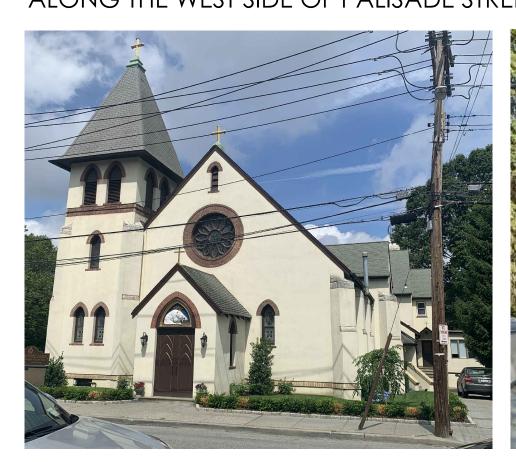

WITHIN 250 FT RADIUS



#107A WITHIN 250 FT RADIUS



#111 WITHIN 250 FT RADIUS



#119



WITHIN 250 FT RADIUS



#123 WITHIN 250 FT RADIUS



ARCHITECTS

12 SPRING STREET

HASTINGS.on.HUDSON
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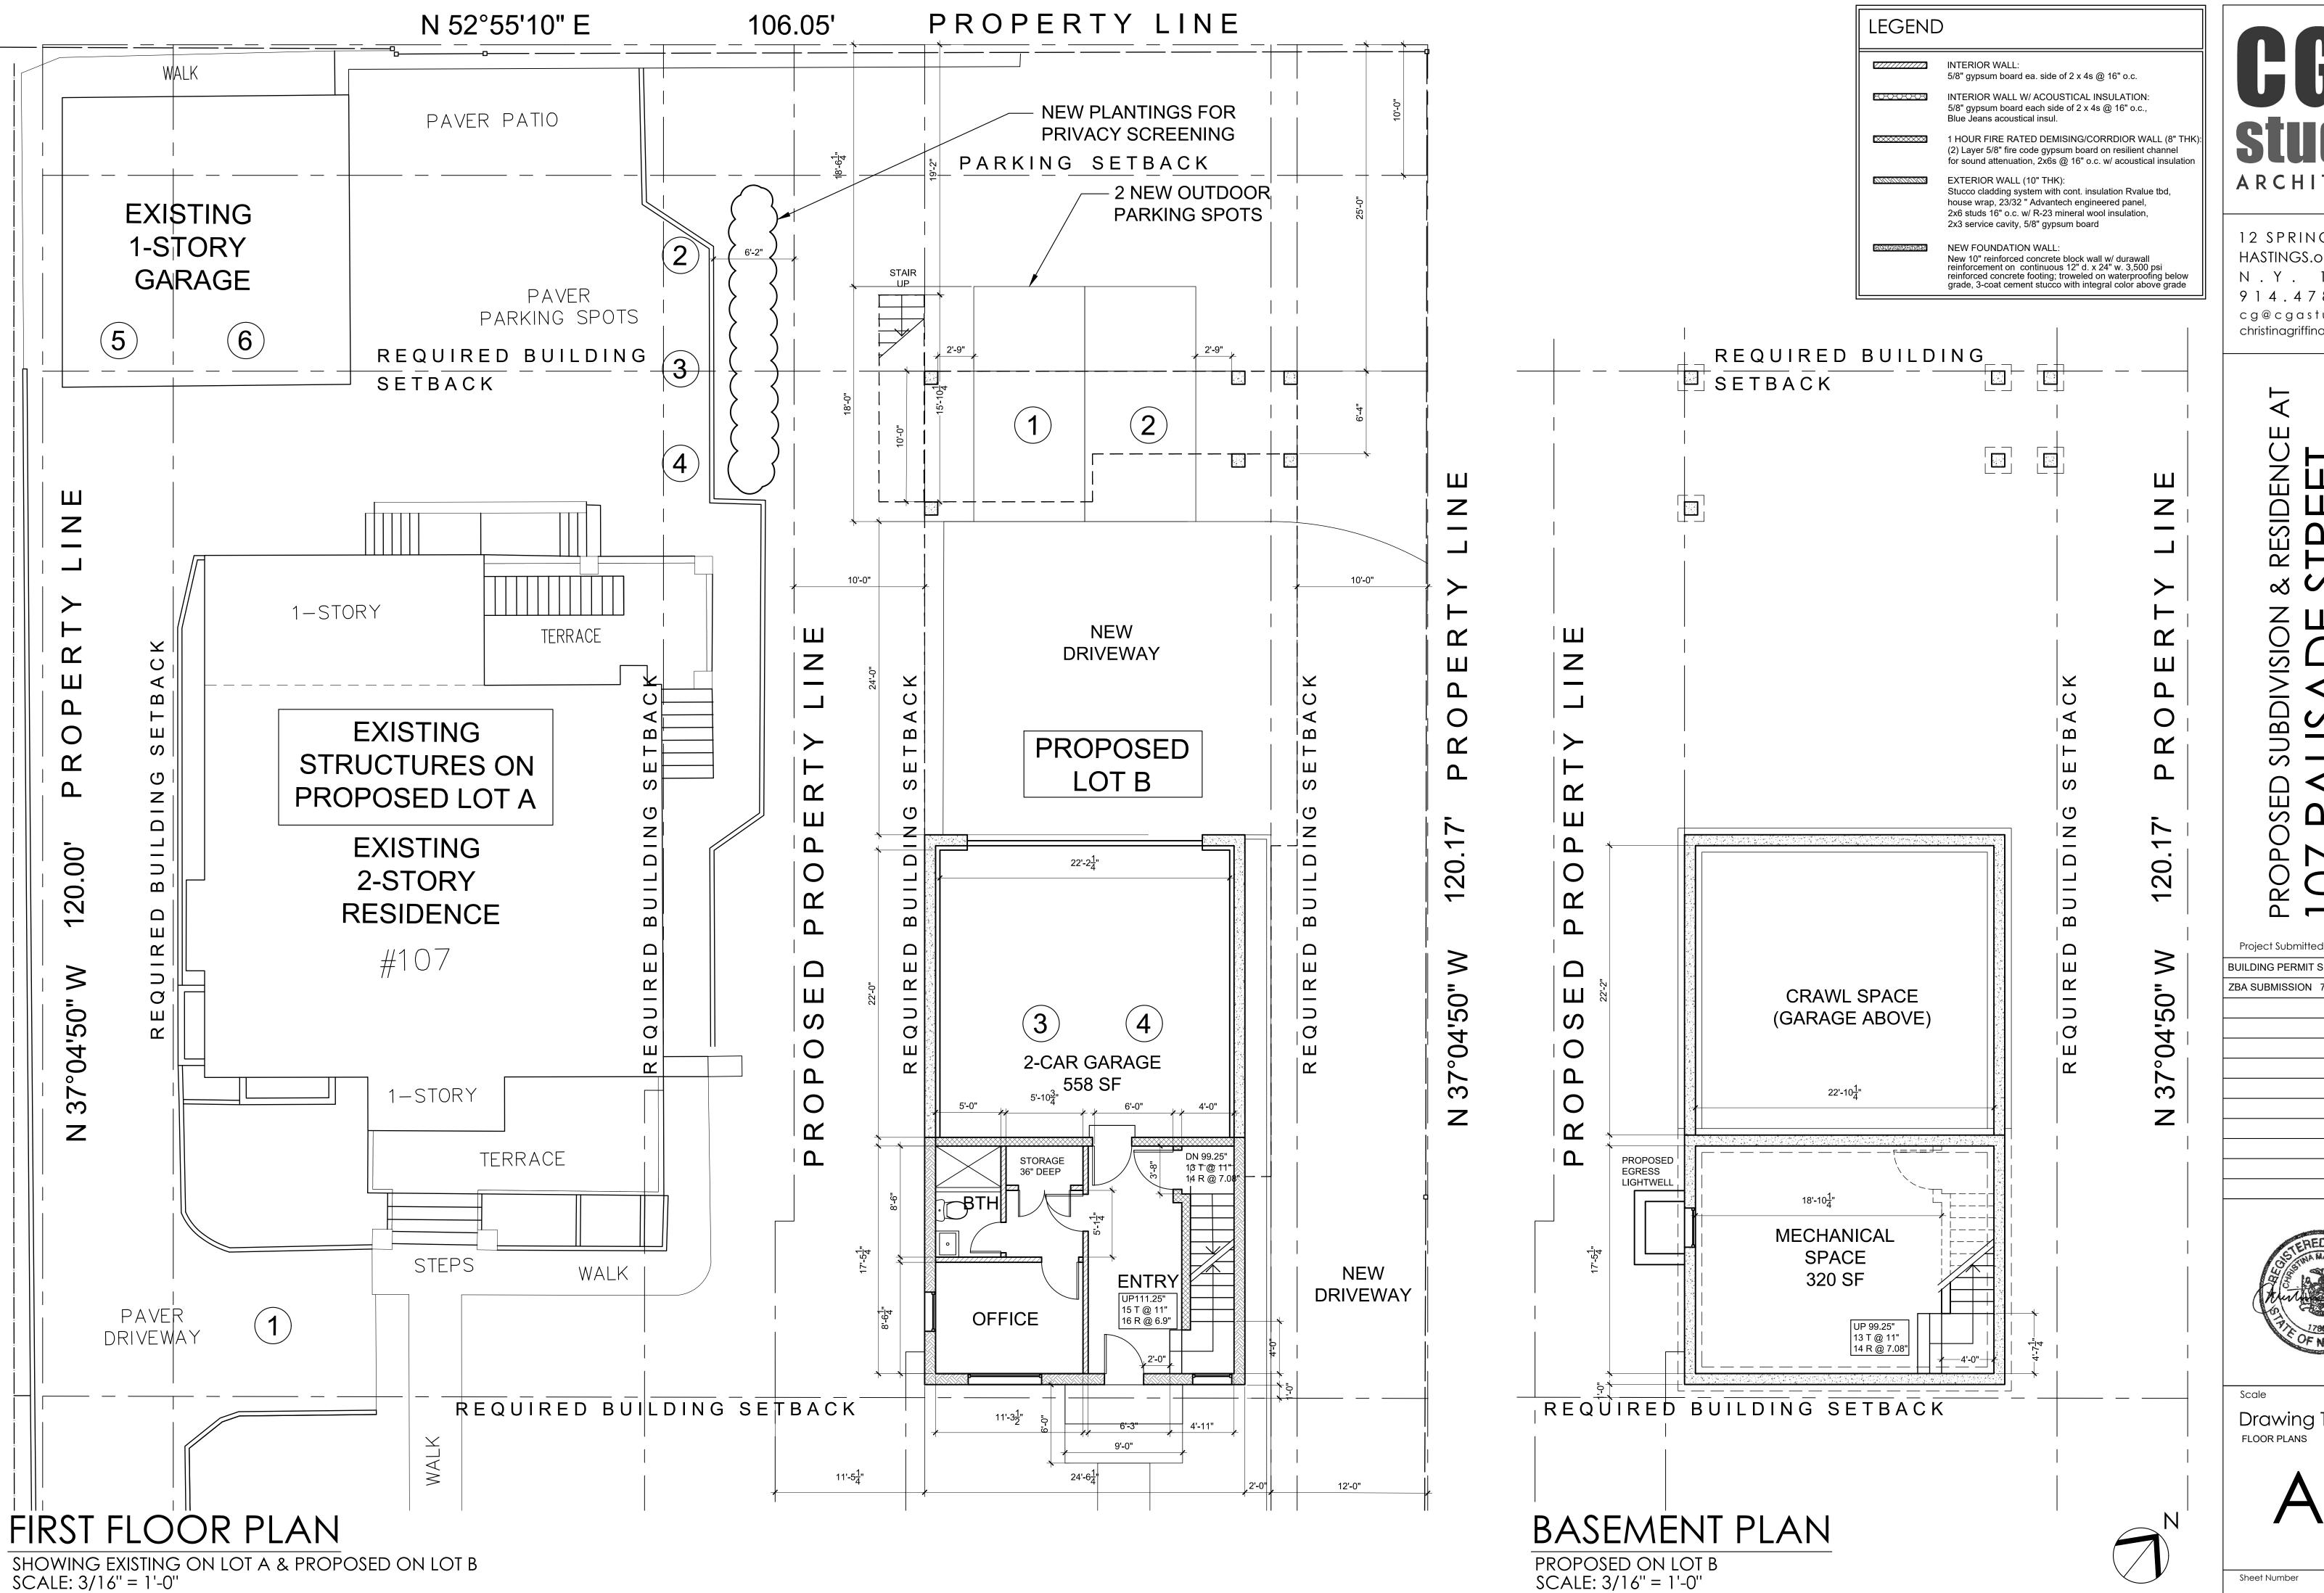
RESIDENCE

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Drawing Title
NEIGHBORHOOD CONTEXT

5-2

Sheet Number



ARCHITECTS

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As Shown Drawing Title

