

The Hoffman Residence

242 Clinton Avenue, Dobbs Ferry, New York 10522

1 NOTES

1. Approved subject to all requirements and conditions of a July 1, 2021, resolution of the Planning Board of the Village of Dobbs Ferry, New York. Any change, erasure, modification, or revision of this plan, absent re-approval from the Planning Board, shall void this approval.
2. All construction work shall be performed in compliance with the administrative Building Code of the village of Dobbs Ferry, NY, and all other applicable ordinances and regulation of all Governing Agencies having jurisdiction over the work.
3. All Construction, including Plumbing, Mechanical and Electrical work, to be performed by Licensed Contractors and all required permits and certification shall be obtained prior to commencement of work.
4. The services of Gregory Sharp Architect (GSA) are being performed solely for the clients benefit and no Contractor, Subcontractor, Supplier, Fabricator, Manufacturer, Tenant, Vendor, Consultant or other third party shall have any claim against GSA as a result of the architectural agreement with the client or the performance or non-performance of GSA's services. It is understood that this provision will be brought to the attention of the parties with whom the client contracts and have them do the same with those who they contract.
5. The Construction and vendor contracts shall include provision describing GSA's role as stated in this agreement with respect to construction and installation of the furnishing and require the Contractor(s) (and any Vendors(s) working on the job site) to indemnify the client and GSA as set forth in the indemnification clause below, which shall appear in the Construction and Vendor Contracts. This obligation shall be insured by the contactor(s) and its subcontractors and any vendor working on the job site.
6. The contractor(s) shall defend, indemnify and hold harmless GSA and their respective directors, officers, partners, employees, and agents, from any and all claims directly or indirectly arising or alleged to arise out of the adjoining land or driveways, or streets or alleys used in connection with the performance of the work, and from any and all claims by Workmen, Suppliers or Subcontractors who are involved in the performance of the work.
7. The obligators set forth in this provision shall specifically include, but not be limited to, all claims directly or indirectly arising or alleged to arise under any scaffolding, structural work with respect to the protection of adjacent landowners.
8. The Contractor(s) shall be notified of any claims against GSA and given such reasonable information, authority and assistance as may be requested by him to enable him to perform the obligations set forth in this section. Failure to notify the Contractor(s) of a claim or to give such information, authority and assistance shall not discharge the obligations set forth in this section unless the Contractor(s) has been prejudiced in the defense of such a claim.
9. The Contractor(s) also expressly warrants and guarantees to GSA that all work performed by the Contractor(s), its Workmen, Suppliers and Subcontractors, shall conform to the requirements of the the contract documents and shall be performed in a safe and careful manner. The foregoing shall not deprive GSA of any other action, right or remedy otherwise available to them, at common law or otherwise. The term "Work" for purposes of this section means the obligations undertaken by the Contractor(s) pursuant to the contract documents. Work includes, unless specifically excepted, Furnishing all Material, Labor, Equipment, Supplies, Plant, Tools, Scaffolding, Transportation, Superintendence, Insurance, Taxes and all other Services, Facilities, and Expenses necessary for the full performance and Completion of the Requirements of the Contract Documents. Work also includes that which produced, constructed or built pursuant to the Contract Documents.
10. The Construction Contracts shall include a provision requiring the Contractor(s) or Vendor(s) to warrant to the Client and GSA that all Materials and Equipment Furnished will be new unless otherwise specified, and that all work will be of good quality, free from faults and defects and in conformance with the Construction Documents.

General Construction Notes: Building Department

- 1.0 The Building is a Single Family Residence
- 2.0 The New International Type Building Code went into effect in New York State on 2015. Building Code Chapter 92 - Final Version June, 2009
- 3.0 Special Inspection Items:
 - *Sediment and Erosion Control
 - *Footing
 - *Preparation for Concrete Slabs and Walls
 - *Framing
 - *Building Systems, including underground rough in.
 - *Fire resistant Construction and Penetrations
 - *Insulation
 - *Solid Fuel
 - *Foundation and Footing drain
 - *Energy Code Compliance
 - *Final Inspection for Cof O
 - *Additional State and Local Law Inspections as required.

- 4.1 Scope of work: Proposed Distribution in the existing house, Proposed facades and Proposed livingroom. The project can be summarized as a Basement plus 1 floor with attached Garage.
 - 4.2 All Proposed work will be set on undisturbed soil.
 - 4.3 All doors marked F.P.S.C. shall be at least 1 hour fire rated.
 - 4.4 All masonry partitions shall be braced.
- All finishes over .036 of an inch in thickness shall comply with flame spread rating or be approved by the Board of Standards and Appeals.
- All sprinkler if required, Halon, fuel oil, etc. shall be filed under separate application.

General Safety Notes

- 1.2 Construction operations shall be confined to normal working hours:
7 am - 7 pm MONDAY-SATURDAY, except legal holidays.
 - 2.1 All work shall be done in accordance with the New York State Building Code and regulations of all other state, local or federal agencies having jurisdiction.
 - 2.2 The Contractor shall provide adequate bracing and shoring to ensure the structural stability of the premises.
 - 2.3 The Contractor must conduct their activities so as not to endanger any individual.
- Contractors shall comply with all applicable OSHA codes.
- 2.4 All Contractors shall be equipped with safety equipment including gloves, eye protection or other specialized equipment required for the work being performed.
 - 2.5 The Contractor shall maintain work areas and access ways thereto safe against intrusion of unauthorized persons. The Contractor shall be responsible for keeping unauthorized persons out of the work area and for protecting the safety and security of the Owners and general public.
 - 2.6 The Contractor shall be required to protect from falling debris all persons and property in areas beneath and adjoining the work area.
 - 2.7 Work which necessitates the use of chemicals or equipment that produces noxious fumes or excessive noise, will be allowed during normal business hours. Should such work be required, arrangements shall be made with the the Owner. The Owner reserves the right to stop any work, which causes excessive disturbances.

- 2.8 Separate access to the affected areas shall be provided by the Contractor and shall be made safe and non-accessible during non-working hours. Construction-related traffic shall be permitted as designated by the Owner.
 - 3.0 Storage
 - 3.1 No flammable, toxic or hazardous materials or supplies shall be allowed in the Building unless specifically approved by the Owner. Storage of such materials is to be in a manner and location designated by the Property Owner.
 - 3.2 Material Safety Data Statements covering safety information, contents and antidotes will be filed with the Property Owner for all materials used in the Building.
 - 3.3 Contractor materials are not to be stored in any public or occupied areas. Owner is not responsible for the theft or damage of construction equipment or materials stored in the building.
 - 3.4 All building materials stored at the construction area and/or in any area of the building are to be secured in a locked area. Access to such areas to be controlled by Owner and/or Contractor.
 - 4.0 Deliveries
 - 5.0 Sprinklers and Fire Alarms
 - 5.1 No work is to be done which affects any aspect of the Buildings sprinkler or fire alarm system without prior approval of the Property Owner. Alarm panels must be returned to full operation by the end of the day.
 - 5.2 There must be one (1) fire extinguisher for every seventy-five feet (75'-0") on the job at all times. ABC type all-purpose extinguishers shall be used.
 - 5.3 All required permits, a Fire Watch (by persons caring of Qualification and Fitness) and protective blankets are required for all burning and welding.
 - 6.0 Trash Removal
 - 6.1 Construction debris and all trash shall be removed from the work area daily and placed in a legal container arranged for by the Contractor. Contractor is responsible for general area of where debris is disposed of (ie where trash drops or is blown from the container).
 - 7.0 Damage
 - 7.2 The Contractor shall assume responsibility to protect all materials from loss or damage at no cost to the Owner, until they are finally incorporated into the work and accepted, whether or not the Owner has paid them for.
- Disconnecting Equipment, Utilities

Required Notes from Town:

- All work must conform to the satisfaction of the building inspector.
- The Building Inspector or Village Engineer may require additional erosion control measures if deemed appropriate to mitigate unforeseen siltation and erosion of disturbed soils.
 - "As-Built" drawings of the site improvements shall be submitted to the Village Engineer for the review prior to obtaining Certificate of Occupancy.
 - Infiltration system access ports shall be shown on the "As-Built".
 - The infiltration system must not be connected until construction is complete and the site is stabilized. A note, stating as much, should be added to the plans.
 - Cut/Fill material shall not be imported to or exported from the site.
 - Fill material imported to the site shall be certified in writing by a New York Licensed Professional Engineer as clean, non contaminated fill suitable for the intended use.
 - Before the plan site is signed by the chairman of the planning board, the applicant shall be required to post a performance bond or other type of acceptable monetary guarantee wich shall be in the amount determenated by the Planning Borad and the Village Engineer and in a form satisfactory to the Village Attorney.

ZONING TABLE				
PROPERTY LOCATION: 242 CLINTON AVENUE, DOBBS FERRY N.Y. BLOCK:115 LOT:2 TAX ID: 3.120-115-2				
OWNER: THE HOFFMAN RESIDENCE				
ZONING DISTRICT		OF-3 ONE FAMILY RESIDENCE		
REQUIREMENT	UNITS	REQUIRED / ALLOWED	EXISTING	PROPOSED
LOT SIZE	S.F.	15,000	20,038 SF.	20,038 SF.
MINIMUM LOT WIDTH	FT.	100	75	75
MINIMUM LOT DEPTH	FT.	100	252.56	252.56
MAXIMUM BUILDING COVERAGE	%	20	16	18.5
MAX. IMPERVIOUS COVEGARE	%	40	23.81	29.55
MINIMUM YARDS				
FRONT YARD SETBACK	FT.	30	48.67	44.5
SIDE YARD SETBACK (EACH)	FT.	15	16.4	16.4
SIDE YARD SETBACK (BOTH)	FT.	40	39.4	35
REAR YARD SETBACK	FT.	40	126.5	126.5
STORIES	#	2 ½	2	3
MAXIMUM HEIGHT	FT.	35	24'-6"	33'-7"
OFF STREET PARKING	#	2	2	2

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A-004	Proposed Elevations

CLIMATIC AND GEOGRAPHIC DESIGN CRITERIA (Effective 10/03/2016)												
Location: Village of Dobbs Ferry Zip Code: 10522												
Ground Snow Load	Wind Design			Seismic Design Category (RCHY Only)	Subject to Damage From			Climate Zone	Ice Barrier Underlayment Req'd	Flood Hazards	Air Freezing Index	Mean Annual Temp
	Speed (mph)	Topo Effects	Special Wind Region		Wind- borne Debris Zone	Weathering	Frost Line Depth					
30	*Special Wind Region	NO	NO	C	Severe	42"	Moderate to Heavy	4A	YES	**FIRM COMMUNITY - PANEL MAP # 36119C0261F EFFECTIVE DATE: 9-28-2007	2000	51.6

*115 MPH to 120 MPH. The specialist wind region should serve as warning to design professionals is evaluating wind loading conditions. Wind speed higher than the derived values taken from Section 1603 of the IRC and Figure R501.2(4)(A) of the IRC are likely to occur and should be consider in the design.
**State if applicable. For Flood Hazards the Design Professional shall state if they are applicable. Y/N. Verify with FIRM Maps. Maps are available on the FEMA web site <http://floodmap.floodsample.com/>

2.Construction Sequences

- Phase 1 - 3 weeks.
- General Site Work, Silt Fence, Tree Protection, Tree removal, Excavation, Utility Connections, Locate Concrete Footings and Foundation Preparation.
- Phase 1.2 - 4 weeks
- Concrete Foundation, Underground plumbing.
- Phase1.3 - 3 weeks
- Basement Concrete Slab, Backfilling foundation, Site Grading, Soil Retention, Site Drainage.
- Phase 2 - 16 Weeks
- Rough Framing, Structural Steel work, Wood Framing, Sub-floors, Sub-Roof, Sheathing, Air Barrier.
- Phase 2.1 - 8 Weeks
- Roofing, Installing Windows, Installing Siding and Exterior Finishes, Interior Framing and Stairs
- Phase 2.2 - 12 Weeks
- All rough in Mechanical, Electrical, and Plumbing. Modifying Framing as required, prepare to accommodate finishes etc.
- Phase 3 - 12 Weeks
- Install Sheetrock, Tape and Prime, Tile and Stone Finishes, Bathroom and Kitchen Waterproofing, Wood Flooring, Decking etc.
- Phase 4 - 12 Weeks
- Install Millwork, Cabinets, Closets, Doors, Hardware, Appliances, Final Paint and Accessories
- Phase 4.1 - 6 Weeks
- Final Landscaping, Hardscape, Plantings, Clean Up, Close Out, C of O. Punch List.


*Case Development Projects that this project will take approximately 15 Months in total construction time and there will be some overlap between the phases. We are hoping to begin upon approval from the Village in the early spring 2017.

3.Maintenance Guidelines For Cultec Stormwater System

- The following guidelines shall be adhered to for the operation and maintenance of the CULTEC stormwater management system:
- a. The owner shall keep a maintenance log which shall include details of any events which would have an effect on the system's operational capacity.
 - b. The operation and maintenance procedure shall be reviewed periodically and changed to meet site conditions.
 - c. Maintenance of the stormwater management system shall be performed by qualified workers and shall follow applicable occupational health and safety requirements.
 - d. Debris removed from the stormwater management system shall be disposed of in accordance with applicable laws and regulations.


4. Suggested Maintenance Schedules

- a. Minor Maintenance
- The following suggested schedule shall be followed for routine maintenance during the regular operation of the stormwater system:
- Frequency Action Monthly in first year Check inlets and outlets for clogging and remove any debris as required.
- Spring and Fall Check inlets and outlets for clogging and remove any debris as required.
- One year after commissioning and every third year following
- Check inlets and outlets for clogging and remove any debris as required.
- b. Major Maintenance
- The following suggested maintenance schedule shall be followed to maintain the performance of the CULTEC stormwater management chambers. Additional work may be necessary due to insuffi cient performance and other issues that might be found during the inspection of the stormwater management chambers.

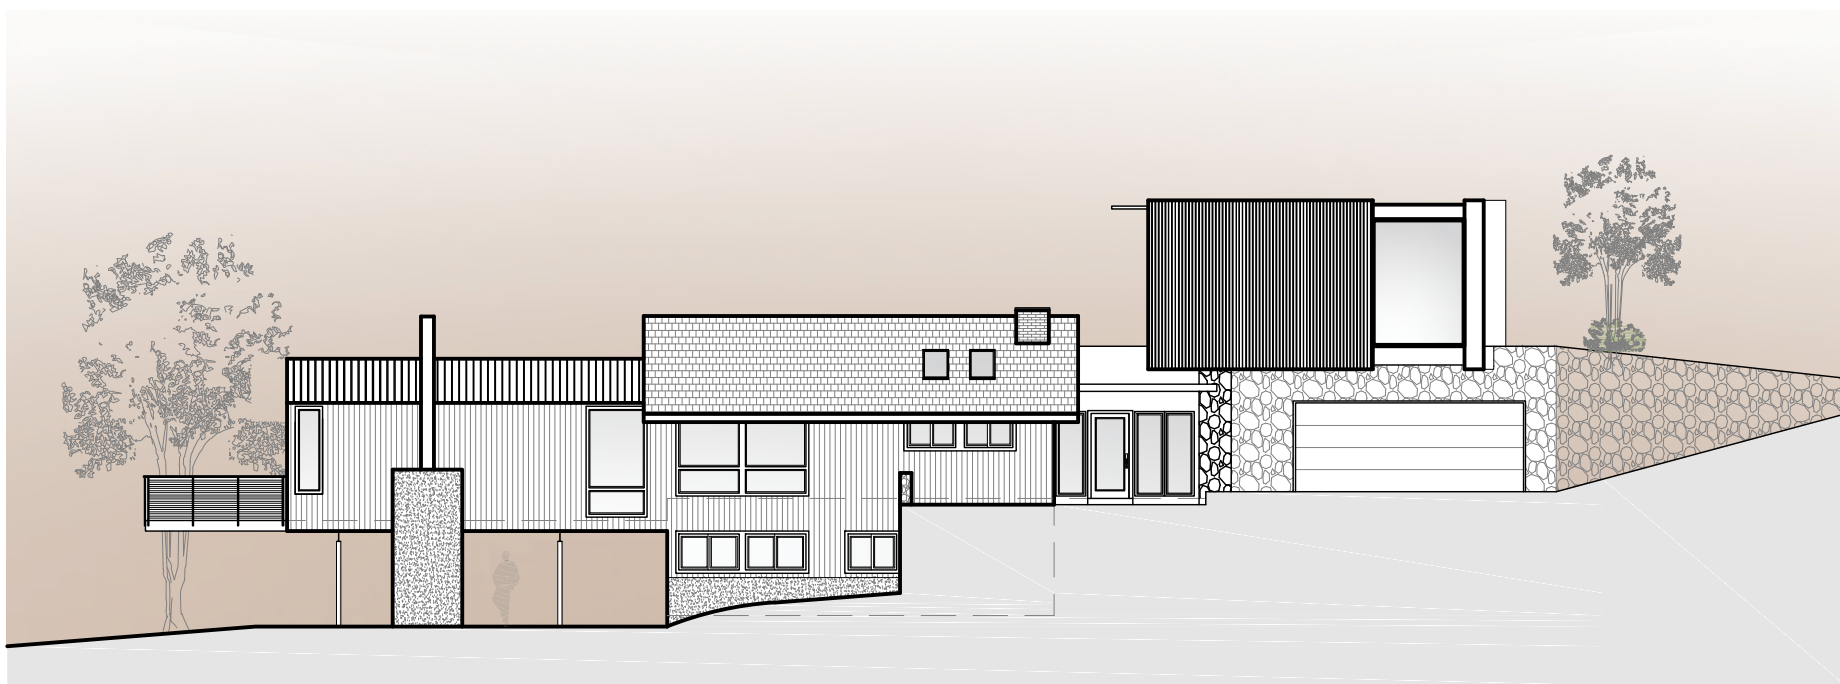


2 Rendering of Proposed Front


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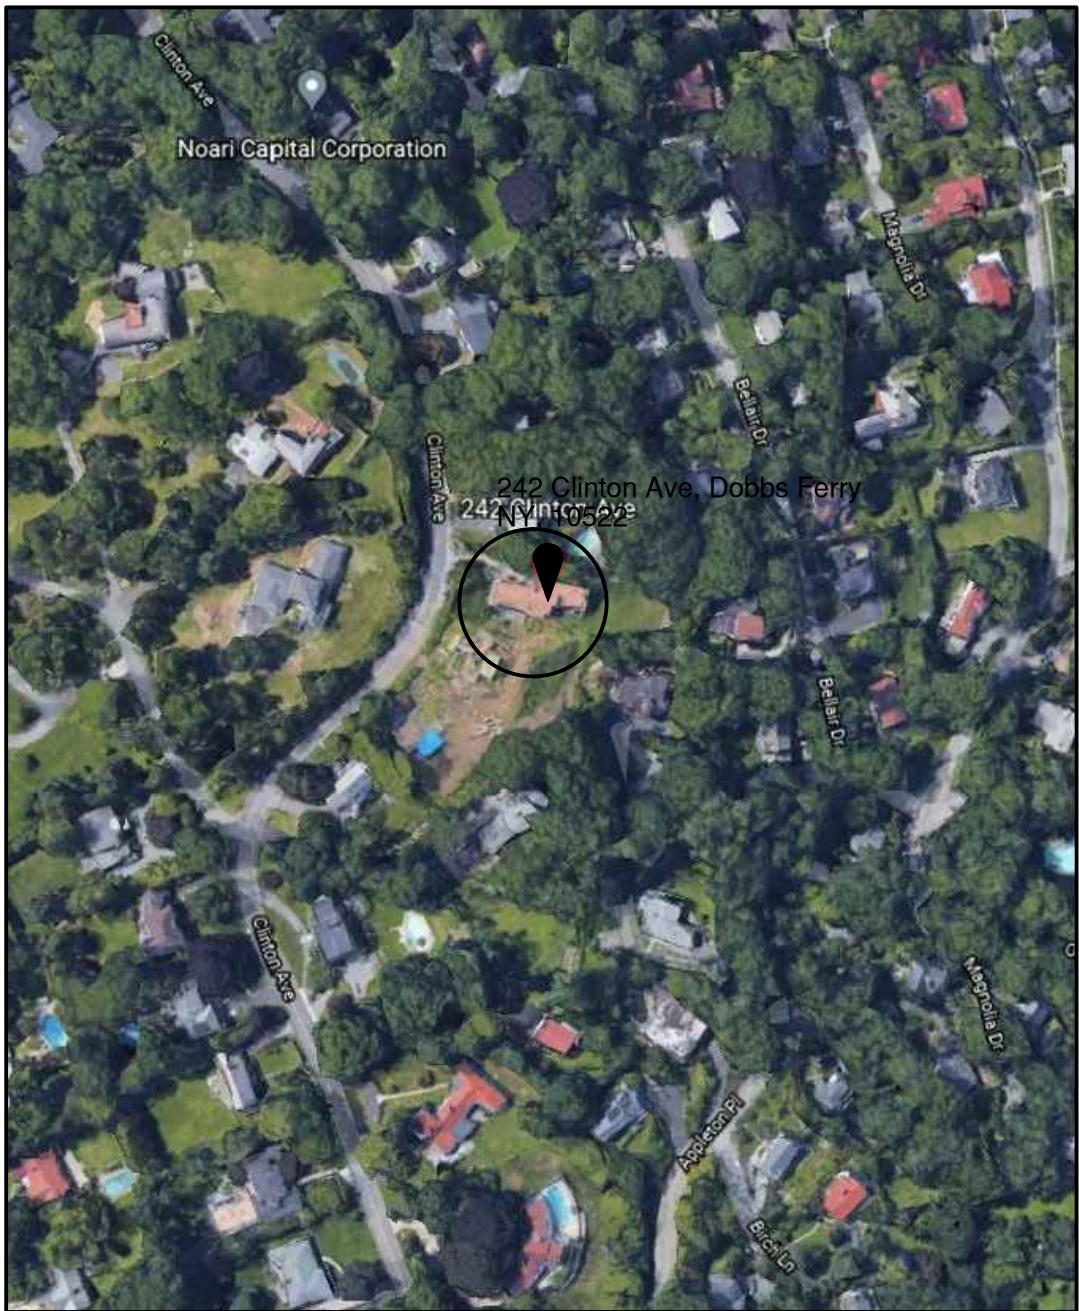
3 Zoning Diagram - Proposed Front & Rear Elevation

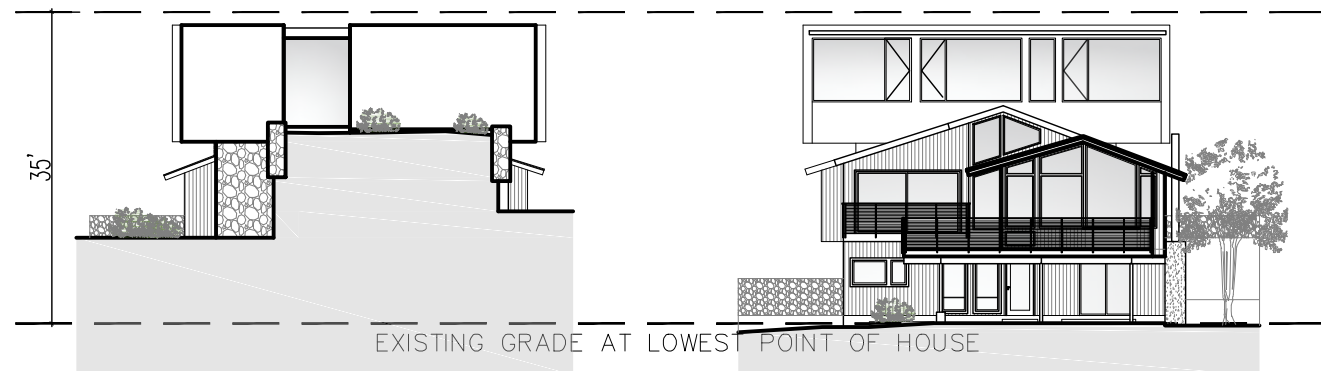

4 Zoning Diagram - Proposed Side Elevation

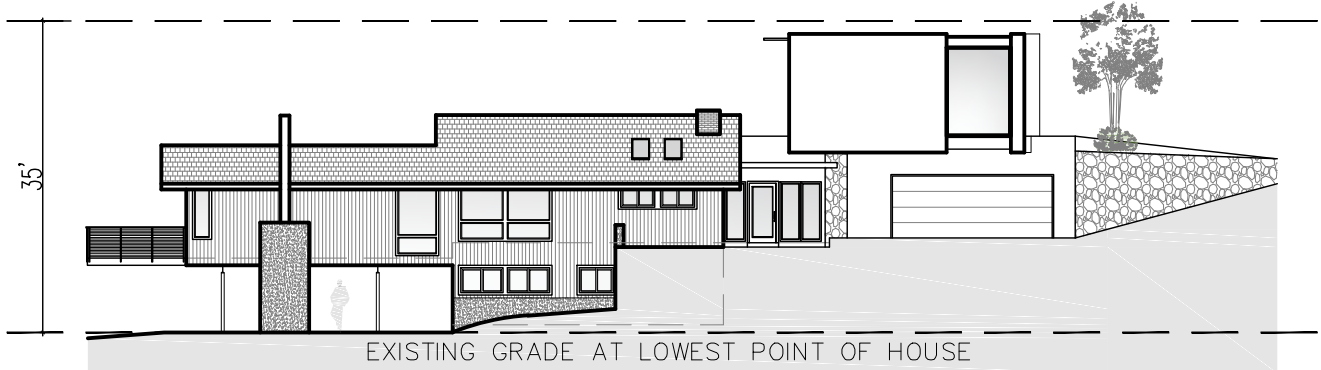

5 Zoning Diagram - Proposed Side Elevation

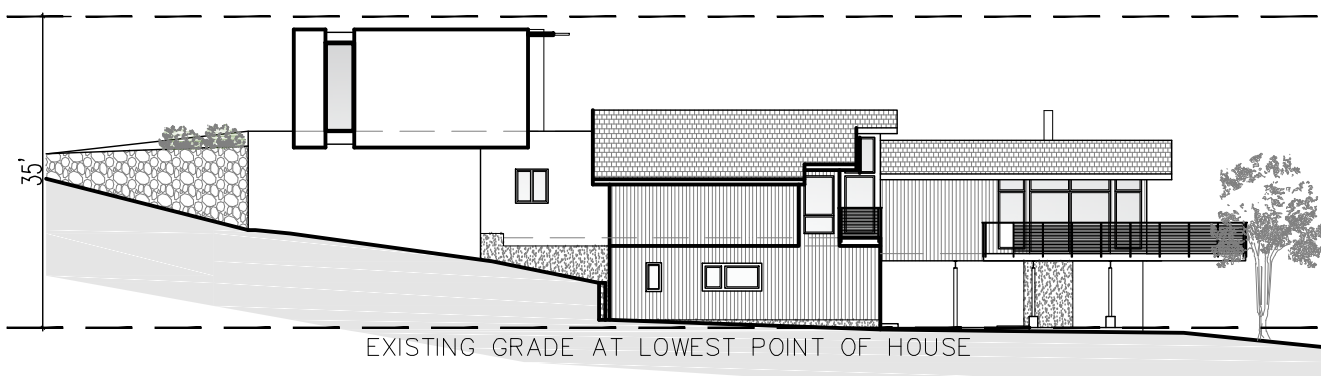

6 Land Parcel and Surrounds from above

Do Not Scale See - Dimensions

Project Architect:

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D.O.B CONSULTANT

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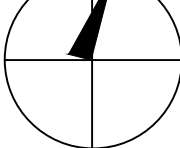
PROJECT ENGINEER

NOTES

SYMBOL LEGEND

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|--|-----------------------|
| | Interior Elevation |
| | See Detail |
| | Elevation |
| | Section Cut |
| | Window Number |
| | Coordination Tag |
| | Door Number |
| | Wall Type |
| | 0.0' Elevation Target |
| | Revision |

North Arrow:



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DRAWING INFORMATION

ISSUED FOR PRE-FILE 5-14-2021
ISSUED FOR REVIEW 6-18-2021
ISSUED FOR PERMIT

D.O.B. No. -

A Remodelation House located in
Dobbs Ferry, NY developed by:

The Hoffman Residence

PROJECT:

THE HOFFMAN RESIDENCE
242 CLINTON AVENUE,
DOBBS FERRY, NY 10522

TITLE PAGE

SEAL AND SIGNATURE:	DATE:	9/19/2021
	PROJECT No:	HOFFMAN_2021
	DRAWING BY:	GS
	CHECK BY:	
	DWG No:	
	T-001.00	
	CADD No:	

BSCAN:

D.O.B CONSULTANT

LANDSCAPE ARCHITECT

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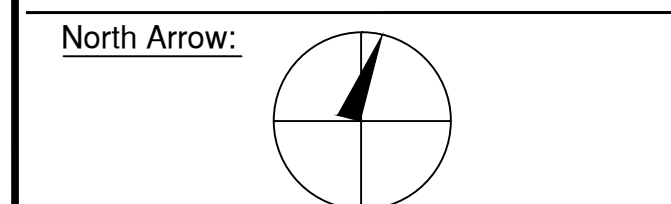
STRUCTURAL ENGINEER

PROJECT ENGINEER

NOTES

SYMBOL LEGEND

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	Elevation
	Section Cut
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	Coordination Tag
	Door Number
	Wall Type
	0.0' Elevation Target
	Revision



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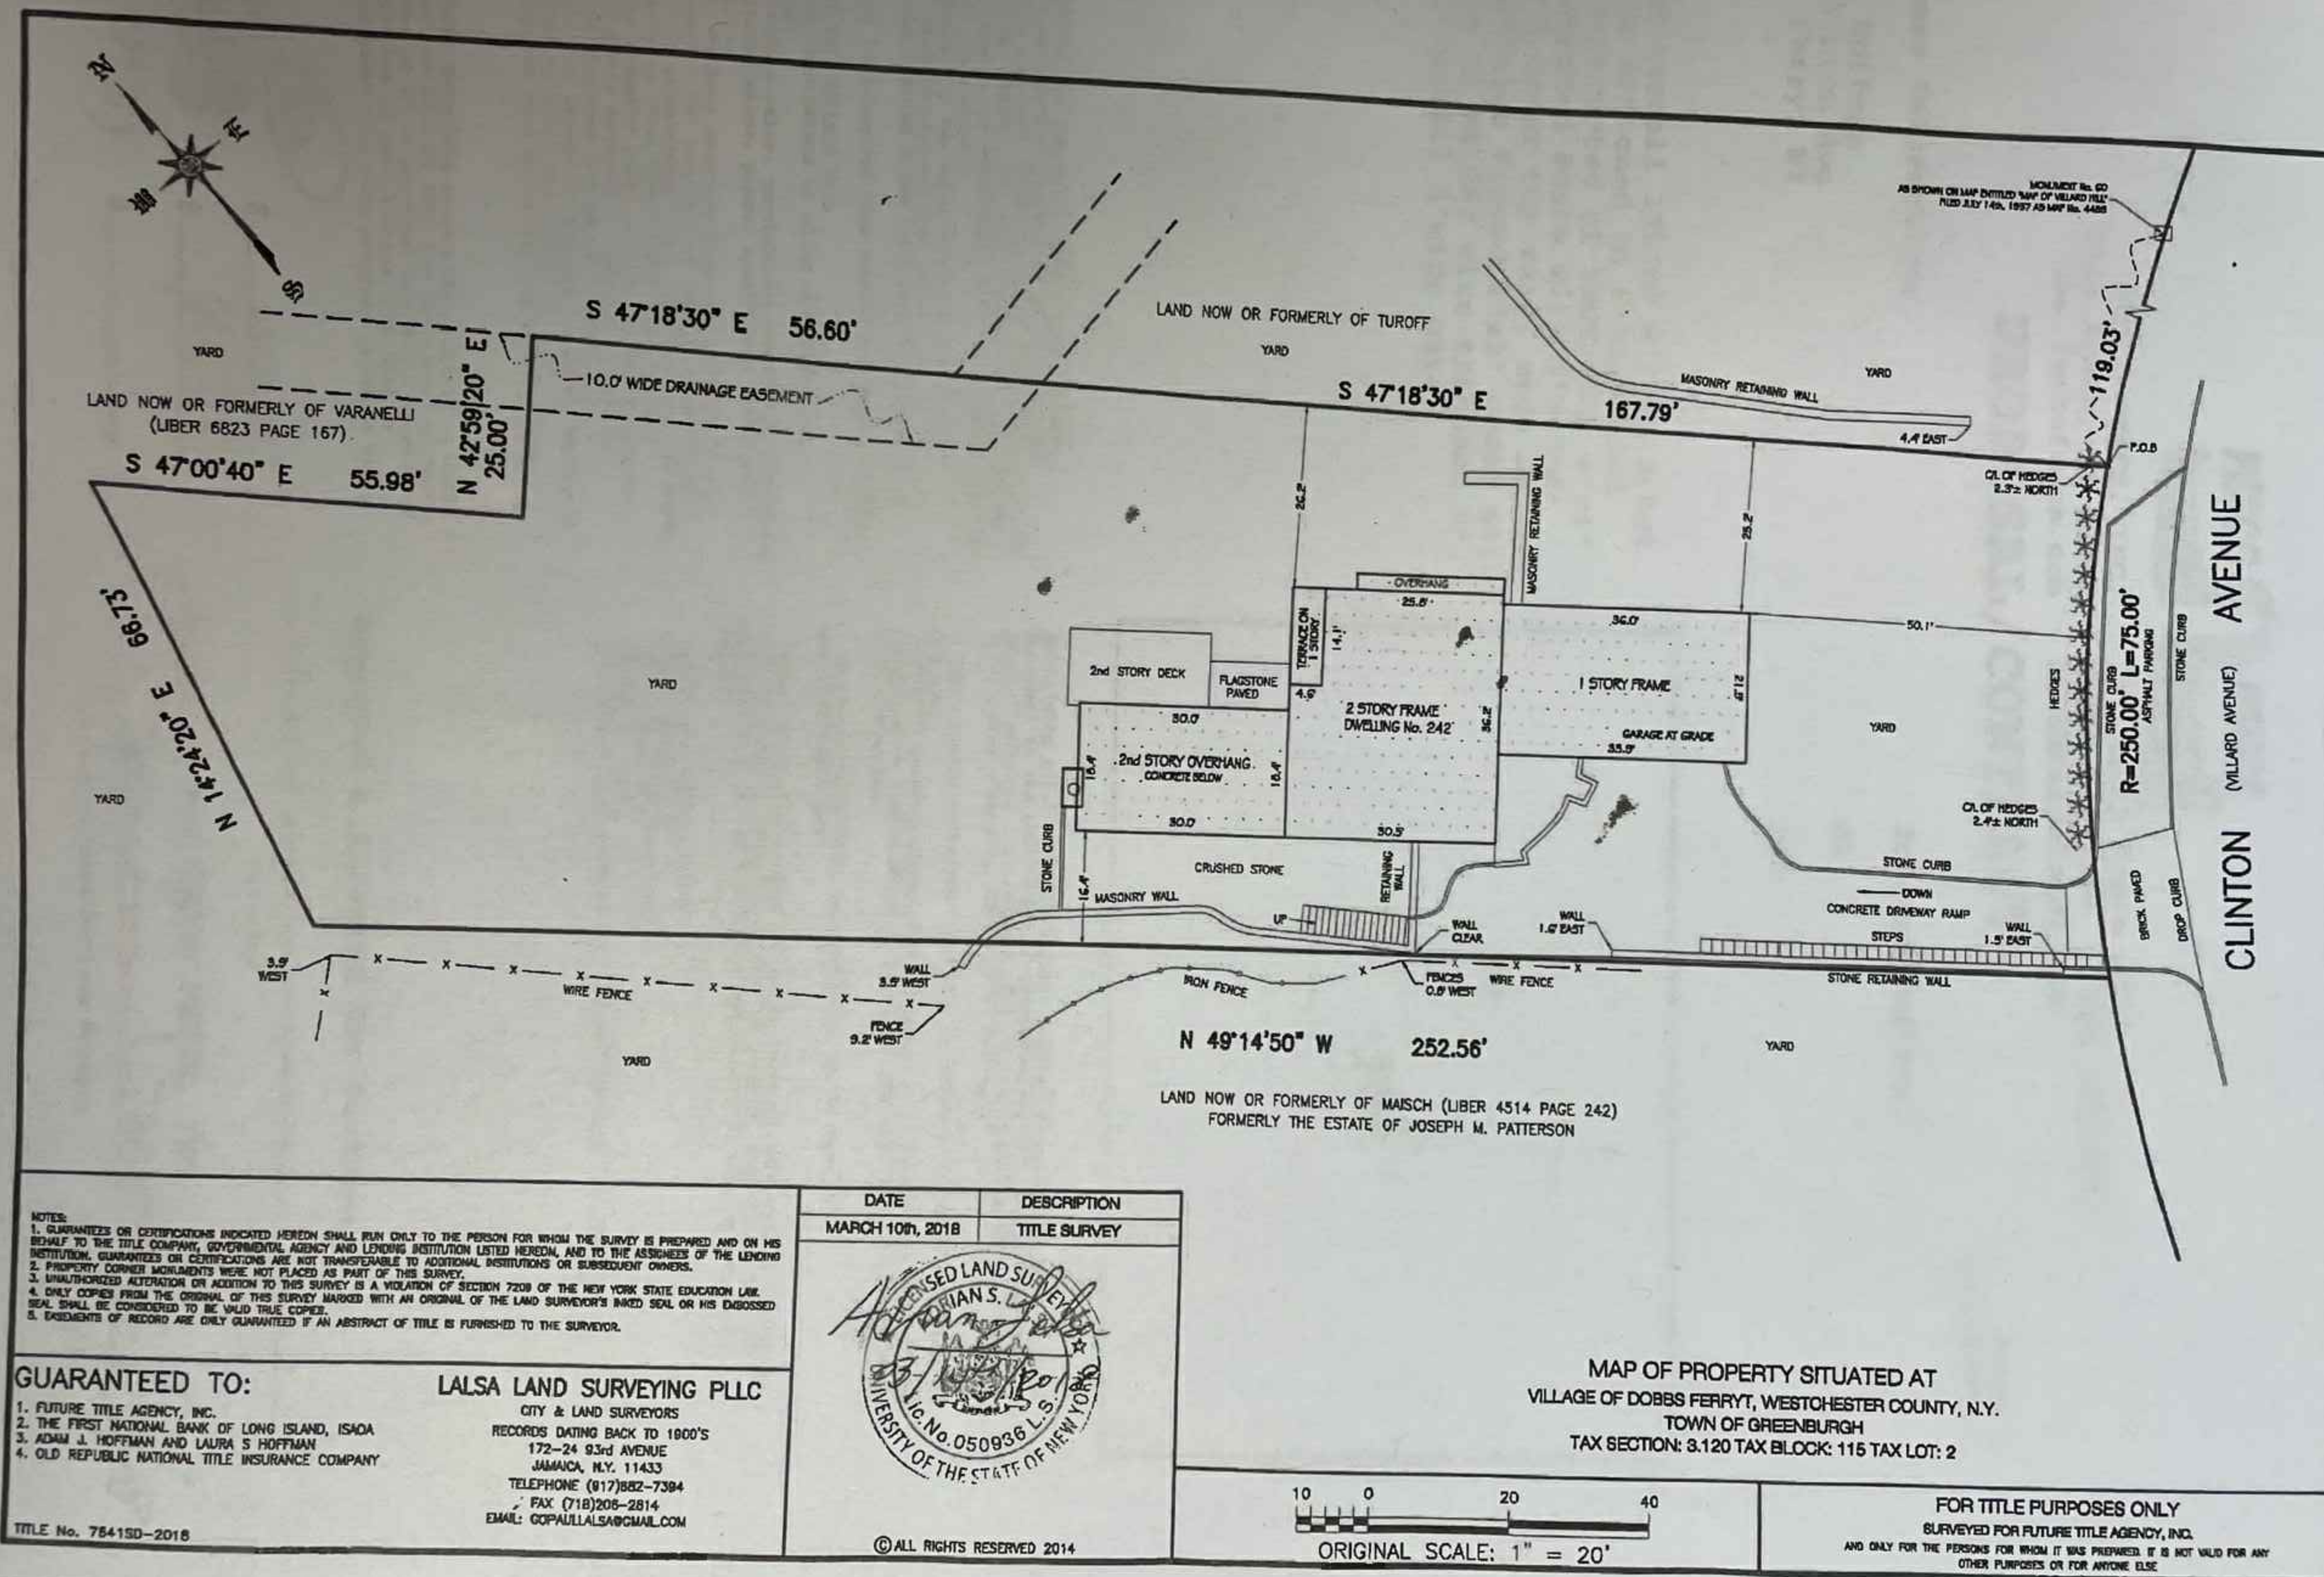
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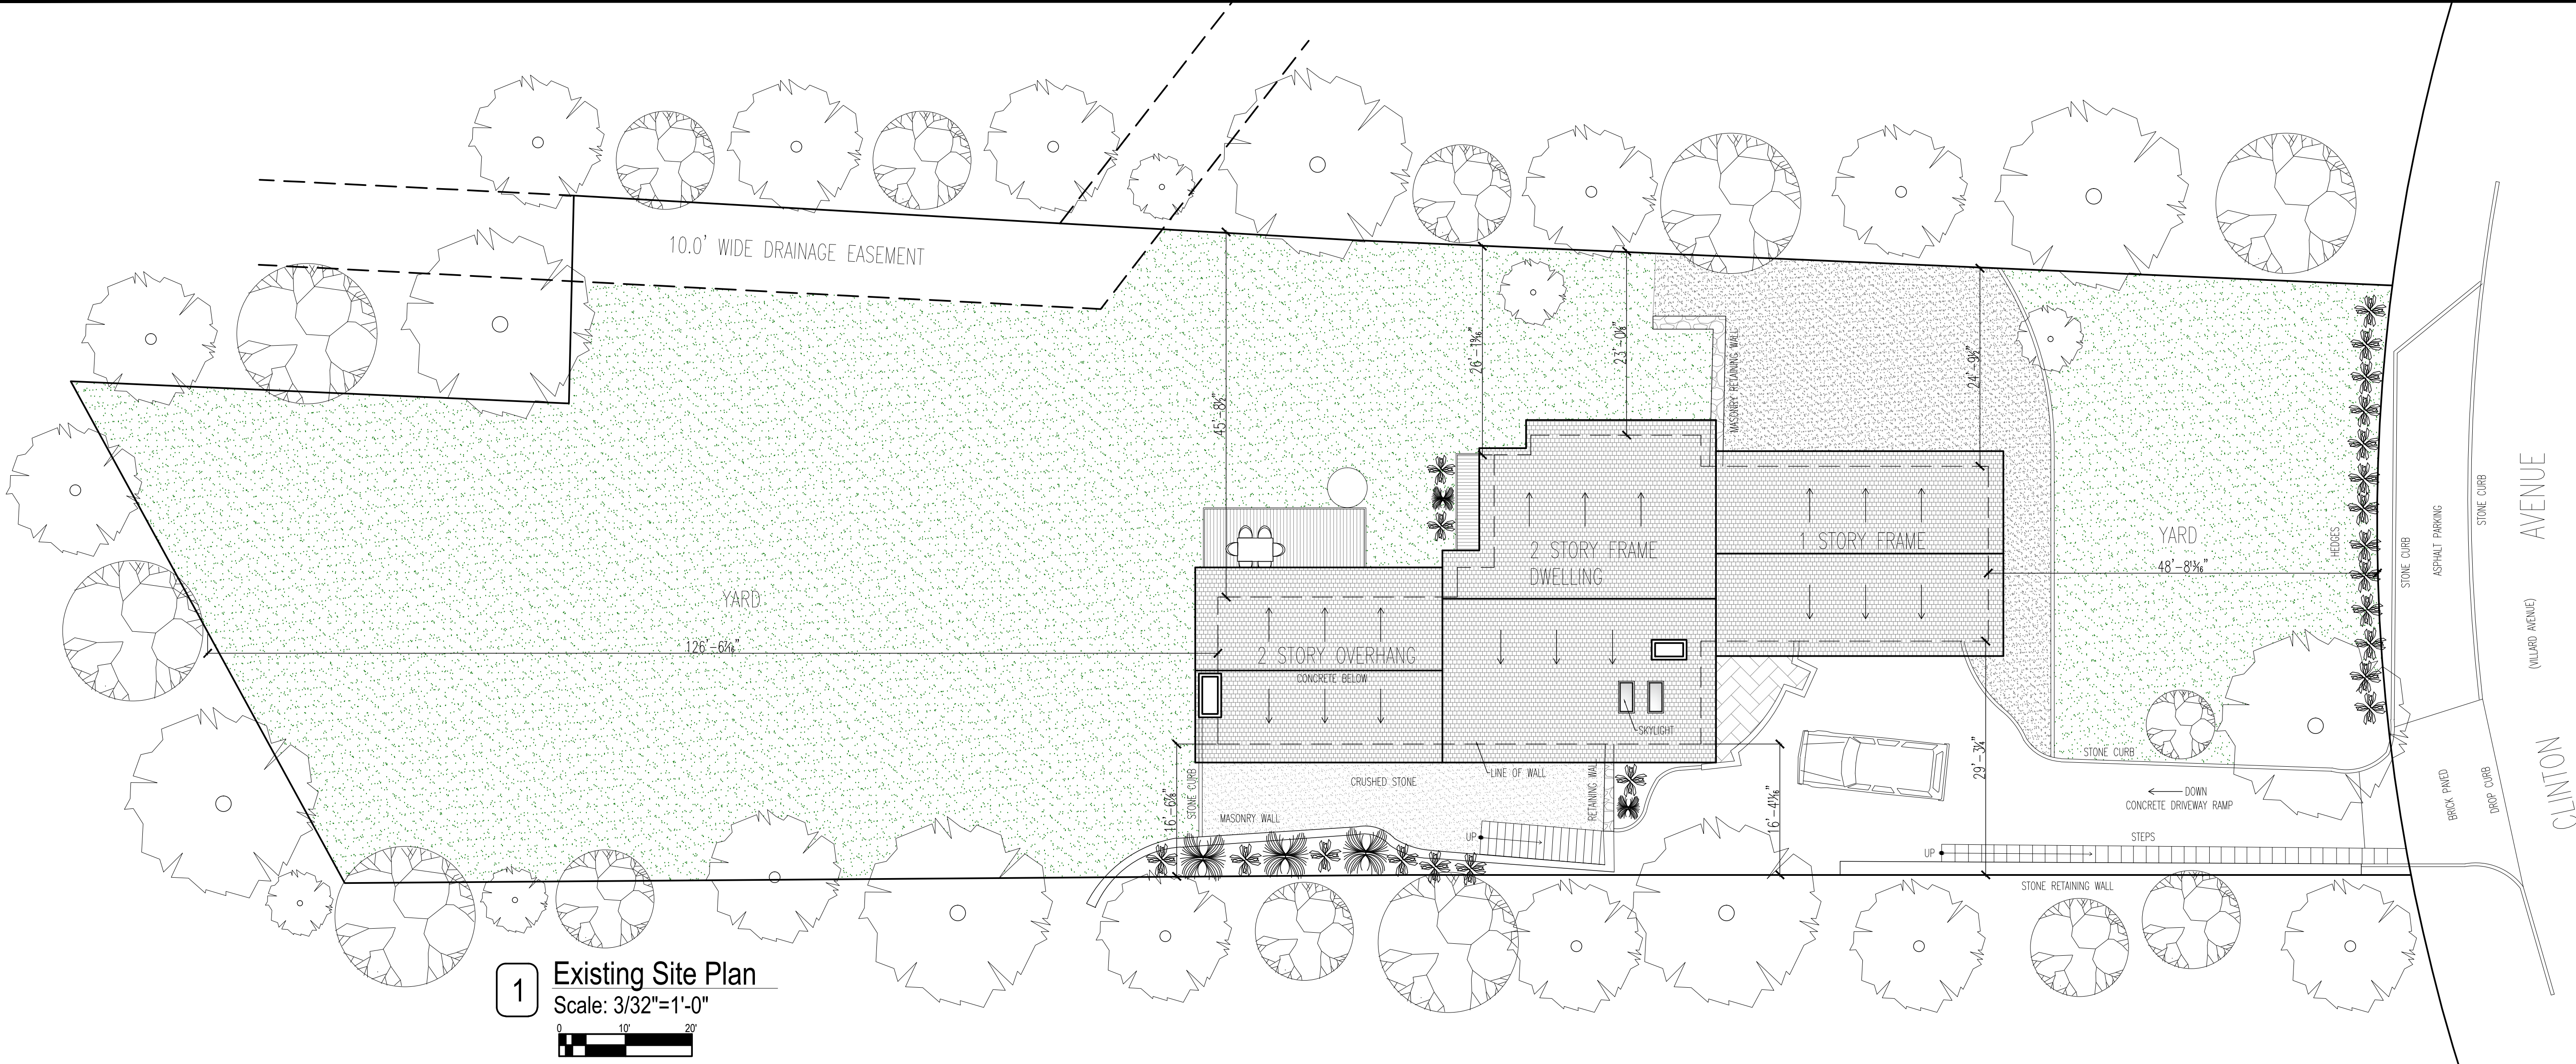
SURVEY

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DATE: 9/18/2021
PROJECT No: HOFFMAN 2021
DRAWING BY: GS
CHK BY:
DWG No:
T-002.00
CADD No:

BSCAN:





1 Existing Site Plan
Scale: 3/32"=1'-0"



2 Existing Conditions



3 Neighbors



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WWW.CASEDEVELOPMENT.COM
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LANDSCAPE ARCHITECT


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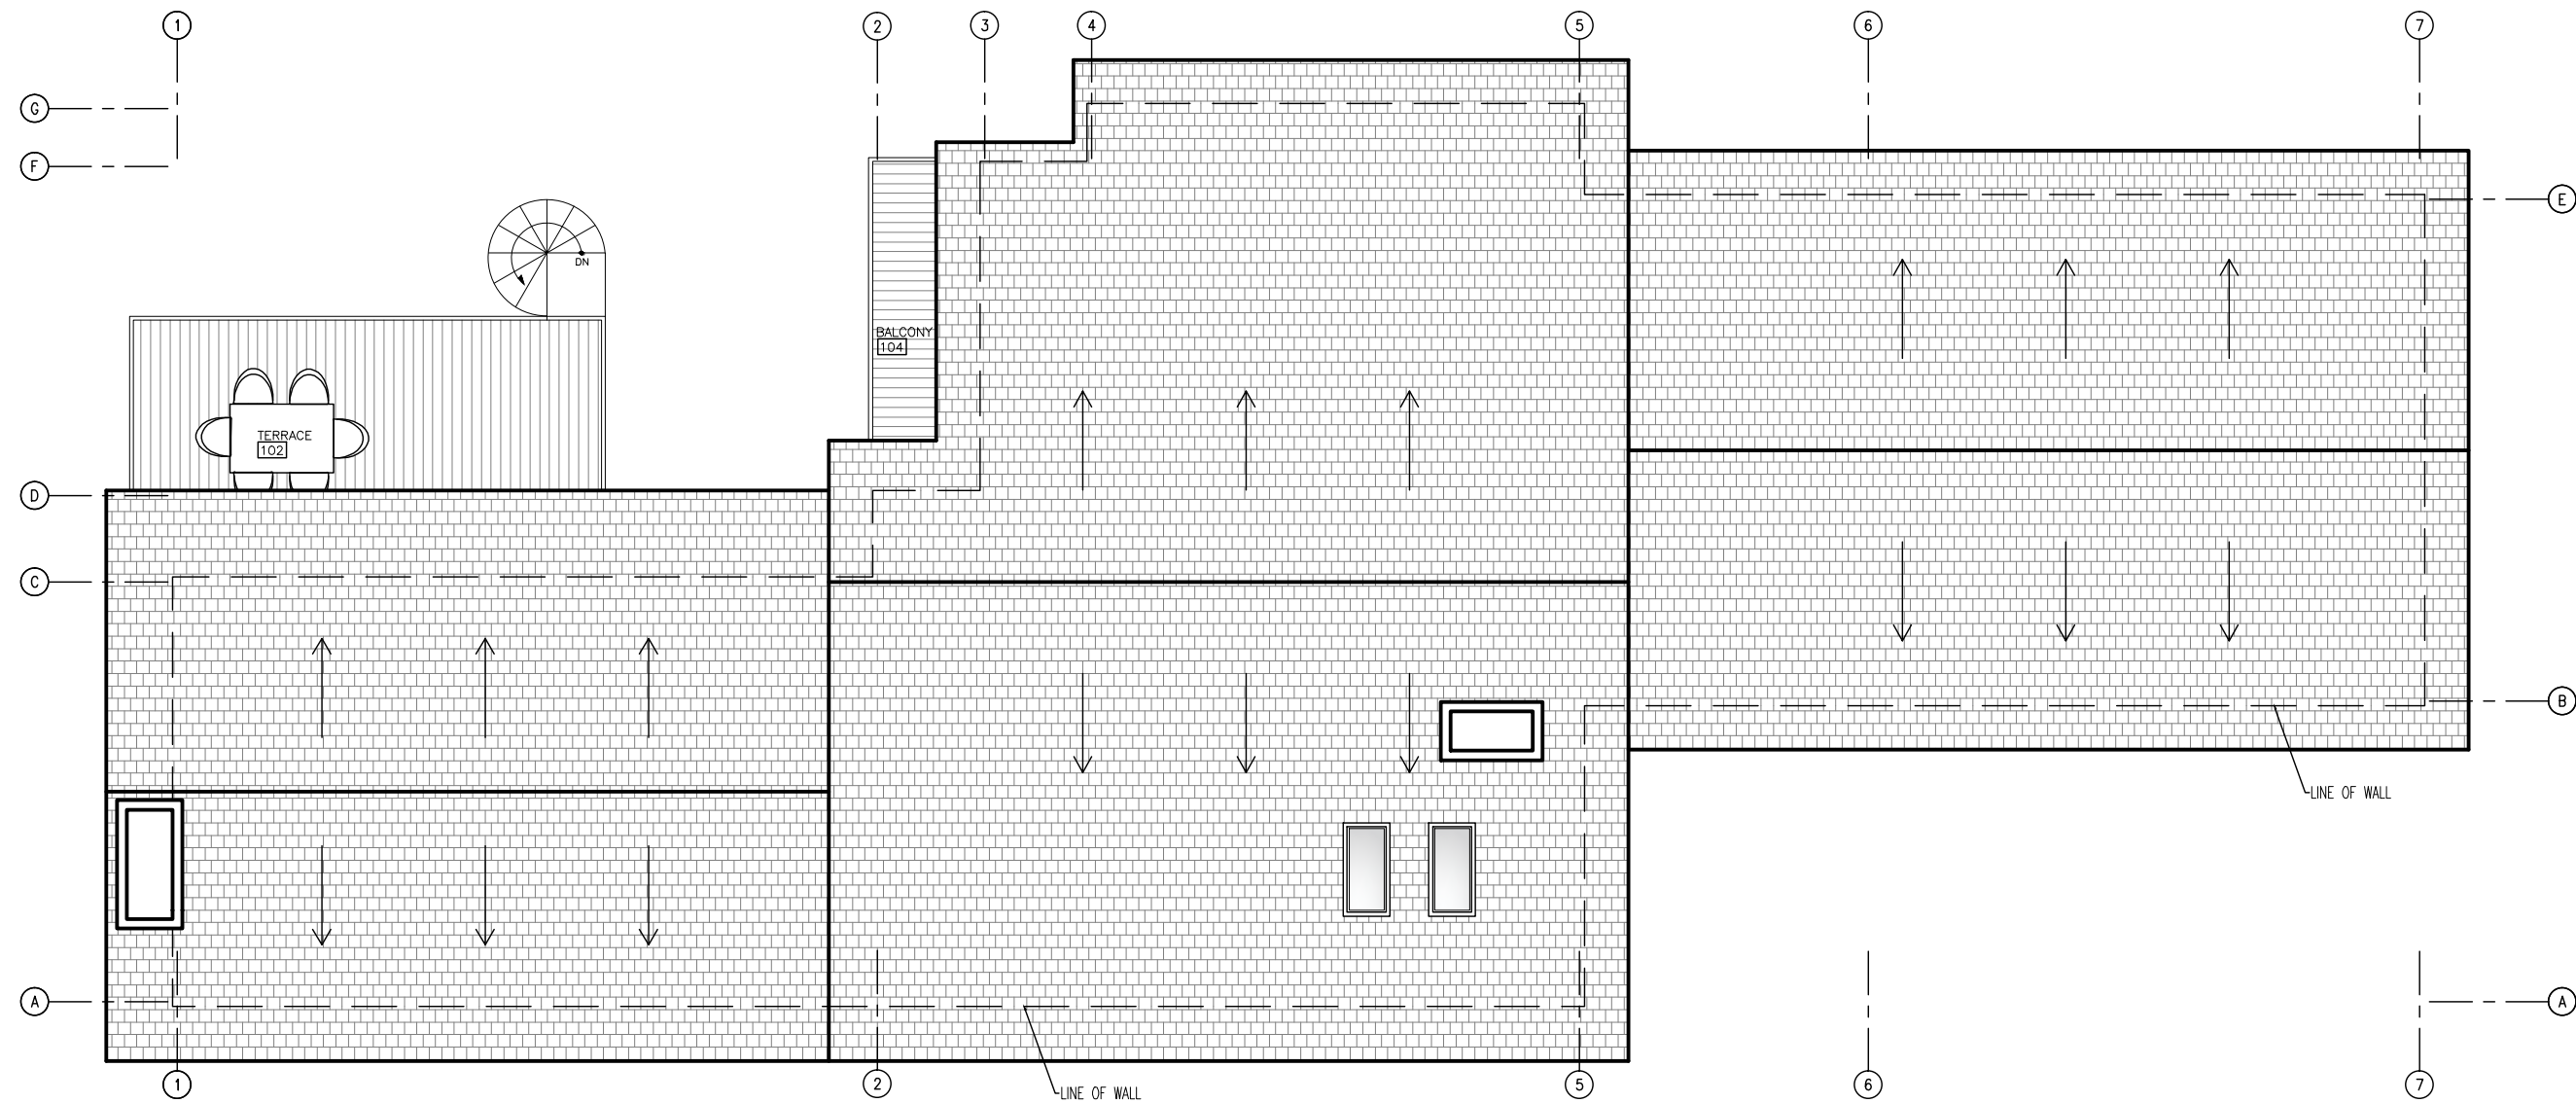
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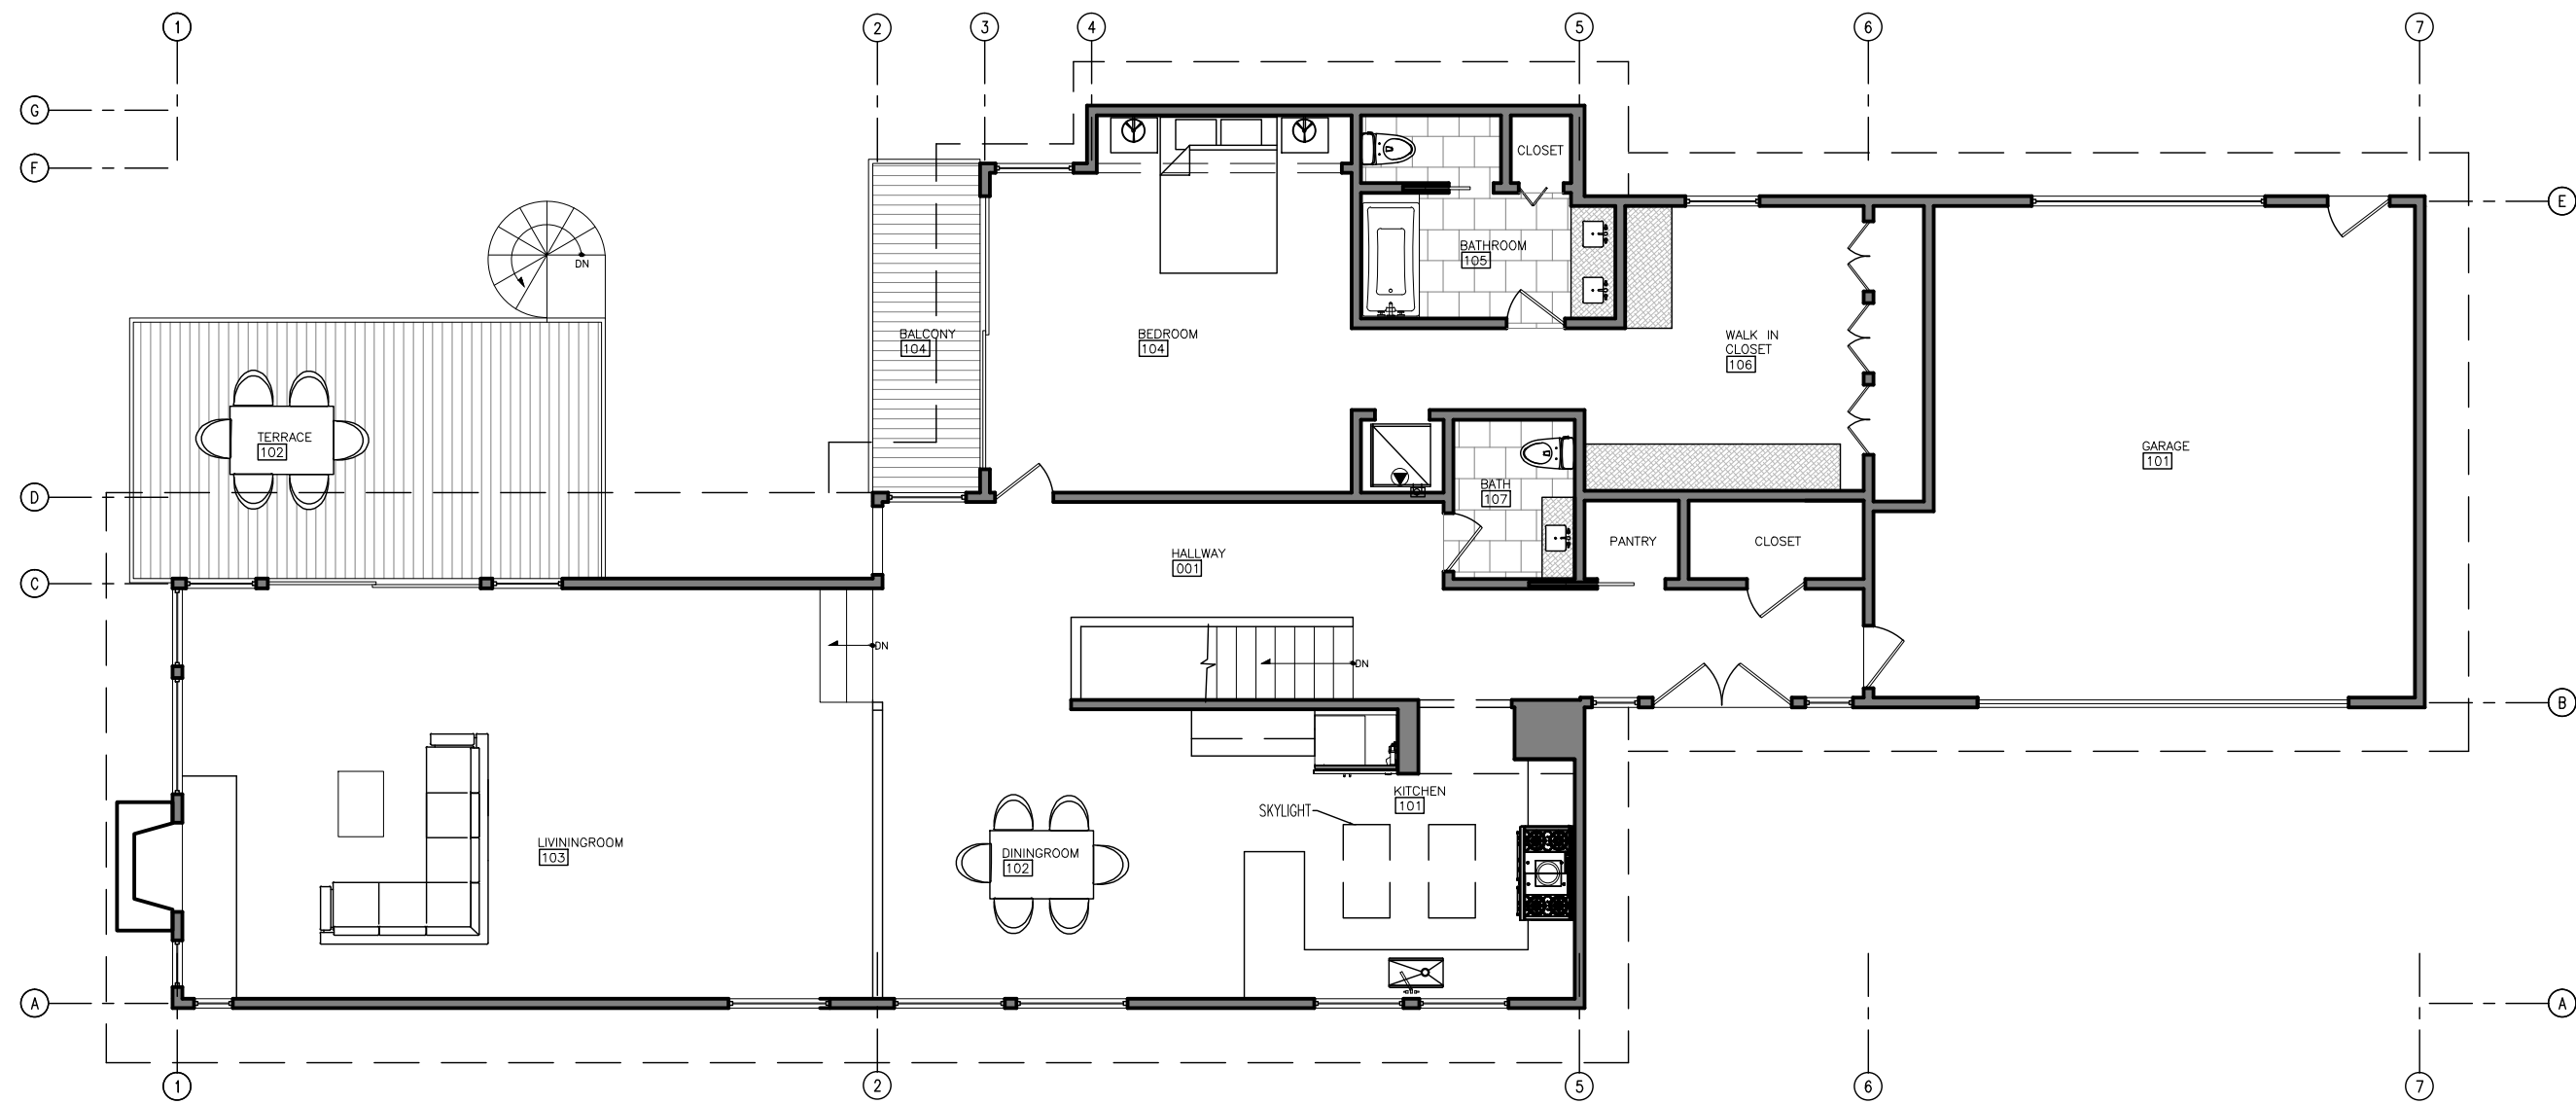
EXISTING SITE PLAN & PICTURES

SEAL AND SIGNATURE: 	DATE: 8/18/2021 PROJECT No: HOFFMAN 2021 DRAWING BY: GS CHK BY: DWG No: T-003.00 CADD No:
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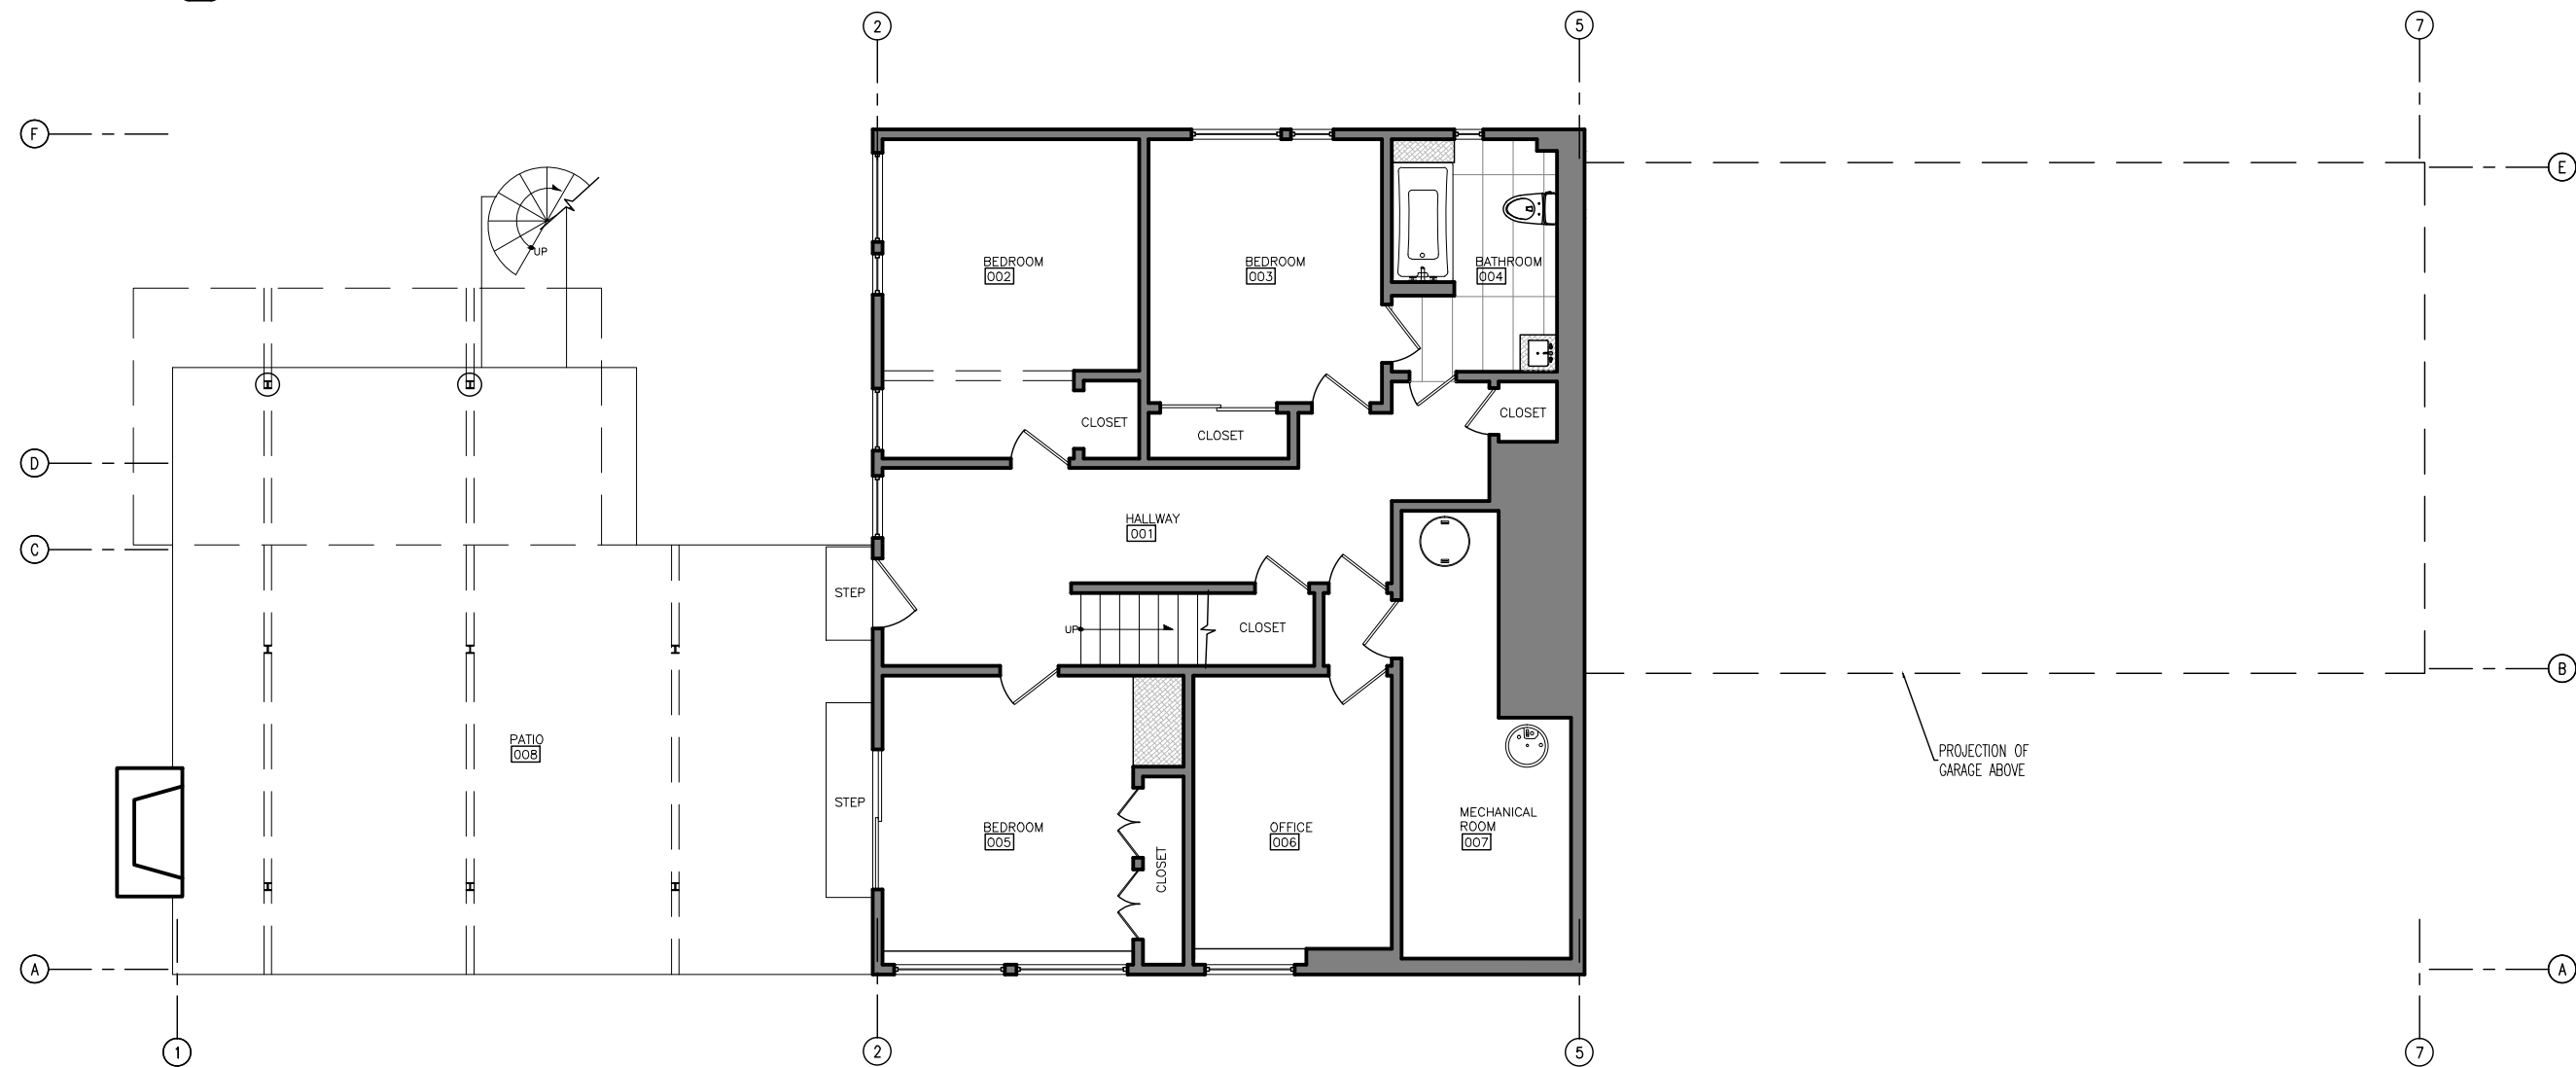
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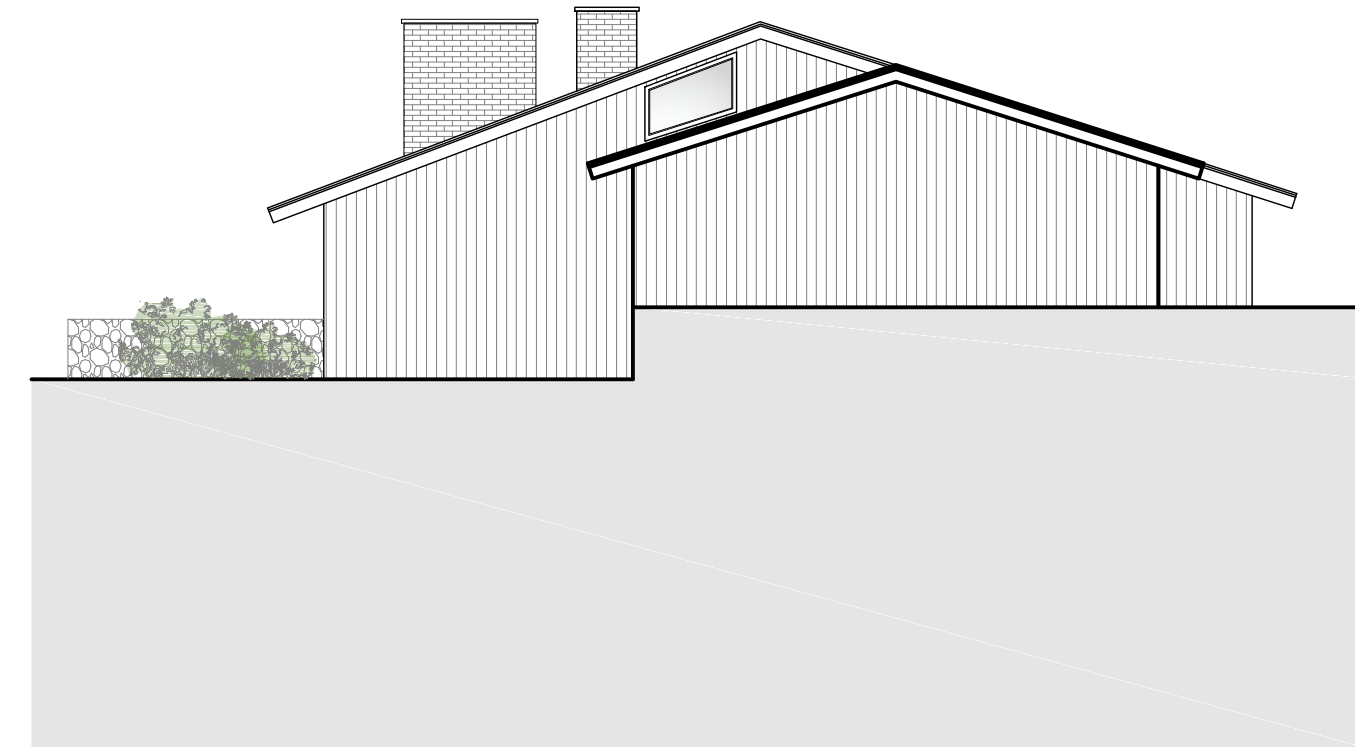
2 Existing First Floor Plan
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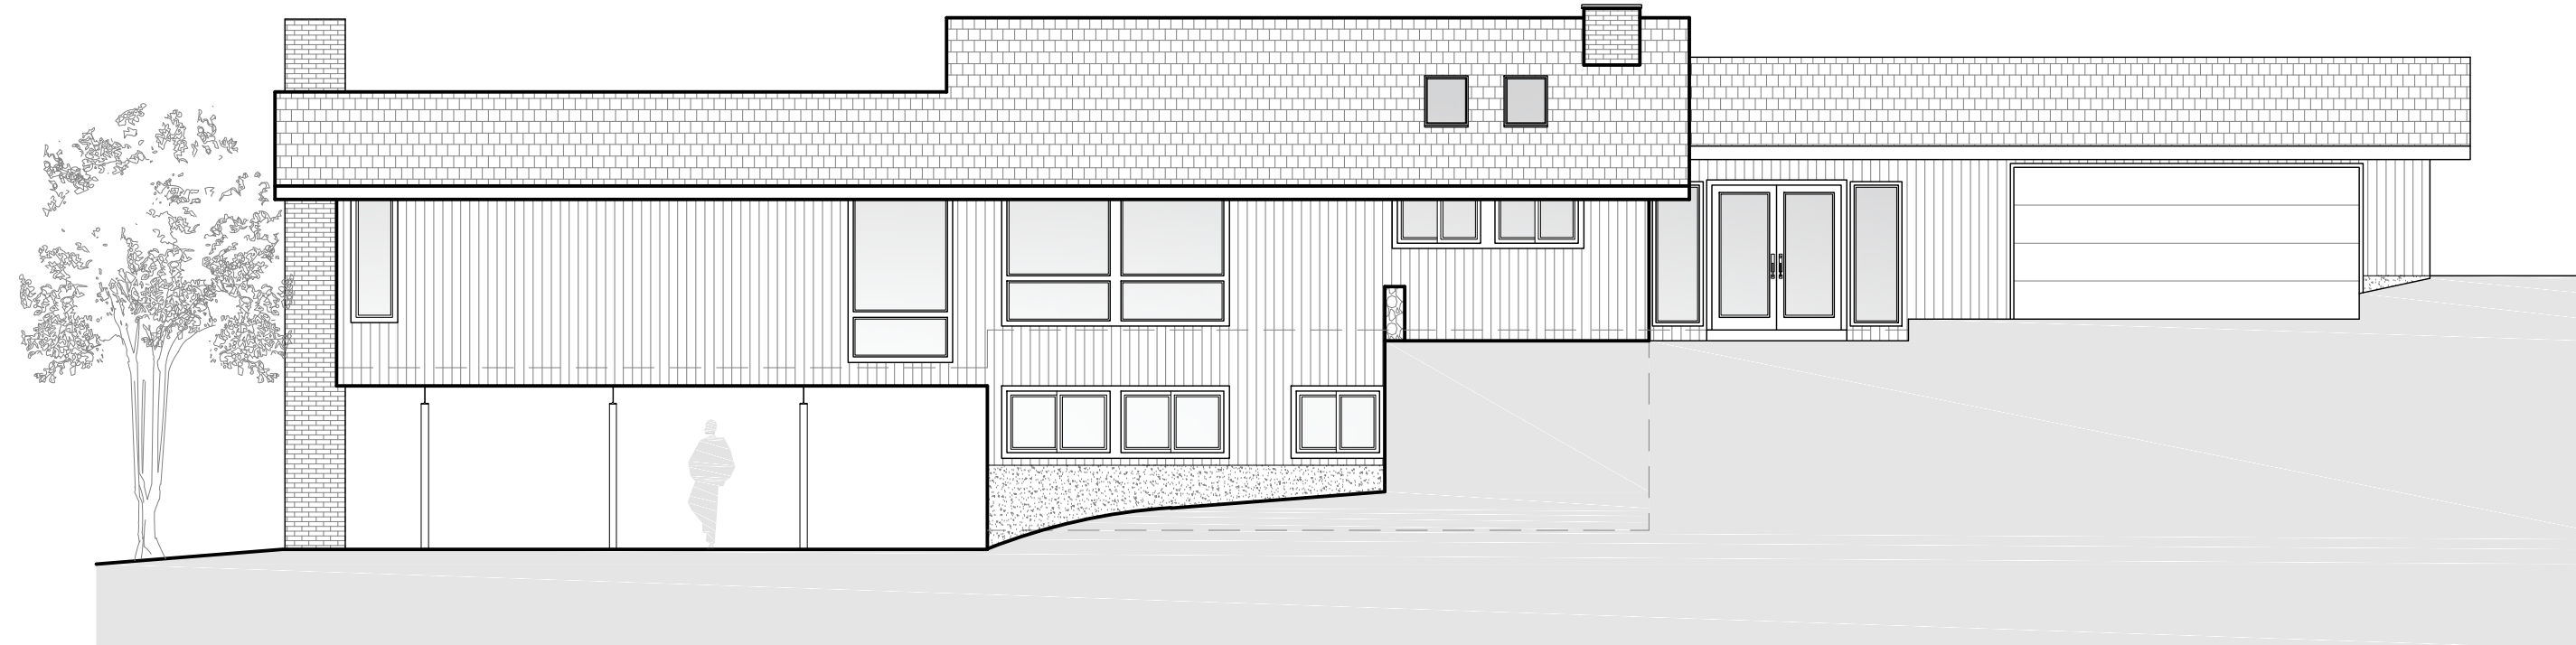
3 Existing Basement Floor Plan
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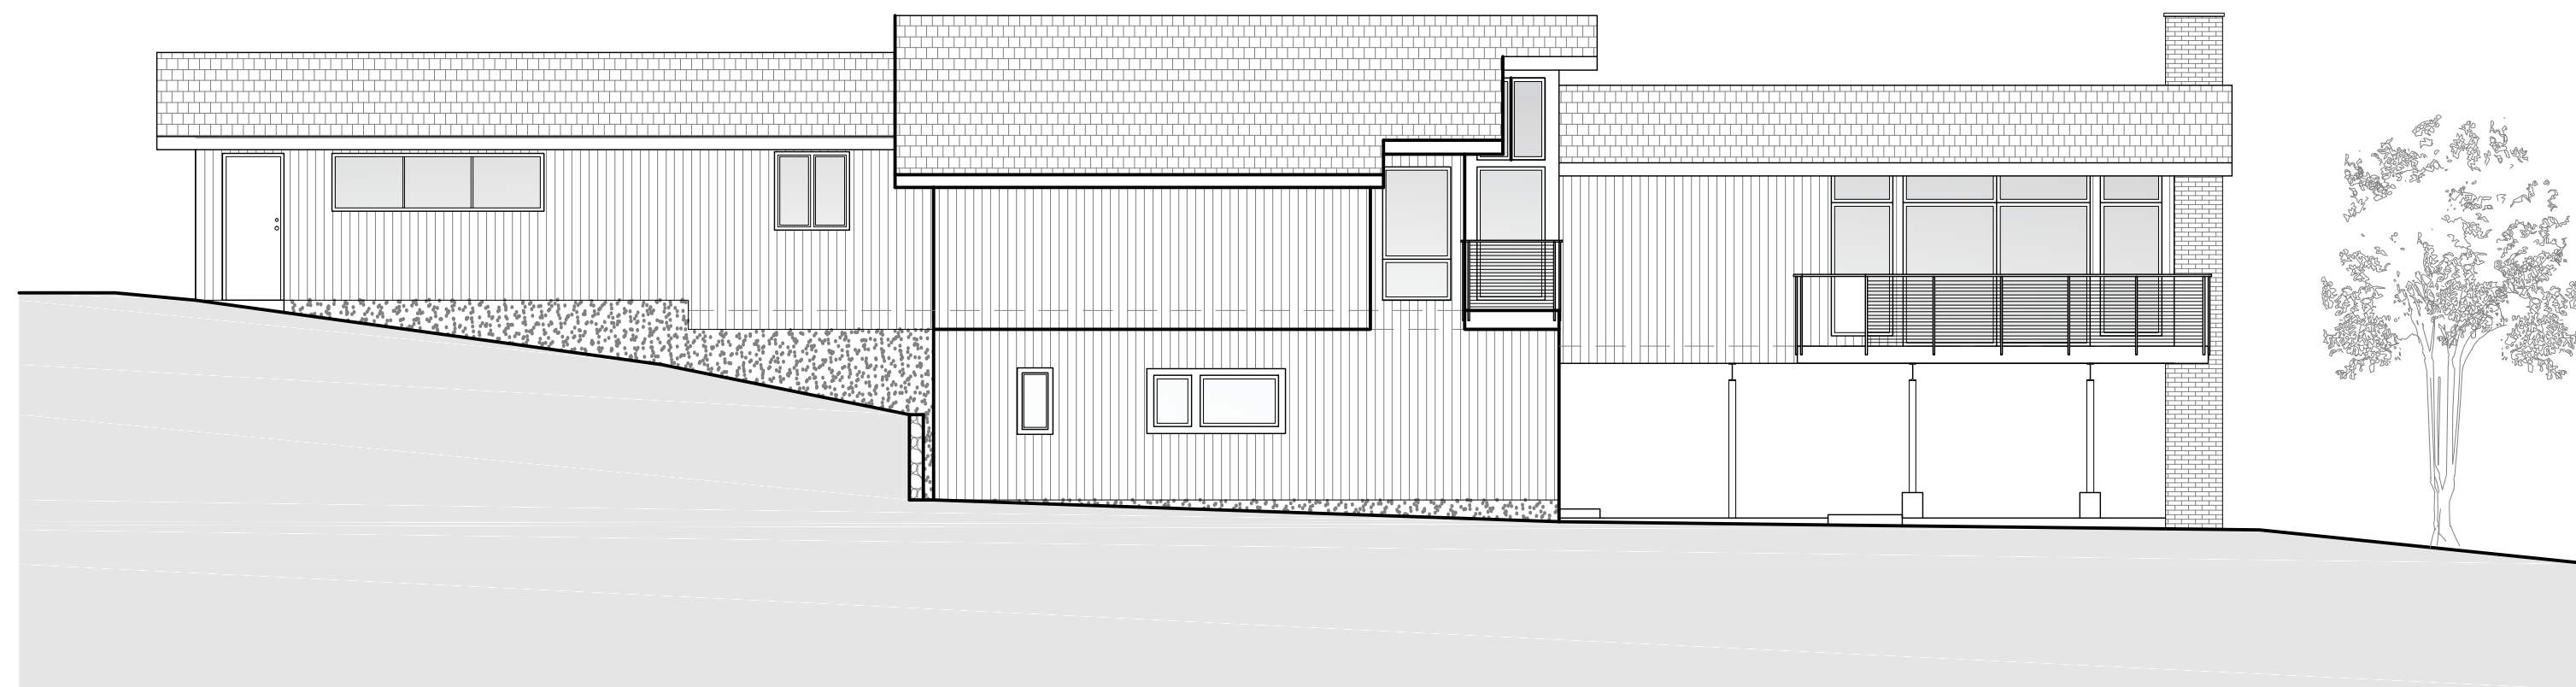
4 Existing Rear Elevation
Scale: 1/8"=1'-0"



5 Existing Front Elevation
Scale: 1/8"=1'-0"

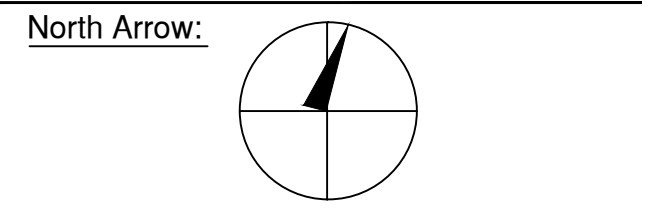

6 Existing Side Elevation
Scale: 1/8"=1'-0"



7 Existing Side Elevation
Scale: 1/8"=1'-0"

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ARBORIST

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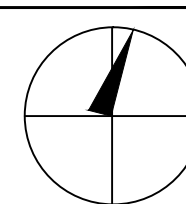
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North Arrow:



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THE HOFFMAN RESIDENCE
242 CLINTON AVENUE,
DOBBS FERRY, NY 10522

EXISTING CONDITIONS

SEAL AND SIGNATURE:



DATE: 6/18/2021

PROJECT No: HOFFMAN 2021

DRAWING BY: GS


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DWG No:


T-004.00

CADD No:

BSCAN:

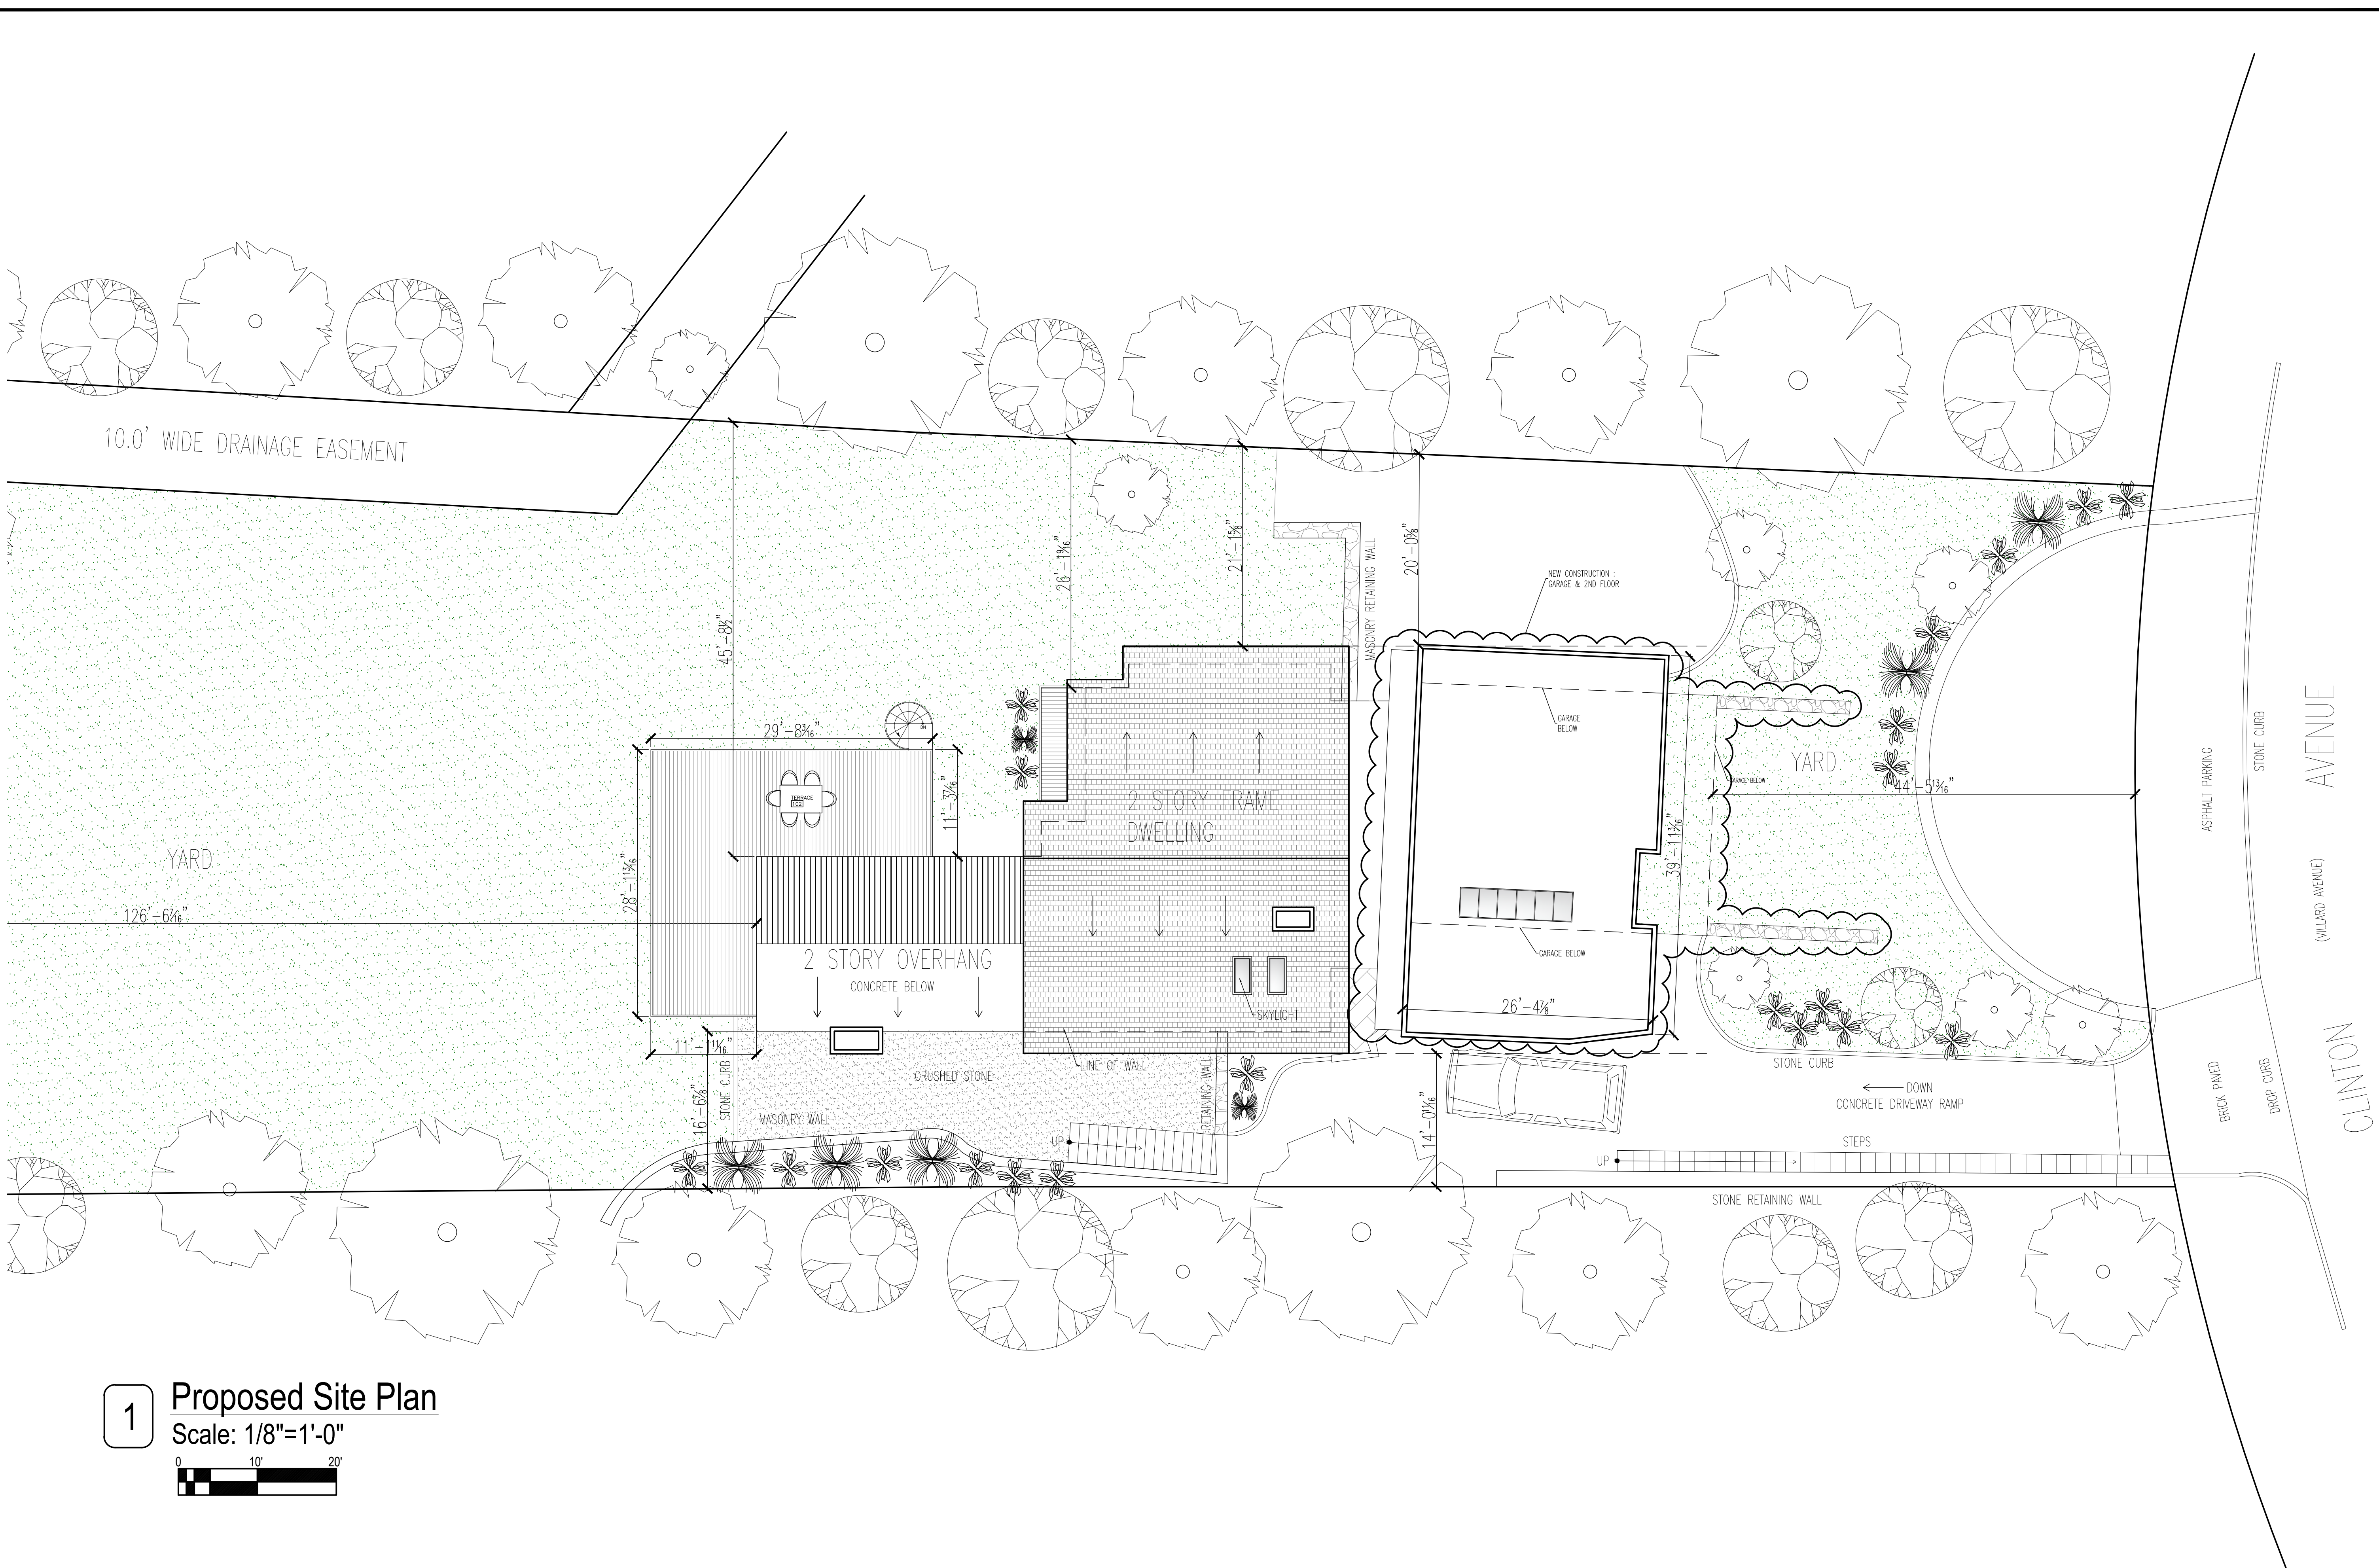

1 Proposed Site Plan
Scale: 1/8"=1'-0"

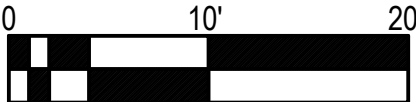

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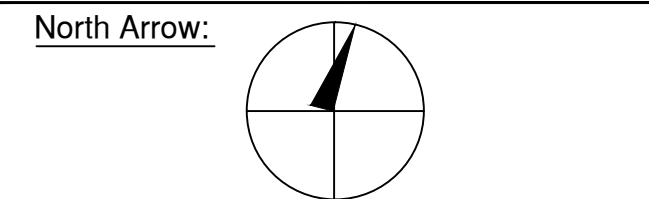
ARBORIST

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Dobbs Ferry, NY developed by:

The Hoffman Residence


PROJECT:
THE HOFFMAN RESIDENCE
242 CLINTON AVENUE,
DOBBS FERRY, NY 10522

PROPOSED SITE PLAN


SEAL AND SIGNATURE:

DATE: 6/18/2021
PROJECT No: HOFFMAN 2021
DRAWING BY: GS
CHK BY:
DWG No: **A-001.00**
CADD No:

BSCAN:

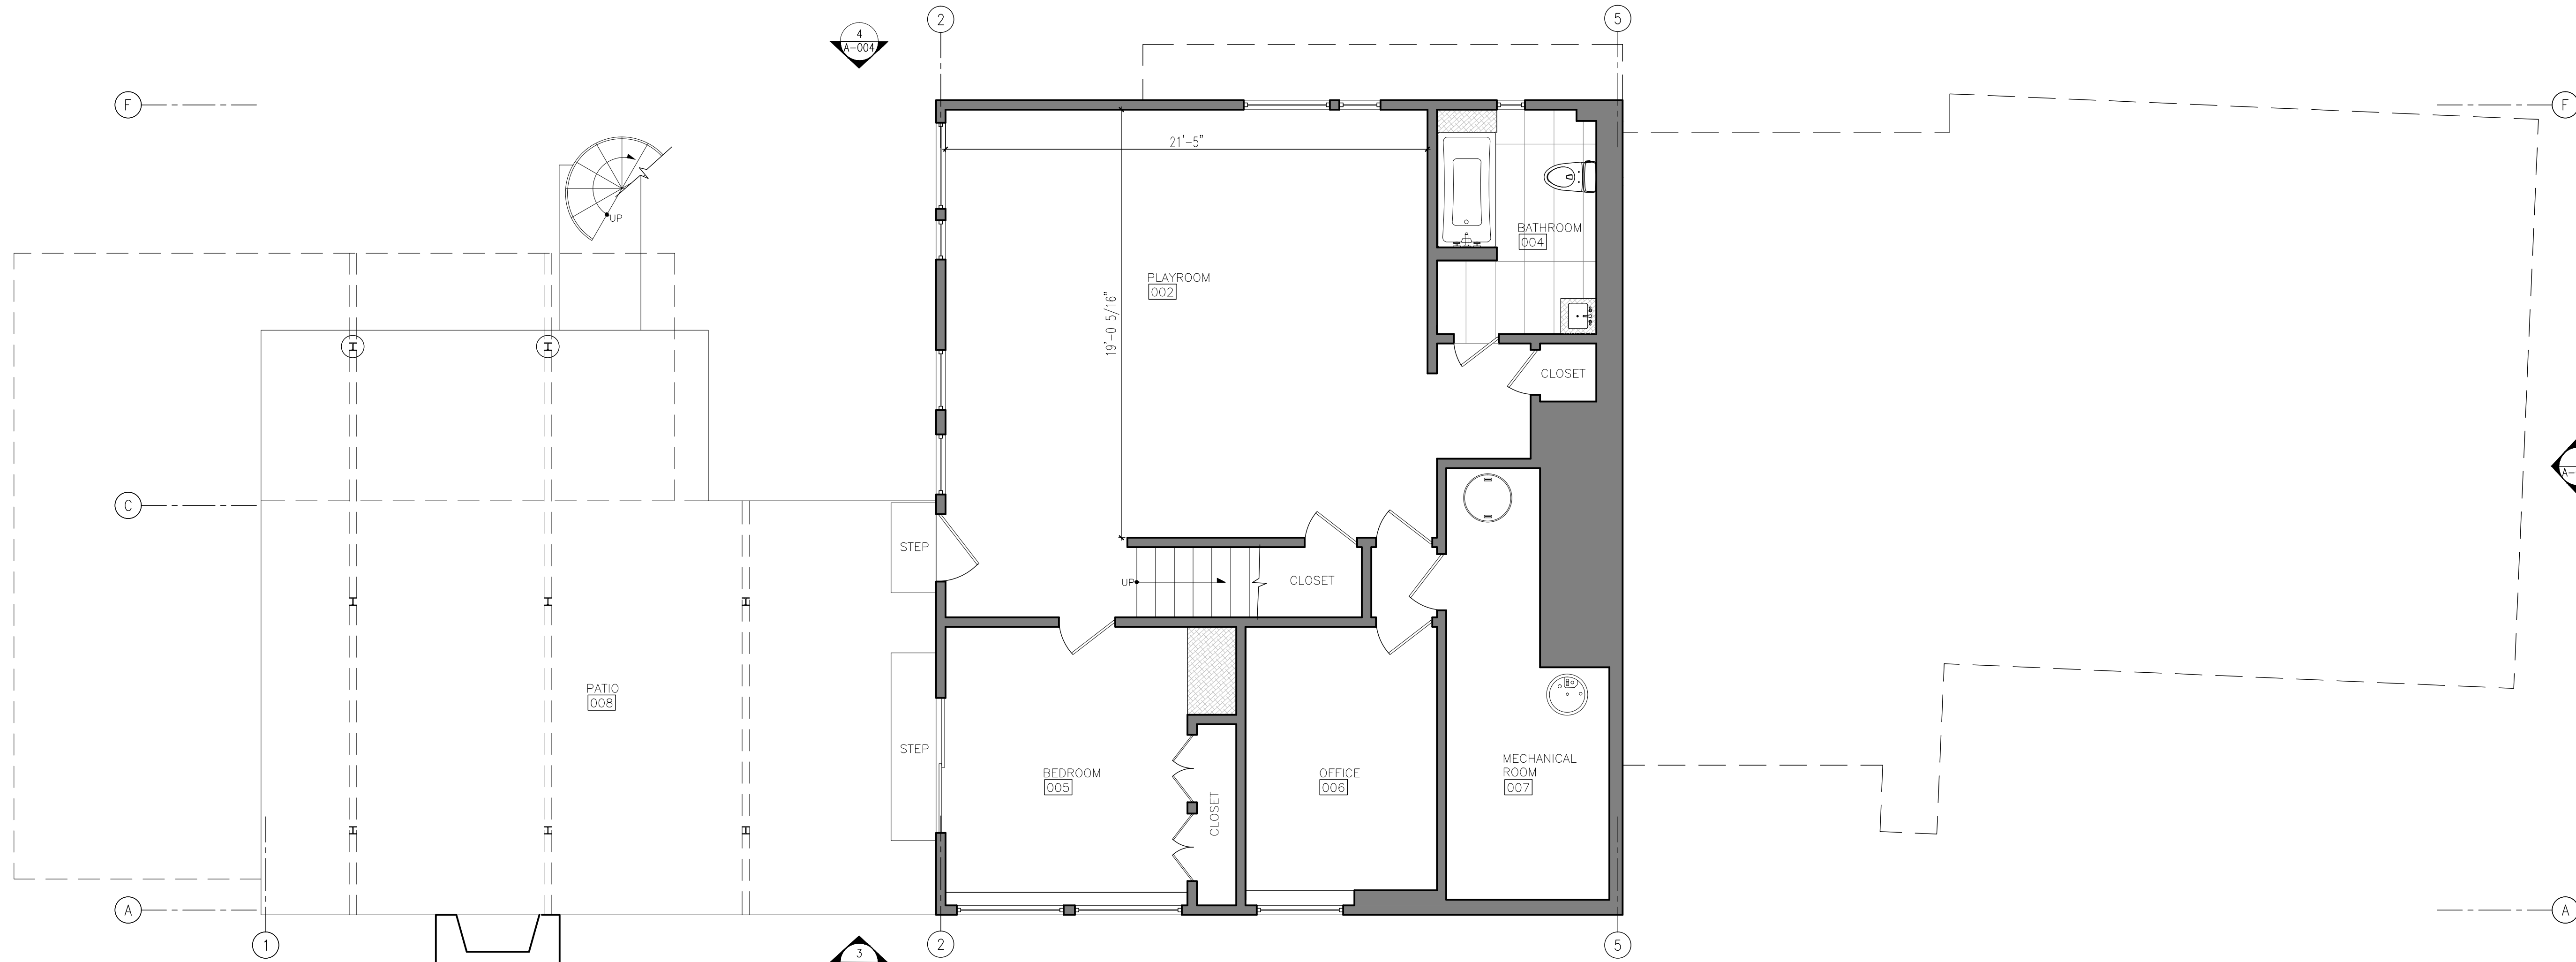

1 Proposed Basement Floor Plan
Scale: 1/4"=1'-0"

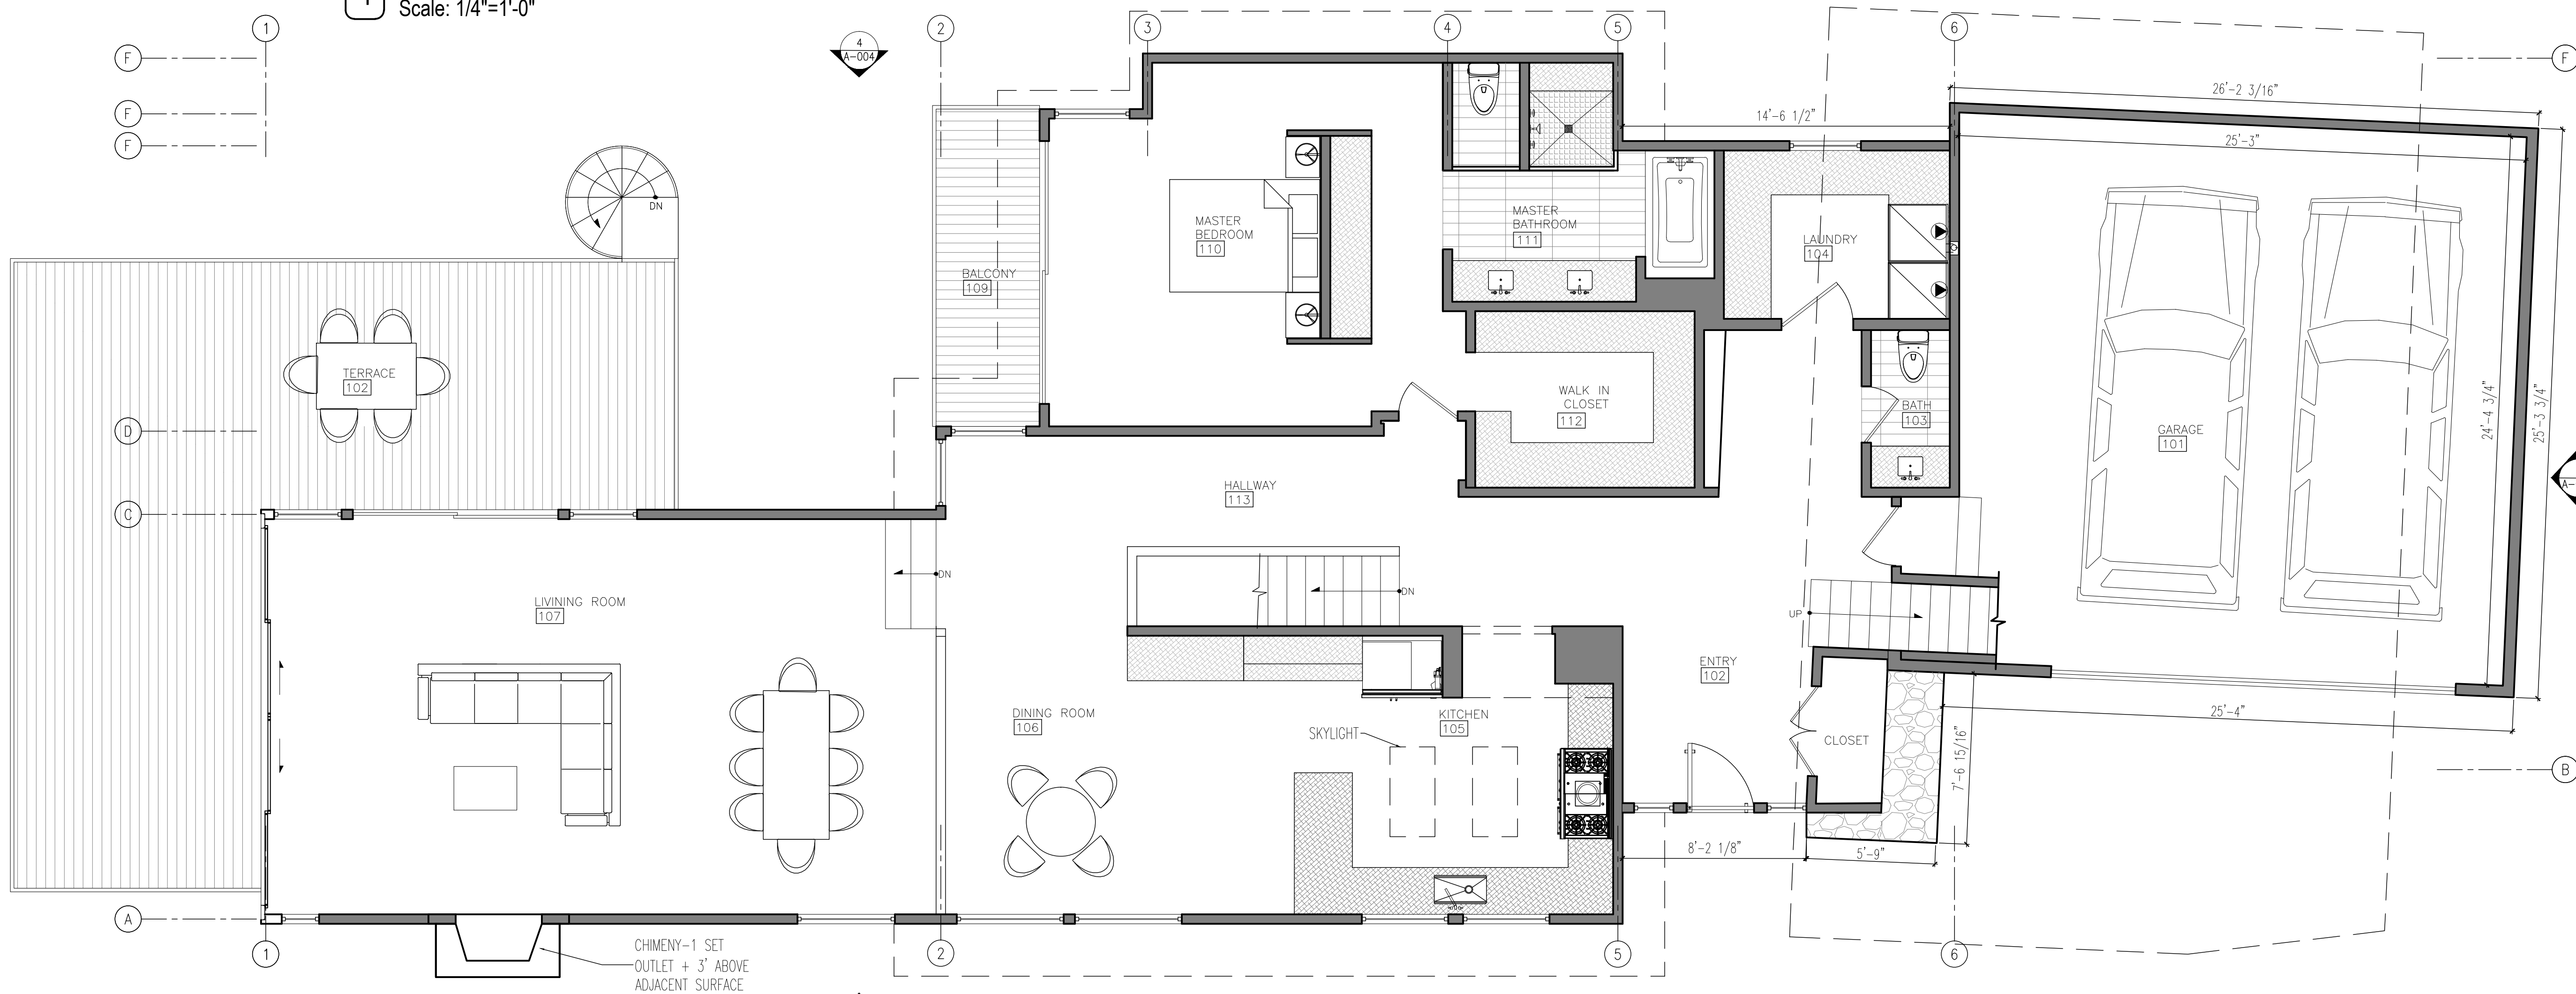

2 Proposed First Floor Plan
Scale: 1/4"=1'-0"

Project Architect:
GSA
GREGORY SHARP ARCHITECT, PC
145 PALISADE STREET, SUITE 211
DOBBS FERRY
DIRECT 917 597 1982
INFO@CASEDEVELOPMENT.COM
OWNER'S REP / PROJECT MANAGER

CASE DEVELOPMENT

Case Development Inc
145 PALISADE STREET, SUITE 211
DOBBS FERRY, NY 10522
www.casedevelopment.com
DIRECT 917 597 1982

D.O.B CONSULTANT

LANDSCAPE ARCHITECT

ARBORIST


STRUCTURAL ENGINEER

PROJECT ENGINEER

NOTES

SYMBOL LEGEND

	Interior Elevation
	See Detail
	Elevation
	Section Cut
	Window Number
	Coordination Tag
	Door Number
	Wall Type
	0.0" Elevation Target
	Revision

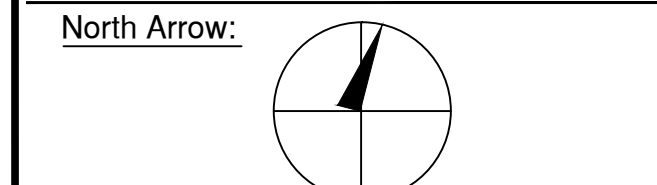

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DRAWING INFORMATION

ISSUED FOR PRE-FILE	5-14-2021
ISSUED FOR REVIEW	6-15-2021
ISSUED FOR PERMIT	

D.O.B. No. -

A Remodelation House located in
Dobbs Ferry, NY developed by:


The Hoffman Residence

PROJECT:
THE HOFFMAN RESIDENCE
242 CLINTON AVENUE,
DOBBS FERRY, NY 10522

PROPOSED BASEMENT & FIRST FLOOR PLAN

SEAL AND SIGNATURE:	DATE: 6/15/2021
	PROJECT No: HOFFMAN 2021
	DRAWING BY: GS
	CHECK BY:
	DWG No:
	A-002.00
	CADD No:

BSCAN:

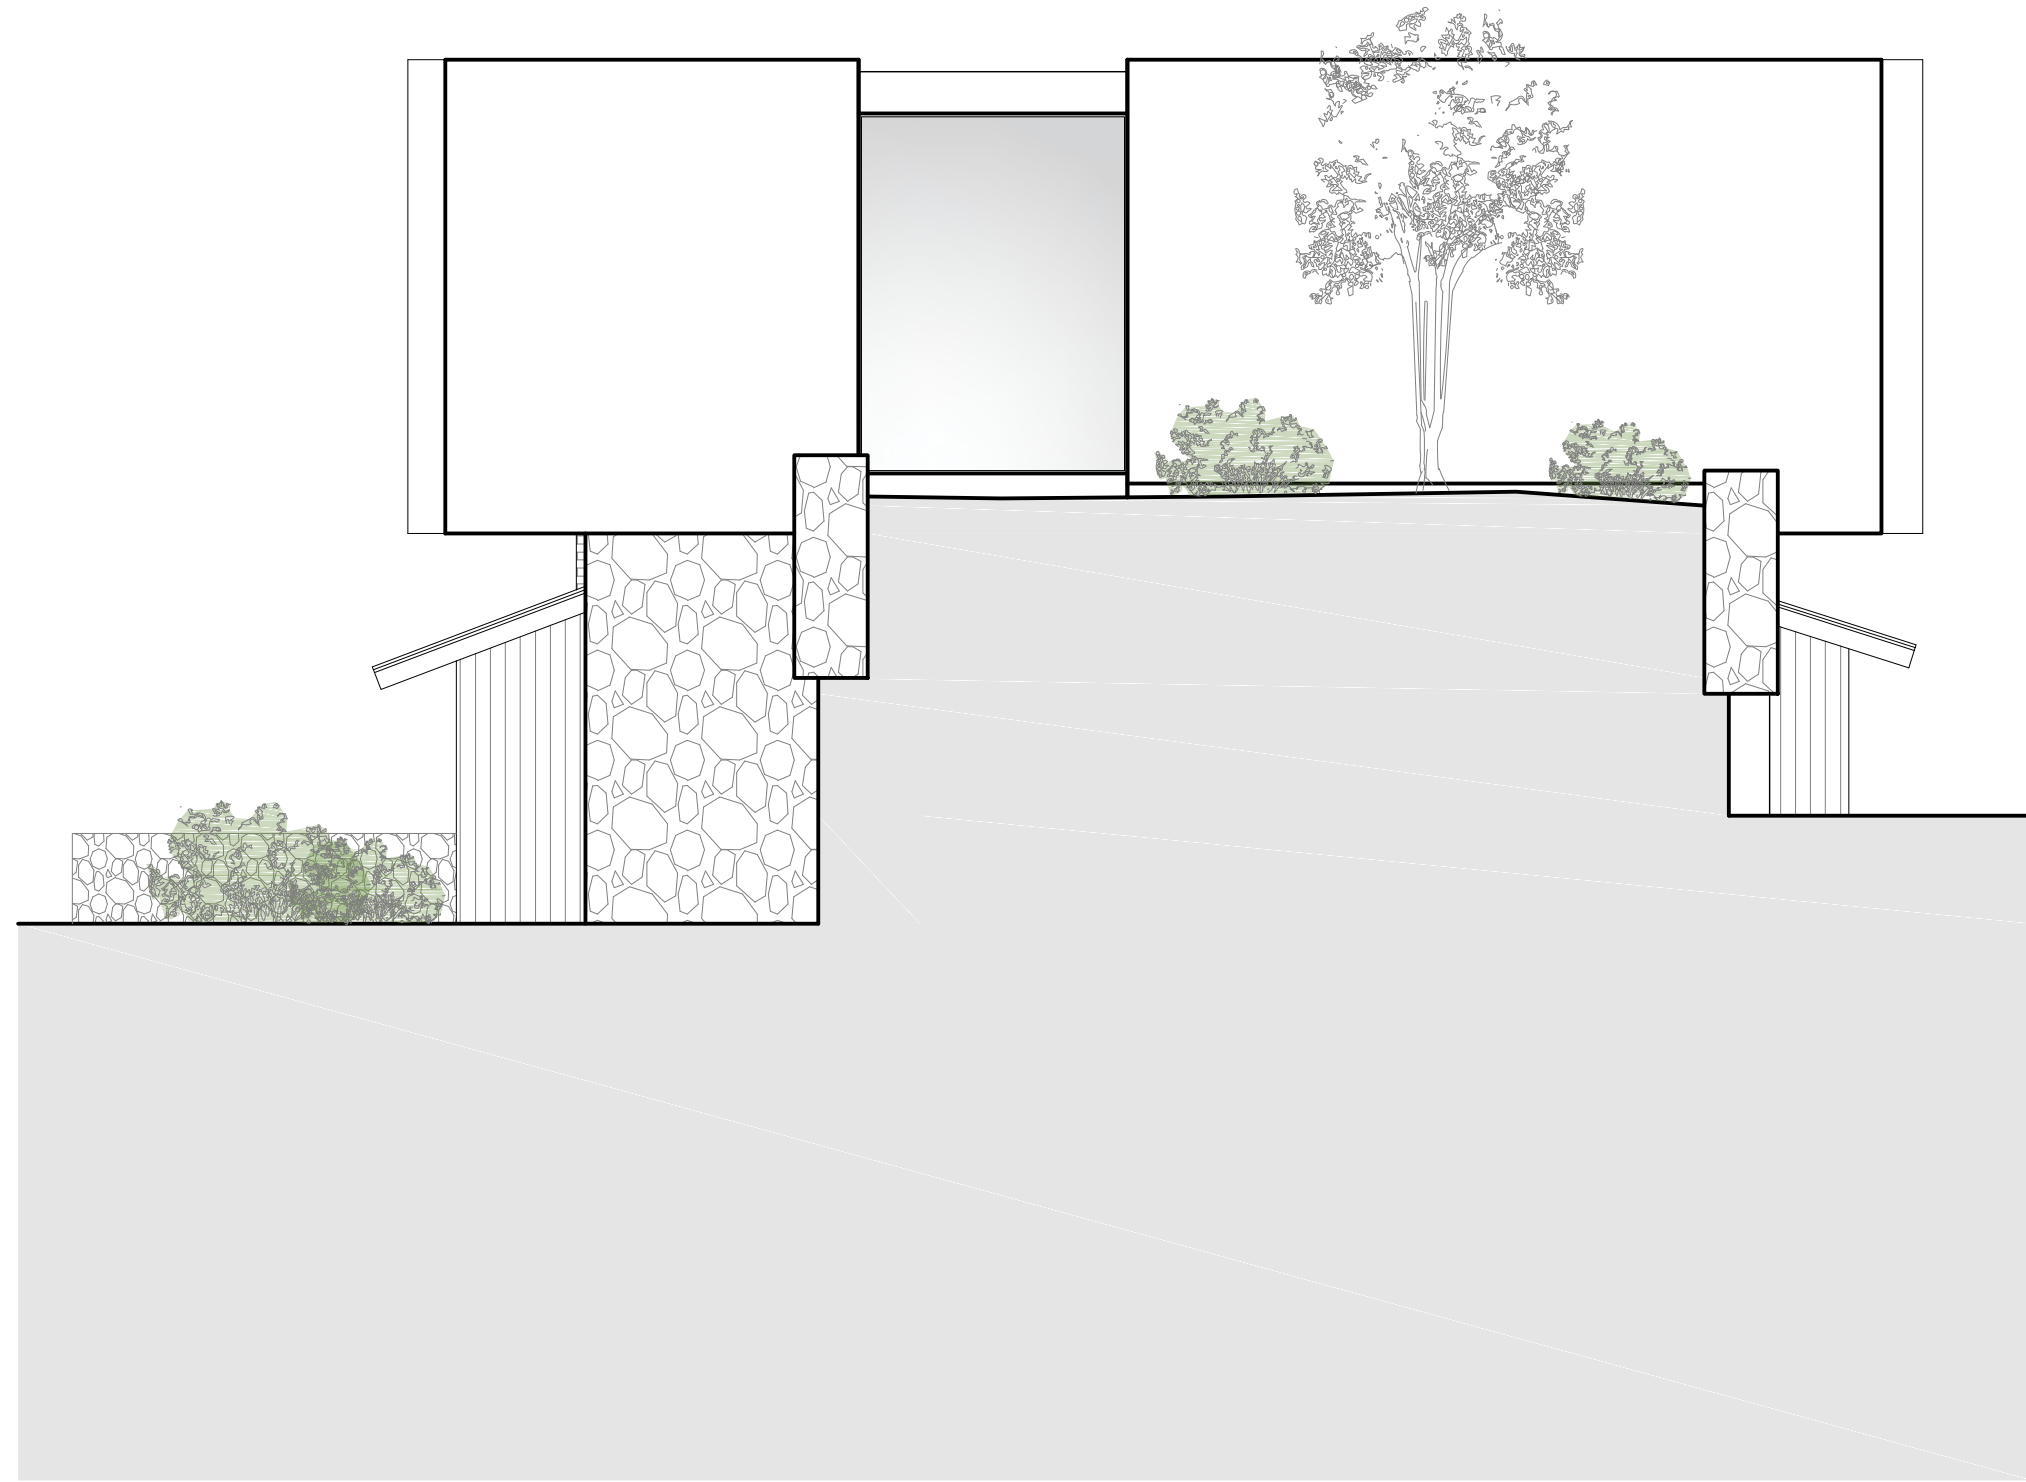

1 Proposed Front Elevation
Scale: 3/16"=1'-0"

TOP OF ROOF
(+) 32'-9"
CEILING 2nd FL
(+) 31'-3"

FINISHED 2nd FL
(+) 21'-3"

BOTTOM 2nd FL
(+) 19'-5"

FINISHED 1st FL
+ 7'-6"

FINISHED Basement FL
0'-0"



2 Proposed Rear Elevation
Scale: 3/16"=1'-0"

TOP OF ROOF
(+) 32'-9"
CEILING 2nd FL
(+) 31'-3"

FINISHED 2nd FL
(+) 21'-3"

BOTTOM 2nd FL
(+) 19'-5"

FINISHED 1st FL
+ 7'-6"

FINISHED Basement FL
0'-0"



3 Proposed Side Elevation
Scale: 3/16"=1'-0"


TOP OF ROOF
(+) 32'-9"
CEILING 2nd FL
(+) 31'-3"

FINISHED 2nd FL
(+) 21'-3"

BOTTOM 2nd FL
(+) 19'-5"

FINISHED GARAGE FL
+ 9'-9"

FINISHED Basement FL
0'-0"

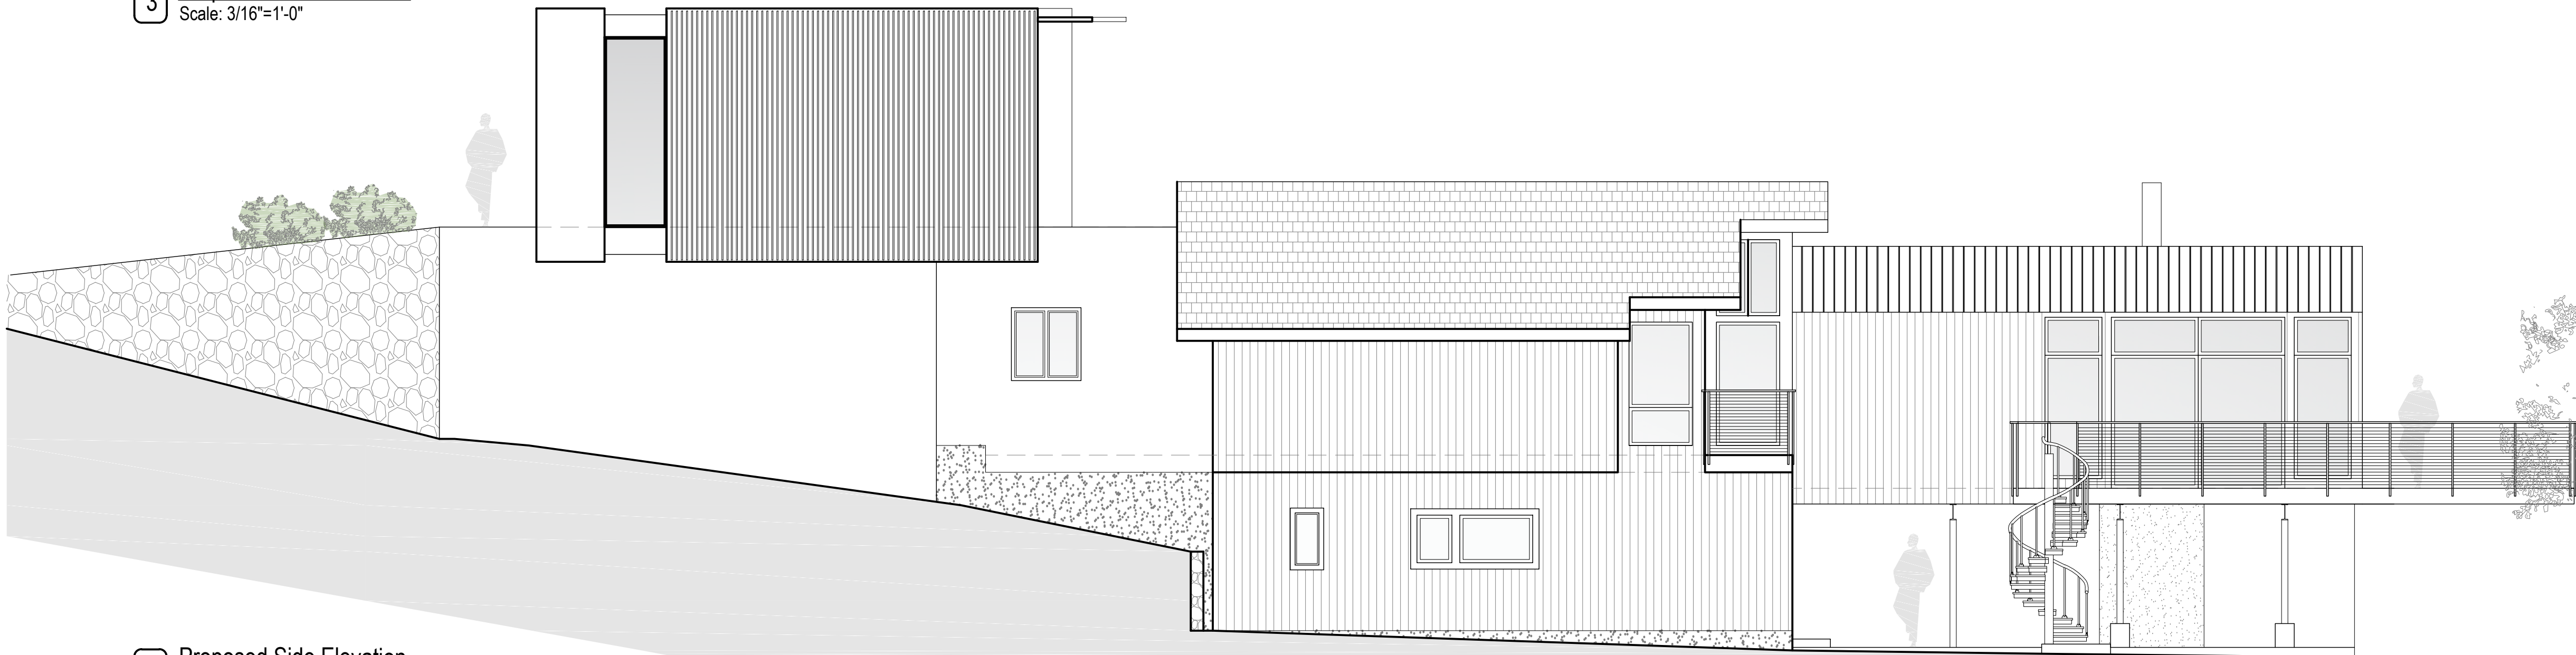

4 Proposed Side Elevation
Scale: 3/16"=1'-0"

TOP OF ROOF
(+) 32'-9"
CEILING 2nd FL
(+) 31'-3"

FINISHED 2nd FL
(+) 21'-3"

BOTTOM 2nd FL
(+) 19'-5"

FINISHED 1st FL
+ 7'-6"

FINISHED Basement FL
0'-0"

Project Architect:

GSA
GREGORY SHARP ARCHITECT, PC
145 PALISADE STREET, SUITE 211
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OWNER'S REP / PROJECT MANAGER

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D.O.B CONSULTANT

LANDSCAPE ARCHITECT

ARBORIST

STRUCTURAL ENGINEER


PROJECT ENGINEER

NOTES

SYMBOL LEGEND

Interior Elevation
See Detail
Elevation
Section Cut
Window Number
Coordination Tag
Door Number
Wall Type
0.0' Elevation Target
Revision

North Arrow:

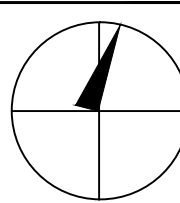

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ISSUED FOR REVIEW
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5-14-2021
6-18-2021

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A Remodelation House located in
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PROJECT:

THE HOFFMAN RESIDENCE
242 CLINTON AVENUE,
DOBBS FERRY, NY 10522

PROPOSED ELEVATIONS

SEAL AND SIGNATURE:



DATE: 6/18/2021

PROJECT No: HOFFMAN 2021

DRAWING BY: GS

CHECK BY:

DWG No:

CADD No:

A-004.00

BSCAN: